

C:\Users\alex_baranga\Documents\20143 WCSS Santa Rosa_Design Review\21-0721_Alex_Kamajia@jacksonmain.com.rvt

RECEIVED

By Monet at 2:58 pm, Sep 14, 2021

WCSS - SANTA ROSA

970 PINER RD,
SANTA ROSA, CA 95404
DESIGN REVIEW PLAN SET
RESUBMITTAL 09/13/2021

SHEET INDEX

GENERAL	
G0.00	COVER SHEET
G0.01	PROJECT INFORMATION & ANNOTATION KEY
G0.02	CODE INFORMATION & ANALYSIS
CIVIL	
C3.0	LAYOUT AND GRADING PLAN
C3.1	LAYOUT AND GRADING PLAN
C5.0	UTILITY PLAN
C5.1	UTILITY PLAN
C8.0	SECTIONS
C8.0	DETAILS
C8.1	DETAILS
LANDSCAPE	
L-1	LANDSCAPE PLANTING PLAN
L-2	PLANTING PLAN
ARCHITECTURAL	
A1.00	SITE PLAN
A1.01	ENLARGED SITE PLAN
A1.03	SITE DETAILS
A1.04	SITE DEMO PLAN
A2.01	FLOOR PLAN - LEVEL 01
A2.02	FLOOR PLAN - LEVEL 02
A2.03	FLOOR PLAN - LEVEL 03
A3.01	EXTERIOR ELEVATIONS
A3.02	EXTERIOR ELEVATIONS
A4.01	BUILDING SECTIONS
A10.01	PROJECT IMAGERY



WEST COAST SELF STORAGE
GROUP

808 134TH ST SW, BLDG.B, STE 211
EVERETT WA, 98204

WCSS - SANTA ROSA

970 PINER RD,
SANTA ROSA, CA 95404

DATE	NO.	DESCRIPTION
07/24/21	0	DESIGN REVIEW - PRELIMINARY
08/24/21	1	AND/OR RESPONSE #1



NOT FOR CONSTRUCTION
FOR REVIEW ONLY

PROJECT NO.: 20143
PROJECT MGR.: LH
DRAWN BY: AK
CHECKED BY: RAM

COVER SHEET

G0.00

JACKSON | MAIN ARCHITECTURE P.S. © 2021

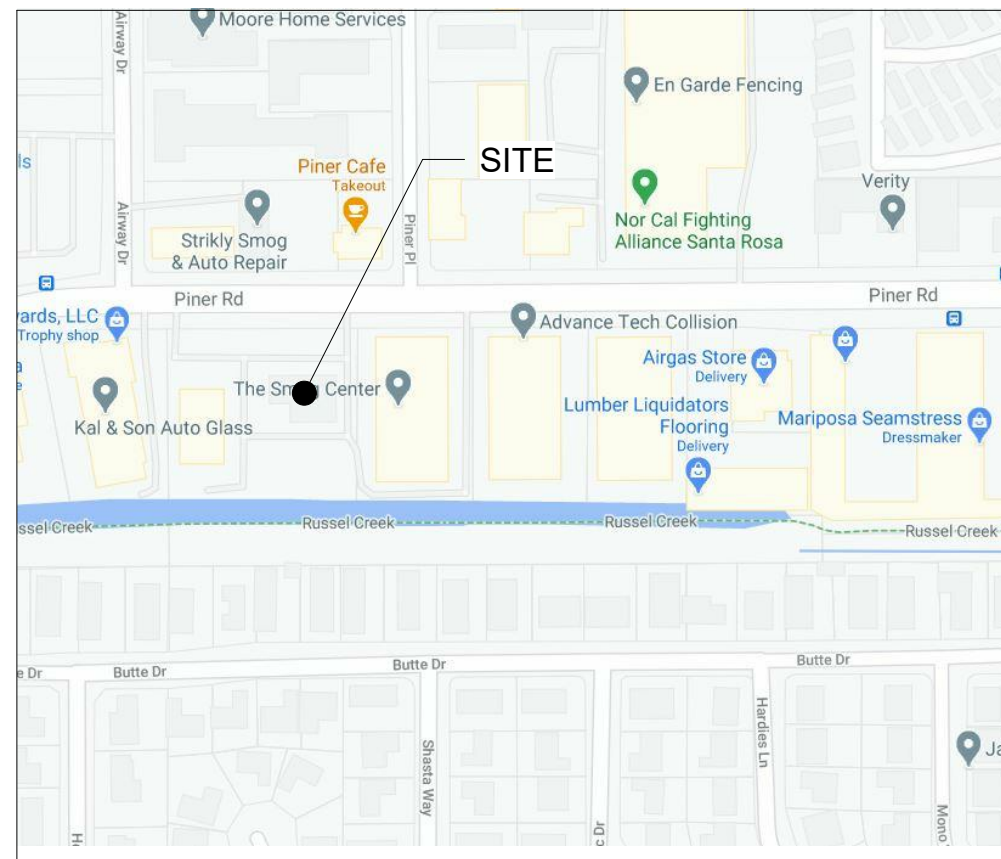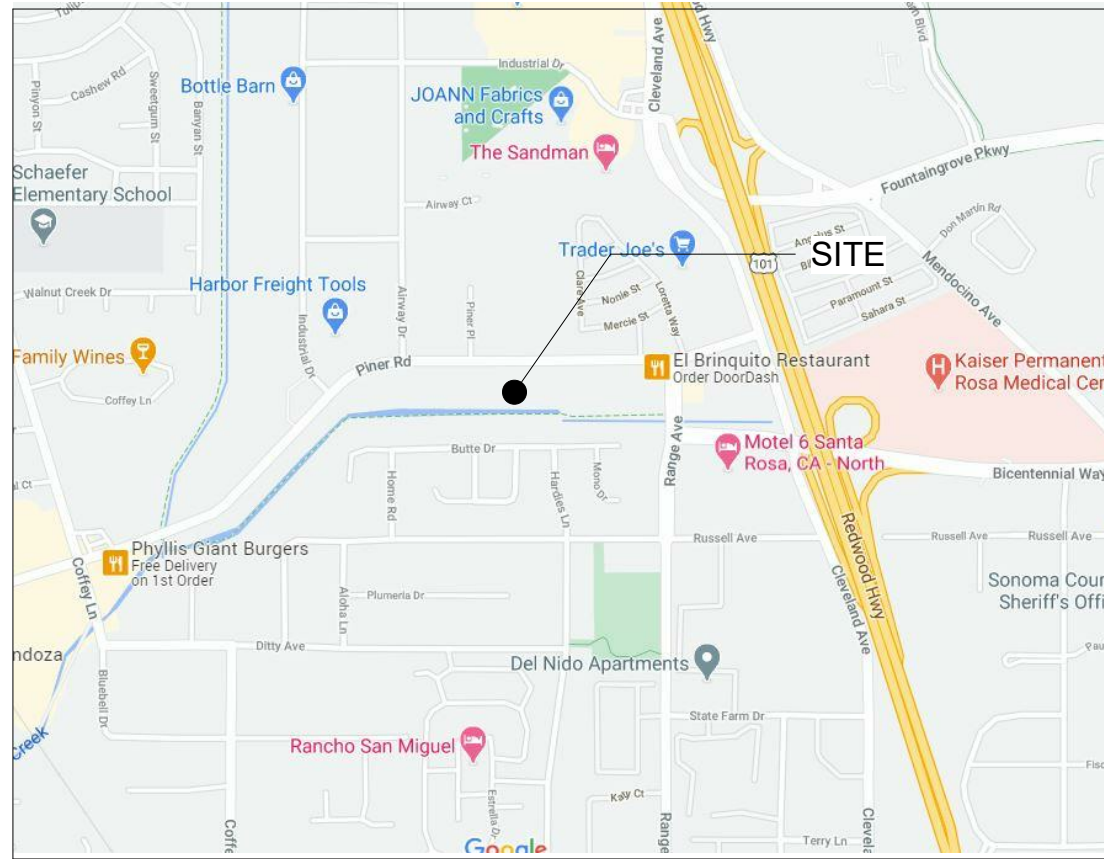

LEGAL DESCRIPTION

LEGAL DESCRIPTION (PER TITLE REPORT):
REAL PROPERTY IN THE CITY OF SANTA ROSA, COUNTY OF SONOMA, STATE OF CALIFORNIA,
DESCRIBED AS FOLLOWS:
LOT 2, AS SHOWN ON CITY OF SANTA ROSA PARCEL MAP NO. 749, FILED ON JULY 1ST, 2020,
IN BOOK 814 OF PARCEL MAPS AT PAGES 49 TO 53, SONOMA COUNTY RECORDS.
APN: 015-680-015-000 UNDERLYING, (NEW APN NOT YET ASSESSED)

PROJECT DESCRIPTION

CONSTRUCTION A STORAGE FACILITY THAT INCLUDES:

A LEASING OFFICE AND RETAIL BUILDING AT THE FORWARD PORTION OF THE
BUILDING AND A 3-STORY, SEMI-CONDITIONED SELF-STORAGE STRUCTURE.

ZONING:

LIGHT INDUSTRIAL (LI) SRMC 20-24.040

OCCUPANCY CLASSIFICATION :

S-1

CODE INFORMATION:

REFERENCE SHEETS G0-02, -03, AND G0-05 DETAILED CODE ANALYSIS

DEFERRED PERMITTING:

CONTRACTOR TO SUBMIT
• ELEVATOR
• FIRE PROTECTION (SPRINKLER & FIRE ALARM)
• AUTOMATIC GATE
• SIGNAGE

NOTE:

- SUBMITTAL DOCUMENTS FOR DEFERRED SUBMITTAL SHALL BE SUBMITTED TO THE BUILDING INSPECTOR AND ALL SUBCONTRACTORS THAT WILL BE INSTALLING FIRESTOPPING MATERIALS. EACH SUBCONTRACTOR WILL PROVIDE A LIST OF FIRESTOP INFORMATION (I.E. CBC OR OTHER APPROVED REPORT/LISTING NUMBERS). THIS INFORMATION MUST BE SUBMITTED TO AND APPROVED BY THE BUILDING INSPECTOR PRIOR TO ANY INSTALLATION.
- GENERAL CONTRACTOR SHALL SUBMIT AND OBTAIN APPROVAL FOR ALL DEFERRED SUBMITTALS

DELEGATED DESIGN

THE GENERAL CONTRACTOR SHALL SCHEDULE A FIRESTOPPING MEETING WITH THE BUILDING INSPECTOR AND ALL SUBCONTRACTORS THAT WILL BE INSTALLING FIRESTOPPING MATERIALS. EACH SUBCONTRACTOR WILL PROVIDE A LIST OF FIRESTOP MATERIALS / ASSEMBLIES WHICH WILL BE USED, AND THE LISTING AND APPROVAL INFORMATION (I.E. CBC OR OTHER APPROVED REPORT/LISTING NUMBERS). THIS INFORMATION MUST BE SUBMITTED TO AND APPROVED BY THE BUILDING INSPECTOR PRIOR TO ANY INSTALLATION.

SPECIAL INSPECTIONS



















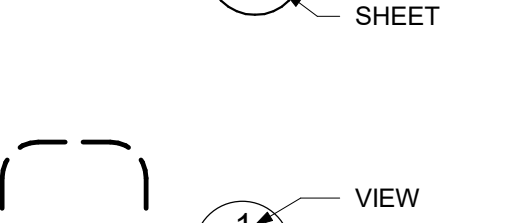
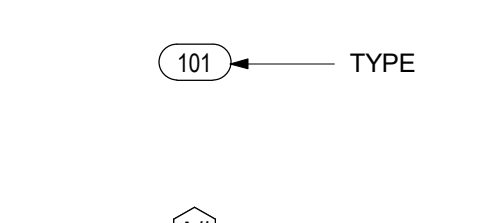
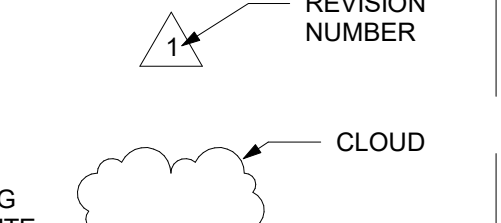
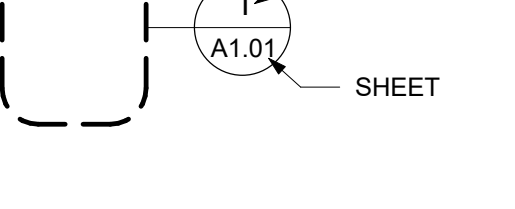
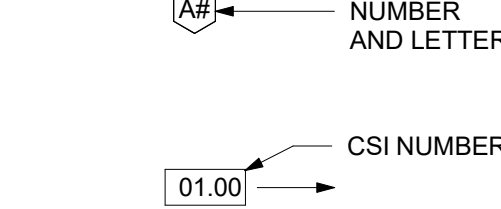
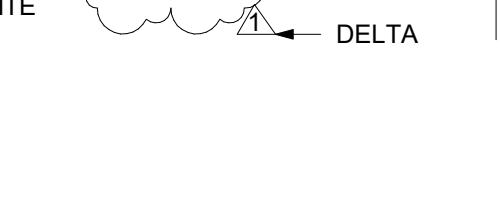
THE GENERAL CONTRACTOR SHALL SCHEDULE A FIRESTOPPING MEETING WITH THE BUILDING INSPECTOR AND ALL SUBCONTRACTORS THAT WILL BE INSTALLING FIRESTOPPING MATERIALS. EACH SUBCONTRACTOR WILL PROVIDE A LIST OF FIRESTOP INFORMATION (I.E. ICC OR OTHER APPROVED REPORT/LISTING NUMBERS). THIS INFORMATION MUST BE SUBMITTED TO AND APPROVED BY THE BUILDING INSPECTOR PRIOR TO ANY INSTALLATION.

- GRADING
- AIR BARRIER TESTING
- REFERENCE STRUCTURAL DRAWINGS FOR ADDITIONAL SPECIAL INSPECTIONS
- INTUMESCENT PAINT

OWNER	ARCHITECT	GEOTECHNICAL ENGINEER	CIVIL ENGINEER	STRUCTURAL ENGINEER	MECHANICAL & PLUMBING ENGINEER	ELECTRICAL ENGINEER	LANDSCAPE ARCHITECT
WEST COAST SELF STORAGE 808 134TH ST SW BLDG B, SUITE 211 EVERETT, WASHINGTON 98204 PHONE: 408-636-4543 EMAIL: stangney@wcselfstorage.com CONTACT: Steve Tangney	JACKSON MAIN ARCHITECTURE P.S. 311 1ST AVE. S. SEATTLE WA 98104 PHONE: 206-324-4800 EMAIL: laez.hitchcock@jacksonmain.com CONTACT: Larz Hitchcock ARCHITECT: Robin Murphy	BAUER ASSOCIATES INC. 6470 MIRABLE RD, P O BOX 460 FORESTVILLE, WA 95406 PHONE: 707-884-2506 EMAIL: arthur@bauergeotech.com CONTACT: Arthur H. Graff - Geo Tech Eng	SUMMIT ENGINEERING 463 AVIATION BLVD STE 200 SANTA ROSA, CALIFORNIA 95403 PHONE: 707-527-0775 EMAIL: mlorica@summit-e.com CONTACT: Monica Shah PE -PM.	HW ENGINEERING 8887 W. FLAMINGO RD SUITE 101 LAS VEGAS, NV. 89147 PHONE: 702-202-0061 EMAIL: hongyu@hwengineeringusa.com CONTACT: Hongyu Wang - PE, SE	LMR CONSULTING MECHANICAL ENGINEERS 1165 A STREET SANTA CLARA, CA. 94541 PHONE: 510-7332330 EMAIL: team@lmrengineers.com CONTACT: Leonard M. Rose - Principal PE	AMERICAN CONSULTANT ENGINEERS ELECTRICAL INC. 100 SARATOGA AVE, SUITE 200 SANTA CLARA, CA. 94501 PHONE: 408-236-2312 EMAIL: rgarcia@amcengine.com CONTACT: Renier C. Garcia	BILL RINEHART 118 ENGLISH ST PETALUMA, CA. 94952 PHONE: 707-480-6451 EMAIL: bill@johnsonrinhart.com CONTACT: Bill Rinehart ASLA

9/14/2021 10:52:59 AM

TYPICAL SYMBOLS

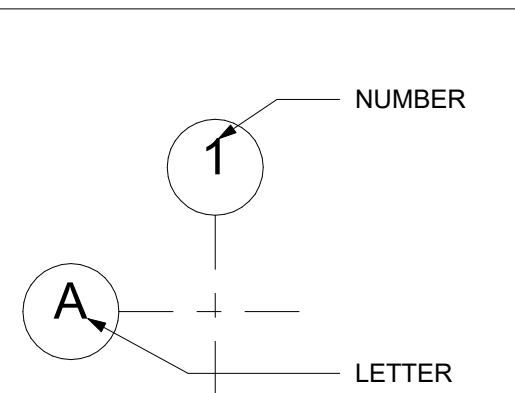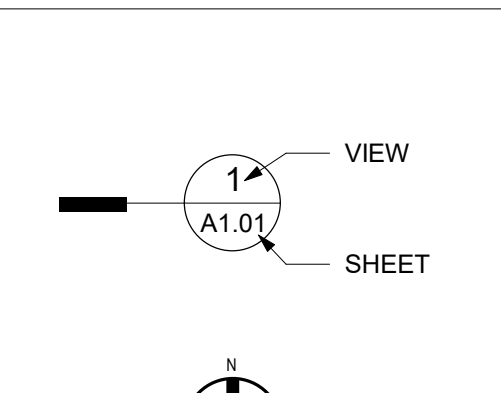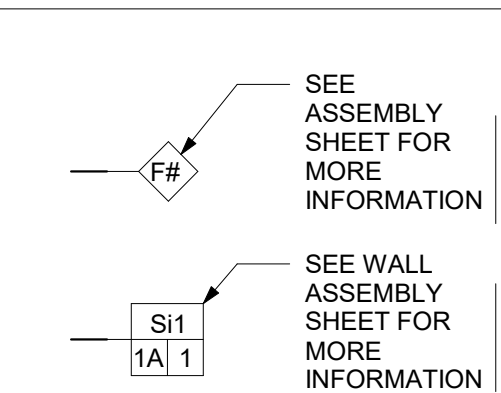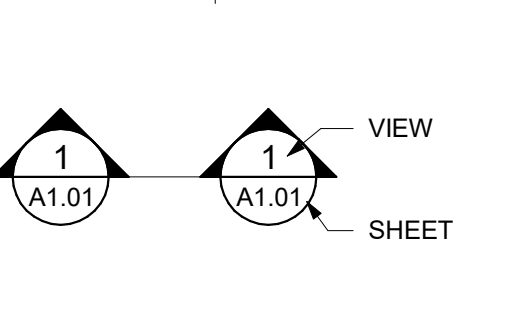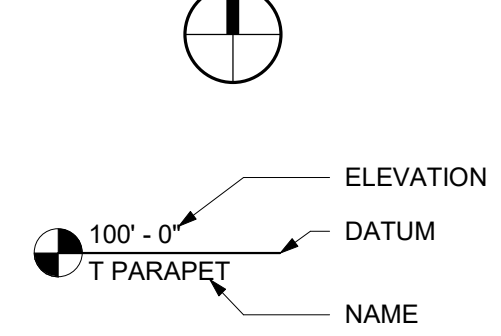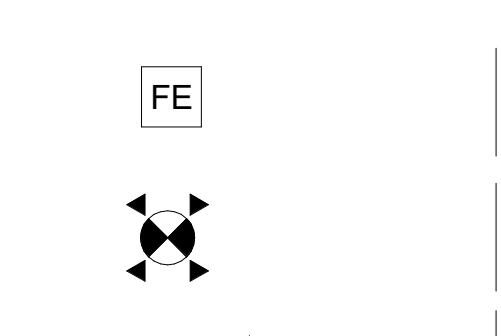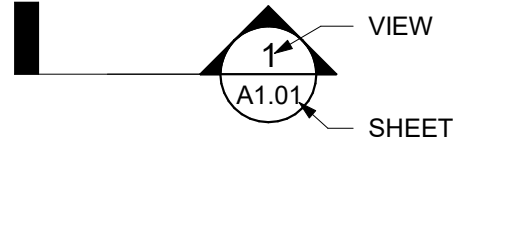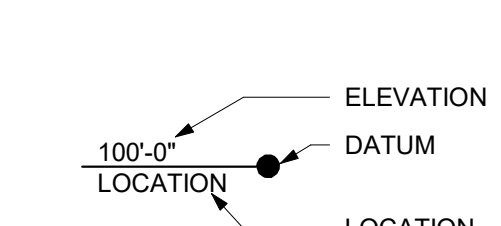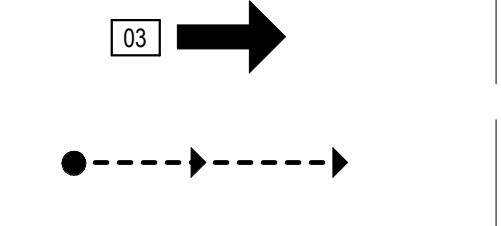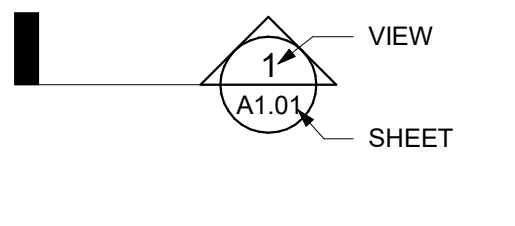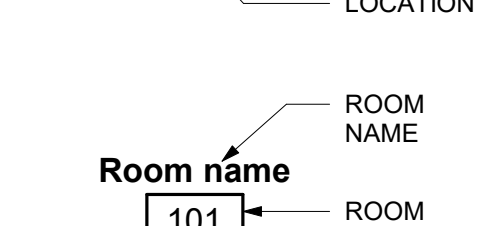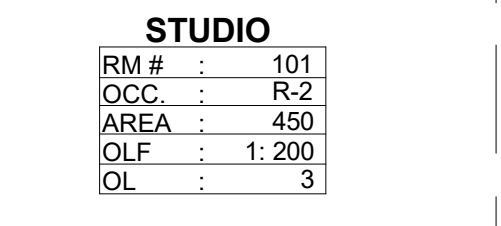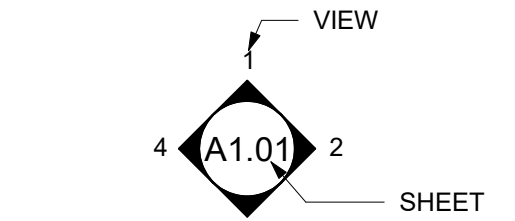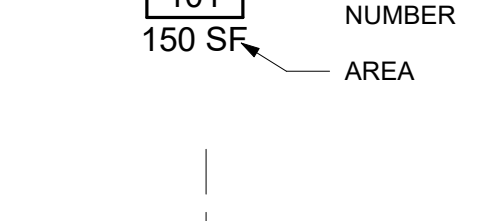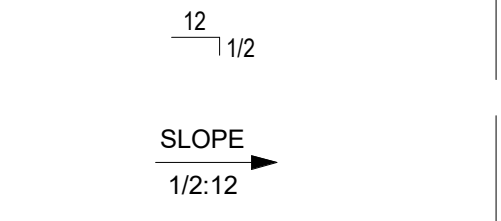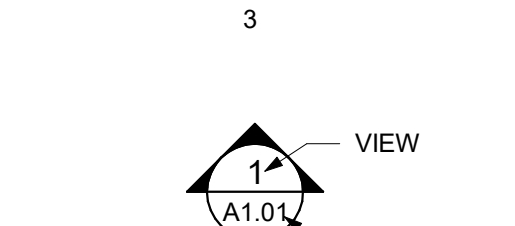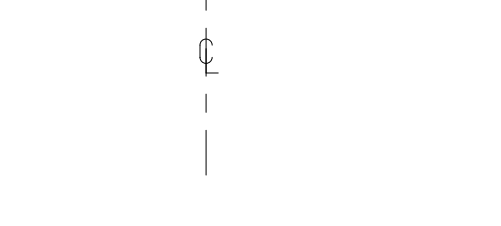	<p>NUMBER</p> <p>REFERENCE GRID LINES</p> <p>LETTER</p>		<p>VIEW</p> <p>SHEET</p>		<p>SEE ASSEMBLY SHEET FOR MORE INFORMATION</p> <p>FLOOR/ROOF TAG</p> <p>SEE WALL ASSEMBLY SHEET FOR MORE INFORMATION</p> <p>WALL TAG</p>
	<p>OVERALL BUILDING SECTION</p>		<p>NORTH ARROW</p>		<p>FIRE EXTINGUISHER</p>
	<p>PARTIAL BUILDING SECTION</p>		<p>ELEVATION</p> <p>DATUM</p> <p>NAME</p>		<p>EXIT LIGHTING</p>
	<p>WALL SECTION</p>		<p>ELEVATION</p> <p>DATUM</p> <p>LOCATION</p>		<p>EGRESS ARROW AND OCCUPANT LOAD EXITING</p>
	<p>ROOM TAG</p>		<p>ROOM NAME</p> <p>ROOM NUMBER</p> <p>AREA</p>		<p>EGRESS DIRECTION PATH OF TRAVEL</p>
	<p>INTERIOR ELEVATION REFERENCE</p>		<p>ROOM TAG</p>		<p>ROOM TAG / OCCUPANT LOAD CALCULATOR</p>
	<p>EXTERIOR ELEVATION REFERENCE</p>		<p>ROOM TAG</p>		<p>REVISION TAG</p>
	<p>CALL OUT</p>		<p>REVISION TAG</p>		<p>REVISION CLOUD</p>

GRAPHIC CONVENTIONS

- A. WALL ASSEMBLY TYPE SYMBOLS APPLY TO THE FULL LENGTH OF CONTINUOUS WALLS INCLUDING OFFSETS AND AROUND CORNERS UNLESS INDICATED OTHERWISE.
- B. CHANGES IN PARTITION TYPES ARE INDICATED BY DIFFERENT SYMBOLS OCCURRING AT EACH SIDE OF A TRANSITION OR INTERRUPTION, OR BY A CHANGE IN THE GRAPHICS ON THE PLAN, UNLESS REQUIRED FOR CLARITY.
- C. DRAWING REFERENCE SYMBOLS: DRAWINGS CROSS-REFERENCES NORMALLY ARE REFERENCED ON SMALLER SCALE DRAWINGS TO THE NEXT LARGER SCALE VIEW. FOR EXAMPLE, A BUILDING ELEVATION WILL SHOW A WALL SECTION, AND THE WALL SECTION WILL REFER TO THE LARGER-SCALE DETAILS WHICH APPLY. U.N.O.
- D. REFER TO LARGEST AVAILABLE DETAIL OR VIEW TO DETERMINE COMPLETE ASSEMBLY, CONDITION AND/OR DIMENSION, AND FOR SIMILAR INFORMATION. WHERE DRAFTING DISCREPANCIES OCCUR BETWEEN VIEWS OF SAME CONDITION AT DIFFERENT SCALES, THE LARGER-SCALE VIEW GOVERNS UNLESS NOTED OTHERWISE.
- E. DETAIL VIEWS MAY BE DRAFTED TO CONVEY ONLY PORTIONS OF THE OVERALL CONDITION AT A SPECIFIC LOCATION. REFER TO OTHER SIMILAR AND SUPPORTING VIEWS TO DETERMINE OVERALL CONDITION OR ASSEMBLY IN PLACE.

[illegible]

NUMBER OF ACCESSIBLE STORAGE UNITS REQUIRED:
PER 2019 CBC TABLE 11B-225.3 : 10, PLUS 2% OF TOTAL NUMBER OF UNITS OVER 200

NUMBER OF ACCESSIBLE STORAGE UNITS PROVIDED:
 $10 + ((599-200) \cdot .02) = 7.98$ UNITS TO BE ACCESSIBLE; 8 ACCESSIBLE UNITS PROVIDED

11B-225.3.1: DISTRIBUTED EVENLY PER UNIT TYPE : **8/9 = 0.8 OR 1 EACH**

ROOMS AREA			
NAME	NUMBER	LEVEL	Area
LEVEL 1	03	Not Placed	Not Placed
1CORRIDOR			
REST ROOM	05	LEVEL 01	101.48 SF
REST ROOM 02	06	LEVEL 01	107.18 SF
STAIR 02	07	LEVEL 01	142.40 SF
STAIR 01	08	LEVEL 01	166.96 SF
TOTAL	102	LEVEL 01	722.89 SF
10x10	102	Not Placed	Not Placed
BREAK ROOM	103	LEVEL 01	108.16 SF
ELEC	104	Not Placed	Not Placed
ELEC	115	LEVEL 01	175.30 SF
RISER	116	LEVEL 01	55.02 SF
Totals: 11			

LEVEL 1CORRIDOR	03	Not Placed	Not Placed
REST ROOM	05	LEVEL 01	101.48 SF
REST ROOM 02	06	LEVEL 01	107.18 SF
STAIR 02	07	LEVEL 01	142.40 SF
STAIR 01	08	LEVEL 01	166.96 SF
RETAIL	101	LEVEL 01	722.99 SF
10x10	102	Not Placed	Not Placed
BREAK ROOM	103	LEVEL 01	108.16 SF
ELEC	104	Not Placed	Not Placed
ELEC	115	LEVEL 01	175.30 SF
RISER	116	LEVEL 01	55.02 SF

LEVEL 1CORRIDOR	03	Not Placed	Not Placed
REST ROOM	05	LEVEL 01	101.48 SF
REST ROOM 02	06	LEVEL 01	107.18 SF
STAIR 02	07	LEVEL 01	142.40 SF
STAIR 01	08	LEVEL 01	166.96 SF
RETAIL	101	LEVEL 01	722.99 SF
10x10	102	Not Placed	Not Placed
BREAK ROOM	103	LEVEL 01	108.16 SF
ELEC	104	Not Placed	Not Placed
ELEC	115	LEVEL 01	175.30 SF
RISER	116	LEVEL 01	55.02 SF


ENVIRONMENTAL	
AHJ GREEN INCENTIVES:	Santa Rosa Climate Action Plan
HAZARDOUS MATERIALS:	Remediation Part of Contract
PHOTO VOTAICS:	Site Ready Required
ELEC. CAR STALLS:	Site Ready Optional
	<p>ITEMS REQUIRED By SR Climate Action Plan</p> <ul style="list-style-type: none"> •Provide subsidized transit passes to employees over 50 •Increase diversion of construction waste •Minimize construction equipment idling time to 5 minutes or less •Maintain Construction equipment per manf. Specs <p>OTHER:</p> <ul style="list-style-type: none"> •Limit GHG const eqpm emissions by using electrical equipment or alt fuels •Install real time energy monitors •Sidewalks to have high solar reflectance •Comply with City Tree preservation Ordinance •Low water landscapes •Parking Tree Compliance

BUILDING UTILITY INFORMATION	
POWER SERVICE PROVIDER:	PG&E
WATER SERVICE PROVIDER:	SANTA ROSA WATER
TRASH SERVICE PROVIDER:	NORTH BAY COROPORATION
GAS SERVICE PROVIDER:	PG&E

ENVIRONMENTAL	
AHJ GREEN INCENTIVES:	Santa Rosa Climate Action Plan
HAZARDOUS MATERIALS:	Remediation Part of Contract
PHOTO VOTAICS:	Site Ready Required
ELEC. CAR STALLS:	Site Ready Optional
	<p>ITEMS REQUIRED By SR Climate Action Plan</p> <ul style="list-style-type: none"> •Provide subsidized transit passes to employees over 50 •Increase diversion of construction waste •Minimize construction equipment idling time to 5 minutes or less •Maintain Construction equipment per manf. Specs <p>OTHER:</p> <ul style="list-style-type: none"> •Limit GHG const eqpm emissions by using electrical equipment or alt fuels •Install real time energy monitors •Sidewalks to have high solar reflectance •Comply with City Tree preservation Ordinance •Low water landscapes •Parking Tree Compliance

G0.02

THIS DOCUMENT AND THE IDEAS AND DESIGNS INCORPORATED HEREIN, AS AN INSTRUMENT OF PROFESSIONAL SERVICE, IS THE PROPERTY OF SUMMIT ENGINEERING, INC. AND IS NOT TO BE USED IN WHOLE OR IN PART, FOR ANY OTHER PROJECT WITHOUT THE WRITTEN AUTHORIZATION OF SUMMIT ENGINEERING, INC.

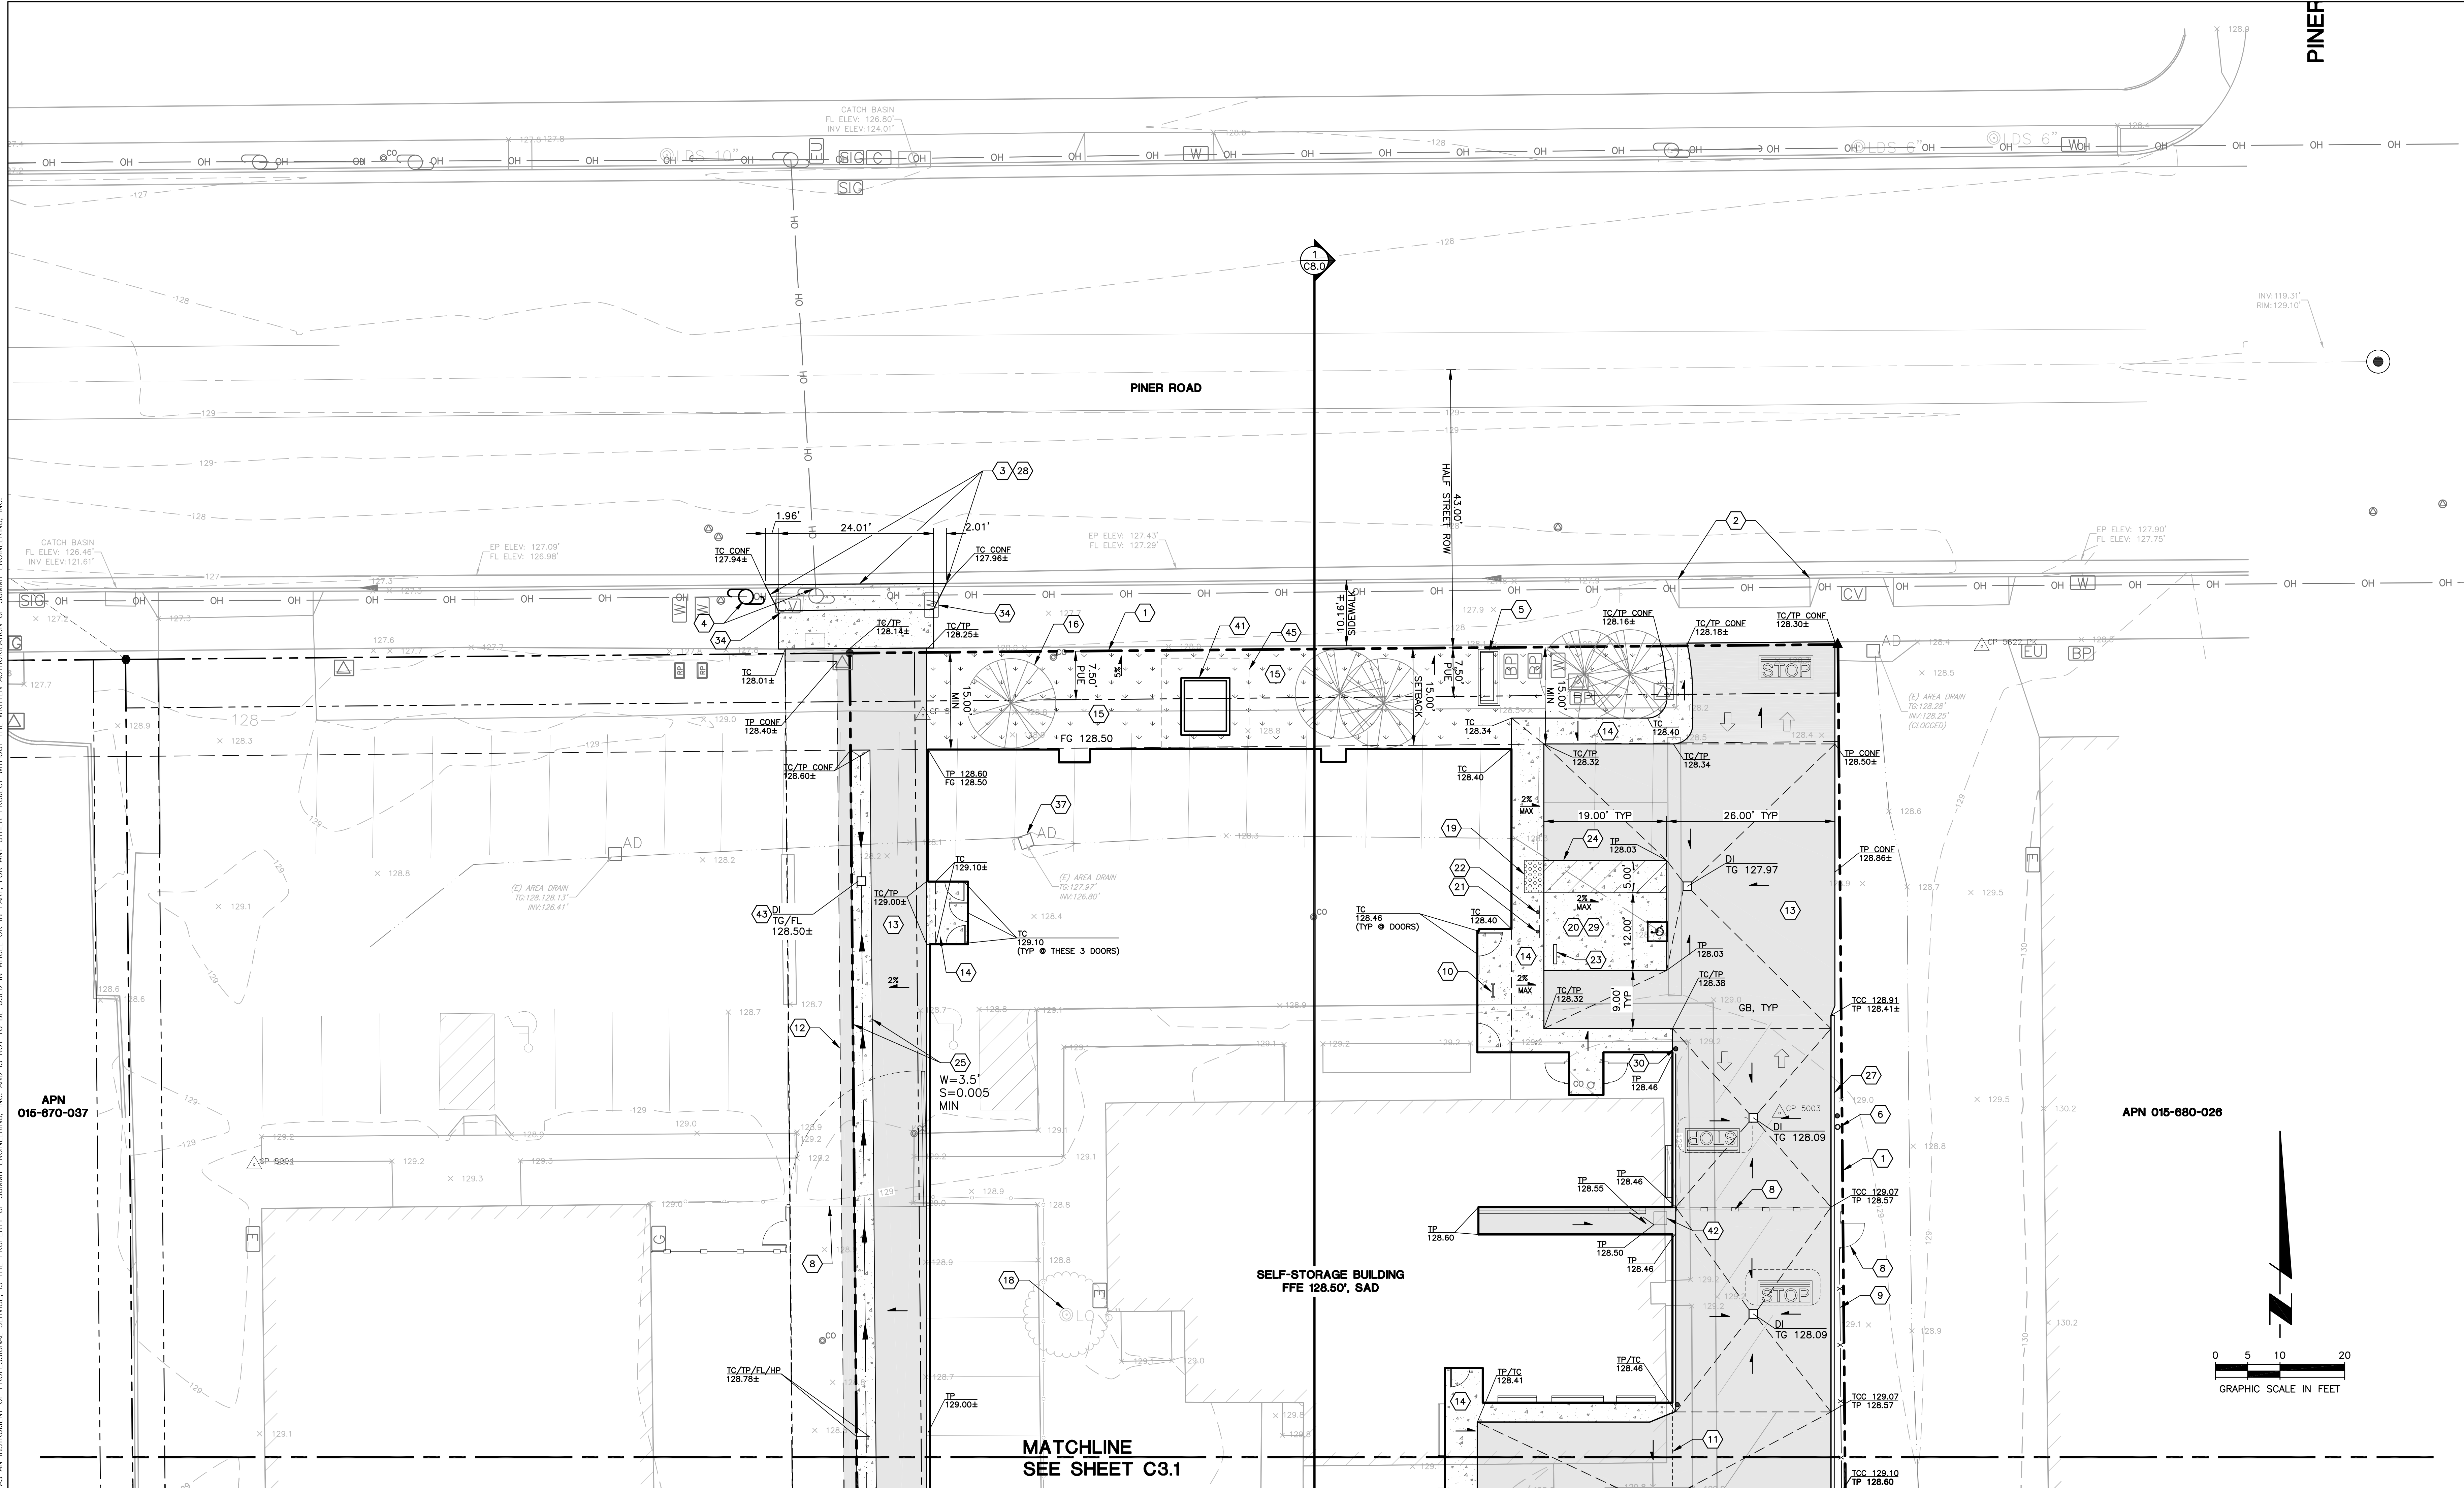

LAYOUT & GRADING KEY NOTES

#	DESCRIPTION	#	DESCRIPTION	#	DESCRIPTION
1.	APPROXIMATE PROPERTY LINE, TYP	13.	SHADING REPRESENTS LIMITS OF ASPHALT CONCRETE SURFACING, 3" AC OVER 12" CL 2 AB OR 3" AC OVER 6" CL 2 AB OVER 12" AGG SUBBASE, TI=5.5, OVEREXCAVATION & RECOMPACTION PER SOILS REPORT	23.	WHEEL STOP, SEE 16/C9.1
2.	(E) DRIVEWAY APRON	14.	HATCH REPRESENTS LIMITS OF CONC SIDEWALK, SEE DETAIL 8/C9.1	24.	PAVEMENT STRIPING, TYP
3.	DRIVEWAY APRON PER CITY OF SANTA ROSA STANDARDS 250A	15.	LANDSCAPING, SLAD	25.	CONCRETE VALLEY GUTTER, SEE 11/C9.1
4.	(E) POWER POLE TO BE RELOCATED, USP	16.	TREE, TYP, SLAD	26.	CONCRETE CURB & GUTTER, SEE 10/C9.1
5.	SIGN, SAD	17.	(E) TREE, TYP, PIP, UNO	27.	RAISED CONCRETE CURB, TYP SEE 9/C9.1
6.	GATE CONTROL & KNOX BOX, SAD	18.	(E) TREE TO BE REMOVED	28.	CURB CUT PER COSR STDS 250A
7.	KNOX BOX, SAD	19.	HATCH REPRESENTS LIMITS OF TRUNCATED DOMES SURFACING OVER PAVEMENT	29.	HATCH REPRESENTS LIMITS OF 5.5" THK CONC W/#4 BARS AT 16" OC EW, OVEREXCAVATION & RECOMPACTION PER SOILS REPORT
8.	GATE, SAD	20.	ACCESSIBLE PARKING (VAN STALL), SEE 12/C9.1	30.	4" GUARD POSTS, SEE 2/C9.1
9.	FENCE, SAD	21.	ACCESSIBLE PARKING SIGNAGE, SEE 14/C9.1	31.	FIRE HYDRANT, SEE UTILITY PLANS
10.	BIKE RACK, SAD	22.	UNAUTHORIZED PARKING SIGNAGE, SEE 15/C9.1	32.	BIORETENTION FACILITY, SEE 9/C9.1
11.	LIMITS OF ROOF OVERHANG, TYP, SAD			33.	RIPRAP OUTLET, TYP, SEE 5/C9.0
12.	SAWCUT AND CONFORM TO (E) GRADE			34.	(E) UTILITY STRUCTURE IN APRON, PIP, ADJUST LIDS TO FINISH GRADE
				35.	2" CURB CUT, TYP, SEE 13/C9.0
				36.	(E) DI, & 18" SD, PIP
				37.	REMOVE (E) DI AND ASSOCIATED PIPING.
				38.	(E) TOP OF CREEK BANK
				39.	(E) SWALE, PIP
				40.	(E) STORAGE CONTAINER, PIP
				41.	TRANSFORMER, SED
				42.	CONTROLLER GATE PAD, SAD
				43.	DRAIN INLET IN VALLEY GUTTER, SEE 11/C9.0
				44.	GUARD RAIL, SEE 12/C9.0
				45.	REQUIRED CLEARANCE FROM TRANSFORMER, TYP

NOTES:

- ALL CUTS AND FILL SLOPES SHALL BE PLANTED WITH EROSION RESISTANT VEGETATION UPON COMPLETION OF GRADING OR NO LATER THAN OCTOBER 1ST.
- LOCATIONS OF ALL UNDERGROUND UTILITIES ARE APPROXIMATE. CONTRACTOR TO VERIFY SIZE, LOCATION AND DEPTH IN FIELD PRIOR TO CONSTRUCTION.
- SUBGRADE PREPARATION PAVEMENT THICKNESS PER GEOTECHNICAL ENGINEER'S RECOMMENDATIONS.
- MODIFICATIONS TO ANY UTILITIES WITHIN THE CITY RIGHT OF WAY TO BE DONE UNDER A SEPARATE ENCROACHMENT PERMIT.
- SEE SHEET C1.1 FOR UTILITY STRUCTURE TABLE.
- DEMOLITION OF (E) BUILDING AND ASSOCIATED UTILITIES UNDER SEPARATE PERMIT.

GRADING & DRAINAGE LEGEND

EXISTING	NEW
OH (OH) OH (SD) STORM DRAIN (<10") (SD) STORM DRAIN (>10")	OH (OH) OH (SD) STORM DRAIN
MANHOLE OR SUMP FH PIV, CV, FDC VALVE	DRAINAGE STRUCTURE RIPRAP ENERGY DISSIPATOR
SPOT ELEVATION CONTOUR FENCE PROPERTY LINE EASEMENT	FH PIV, CV, FDC CONNECTION POINT CAP OR PLUG CLEANOUT DOWNSPOUT

ABBREVIATIONS:

AC	ASPHALT CONCRETE
AD	AREA DRAIN
APN	ASSESSOR'S PARCEL NUMBER
BASMAA	BAY AREA STORMWATER MANAGEMENT AGENCIES ASSOCIATION
BFE	BASE FLOOD ELEVATION
BLDG	BUILDING
BOT	BOTTOM
C	CENTERLINE
CONC	CONCRETE
DI	DRAIN INLET
DS	DOWNSPOUT
GB	GRADE BREAK
LD	LOWER LEVEL
LUD	LOW IMPACT DEVELOPMENT FACILITY
LU	LANDSCAPING
PD	PLANTER DRAIN
PIP	PROTECT IN PLACE
PW	PROCESS WASTE
SAD	SEE ARCHITECTURAL DRAWINGS
SB	SETBACK
SD	STORM DRAIN
SLAD	SEE LANDSCAPE ARCHITECTURAL DRAWINGS
SS	SANITARY SEWAGE
STD	STANDARD
TC	TOP OF CONCRETE
TD	TRENCH DRAIN
TG	TOP OF GRADE
TOW	TOP OF WALL
TYP	TYPICAL
TW	TRAVELED WAY
UL	UPPER LEVEL

DESIGN REVIEW NOTES:

- ALL CUTS AND FILL SLOPES SHALL BE PLANTED WITH EROSION RESISTANT VEGETATION UPON COMPLETION OF GRADING OR NO LATER THAN OCTOBER 1ST.
- LOCATIONS OF ALL UNDERGROUND UTILITIES ARE APPROXIMATE. CONTRACTOR TO VERIFY SIZE, LOCATION AND DEPTH IN FIELD PRIOR TO CONSTRUCTION.
- SUBGRADE PREPARATION PAVEMENT THICKNESS PER GEOTECHNICAL ENGINEER'S RECOMMENDATIONS.
- MODIFICATIONS TO ANY UTILITIES WITHIN THE CITY RIGHT OF WAY TO BE DONE UNDER A SEPARATE ENCROACHMENT PERMIT.
- SURFACE CONTOURS AND GROUND ELEVATIONS PER SURVEY FROM HOGAN LAND SERVICES DATED 2018 AND LIDAR DATA OBTAINED FROM SONOMA COUNTY VEGETATION MAPPING.
- PROJECT DATUM AND BENCHMARK:
6.1. HORIZONTAL CONTROL PER IRON PIPE FOUND IN THE CENTER OF PINER ROAD
6.2. VERTICAL CONTROL ELEVATION DATUM BASED ON A CITY OF SANTA ROSA BENCHMARK "089" (128.373) LOCATED IN THE INTERSECTION OF PINER ROAD AND AIRWAY DRIVE.


DATE	NO.	DESCRIPTION
2020-12-08	1	DESIGN REVIEW
2021-01-14	2	FINAL REVIEW
2021-05-06	3	DESIGN REVIEW COMMENTS
2021-06-13	4	DESIGN REVIEW RESUBMITTAL



PROJECT NO.: 20213
PROJECT MGR.: MS
DRAWN BY: TF
CHECKED BY: MS

Layout & Grading Plan

THIS DOCUMENT AND THE IDEAS AND DESIGNS INCORPORATED HEREIN, AS AN INSTRUMENT OF PROFESSIONAL SERVICE, IS THE PROPERTY OF SUMMIT ENGINEERING, INC. AND IS NOT TO BE USED IN WHOLE OR IN PART, FOR ANY OTHER PROJECT WITHOUT THE WRITTEN AUTHORIZATION OF SUMMIT ENGINEERING, INC.

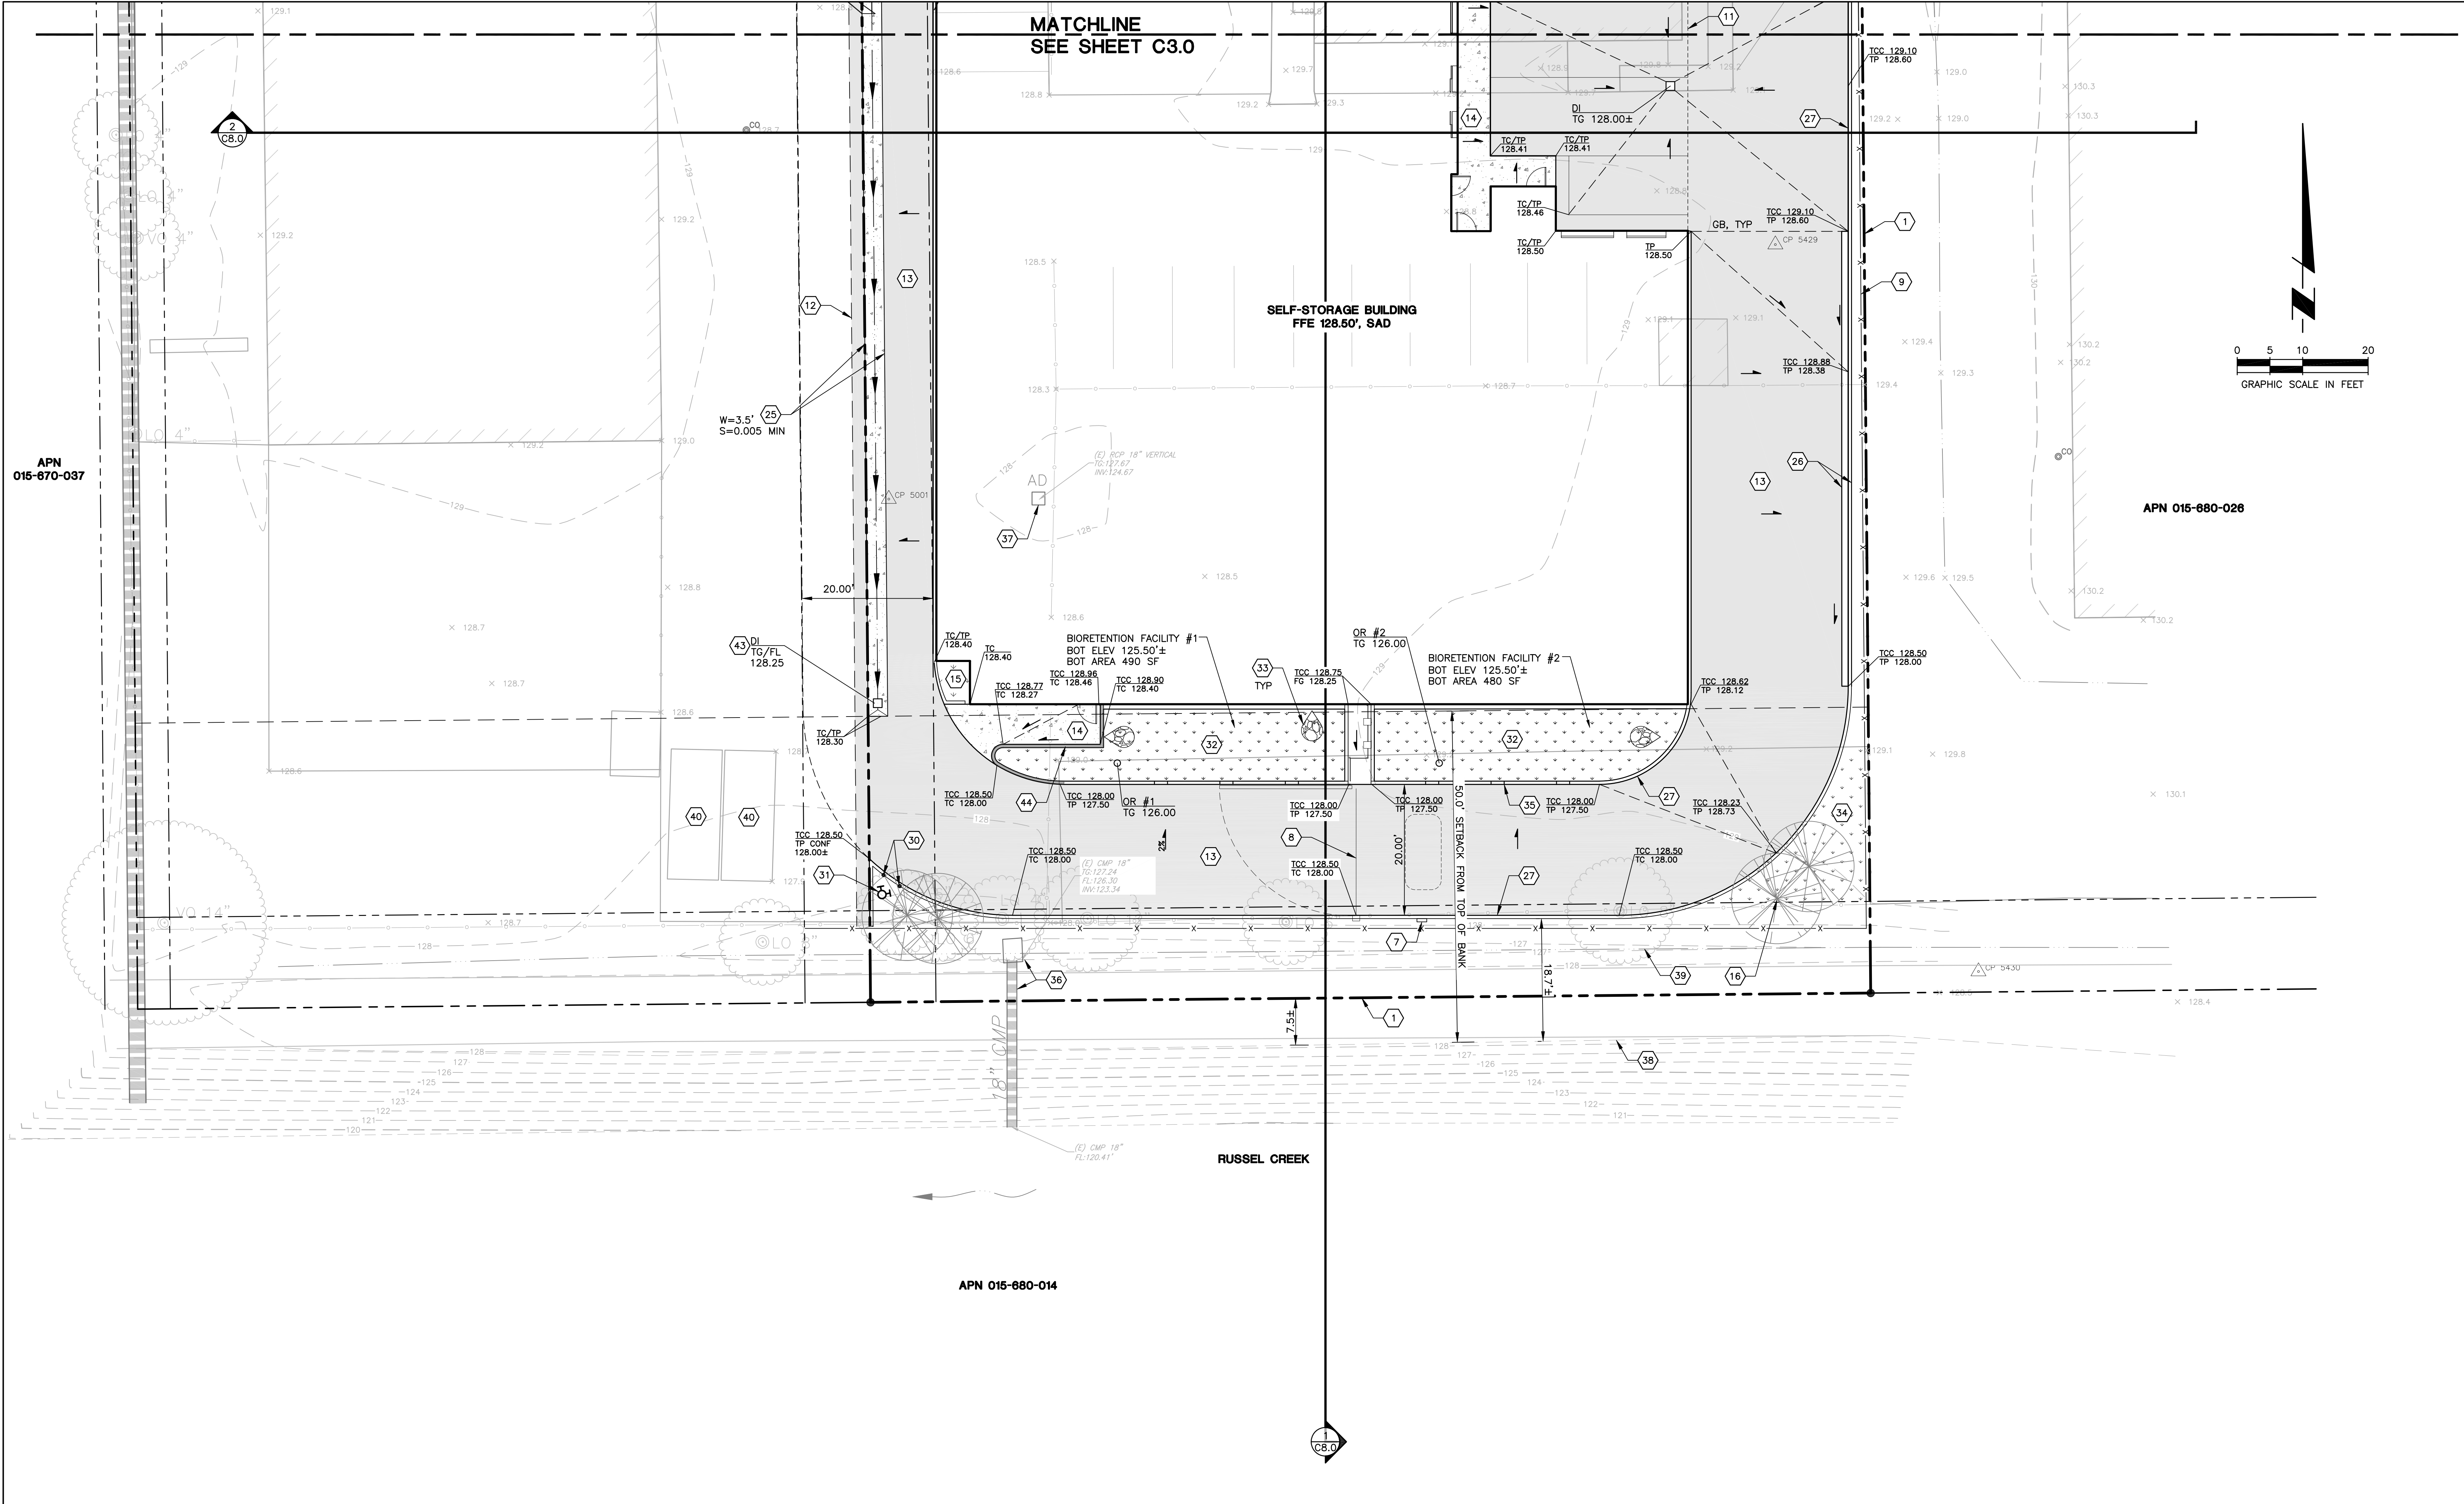


LAYOUT & GRADING KEY NOTES

#	DESCRIPTION	#	DESCRIPTION	#	DESCRIPTION
1.	APPROXIMATE PROPERTY LINE, TYP	13.	SHADING REPRESENTS LIMITS OF ASPHALT CONCRETE SURFACING, 3" AC OVER 12" CL 2 AB OR 3" AC OVER 6" CL 2 AB OVER 12" AGG SUBBASE, TI=5.5, OVEREXCAVATION & RECOMPACTION PER SOILS REPORT	23.	WHEEL STOP, SEE 16/C9.1
2.	(E) DRIVEWAY APRON	14.	HATCH REPRESENTS LIMITS OF CONC SIDEWALK, SEE DETAIL 8/C9.1	24.	PAVEMENT STRIPING, TYP
3.	DRIVEWAY APRON PER CITY OF SANTA ROSA STANDARDS 250A	15.	LANDSCAPING, SLAD	25.	CONCRETE VALLEY GUTTER, SEE 11/C9.1
4.	(E) POWER POLE TO BE RELOCATED, USP	16.	TREE, TYP, SLAD	26.	CONCRETE CURB & GUTTER, SEE 10/C9.1
5.	SIGN, SAD	17.	(E) TREE, TYP, PIP, UNO	27.	RAISED CONCRETE CURB, TYP SEE 9/C9.1
6.	GATE CONTROL & KNOX BOX, SAD	18.	(E) TREE TO BE REMOVED	28.	CURB CUT PER COSR STDS 250A
7.	KNOX BOX, SAD	19.	HATCH REPRESENTS LIMITS OF TRUNCATED DOMES SURFACING OVER PAVEMENT	29.	HATCH REPRESENTS LIMITS OF 5.5" THK CONC W/#4 BARS AT 16" OC EW, OVEREXCAVATION & RECOMPACTION PER SOILS REPORT
8.	GATE, SAD	20.	ACCESSIBLE PARKING (VAN STALL), SEE 12/C9.1	30.	4" GUARD POSTS, SEE 2/C9.1
9.	FENCE, SAD	21.	ACCESSIBLE PARKING SIGNAGE, SEE 14/C9.1	31.	FIRE HYDRANT, SEE UTILITY PLANS
10.	BIKE RACK, SAD	22.	UNAUTHORIZED PARKING SIGNAGE, SEE 15/C9.1	32.	BIORETENTION FACILITY, SEE 9/C9.1
11.	LIMITS OF ROOF OVERHANG, TYP, SAD			33.	RIPRAP OUTLET, TYP, SEE 5/C9.0
12.	SAWCUT AND CONFORM TO (E) GRADE			34.	(E) UTILITY STRUCTURE IN APRON, PIP, ADJUST LIDS TO FINISH GRADE
				35.	2" CURB CUT, TYP, SEE 13/C9.0
				36.	(E) DI, & 18" SD, PIP
				37.	REMOVE (E) DI AND ASSOCIATED PIPING.
				38.	(E) TOP OF CREEK BANK
				39.	(E) SWALE, PIP
				40.	(E) STORAGE CONTAINER, PIP
				41.	TRANSFORMER, SED
				42.	CONTROLLER GATE PAD, SAD
				43.	DRAIN INLET IN VALLEY GUTTER, SEE 11/C9.0
				44.	GUARD RAIL, SEE 12/C9.0
				45.	REQUIRED CLEARANCE FROM TRANSFORMER, TYP

NOTES:

- ALL CUTS AND FILL SLOPES SHALL BE PLANTED WITH EROSION RESISTANT VEGETATION UPON COMPLETION OF GRADING OR NO LATER THAN OCTOBER 1ST.
- LOCATIONS OF ALL UNDERGROUND UTILITIES ARE APPROXIMATE. CONTRACTOR TO VERIFY SIZE, LOCATION AND DEPTH IN FIELD PRIOR TO CONSTRUCTION.
- SUBGRADE PREPARATION PAVEMENT THICKNESS PER GEOTECHNICAL ENGINEER'S RECOMMENDATIONS.
- MODIFICATIONS TO ANY UTILITIES WITHIN THE CITY RIGHT OF WAY TO BE DONE UNDER A SEPARATE ENCROACHMENT PERMIT.
- SEE SHEET C1.1 FOR UTILITY STRUCTURE TABLE.
- DEMOLITION OF (E) BUILDING AND ASSOCIATED UTILITIES UNDER SEPARATE PERMIT.

GRADING & DRAINAGE LEGEND

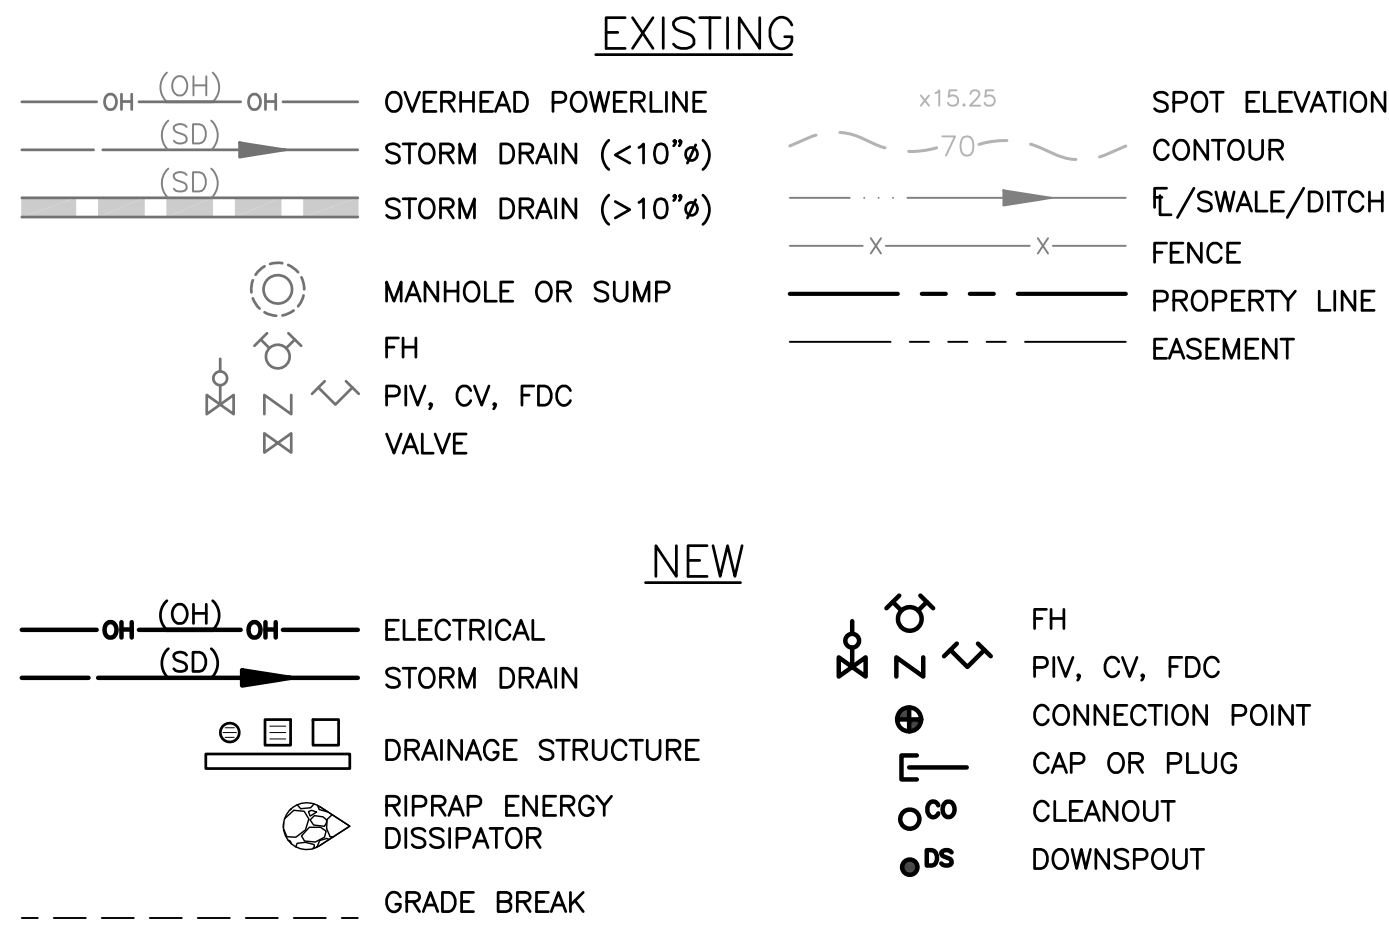

ABBREVIATIONS:

AC	ASPHALT CONCRETE
AD	AREA DRAIN
APN	ASSESSOR'S PARCEL NUMBER
BASMAA	BAY AREA STORMWATER MANAGEMENT AGENCIES ASSOCIATION
BFE	BAY AREA STORMWATER MANAGEMENT AGENCIES ASSOCIATION
BLDG	BUILDING
BOT	BOTTOM
CB	CATCH BASIN
CONC	CONCRETE
DI	DRAIN INLET
DS	DRAINAGE STRUCTURE
(E)	EXISTING
FF	FINISH FLOOR
FH	FIRE HYDRANT
GB	GRADE BREAK
LIDF	LOW IMPACT DEVELOPMENT FACILITY
LL	LOWER LEVEL
PD	PLANTER DRAIN
PIP	PROTECT IN PLACE
PW	PROCESS WASTE
SAD	SEE ARCHITECTURAL DRAWINGS
SB	SETBACK
SD	STORM DRAIN
SLAD	SEE LANDSCAPE ARCHITECTURAL DRAWINGS
SS	SANITARY SEWAGE
STD	STANDARD
TC	TOP OF CONCRETE
TD	TRENCH DRAIN
TP	TOP OF GRADE
TOW	TOP OF WALL
TYP	TYPICAL
TW	TRAVELED WAY
UL	UPPER LEVEL

DESIGN REVIEW NOTES:

- ALL CUTS AND FILL SLOPES SHALL BE PLANTED WITH EROSION RESISTANT VEGETATION UPON COMPLETION OF GRADING OR NO LATER THAN OCTOBER 1ST.
- LOCATIONS OF ALL UNDERGROUND UTILITIES ARE APPROXIMATE. CONTRACTOR TO VERIFY SIZE, LOCATION AND DEPTH IN FIELD PRIOR TO CONSTRUCTION.
- SUBGRADE PREPARATION PAVEMENT THICKNESS PER GEOTECHNICAL ENGINEER'S RECOMMENDATIONS.
- MODIFICATIONS TO ANY UTILITIES WITHIN THE CITY RIGHT OF WAY TO BE DONE UNDER A SEPARATE ENCROACHMENT PERMIT.
- SURFACE CONTOURS AND GROUND ELEVATIONS PER SURVEY FROM HOGAN LAND SERVICES DATED 2018 AND LIDAR DATA OBTAINED FROM SONOMA COUNTY VEGETATION MAPPING.
- PROJECT DATUM AND BENCHMARK: 6.1. HORIZONTAL CONTROL PER IRON PIPE FOUND IN THE CENTER OF PINER ROAD 6.2. VERTICAL CONTROL ELEVATION DATUM BASED ON A CITY OF SANTA ROSA BENCHMARK "089" (128.373) LOCATED IN THE INTERSECTION OF PINER ROAD AND AIRWAY DRIVE.

DATE	NO.	DESCRIPTION
2020-12-08	1	DESIGN REVIEW
2021-05-06	2	FINAL REVIEW
2021-05-06	3	DESIGN REVIEW COMMENTS
2021-05-13	4	DESIGN REVIEW RESUBMITTAL






PROJECT NO.: 20213
PROJECT MGR.: MS
DRAWN BY: TF
CHECKED BY: MS

Layout &
Grading Plan


[illegible]

PROJECT NO.:	20213
PROJECT MGR.:	MS
DRAWN BY:	TF
CHECKED BY:	MS

C8.0

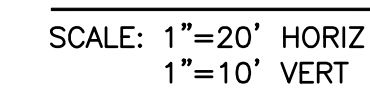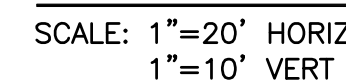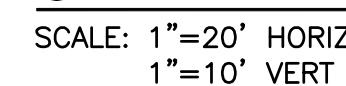

THIS DOCUMENT AND THE IDEAS AND DESIGNS INCORPORATED HEREIN, AS AN INSTRUMENT OF PROFESSIONAL SERVICE, IS THE PROPERTY OF SUMMIT ENGINEERING, INC. AND IS NOT TO BE USED IN WHOLE OR IN PART, FOR ANY OTHER PROJECT WITHOUT THE WRITTEN AUTHORIZATION OF SUMMIT ENGINEERING, INC.

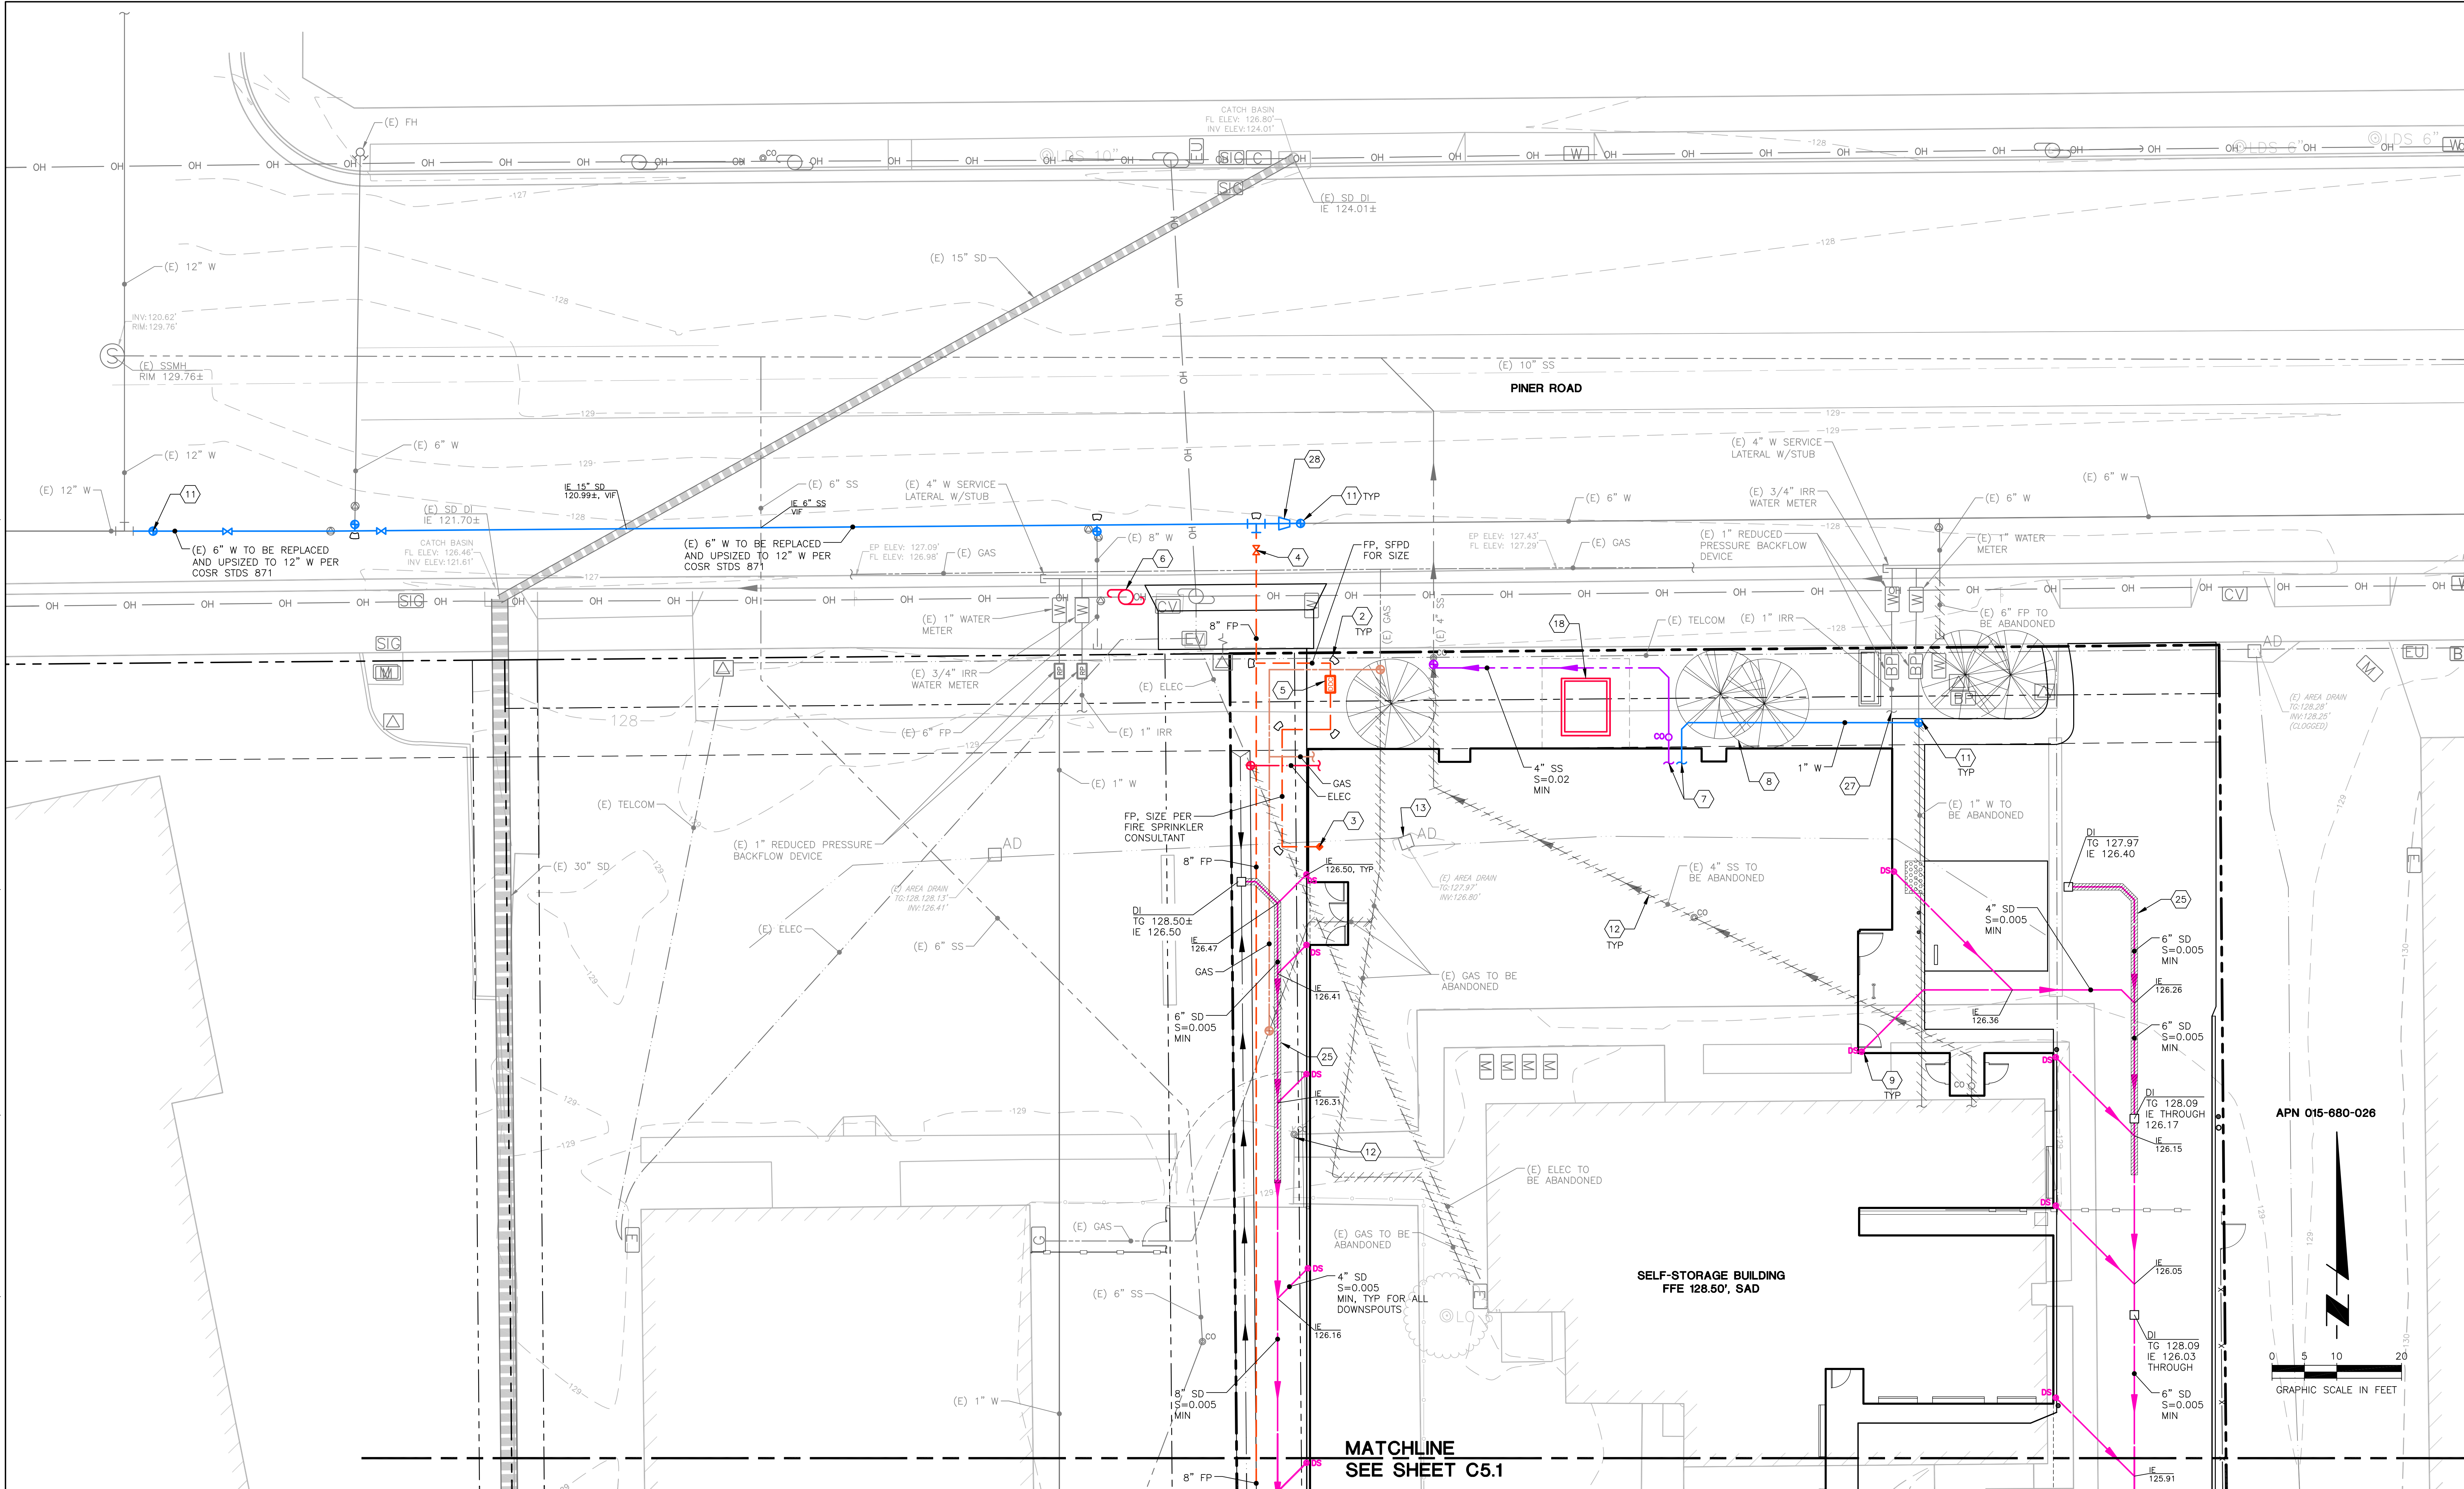

UTILITY KEY NOTES

#	DESCRIPTION	#	DESCRIPTION	#	DESCRIPTION
1.	FIRE HYDRANT SEE 1/C9.1	10.	CONNECT TO BUILDING UNDERSLAB DRAINAGE, BY OTHERS, INVERT TO BE VERIFIED IN FIELD AND TO BE ABOVE THE INVERT OF THE SD FROM THE OVERFLOW RISER	18.	TRANSFORMER, SED
2.	ANTICIPATED FIRE PROTECTION THRUST BLOCK LOCATION, SEE 3/C9.1 AND PER COSR STDS 854 WITHIN CITY ROW	11.	CONNECT TO (E) UTILITY OR UTILITY STRUCTURE (VERIFY SIZE, LOCATION AND ELEVATION PRIOR TO START OF CONSTRUCTION)	19.	WALL BACK DRAIN HIGH POINT, S=0.01 MIN TO DRAIN PER SOILS REPORT
3.	FIRE SPRINKLER RISER, SPD	12.	ABANDON (E) UTILITY, TYP	25.	CONCRETE CAP FOR SD WITH LESS THAN 2' MIN DEPTH OF BURY, TYP ALL STORM DRAIN PIPES, SEE 18/C9.1
4.	GATE VALVE W/ VALVE BOX, SEE 4/C9.1 AND PER COSR STDS 877 WITHIN CITY ROW	13.	REMOVE (E) DI AND ASSOCIATED PIPING, PLUG PIPE ENDS WITH CONCRETE OR REMOVE AS NECESSARY	26.	SAD AND SSD FOR WATER PROOFING BETWEEN BUILDING FOUNDATION AND BIORETENTION FACILITY
5.	DOUBLE CHECK DETECTOR FIRE LINE BACKFLOW ASSEMBLY PER COSR STDS 880	14.	BIORETENTION FACILITY, SEE 9/C9.0	27.	SLAD FOR CONTINUATION FOR THE IRRIGATION SYSTEM
6.	(E) POWER POLE TO BE RELOCATED, USP, SED	15.	RIPRAP OUTLET, SEE 5/C9.0	28.	12" x 6" REDUCER
7.	FOR CONTINUATION OF UTILITY INTO BUILDING SPD	16.	CURB CUT, TYP		
9.	DOWNSPOUT, CONNECT TO STORM DRAIN, SEE 7/C9.1	17.	ADJUST EXISTING UTILITY COVER, TO FINISH GRADE		

NOTES:

- SEE SHEET C1.1 FOR UTILITY STRUCTURE TABLE.
- THRUST BLOCKS SHALL BE INSTALLED FOR ALL UN RESTRAINED PRESSURE PIPE FITTINGS INCLUDING W, FP, PW, SS & SD.
- HORIZONTAL PIPE BENDS SHOWN ARE 45° OR 90°, UNO, 22-1/2°, 11-1/4° OR COMBO ARE CALLED OUT ON PLANS.
- IMPROVEMENTS WITHIN CITY RIGHT OF WAY TO BE UNDER A SEPARATE ENCROACHMENT PERMIT.

UTILITY LEGEND

EXISTING	NEW
(E/ELEC) ELECTRICAL	(E/ELEC) ELECTRICAL
(FP) FIRE PROTECTION	(FP) FIRE PROTECTION
(G) GAS	(G) GAS
(IRR) IRRIGATION	(IRR) IRRIGATION
(OH) OVERHEAD POWERLINE	(OH) OVERHEAD POWERLINE
(SD) STORM DRAIN (<10'')	(SD) STORM DRAIN (<10'')
(SS) STORM DRAIN (>10'')	(SS) STORM DRAIN (>10'')
(TEL) TELEPHONE LINE	(TEL) TELEPHONE LINE
(W) WATER LINE	(W) WATER LINE
REMOVE OR ABANDON	REMOVE OR ABANDON
	MANHOLE
	PV, CV, FDC
	VALVE
	DRAINAGE STRUCTURE
	CLEANOUT
	DOWNSPOUT
	RIPRAP ENERGY DISSIPATOR
	STANDARD
	TOP OF CONCRETE
	TRENCH DRAIN
	TOP OF GRATE
	TOP OF WALL
	TOP OF PAVEMENT
	TYP
	UPPER LEVEL

ABBREVIATIONS:

AC	ASPHALT CONCRETE
AD	AREA DRAIN
APN	ASSESSOR'S PARCEL NUMBER
BASMA	BAY AREA STORMWATER MANAGEMENT AGENCIES ASSOCIATION
BFE	BASE FLOOD ELEVATION
BLDG	BUILDING
CONC	CONCRETE
DI	DRAIN INLET
DS	DRAIN INLET
EXIST	EXISTING
FF	FINISH FLOOR
FB	FIRE HYDRANT
GB	GRADE BREAK
LDF	LOW IMPACT DEVELOPMENT FACILITY
LL	LOWER LEVEL
PD	PLANTER DRAIN
PDP	PROTECT IN PLACE
PW	PROCESS WASTE
SB	SEE ARCHITECTURAL DRAWINGS
SD	STORM DRAIN
SLAD	SEE LANDSCAPE ARCHITECTURAL DRAWINGS
STD	STANDARD
TC	TOP OF CONCRETE
TD	TRENCH DRAIN
TOW	TOP OF WALL
TP	TOP OF PAVEMENT
UL	UPPER LEVEL

DESIGN REVIEW NOTES:

- ALL CUTS AND FILL SLOPES SHALL BE PLANTED WITH EROSION RESISTANT VEGETATION UPON COMPLETION OF GRADING OR NO LATER THAN OCTOBER 1ST.
- LOCATIONS OF ALL UNDERGROUND UTILITIES ARE APPROXIMATE. CONTRACTOR TO VERIFY SIZE, LOCATION AND DEPTH IN FIELD PRIOR TO CONSTRUCTION.
- SUBGRADE PREPARATION PAVEMENT THICKNESS PER GEOTECHNICAL ENGINEER'S RECOMMENDATIONS.
- MODIFICATIONS TO ANY UTILITIES WITHIN THE CITY RIGHT OF WAY TO BE DONE UNDER A SEPARATE ENCROACHMENT PERMIT.
- SURFACE CONTOURS AND GROUND ELEVATIONS PER SURVEY FROM HOGAN LAND SERVICES DATED 2018 AND LIDAR DATA OBTAINED FROM SONOMA COUNTY VEGETATION MAPPING.
- PROJECT DATUM AND BENCHMARK:
6.1. HORIZONTAL CONTROL PER IRON PIPE FOUND IN THE CENTER OF PINER ROAD
6.2. VERTICAL CONTROL ELEVATION DATUM BASED ON A CITY OF SANTA ROSA BENCHMARK "089" (128.373) LOCATED IN THE INTERSECTION OF PINER ROAD AND AIRWAY DRIVE.


DATE	NO.	DESCRIPTION
2020-12-08	1	DESIGN REVIEW
2021-01-14	2	FINAL REVIEW
2021-06-08	3	DESIGN REVIEW COMMENTS
2021-06-13	4	DESIGN REVIEW RESUBMITTAL



PROJECT NO.:	20213
PROJECT MGR.:	MS
DRAWN BY:	TF
CHECKED BY:	MS

Utility Plan

THIS DOCUMENT AND THE IDEAS AND DESIGNS INCORPORATED HEREIN, AS AN INSTRUMENT OF PROFESSIONAL SERVICE, IS THE PROPERTY OF SUMMIT ENGINEERING, INC. AND IS NOT TO BE USED IN WHOLE OR IN PART, FOR ANY OTHER PROJECT WITHOUT THE WRITTEN AUTHORIZATION OF SUMMIT ENGINEERING, INC.

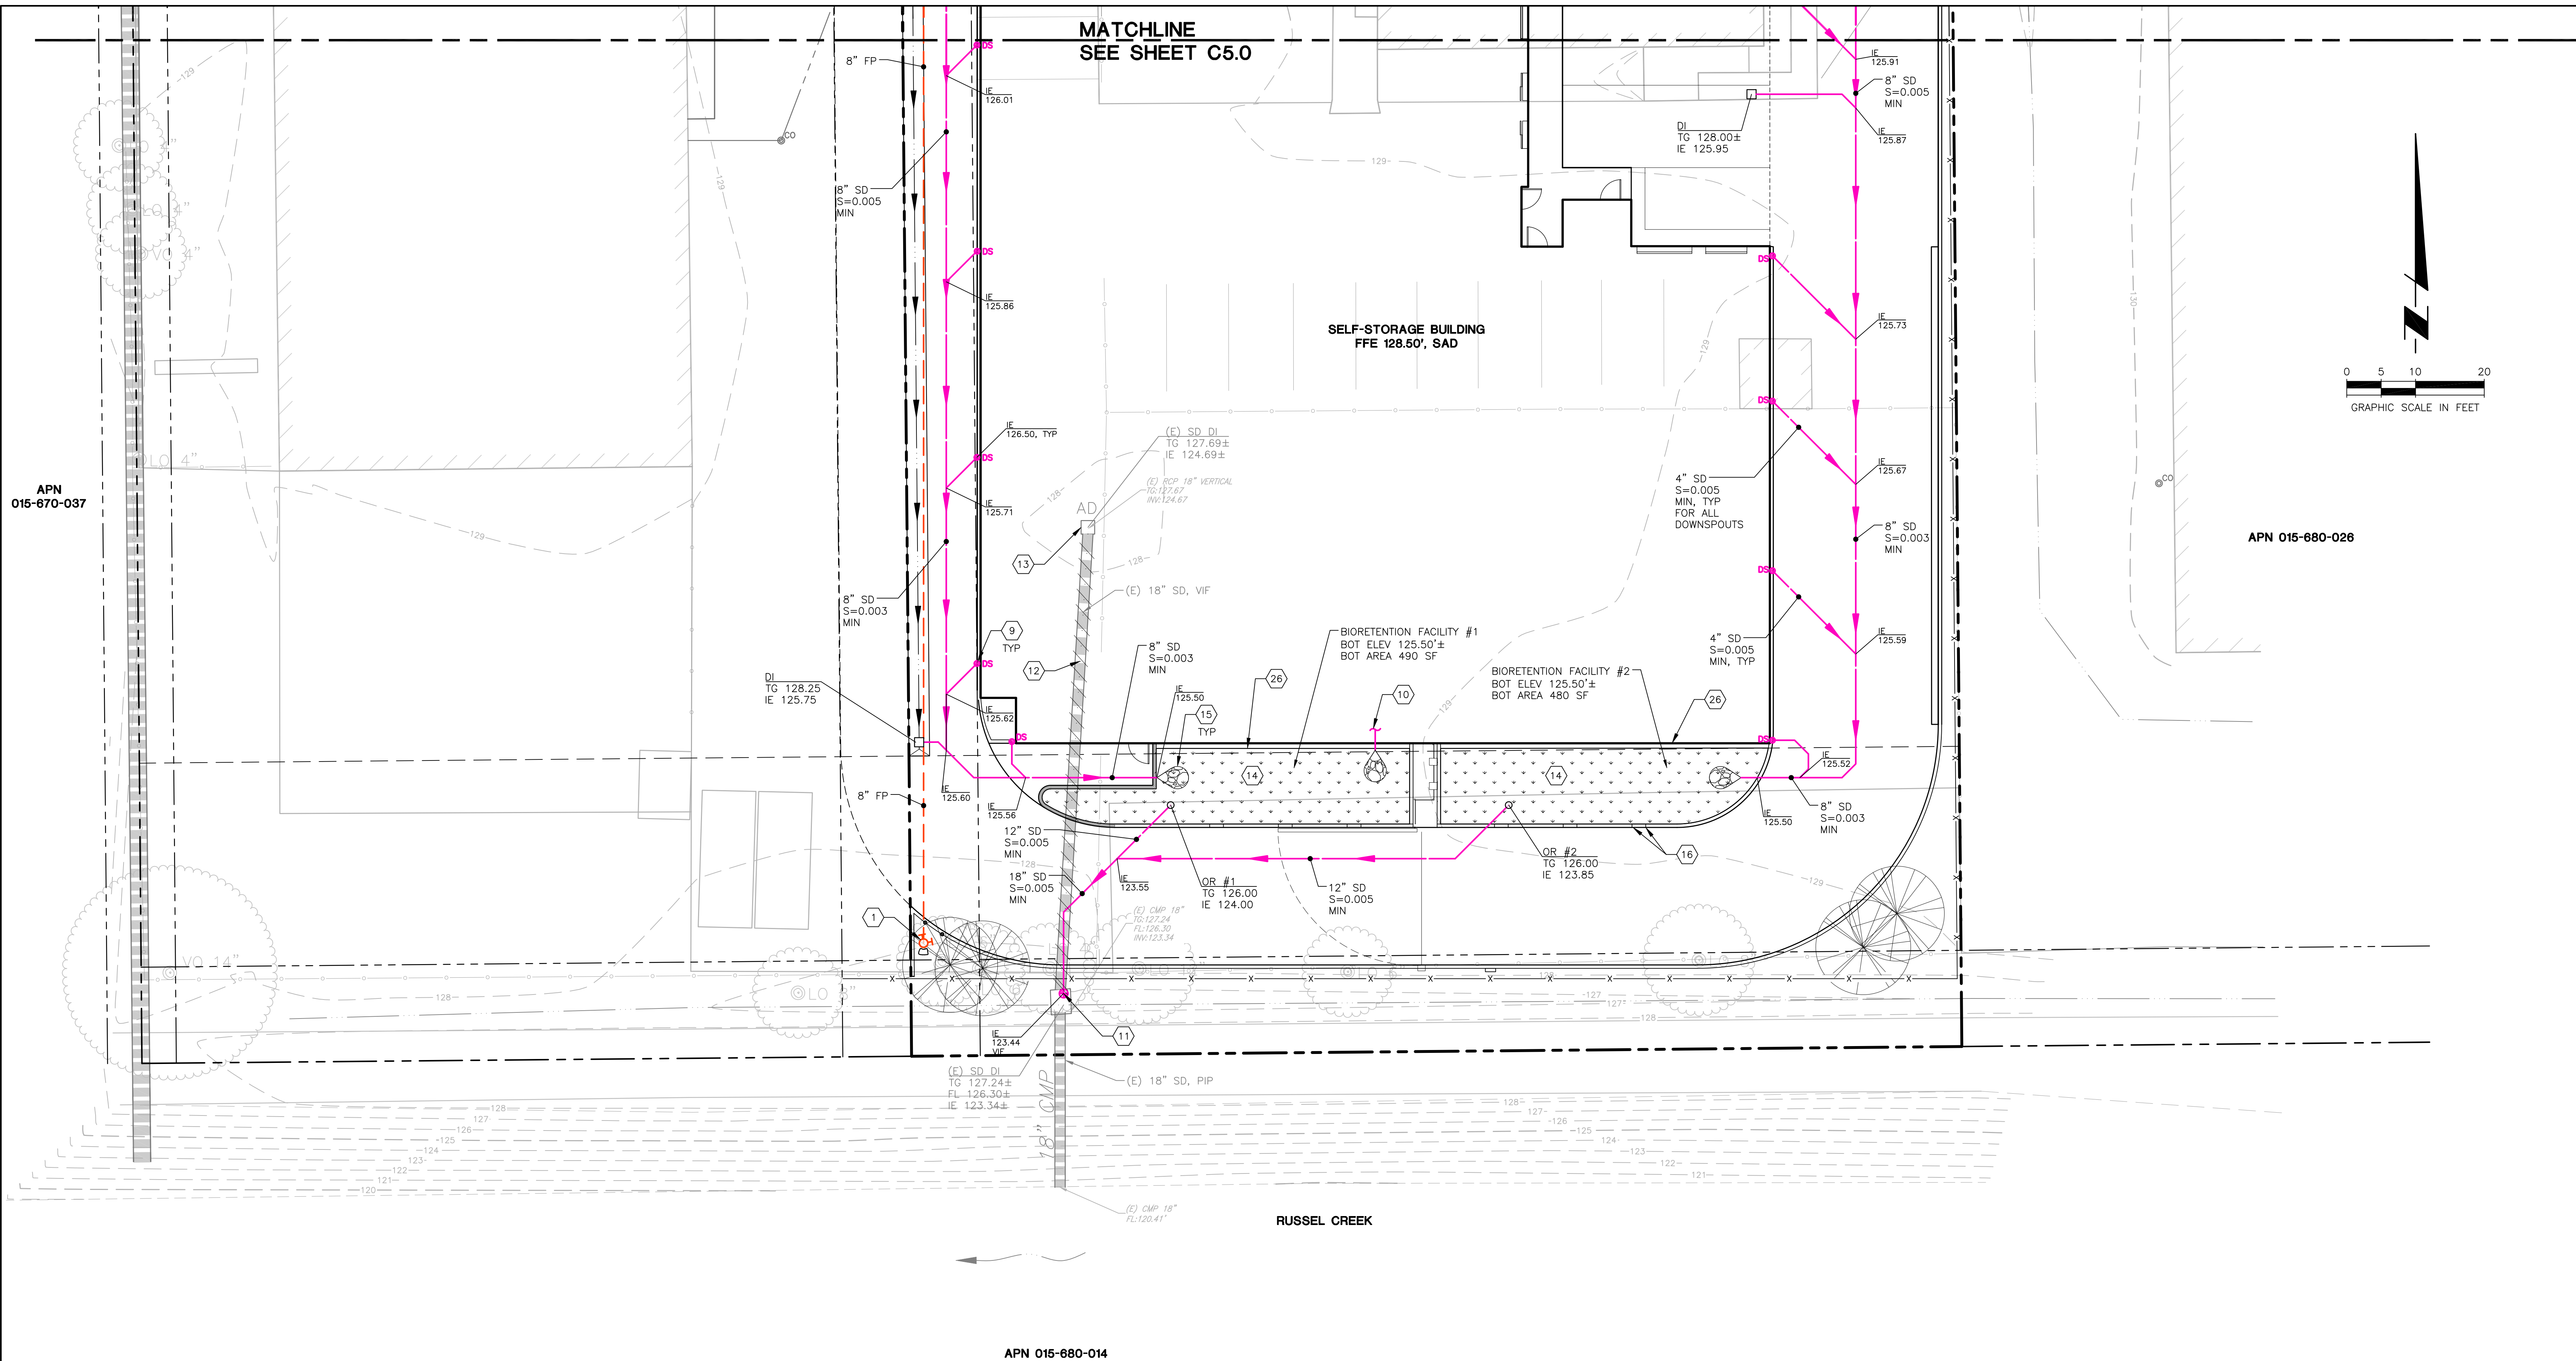

UTILITY KEY NOTES

#	DESCRIPTION	#	DESCRIPTION	#	DESCRIPTION
1.	FIRE HYDRANT SEE 1/C9.1	10.	CONNECT TO BUILDING UNDERSLAB DRAINAGE, BY OTHERS, INVERT TO BE VERIFIED IN FIELD AND TO BE ABOVE THE INVERT OF THE SD FROM THE OVERFLOW RISER	18.	TRANSFORMER, SED
2.	ANTICIPATED FIRE PROTECTION THRUST BLOCK LOCATION, SEE 3/C9.1 AND PER COSR STDS 854 WITHIN CITY ROW	11.	CONNECT TO (E) UTILITY OR UTILITY STRUCTURE (VERIFY SIZE, LOCATION AND ELEVATION PRIOR TO START OF CONSTRUCTION)	19.	WALL BACK DRAIN HIGH POINT, S=0.01 MIN TO DRAIN PER SOILS REPORT
3.	FIRE SPRINKLER RISER, SPD	12.	ABANDON (E) UTILITY, TYP	25.	CONCRETE CAP FOR SD WITH LESS THAN 2' MIN DEPTH OF BURY, TYP ALL STORM DRAIN PIPES, SEE 18/C9.1
4.	GATE VALVE W/ VALVE BOX, SEE 4/C9.1 AND PER COSR STDS 877 WITHIN CITY ROW	13.	REMOVE (E) DI AND ASSOCIATED PIPING, PLUG PIPE ENDS WITH CONCRETE OR REMOVE AS NECESSARY	26.	SAD AND SSD FOR WATER PROOFING BETWEEN BUILDING FOUNDATION AND BIORETENTION FACILITY
5.	DOUBLE CHECK DETECTOR FIRE LINE BACKFLOW ASSEMBLY PER COSR STDS 880	14.	BIORETENTION FACILITY, SEE 9/C9.0	27.	SLAD FOR CONTINUATION FOR THE IRRIGATION SYSTEM
6.	(E) POWER POLE TO BE RELOCATED, USP, SED	15.	RIPRAP OUTLET, SEE 5/C9.0	28.	12" x 6" REDUCER
7.	FOR CONTINUATION OF UTILITY INTO BUILDING SPD	16.	CURB CUT, TYP		
8.	CLEANOUT, SEE 6/C9.1	17.	ADJUST EXISTING UTILITY COVER, TO FINISH GRADE		
9.	DOWNSPOUT, CONNECT TO STORM DRAIN, SEE 7/C9.1				

NOTES:

- SEE SHEET C1.1 FOR UTILITY STRUCTURE TABLE.
- THRUST BLOCKS SHALL BE INSTALLED FOR ALL UN RESTRAINED PRESSURE PIPE FITTINGS INCLUDING W, FP, PW, SS & SD.
- HORIZONTAL PIPE BENDS SHOWN ARE 45° OR 90°, UNO, 22-1/2°, 11-1/4° OR COMBO ARE CALLED OUT ON PLANS.
- IMPROVEMENTS WITHIN CITY RIGHT OF WAY TO BE UNDER A SEPARATE ENCROACHMENT PERMIT.

UTILITY LEGEND

EXISTING	NEW
(E/ELEC) ELECTRICAL	(E/ELEC) ELECTRICAL
(FP) FIRE PROTECTION	(FP) FIRE PROTECTION
(G) GAS	(G) GAS
(IRR) IRRIGATION	(IRR) IRRIGATION
(OH) OVERHEAD POWERLINE	(OH) OVERHEAD POWERLINE
(SD) STORM DRAIN	(SD) STORM DRAIN
(SS) SANITARY SEWER	(SS) SANITARY SEWER
(T/TEL) TELEPHONE LINE	(T/TEL) TELEPHONE LINE
(W) WATER LINE	(W) WATER LINE
REMOVE OR ABANDON	REMOVE OR ABANDON
	FH PIV, CV, FDC
	SPRINKLER RISER
	THRUSTBLOCK
	HOSE BIBB
	CONNECTION POINT
	CAP OR PLUG
	CHECK VALVE
	GATE VALVE
	REDUCER/ENLARGER
	DRAINAGE STRUCTURE
	CLEANOUT
	DOWNSPOUT
	RIPRAP ENERGY DISSIPATOR

ABBREVIATIONS:

AC	ASPHALT CONCRETE
AD	AREA DRAIN
APN	ASSESSOR'S PARCEL NUMBER
BASMA	BAY AREA STORMWATER MANAGEMENT AGENCIES ASSOCIATION
BFE	BASE FLOOD ELEVATION
BLDG	BUILDING
BOT	BOTTOM
C	CENTERLINE
CONC	CONCRETE
DI	DRAIN INLET
DS	DOWNSPOUT
(E)	EXISTING
FF	FINISH FLOOR
FH	FIRE HYDRANT
GB	GRADE BREAK
LDF	LOW IMPACT DEVELOPMENT FACILITY
LL	LOWER LEVEL
PD	PLANTER DRAIN
PIP	PROTECT IN PLACE
PW	PROCESS WASTE
SAD	SEE ARCHITECTURAL DRAWINGS
SB	SETBACK
SD	STORM DRAIN
SS	SEE LANDSCAPE ARCHITECTURAL DRAWINGS
STD	SANITARY SEWAGE STANDARD
TC	TOP OF CONCRETE
TO	TRENCH DRAIN
TD	TOP OF DRAIN
TOW	TOP OF WALL
TP	TOP OF PAVEMENT
TYP	TYPICAL
UL	UPPER LEVEL

DESIGN REVIEW NOTES:


- ALL CUTS AND FILL SLOPES SHALL BE PLANTED WITH EROSION RESISTANT VEGETATION UPON COMPLETION OF GRADING OR NO LATER THAN OCTOBER 1ST.
- LOCATIONS OF ALL UNDERGROUND UTILITIES ARE APPROXIMATE. CONTRACTOR TO VERIFY SIZE, LOCATION AND DEPTH IN FIELD PRIOR TO CONSTRUCTION.
- SUBGRADE PREPARATION PAVEMENT THICKNESS PER GEOTECHNICAL ENGINEER'S RECOMMENDATIONS.
- MODIFICATIONS TO ANY UTILITIES WITHIN THE CITY RIGHT OF WAY TO BE DONE UNDER A SEPARATE ENCROACHMENT PERMIT.
- SURFACE CONTOURS AND GROUND ELEVATIONS PER SURVEY FROM HOGAN LAND SERVICES DATED 2018 AND LIDAR DATA OBTAINED FROM SONOMA COUNTY VEGETATION MAPPING.
- PROJECT DATUM AND BENCHMARK: 6.1. HORIZONTAL CONTROL PER IRON PIPE FOUND IN THE CENTER OF PINER ROAD 6.2. VERTICAL CONTROL ELEVATION DATUM BASED ON A CITY OF SANTA ROSA BENCHMARK "089" (128.373) LOCATED IN THE INTERSECTION OF PINER ROAD AND AIRWAY DRIVE.

DATE	NO.	DESCRIPTION
2020-12-08	1	DESIGN REVIEW
2021-01-14	2	FINAL
2021-06-06	3	DESIGN REVIEW COMMENTS
2021-06-13	4	DESIGN REVIEW RESUBMITTAL




PROJECT NO.:	20213
PROJECT MGR.:	MS
DRAWN BY:	TF
CHECKED BY:	MS


Utility Plan

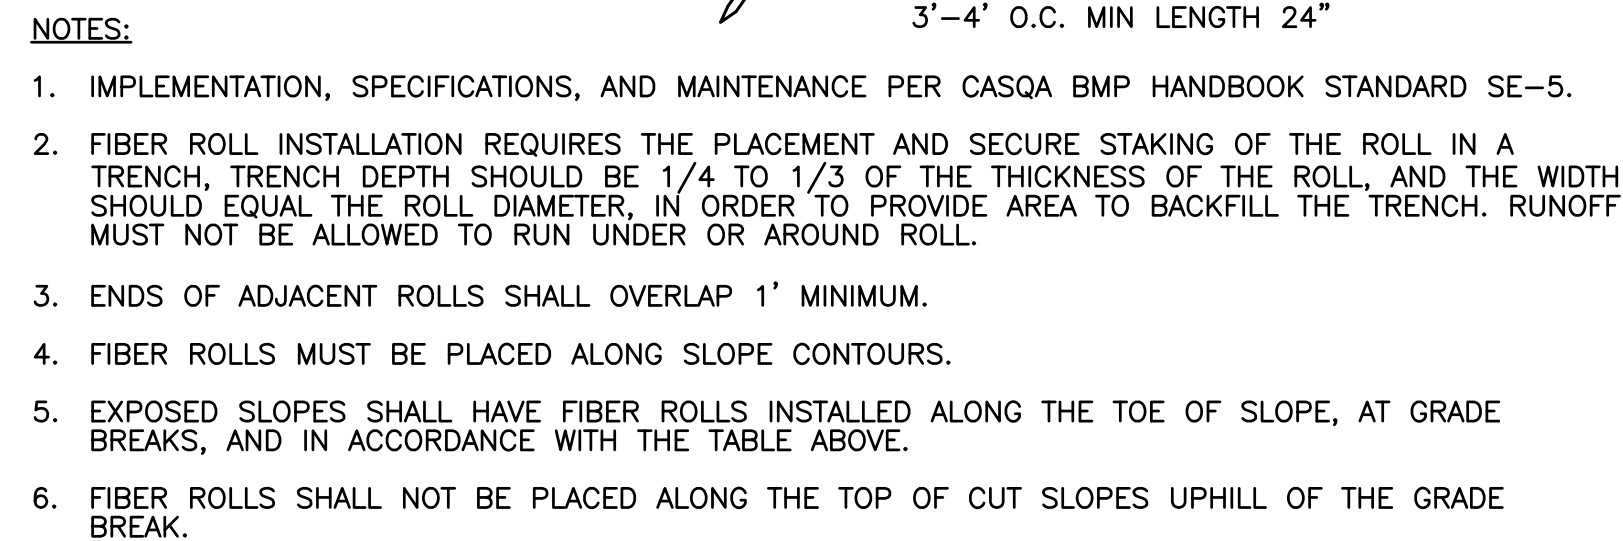


NTS ER013

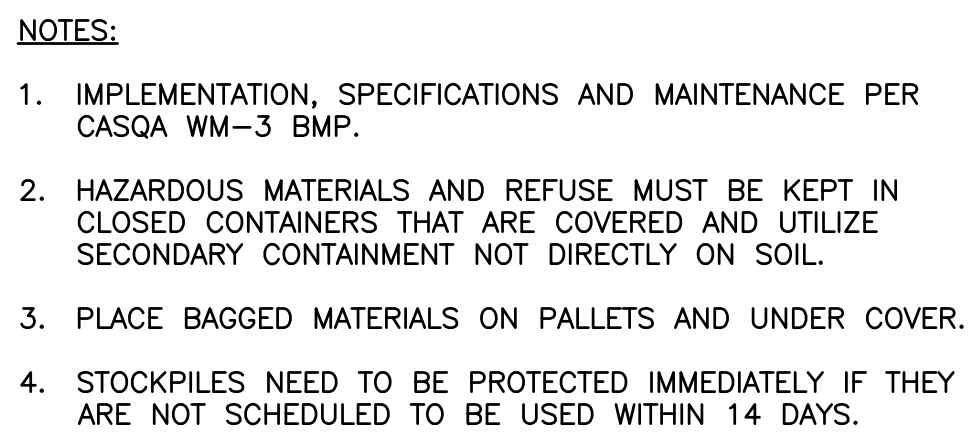


NTS ER025

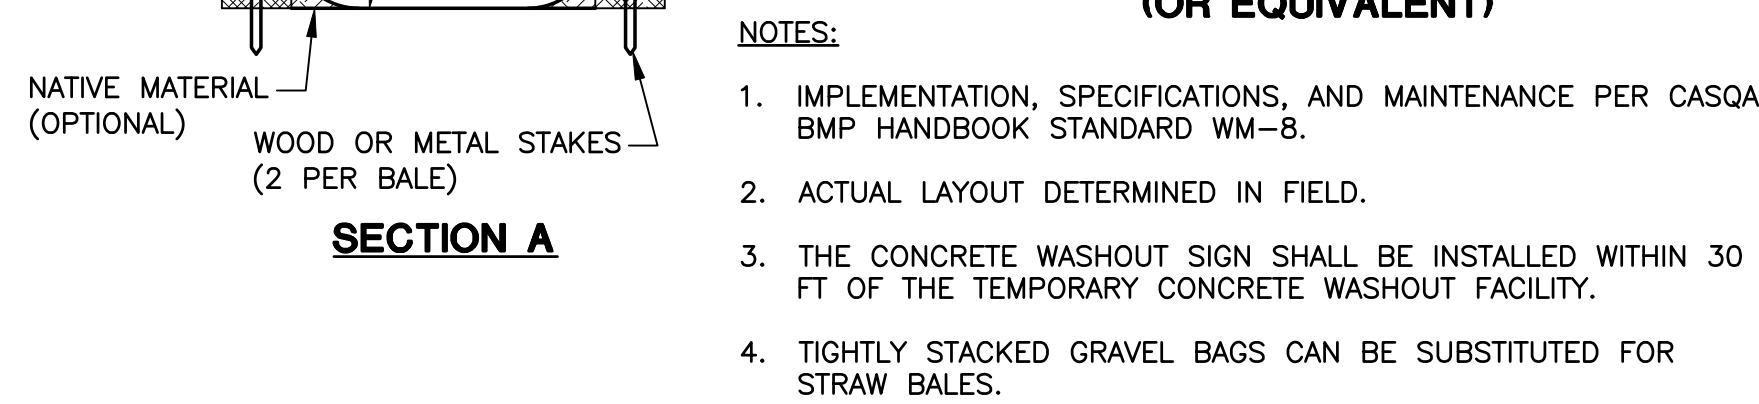

NTS ER019 2

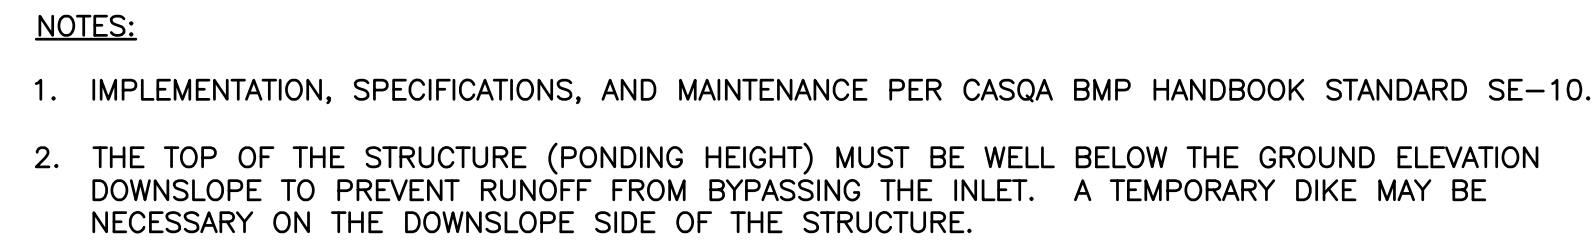


NTS ER023 3

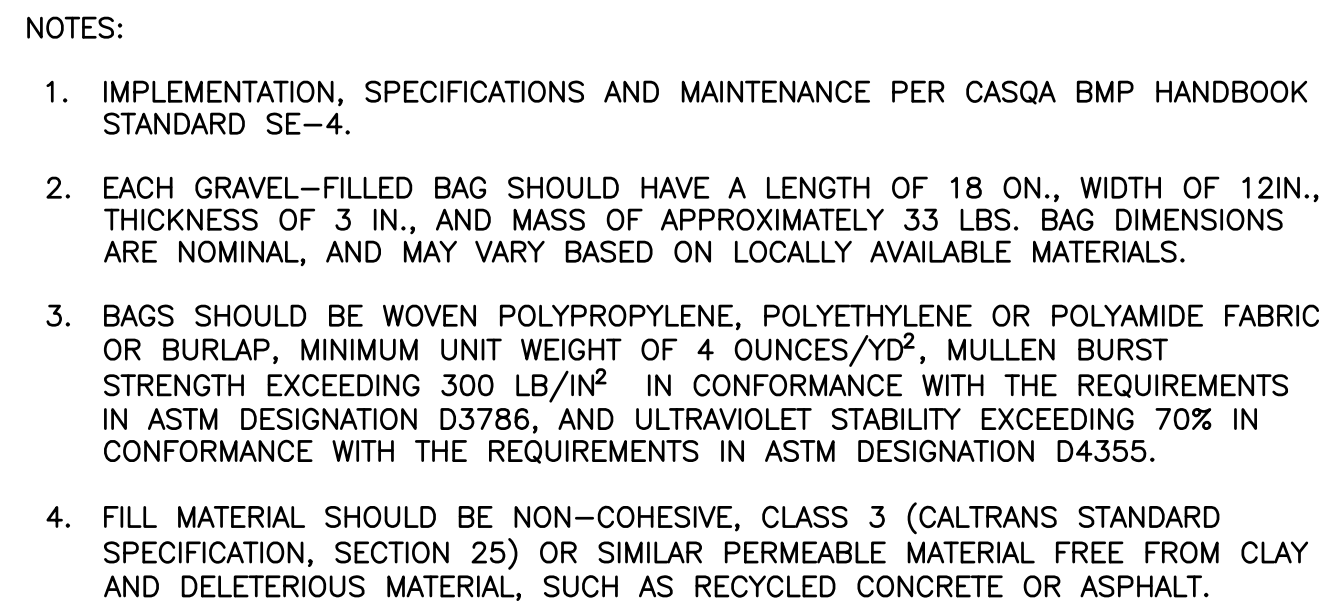


NTS ER022A 4




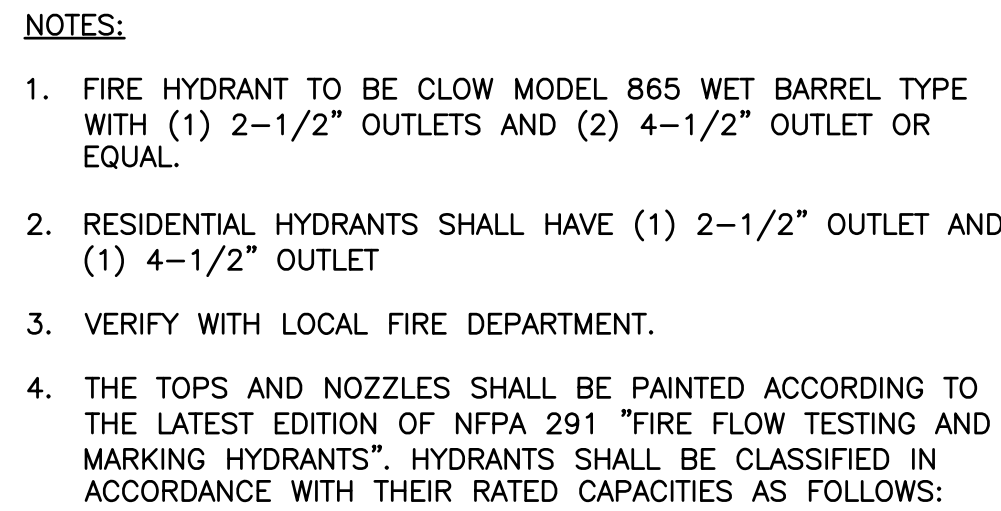



CLASSIFICATION	RATED CAPACITIES	COLOR
CLASS AA	1500 GPM OR GREATER	LIGHT BLUE
CLASS A	1000 — 1499 GPM	GREEN
CLASS B	500 — 999 GPM	ORANGE
CLASS C	LESS THAN 500 GPM	RED

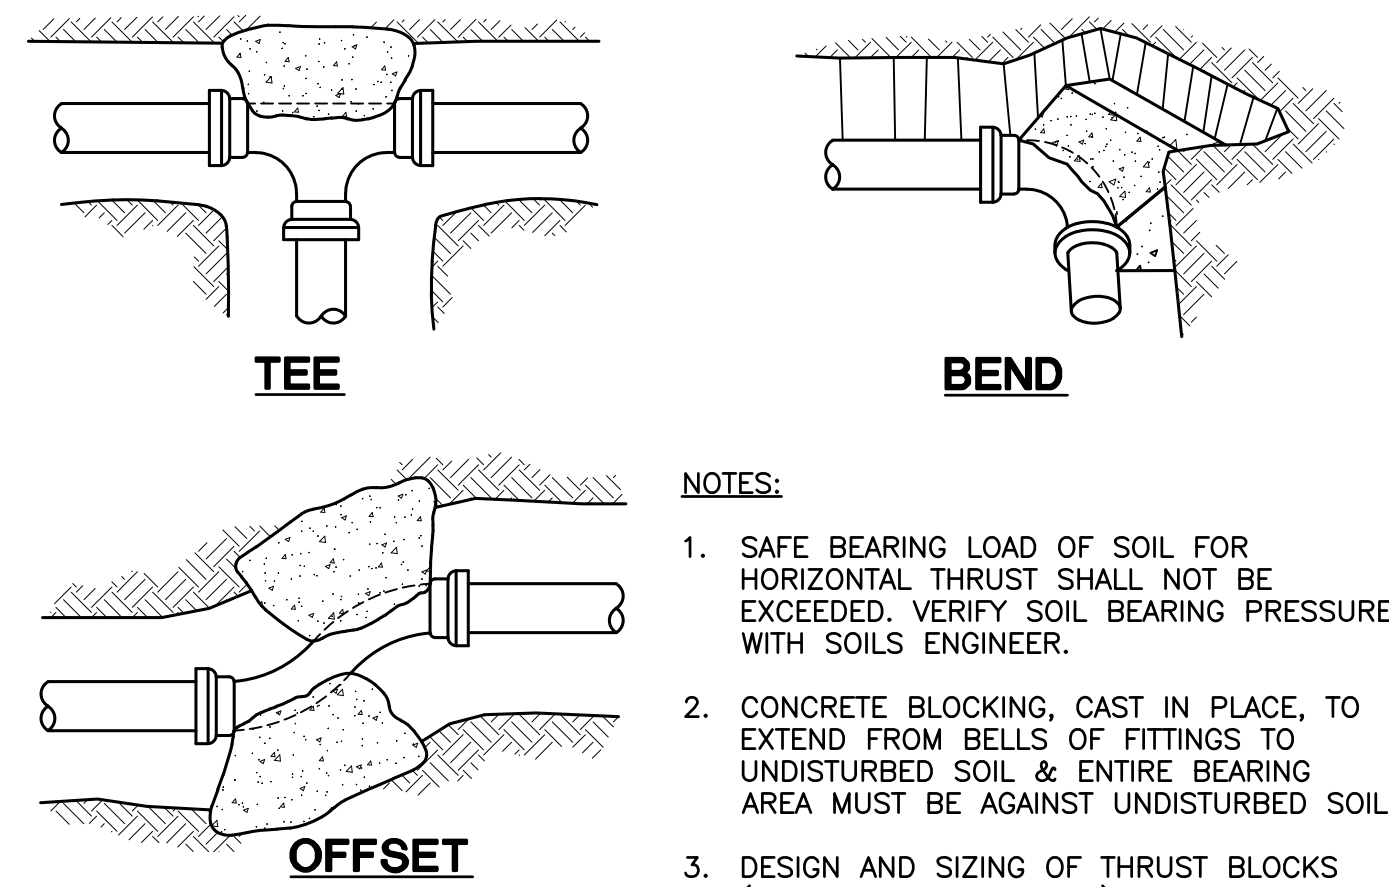


FP014 **1**

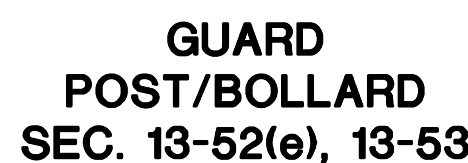


2

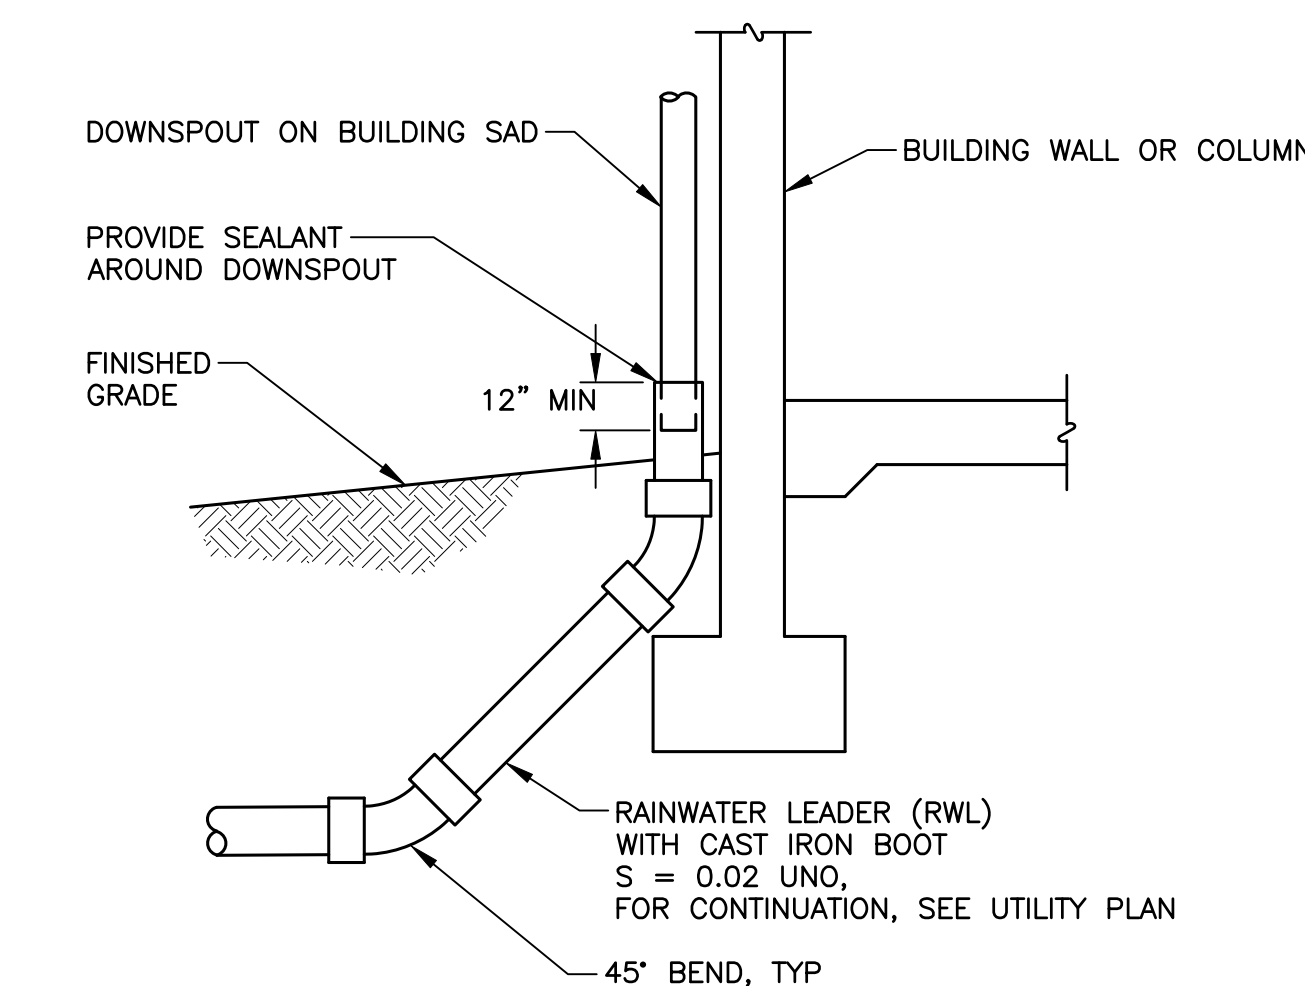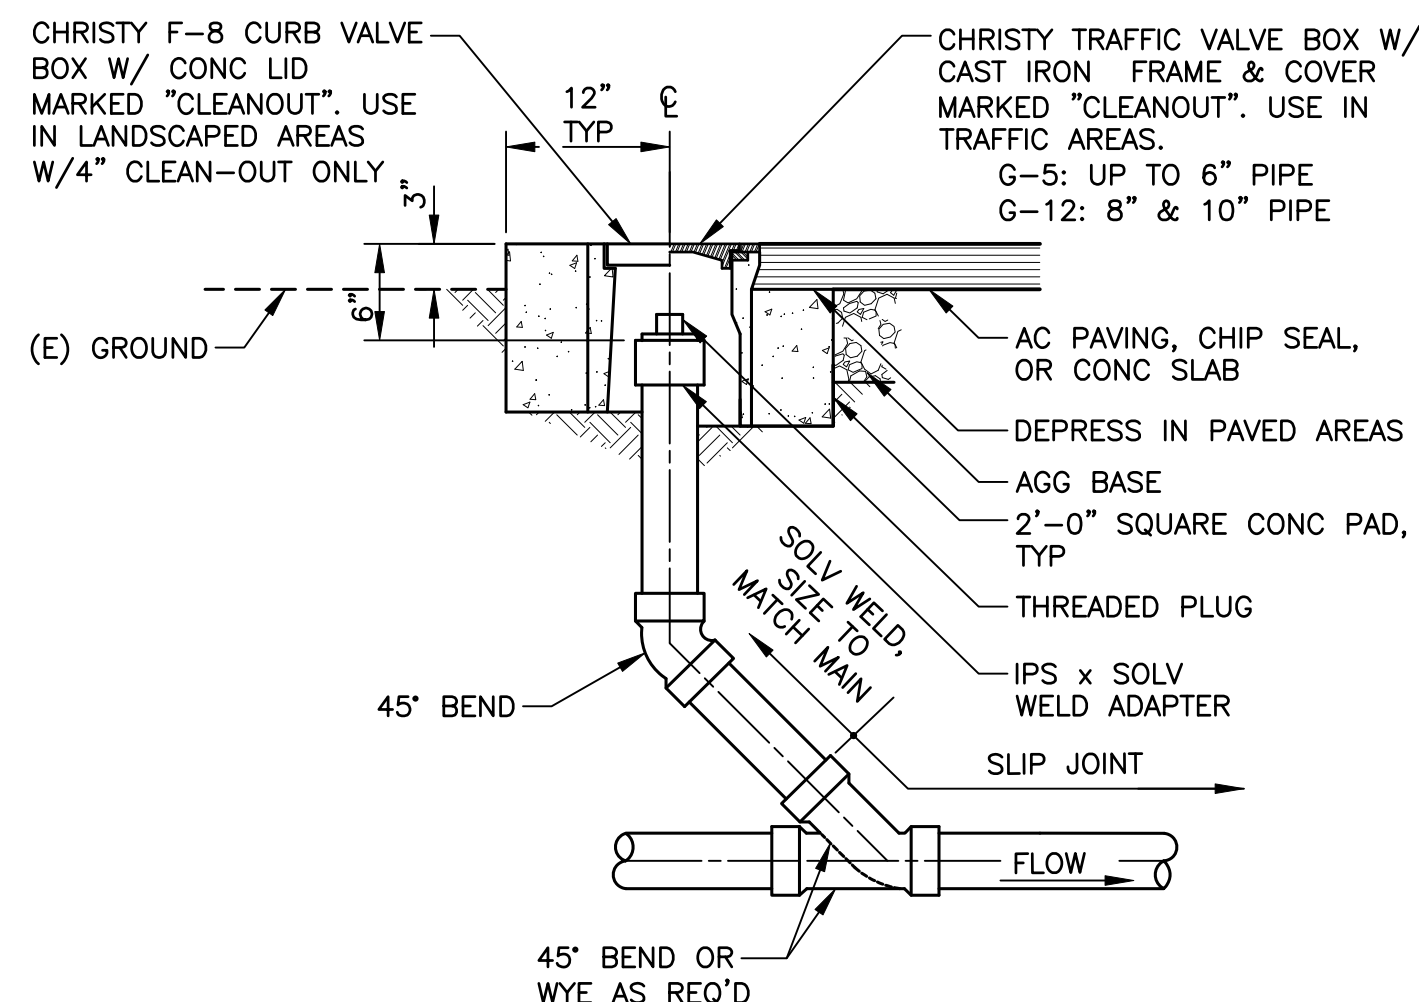


3

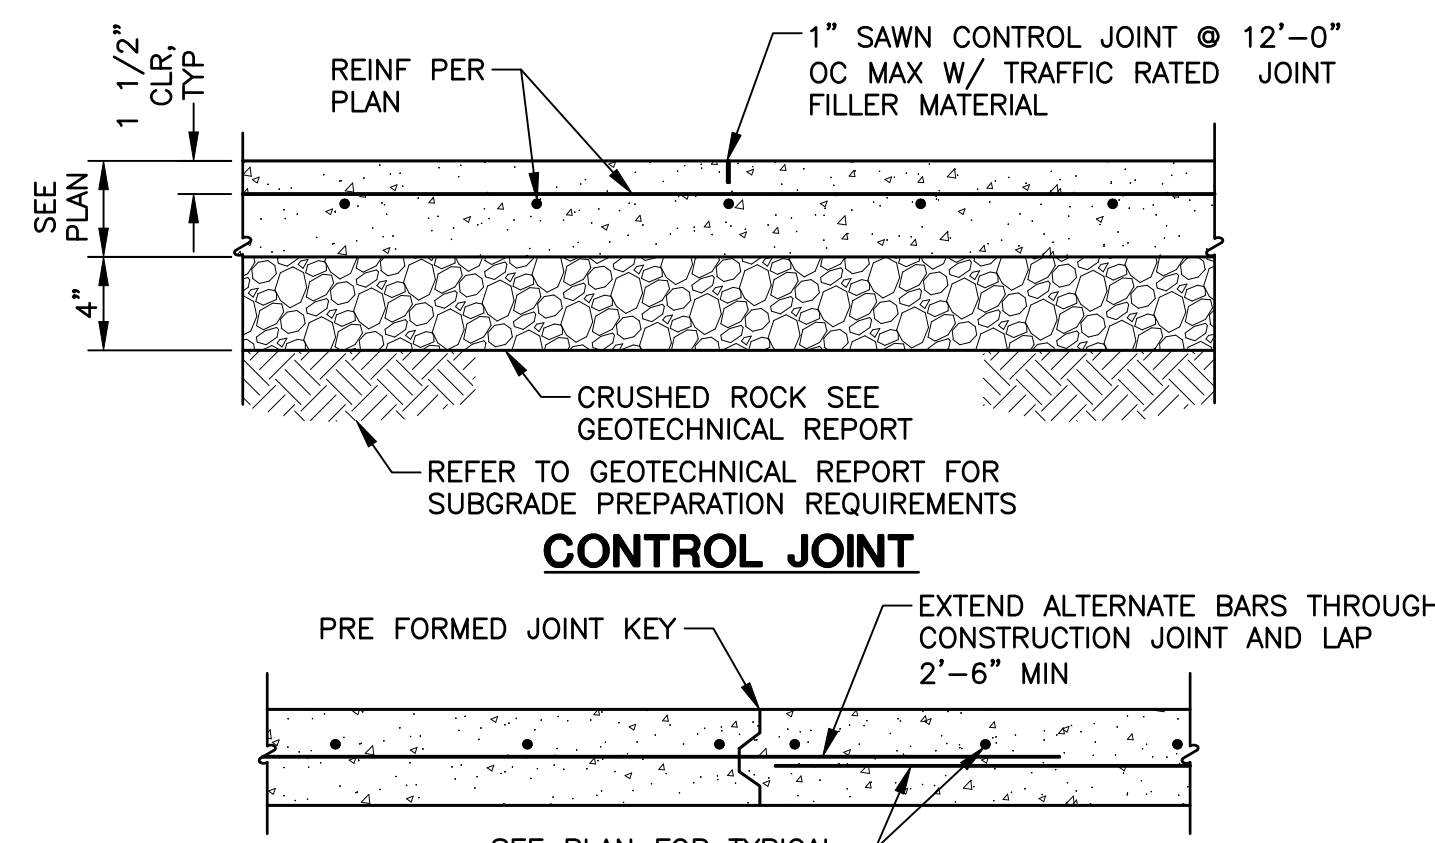


4

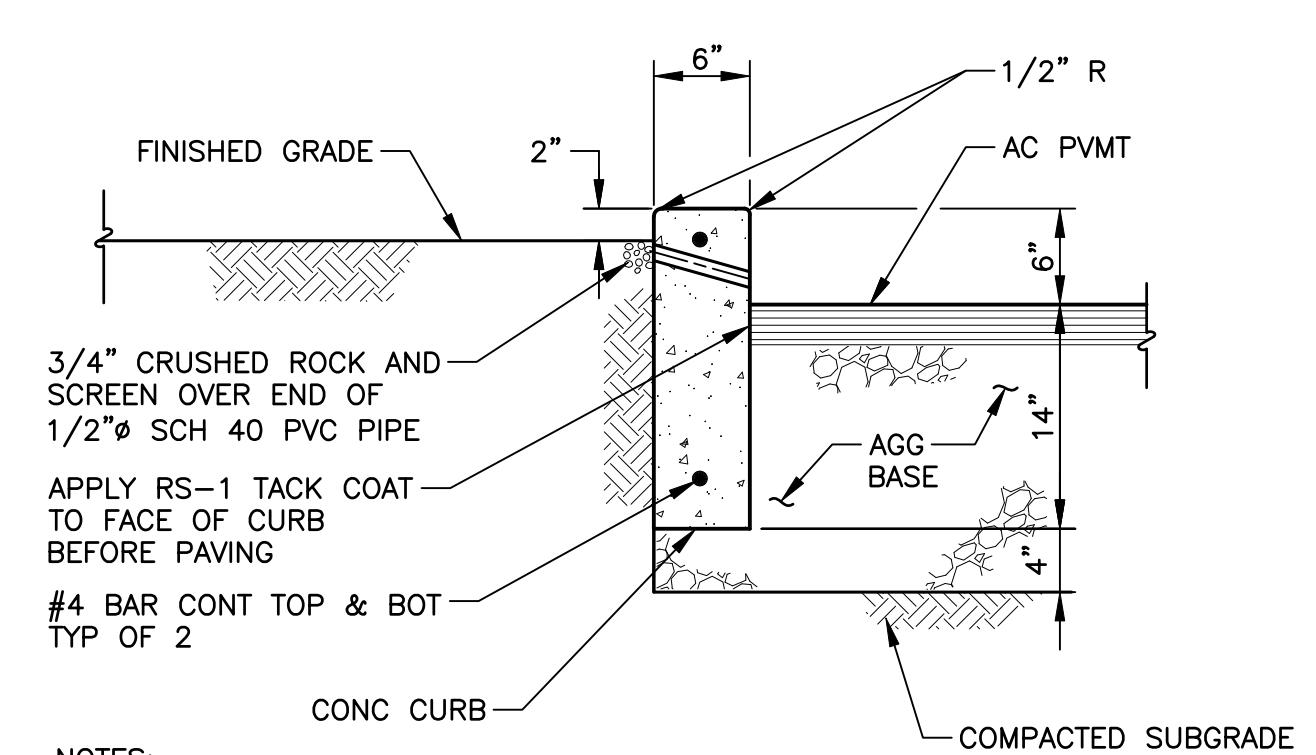


UG001A (5)

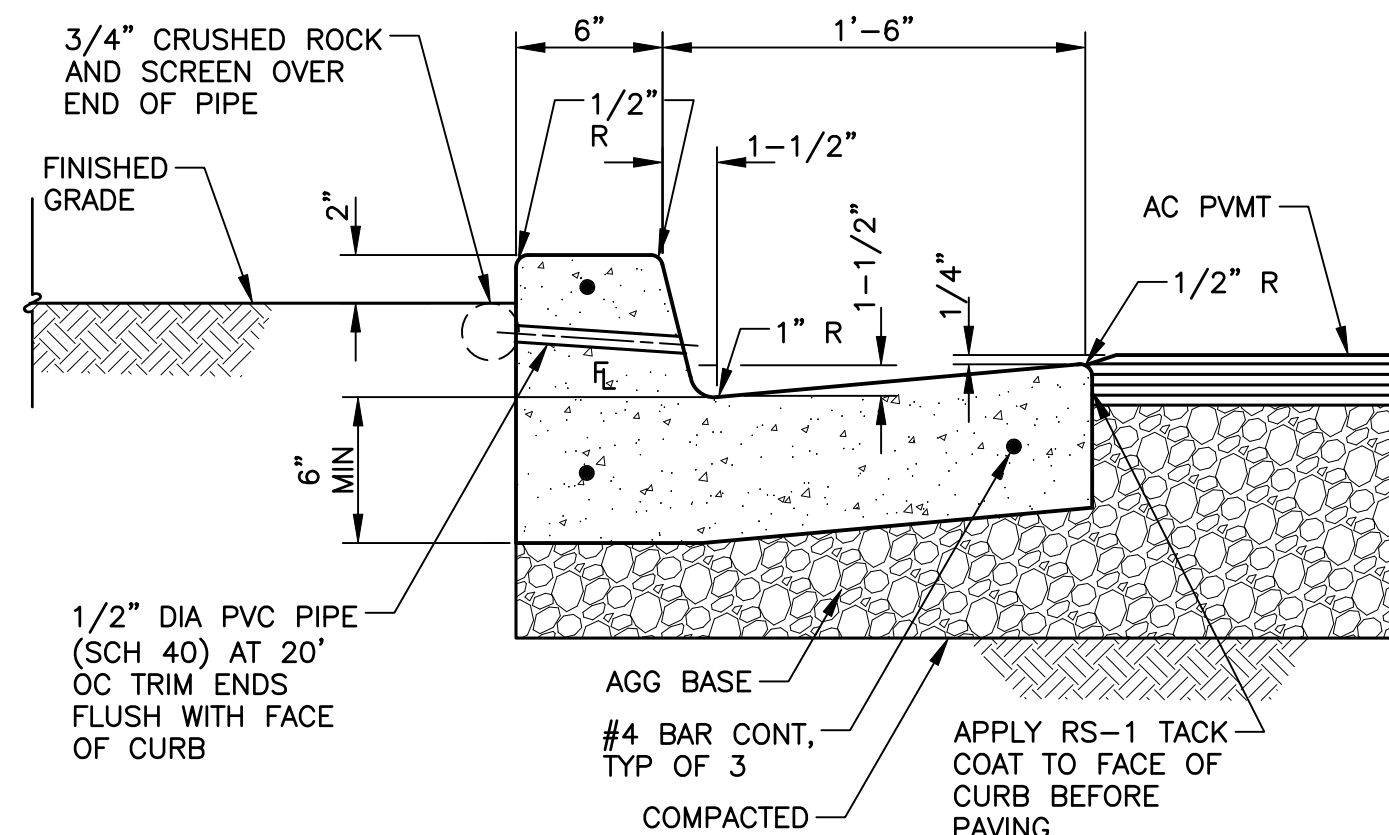


06A

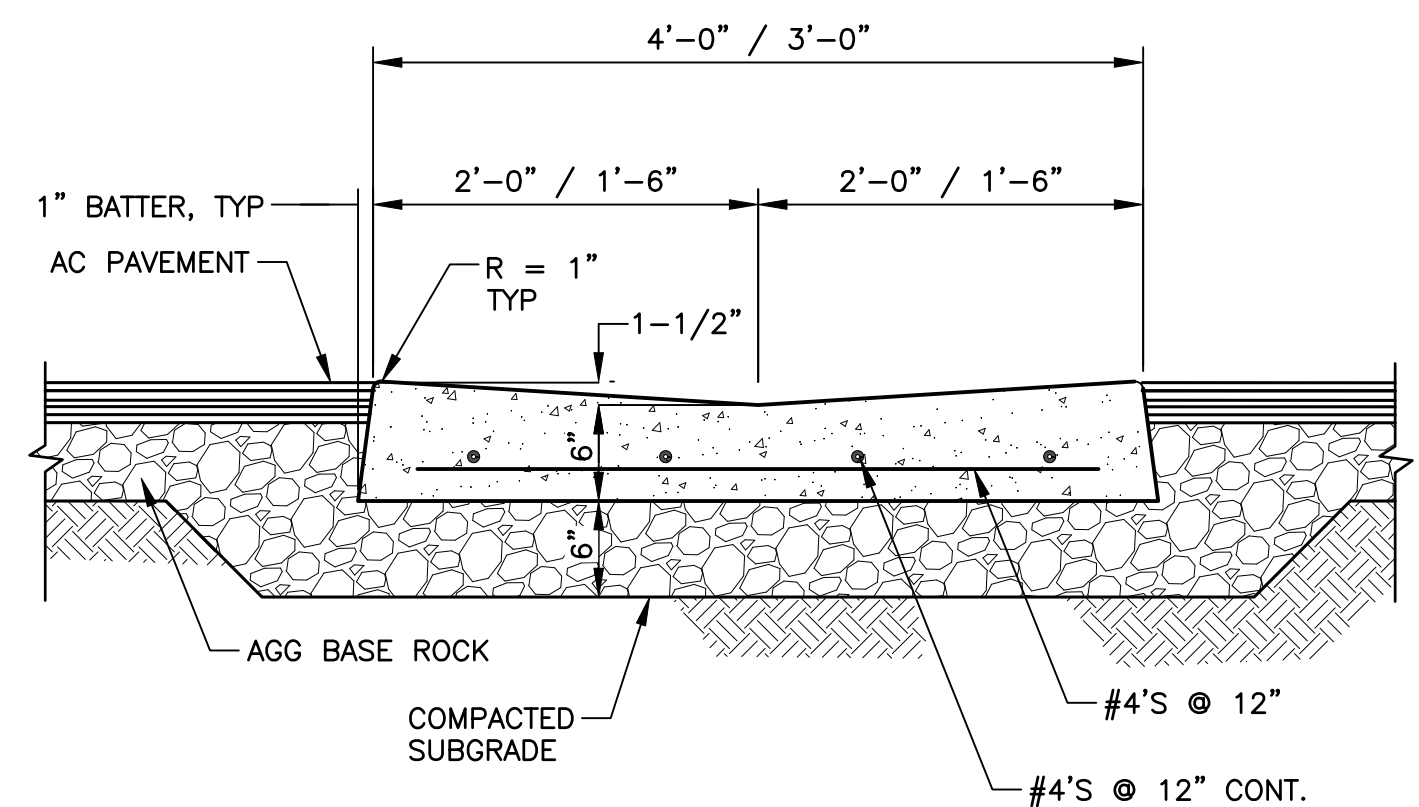


7

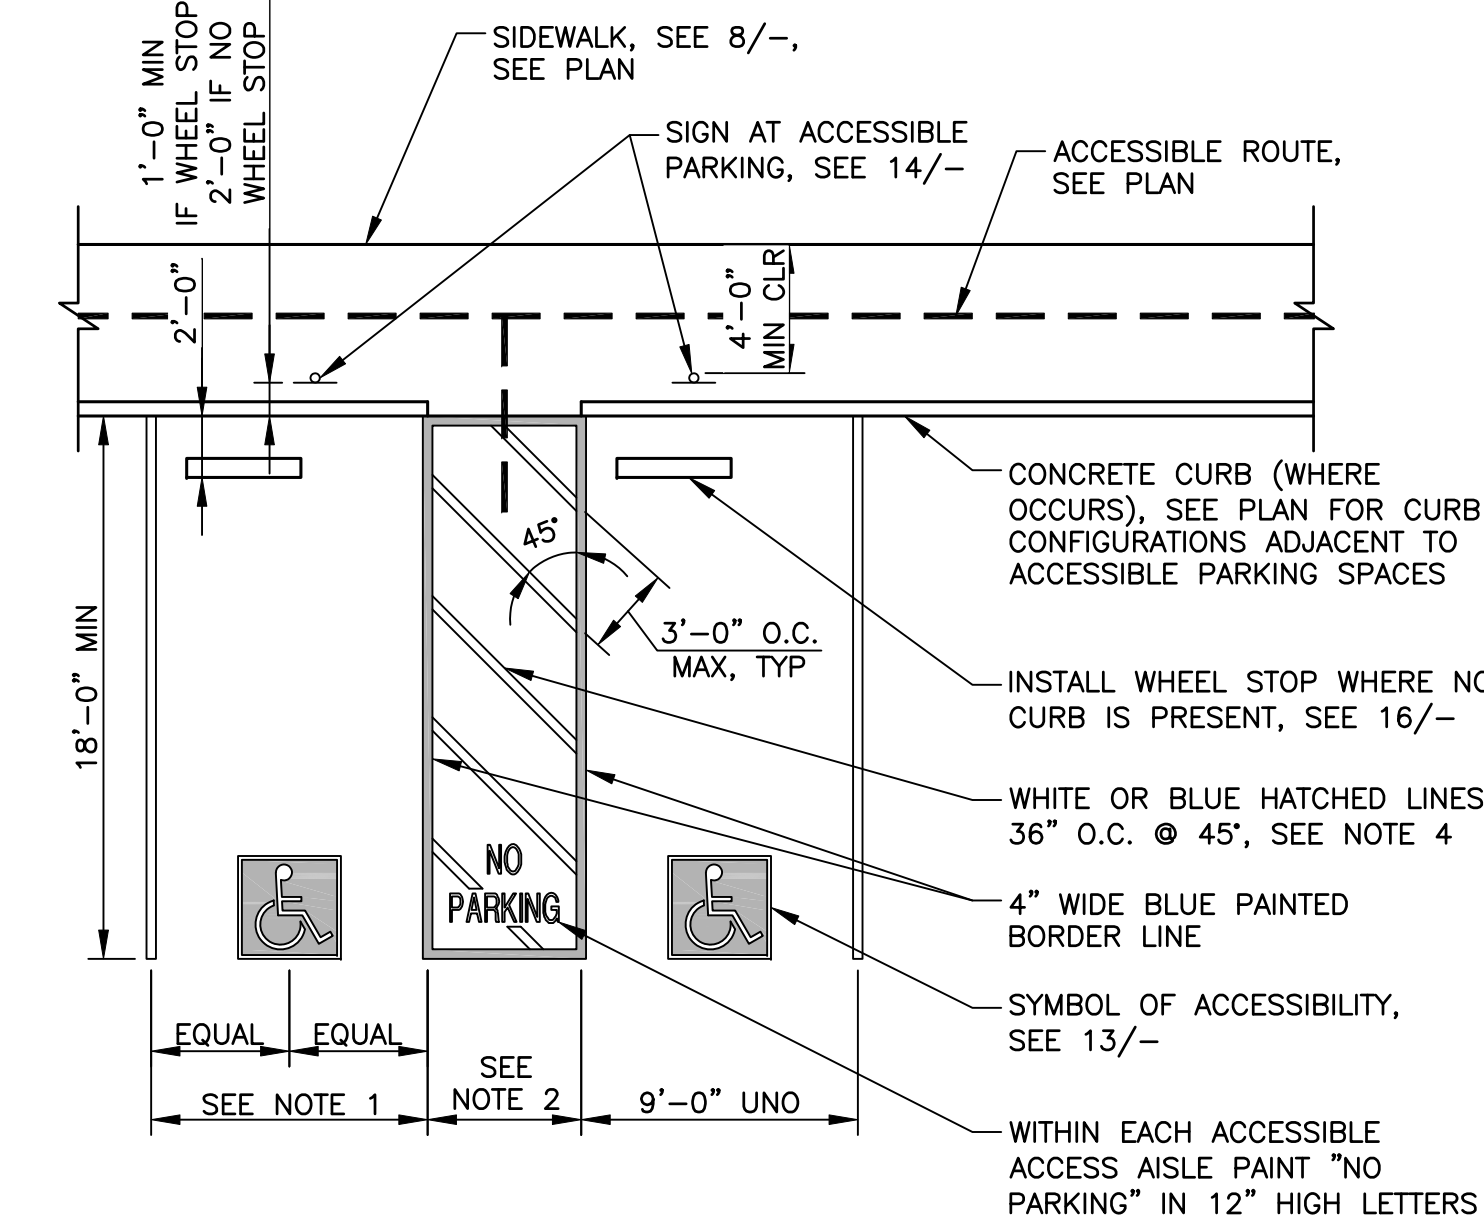


8

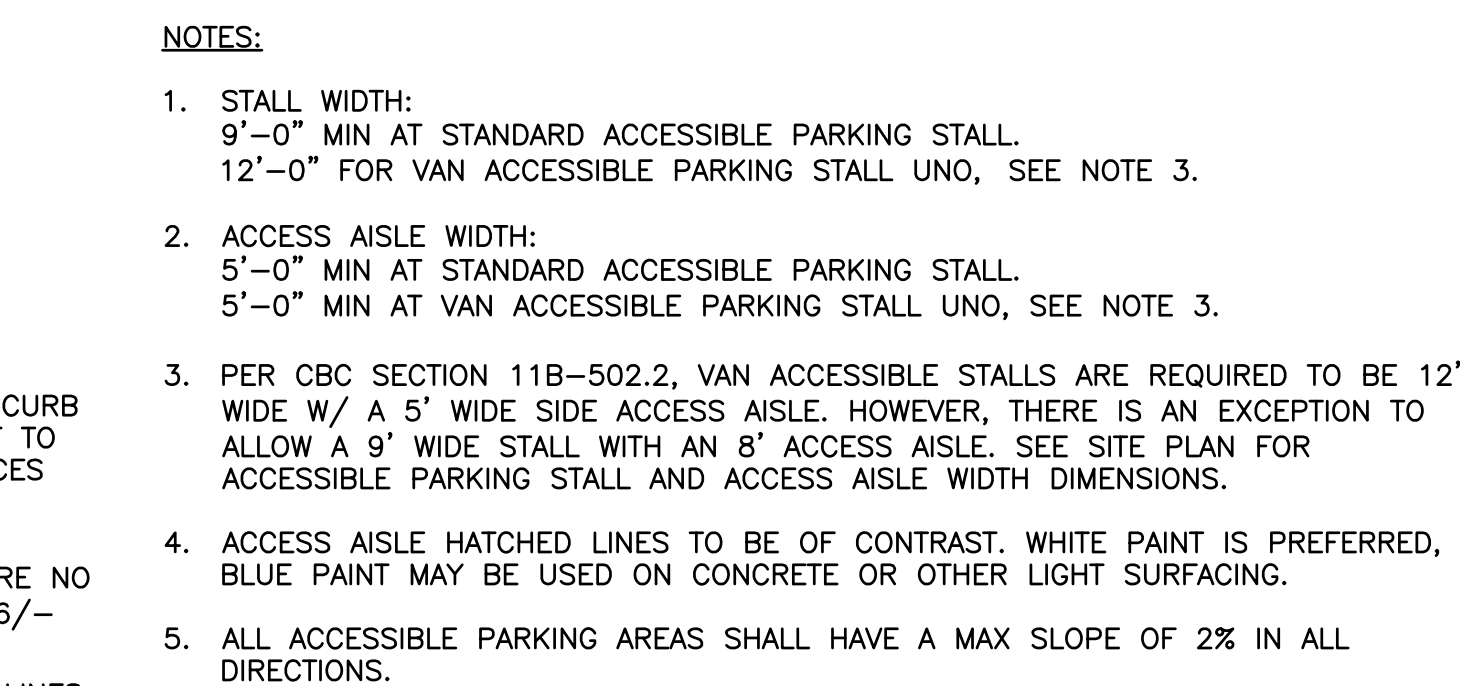


9

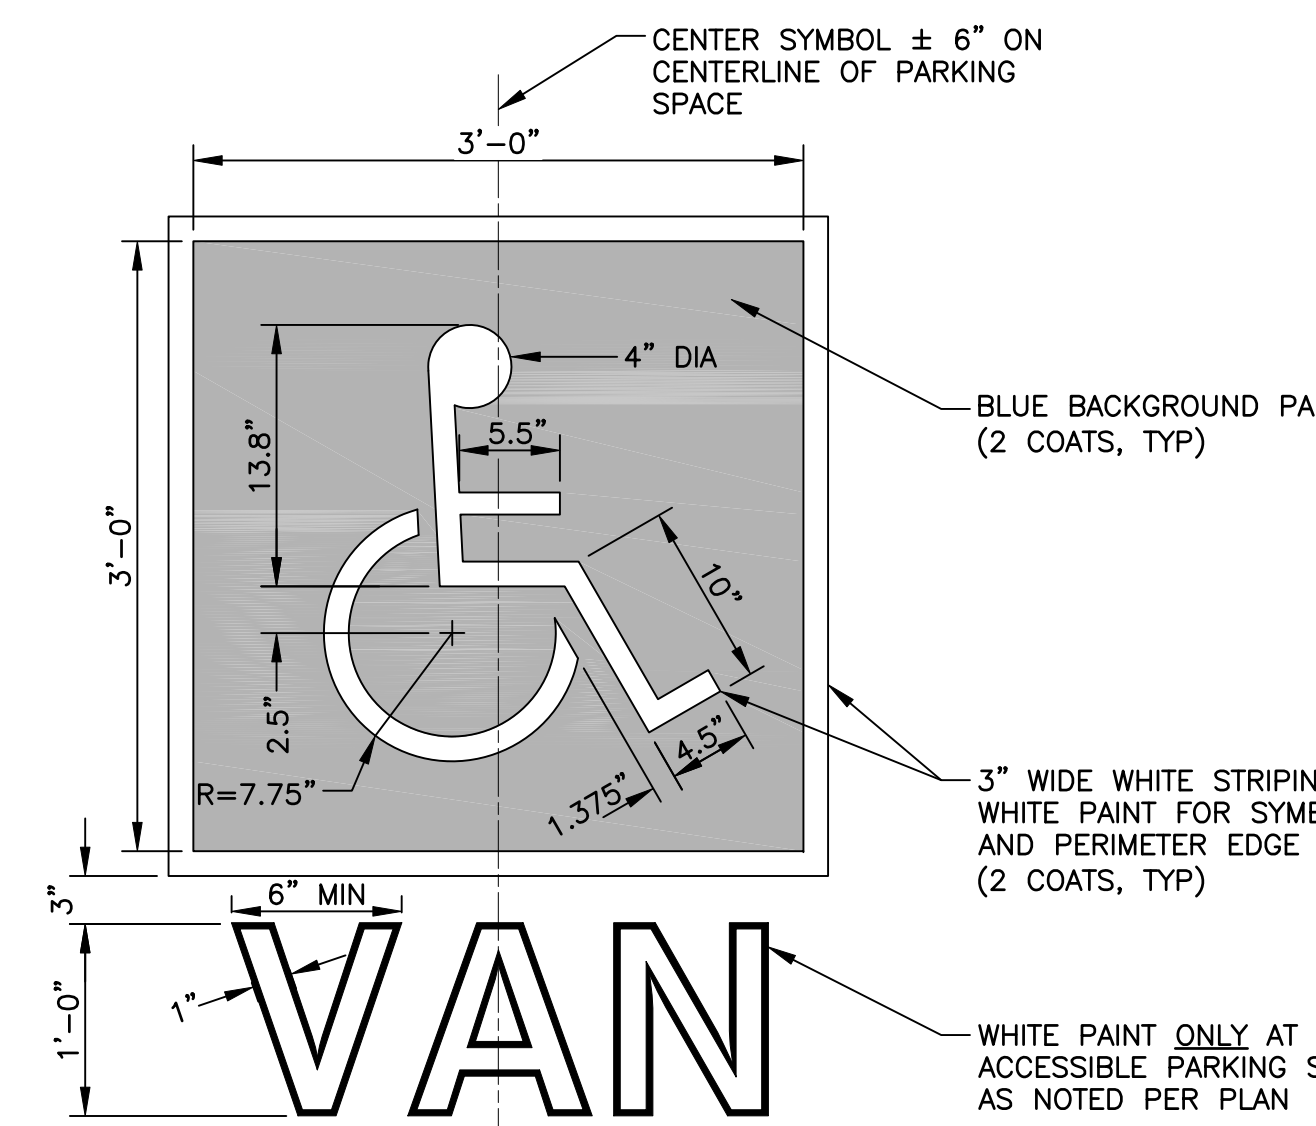


10

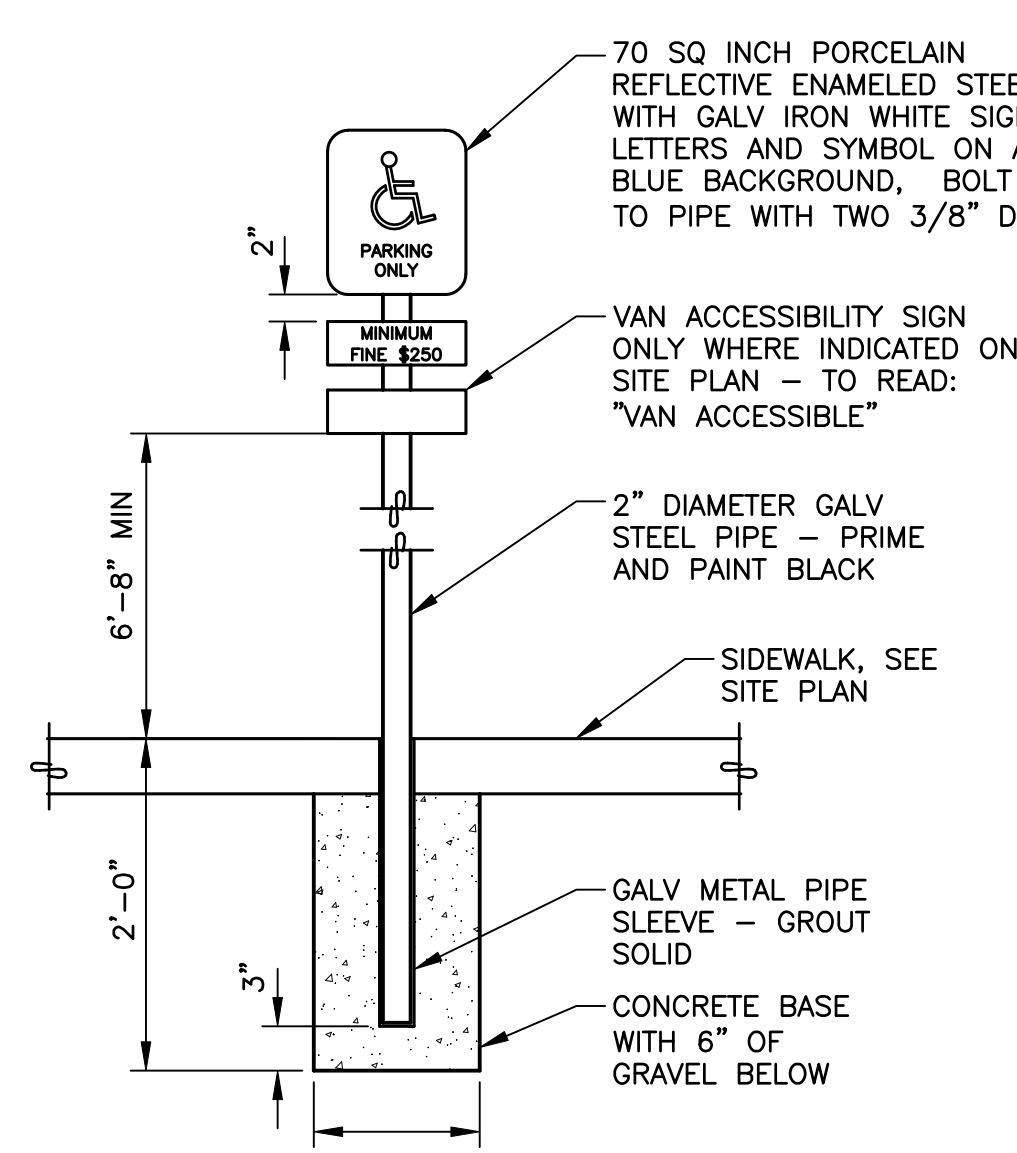

11

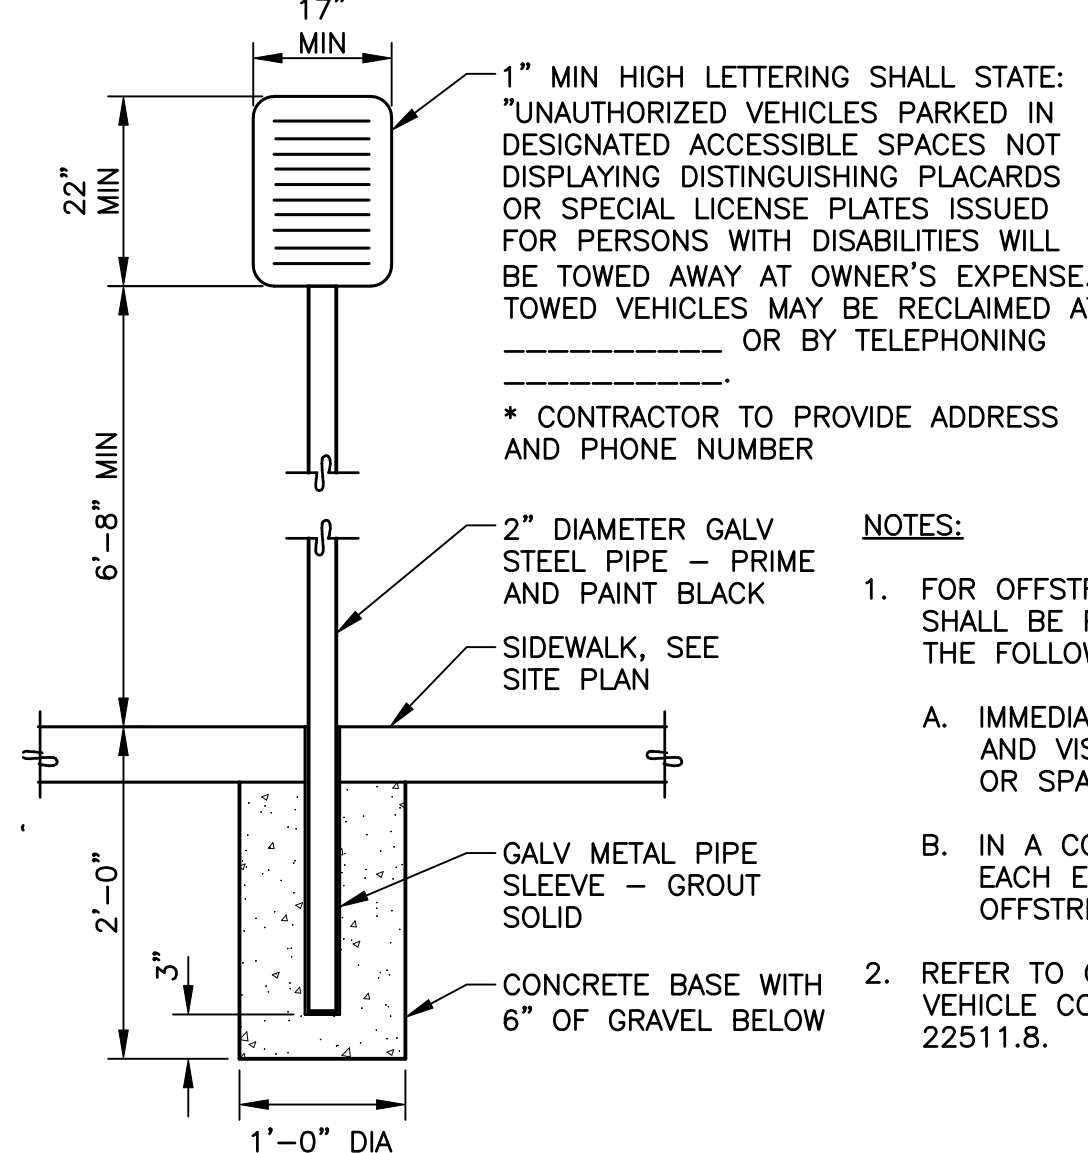


12

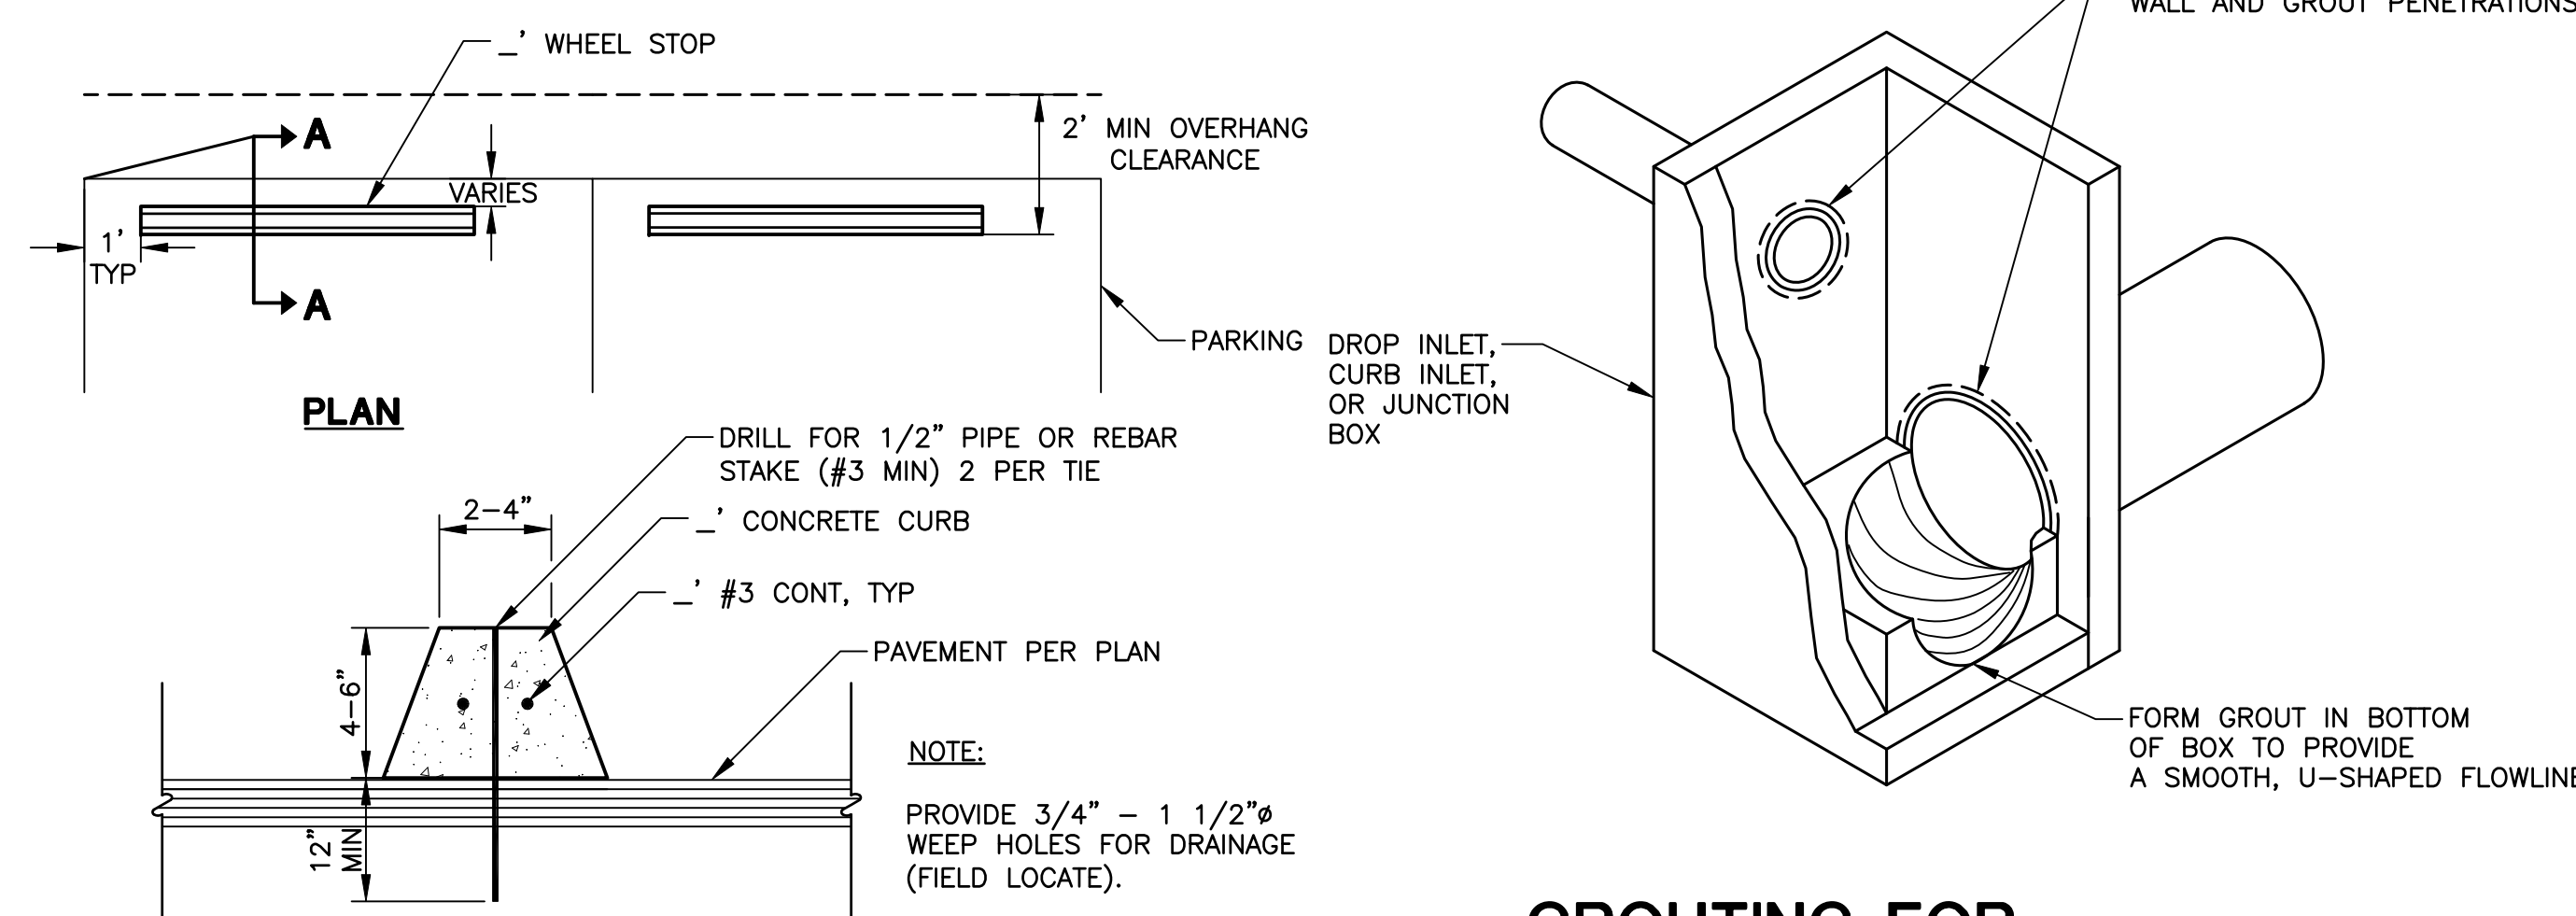

17

009

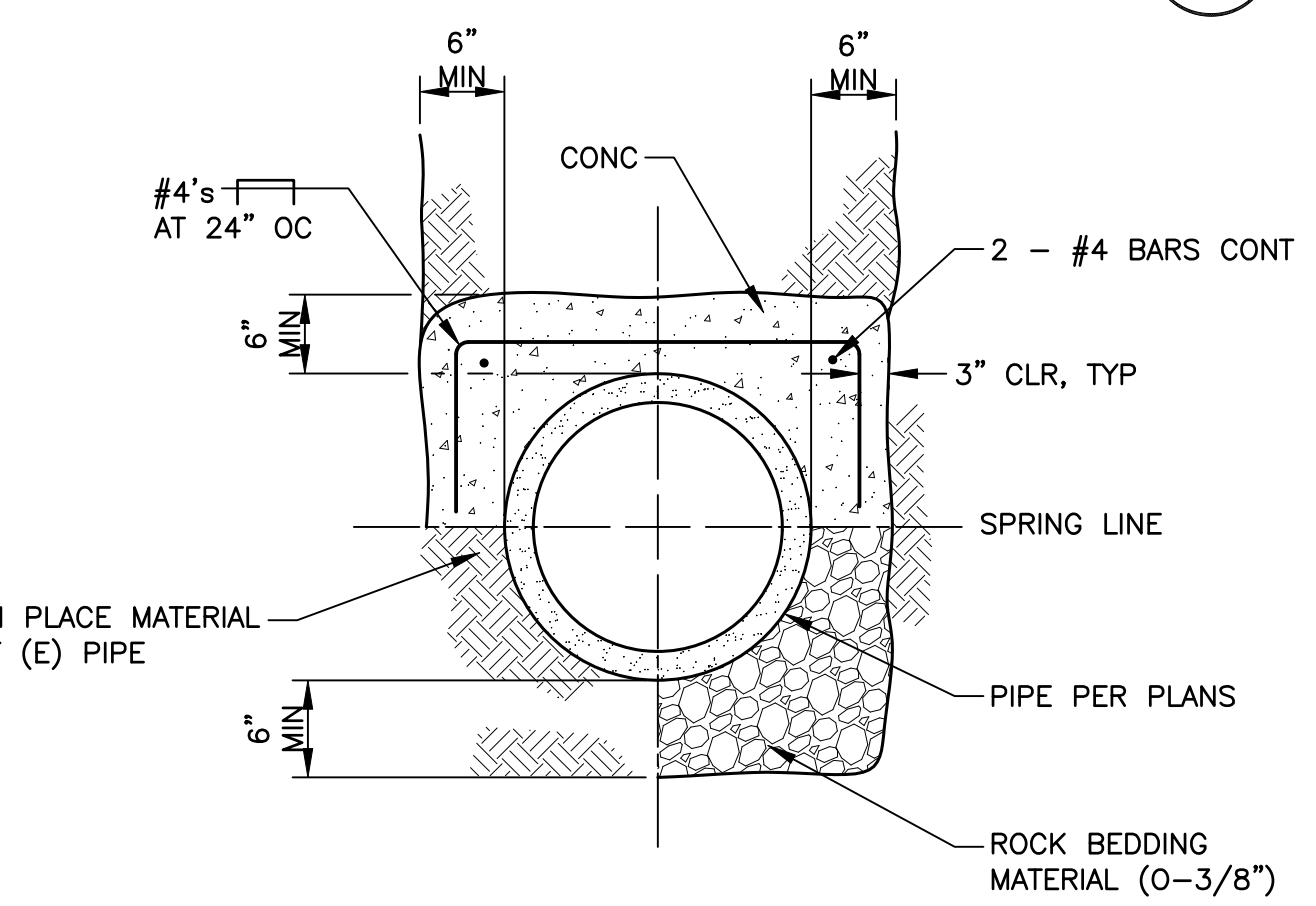


14



16



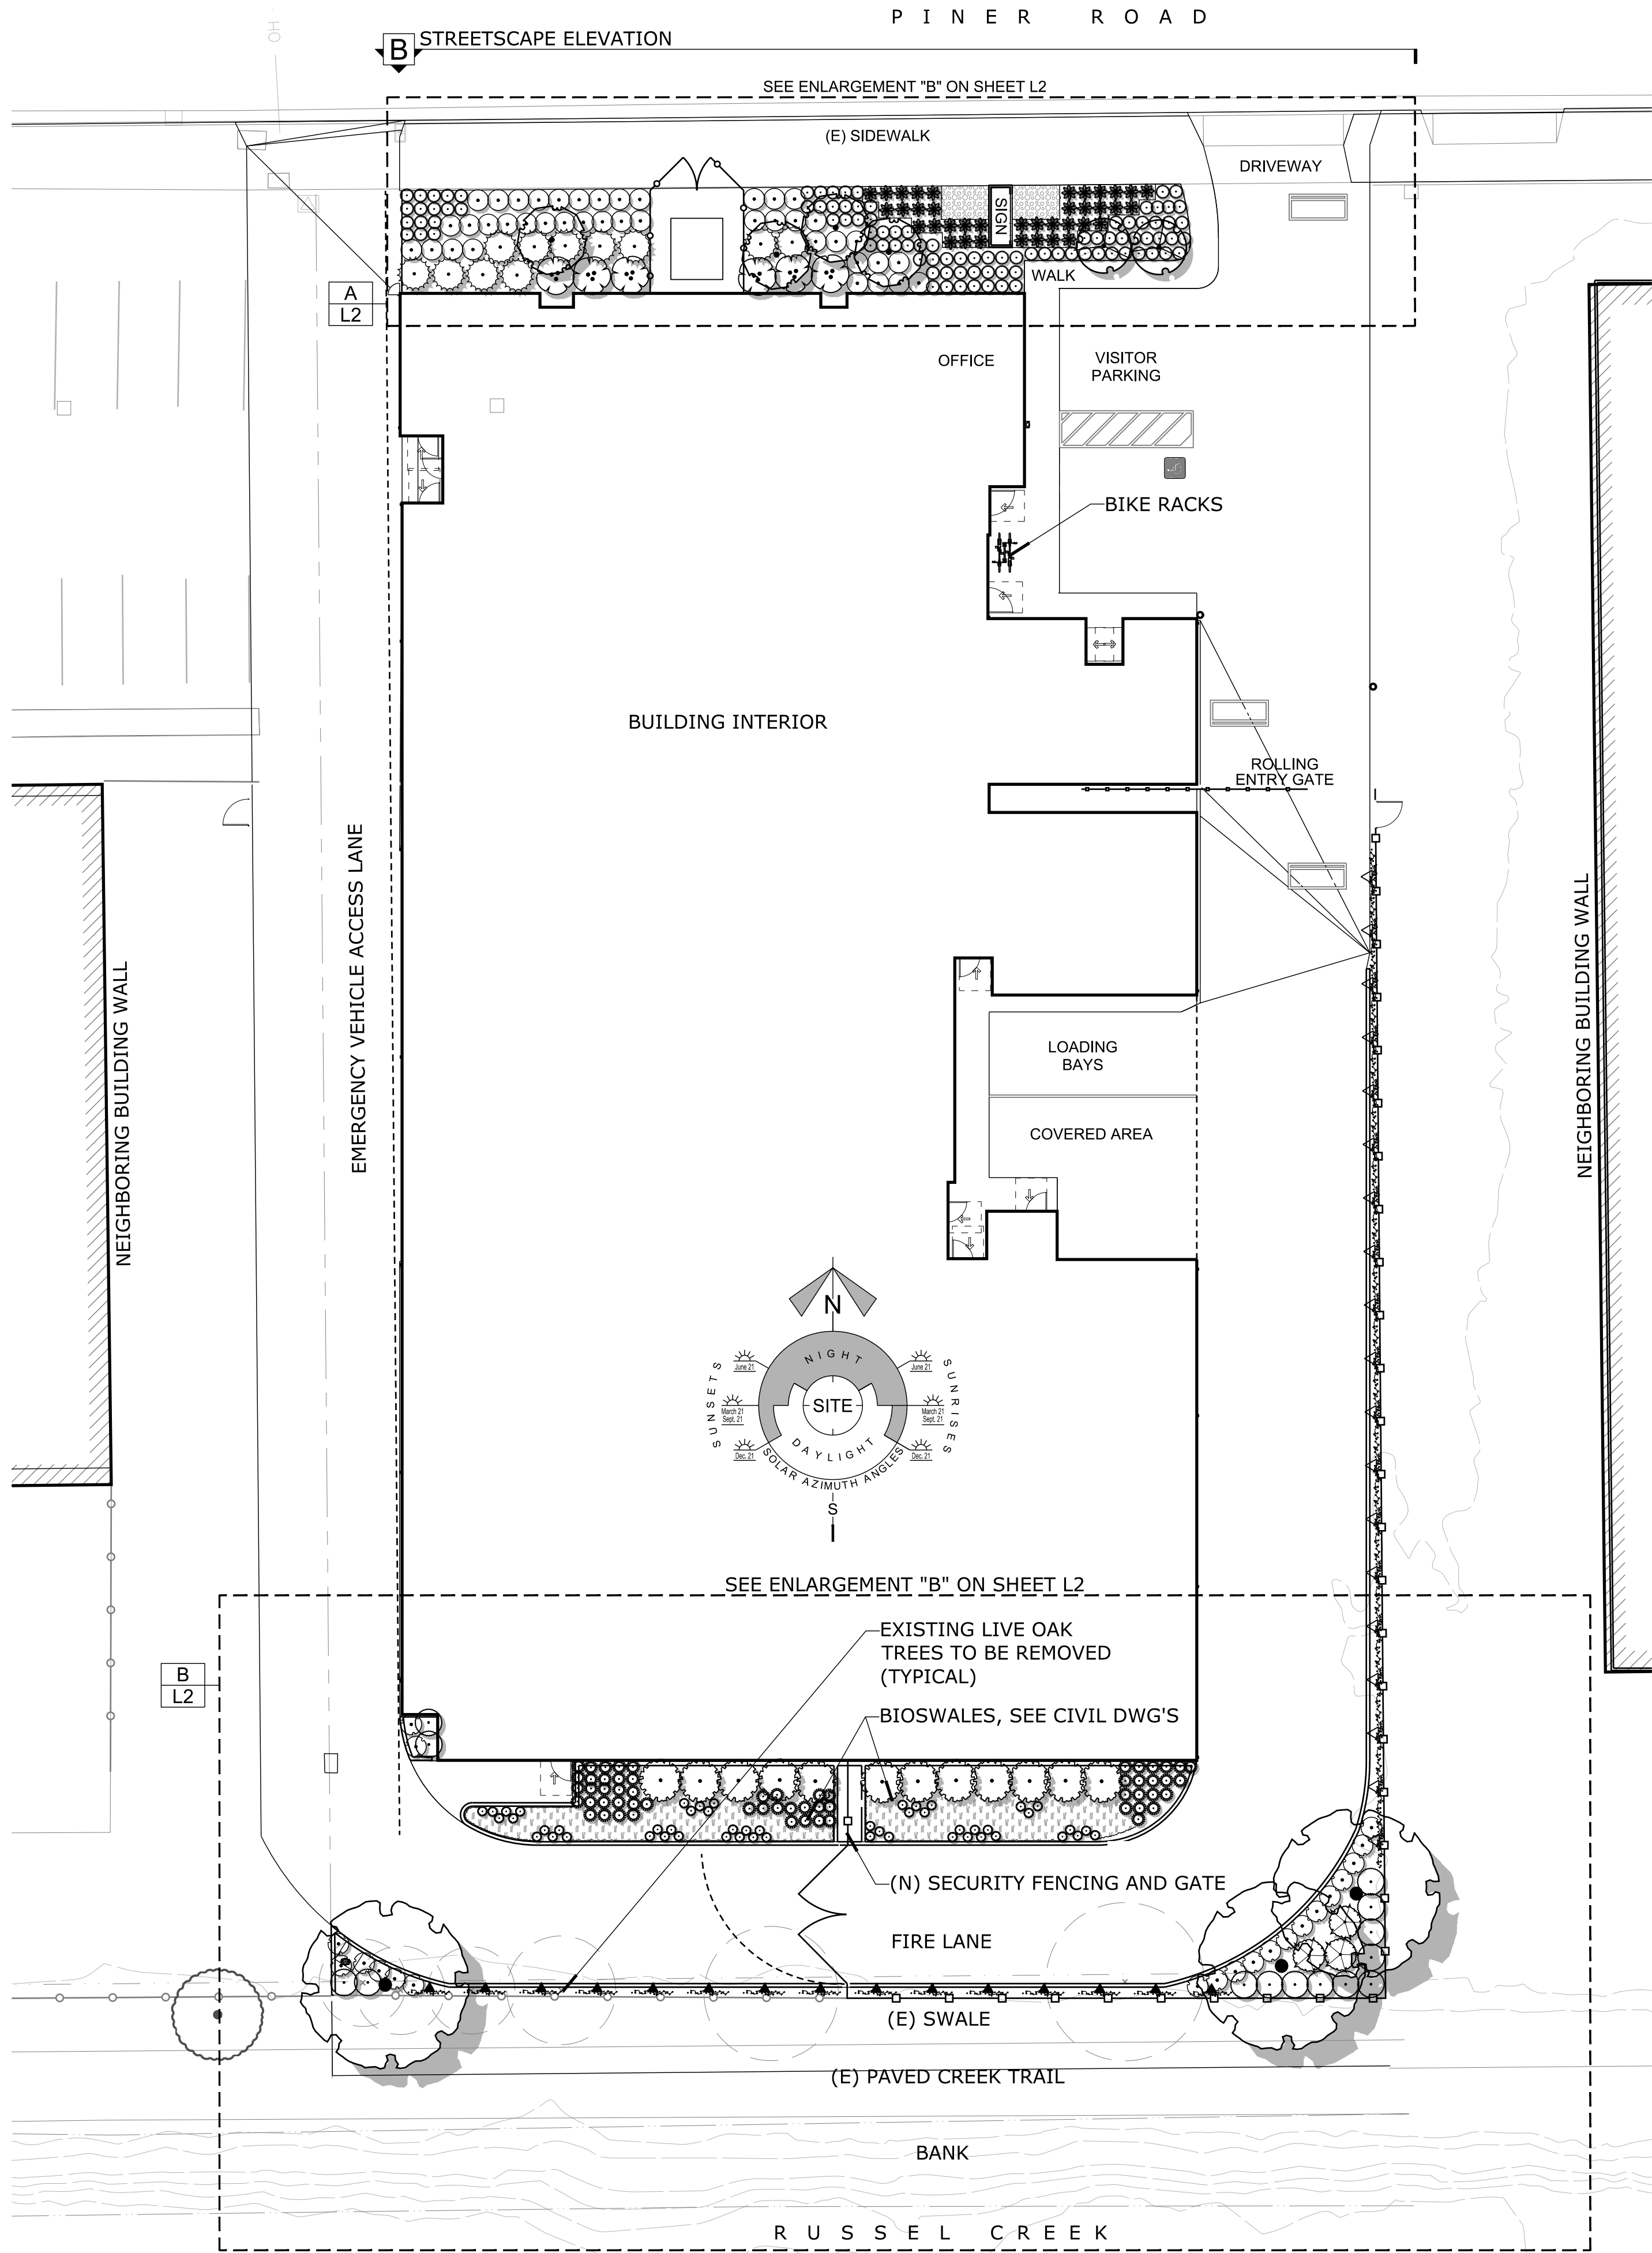

A OVERALL LANDSCAPE PLAN - SEE SHEET L2 FOR AREA ENLARGEMENTS AND DETAILED PLANTING PLANS



PLANT LEGEND

TREES	CODE	BOTANICAL NAME	COMMON NAME	SIZE	QTY
	ACE GOL	ACER RUBRUM 'ARMSTRONG GOLD'	GOLDEN ARMSTRONG MAPLE	24" BOX	4
	LAG CEN	LAGERSTROEMIA INDICA 'CENTENNIAL SPIRIT'	COLUMNAR CRAPE MYRTLE	24" BOX	2
	QUE AGR	QUERCUS AGRIFOLIA	COAST LIVE OAK	24" BOX	3
SHRUBS	CODE	BOTANICAL NAME	COMMON NAME	SIZE	QTY
	AGA BLG	AGAVE X 'BLUE GLOW'	BLUE GLOW AGAVE	2 GAL.	38
	BAM GRA	BAMBUSA TEXTILIS 'GRACILIS'	SLENDER WEAVER'S BAMBOO	15 GAL.	6
	CAL OCC	CALYCANTHUS OCCIDENTALIS	SPICE BUSH	5 GAL.	12
	CAR ELI	CARPENTERIA CALIFORNICA 'ELIZABETH'	ELIZABETH BUSH ANEMONE	5 GAL.	14
	ELY CA2	ELYMUS CONDENSATUS 'CANYON PRINCE'	CANYON PRINCE WILD RYE	1 GAL.	52
	EUP POR	EUPHORBIA CHAR. 'PORTUGUESE VELVET'	PORTUGUESE VELVET SPURGE	5 GAL.	41
	ILE GOL	ILEX AQUIFOLIUM 'GOLD COAST' TM	GOLD COAST HOLLY	15 GAL.	11
	JUN ELK	JUNCUS PATENS 'ELK BLUE'	SPREADING RUSH	1 GAL.	59
	LOM LIM	LOMANDRA X 'LITTLE LIME'	LITTLE LIME MAT RUSH	1 GAL.	96
	RIB SPE	RIBES SPECIOSUM	FUCHSIA FLOWERING GOOSEBERRY	5 GAL.	3
	RIB VIB	RIBES VIBURNIFOLIUM	EVERGREEN CURRANT	5 GAL.	21
VINES	CODE	BOTANICAL NAME	COMMON NAME	SIZE	QTY
	MAC UNG	MACFADYENA UNGUIS-CATI	YELLOW TRUMPET VINE	5 GAL.	19
	ROS BAN	ROSA BANKSIAE	LADY BANKS ROSE	5 GAL.	15
GROUND COVERS	CODE	BOTANICAL NAME	COMMON NAME	SIZE	QTY
	CAR TUM	CAREX TUMULICOLA	FOOTHILL SEDGE	1 GAL. @18" O.C.	168
	MIX SED	MIXED SEDUMS AND SUCCULENTS	SEE BELOW	4" POT @12" O.C.	77

LANDSCAPE GENERAL NOTES

- LANDSCAPE SHALL COMPLY WITH SANTA ROSA'S WATER EFFICIENT LANDSCAPE ORDINANCE (WELO).
- HYDROZONE AREAS ARE SUBJECT TO CHANGE, BUT SHALL NOT CAUSE THE LANDSCAPE TO EXCEED THE "MAXIMUM APPLIED WATER ALLOWANCE" AS SHOWN ON THE "APPENDIX A" SPREADSHEET BELOW.
- ALL UNPAVED AREAS SHALL BE TOP-DRESSED WITH A 3" LAYER OF ORGANIC OR AGGREGATE MULCH.
- ALL PLANTINGS SHALL BE IRRIGATED BY A PERMANENT, AUTOMATIC, WATER CONSERVING IRRIGATION SYSTEM COMPLIANT WITH SANTA ROSA'S WELO.
- SOIL SHALL BE TESTED BY AN APPROVED LABORATORY AND AMENDED AS RECOMMENDED BY THE LAB ANALYSIS
- STREET TREES SHALL BE INSTALLED PER SANTA ROSA STANDARD DETAIL AND "STANDARDS FOR PLANTING OF PARKWAY TREES."
- ALL TREES PLANTED WITHIN 4' OF BUILDINGS, WALL, CURBS OR PAVEMENTS WILL BE INSTALLED WITH ROOT BARRIERS.
- ALL TREES WILL BE PLANTED FROM 24" BOXES (MINIMUM) EXCEPT WHERE NOTED OTHERWISE
- A MINIMUM OF ONE FOOT DEPTH OF NON-MECHANICALLY COMPACTED SOIL SHALL BE AVAILABLE FOR WATER ABSORPTION AND ROOT GROWTH IN PLANTED AREAS.
- SEE CIVIL ENGINEERS DRAWINGS FOR GRADING AND DRAINAGE, AND FOR LOCATIONS AND DESCRIPTIONS OF LANDSCAPE BASED STORMWATER MANAGEMENT BMP'S



SANTA ROSA WELO - APPENDIX "A"

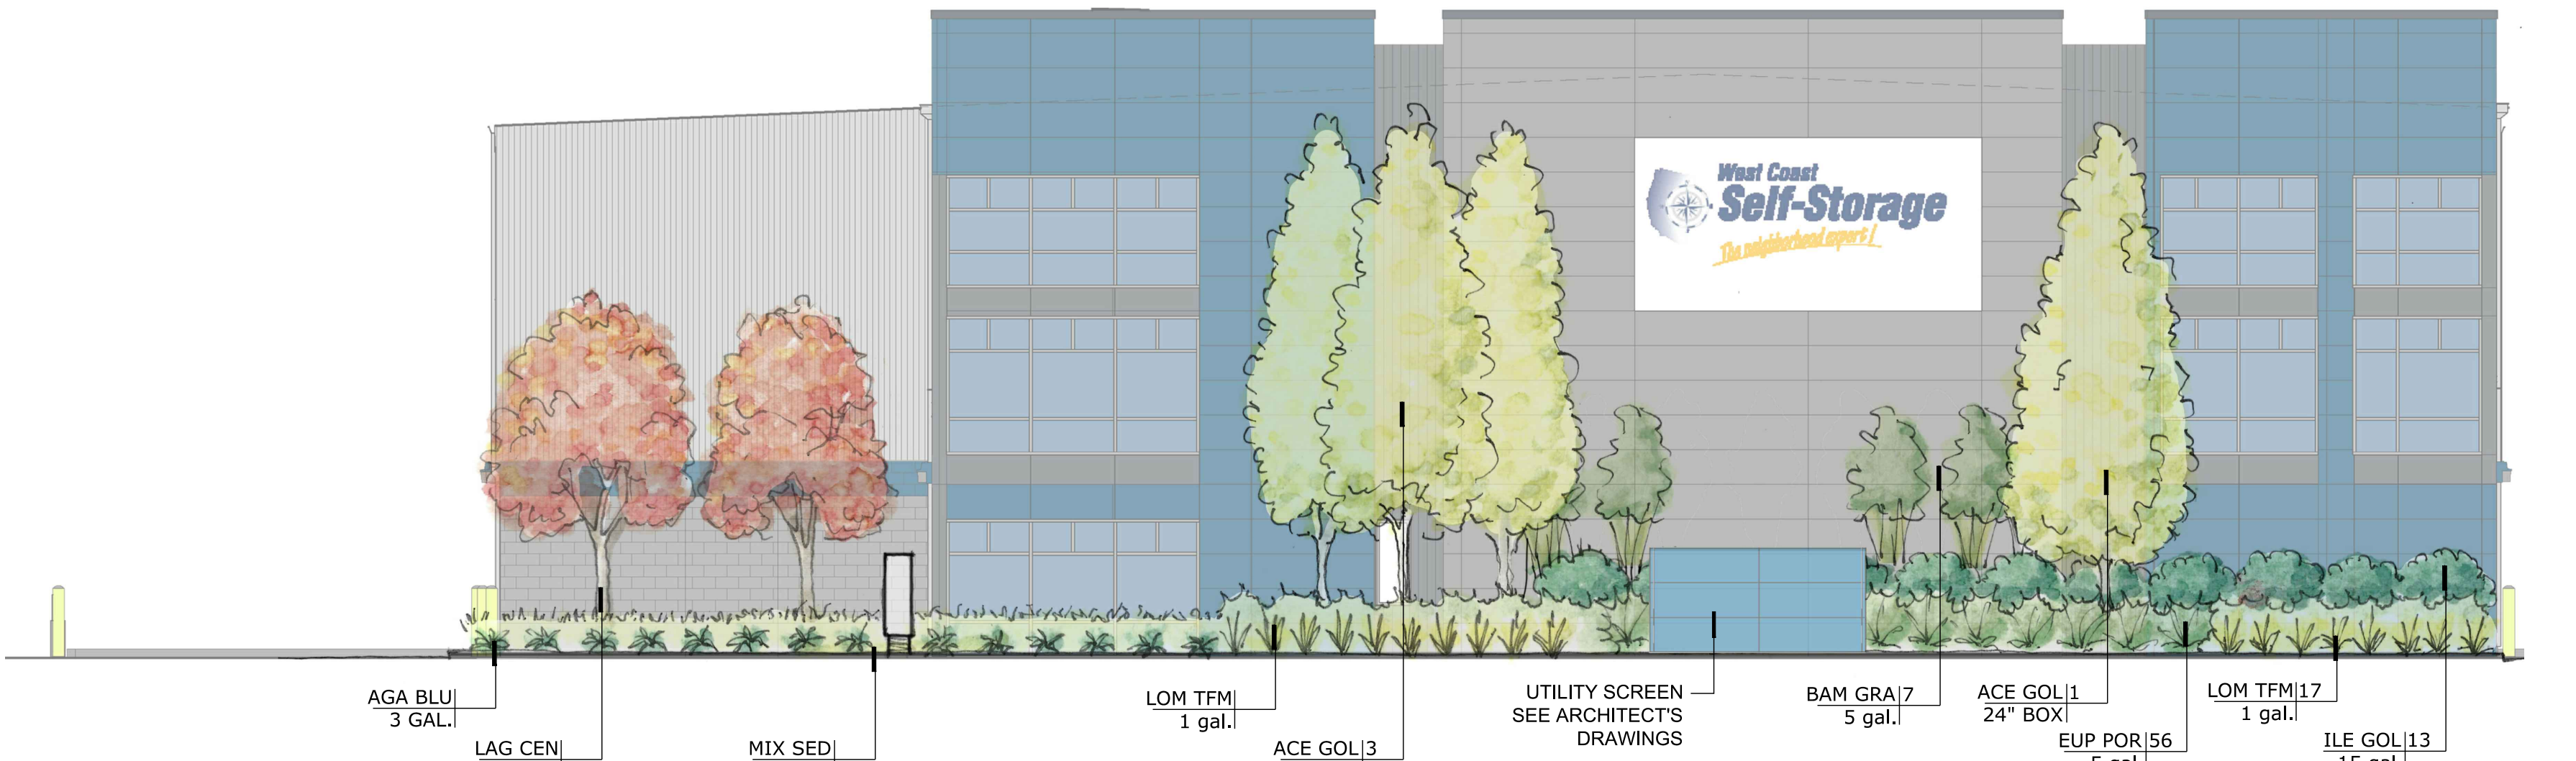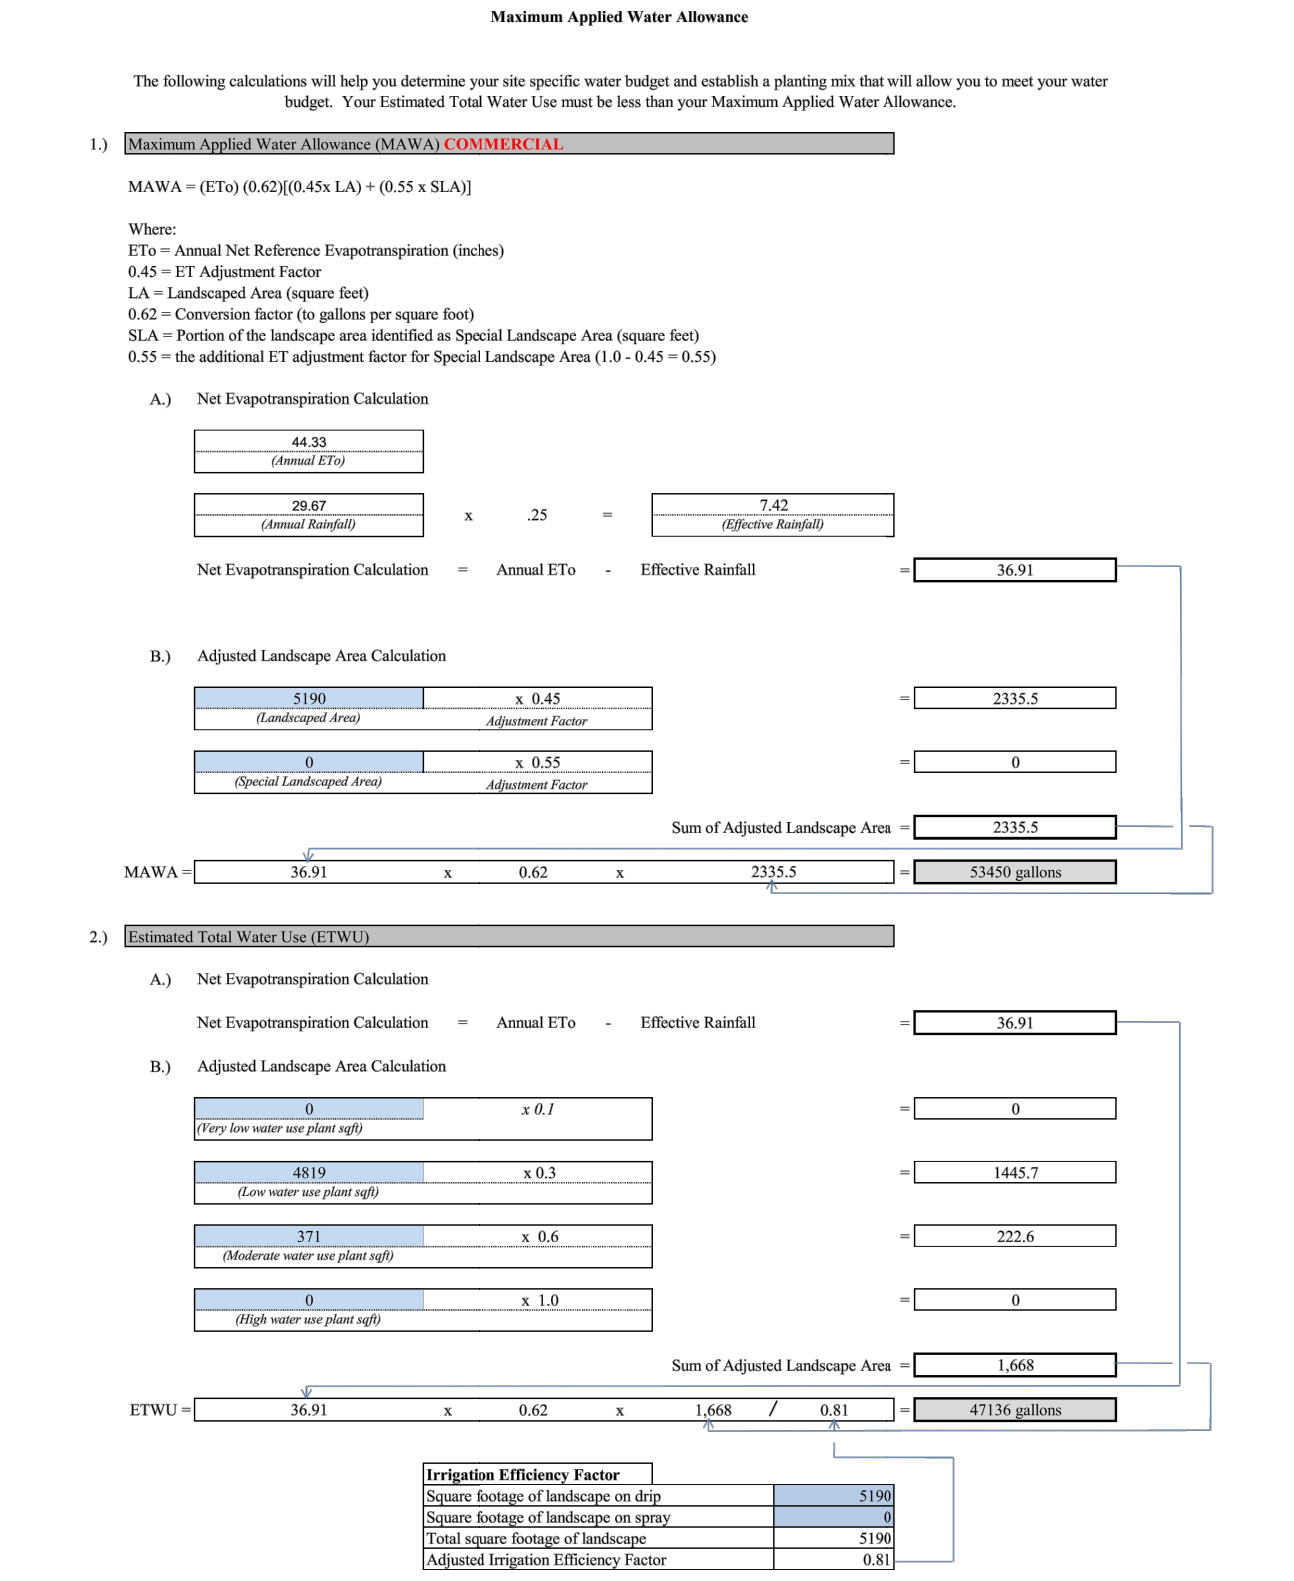

B FRONTAGE LANDSCAPE - ELEVATION (SEE SHEET L2 FOR IMAGES OF KEY PLANT MATERIALS)

PRELIMINARY LANDSCAPE PLANS - FINAL DESIGN REVIEW
WEST COAST SELF STORAGE

970 PINER ROAD
SANTA ROSA, CA 95404
APN: 015-680-013

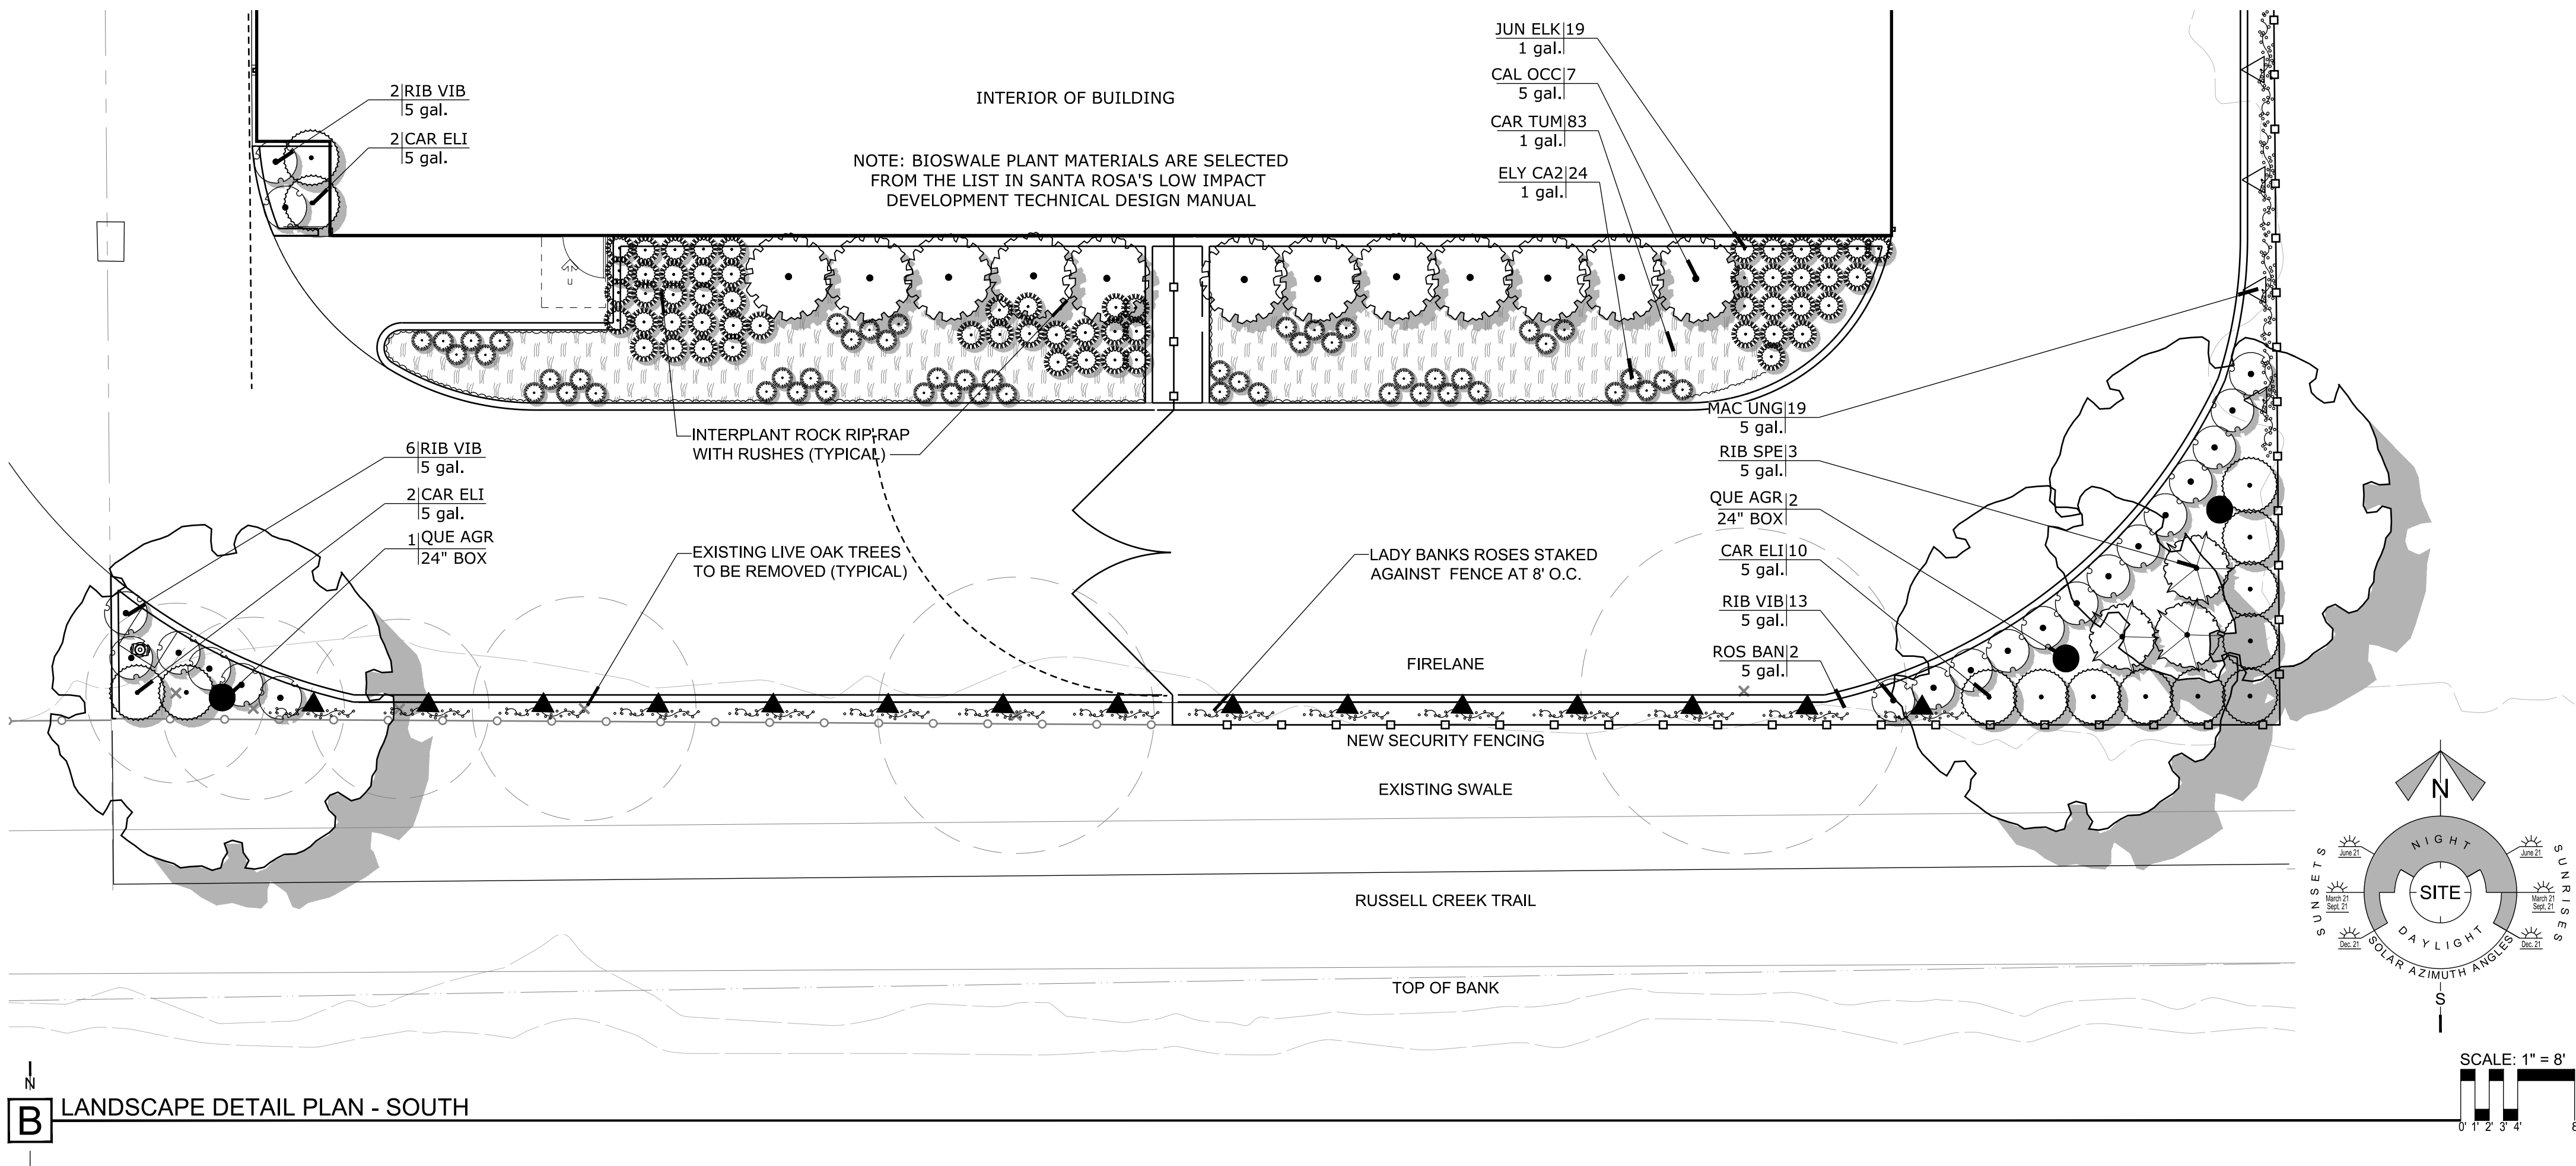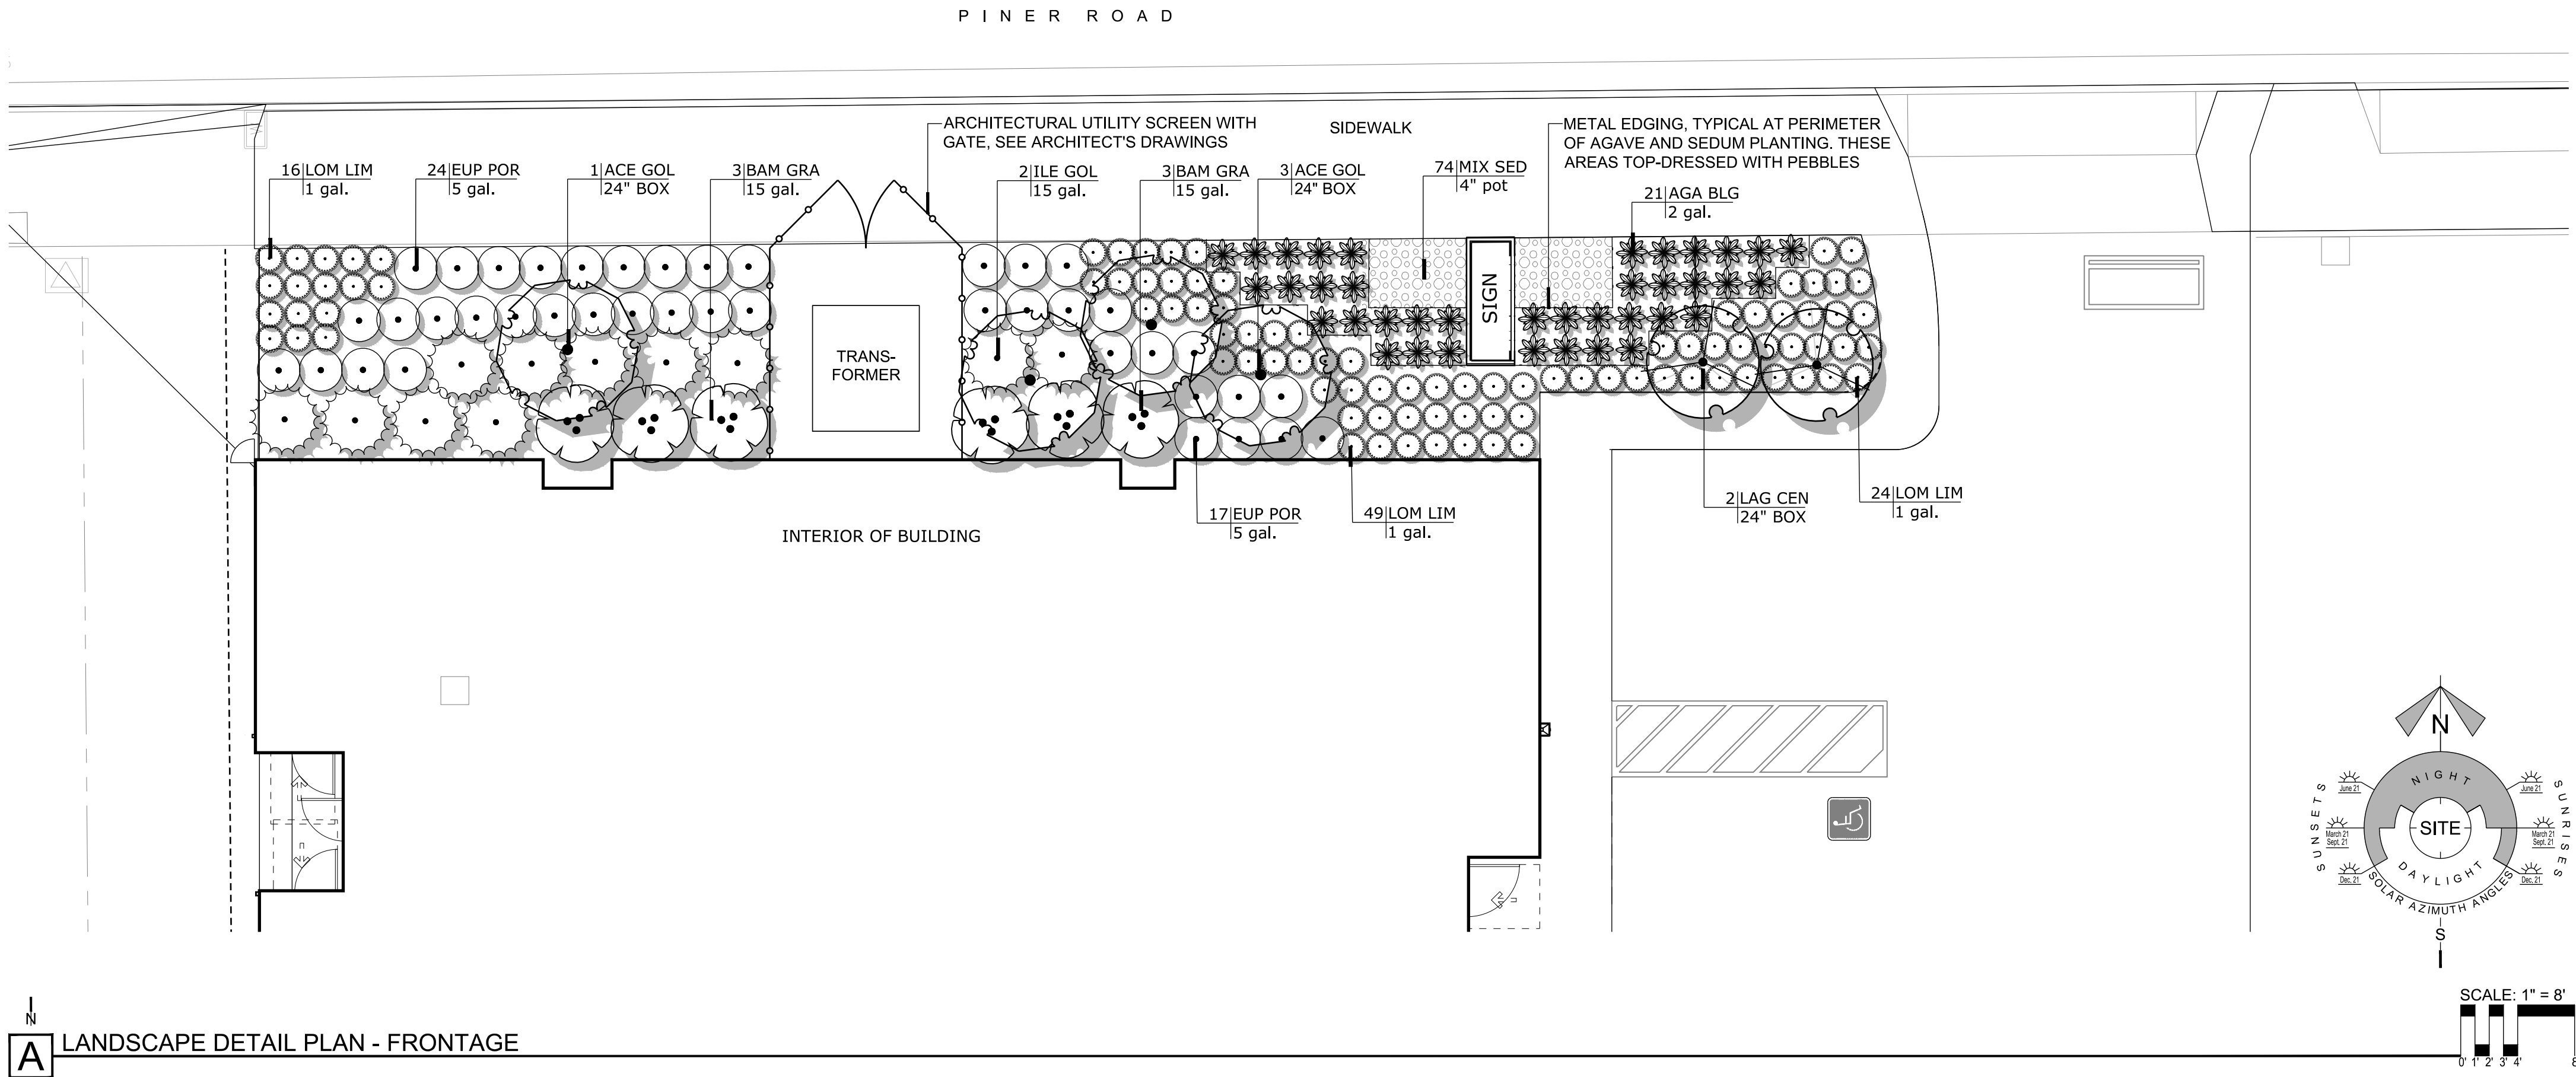

PLANT LEGEND

TREES	CODE	BOTANICAL NAME	COMMON NAME	SIZE	QTY
	ACE GOL	ACER RUBRUM 'ARMSTRONG GOLD'	GOLDEN ARMSTRONG MAPLE	24" BOX	4
	LAG CEN	LAGERSTROEMIA INDICA 'CENTENNIAL SPIRIT'	COLUMNAR CRAPE MYRTLE	24" BOX	2
	QUE AGR	QUERCUS AGRIFOLIA	COAST LIVE OAK	24" BOX	3
SHRUBS	CODE	BOTANICAL NAME	COMMON NAME	SIZE	QTY
	AGA BLG	AGAVE X 'BLUE GLOW'	BLUE GLOW AGAVE	2 GAL.	38
	BAM GRA	BAMBUSA TEXTILIS 'GRACILIS'	SLENDER WEAVER'S BAMBOO	15 GAL.	6
	CAL OCC	CALYCANTHUS OCCIDENTALIS	SPICE BUSH	5 GAL.	12
	CAR ELI	CARPENTERIA CALIFORNICA 'ELIZABETH'	ELIZABETH BUSH ANEMONE	5 GAL.	14
	ELY CA2	ELYMUS CONDENSATUS 'CANYON PRINCE'	CANYON PRINCE WILD RYE	1 GAL.	52
	EUP POR	EUPHORBIA CHAR. 'PORTUGUESE VELVET'	PORTUGUESE VELVET SPURGE	5 GAL.	41
	ILE GOL	ILEX AQUIFOLIUM 'GOLD COAST' TM	GOLD COAST HOLLY	15 GAL.	11
	JUN ELK	JUNCUS PATENS 'ELK BLUE'	SPREADING RUSH	1 GAL.	59
	LOM LIM	LOMANDRA X 'LITTLE LIME'	LITTLE LIME MAT RUSH	1 GAL.	96
	RIB SPE	RIBES SPECIOSUM	FUCHSIA FLOWERING GOOSEBERRY	5 GAL.	3
	RIB VIB	RIBES VIBURNIFOLIUM	EVERGREEN CURRANT	5 GAL.	21
VINES	CODE	BOTANICAL NAME	COMMON NAME	SIZE	QTY
	MAC UNG	MACFADYENA UNGUIS-CATI	YELLOW TRUMPET VINE	5 GAL.	19
	ROS BAN	ROSA BANKSIAE	LADY BANKS ROSE	5 GAL.	15
GROUND COVERS	CODE	BOTANICAL NAME	COMMON NAME	SIZE	QTY
	CAR TUM	CAREX TUMULICOLA	FOOTHILL SEDGE	1 GAL. @18" O.C.	168
	MIX SED	MIXED SEDUMS AND SUCCULENTS	SEE BELOW	4" POT @12" O.C.	77



ACE GOL - 'ARMSTRONG GOLD' MAPLE



LOM LFT - LITTLE LIME LOMANDRA



EUP POR - VELVET SPURGE



BAM GRA - SLENDER WEAVER'S BAMBOO



LAG CEN - CRAPE MYRTLE



BLUE GLOW AGAVE




MIXED SEDUMS AND SUCCULENTS



ILE GOL - GOLD COAST HOLLY

PRELIMINARY LANDSCAPE PLANS - FINAL DESIGN REVIEW
WEST COAST SELF STORAGE

970 PINER ROAD
SANTA ROSA, CA 95404
APN: 015-680-013

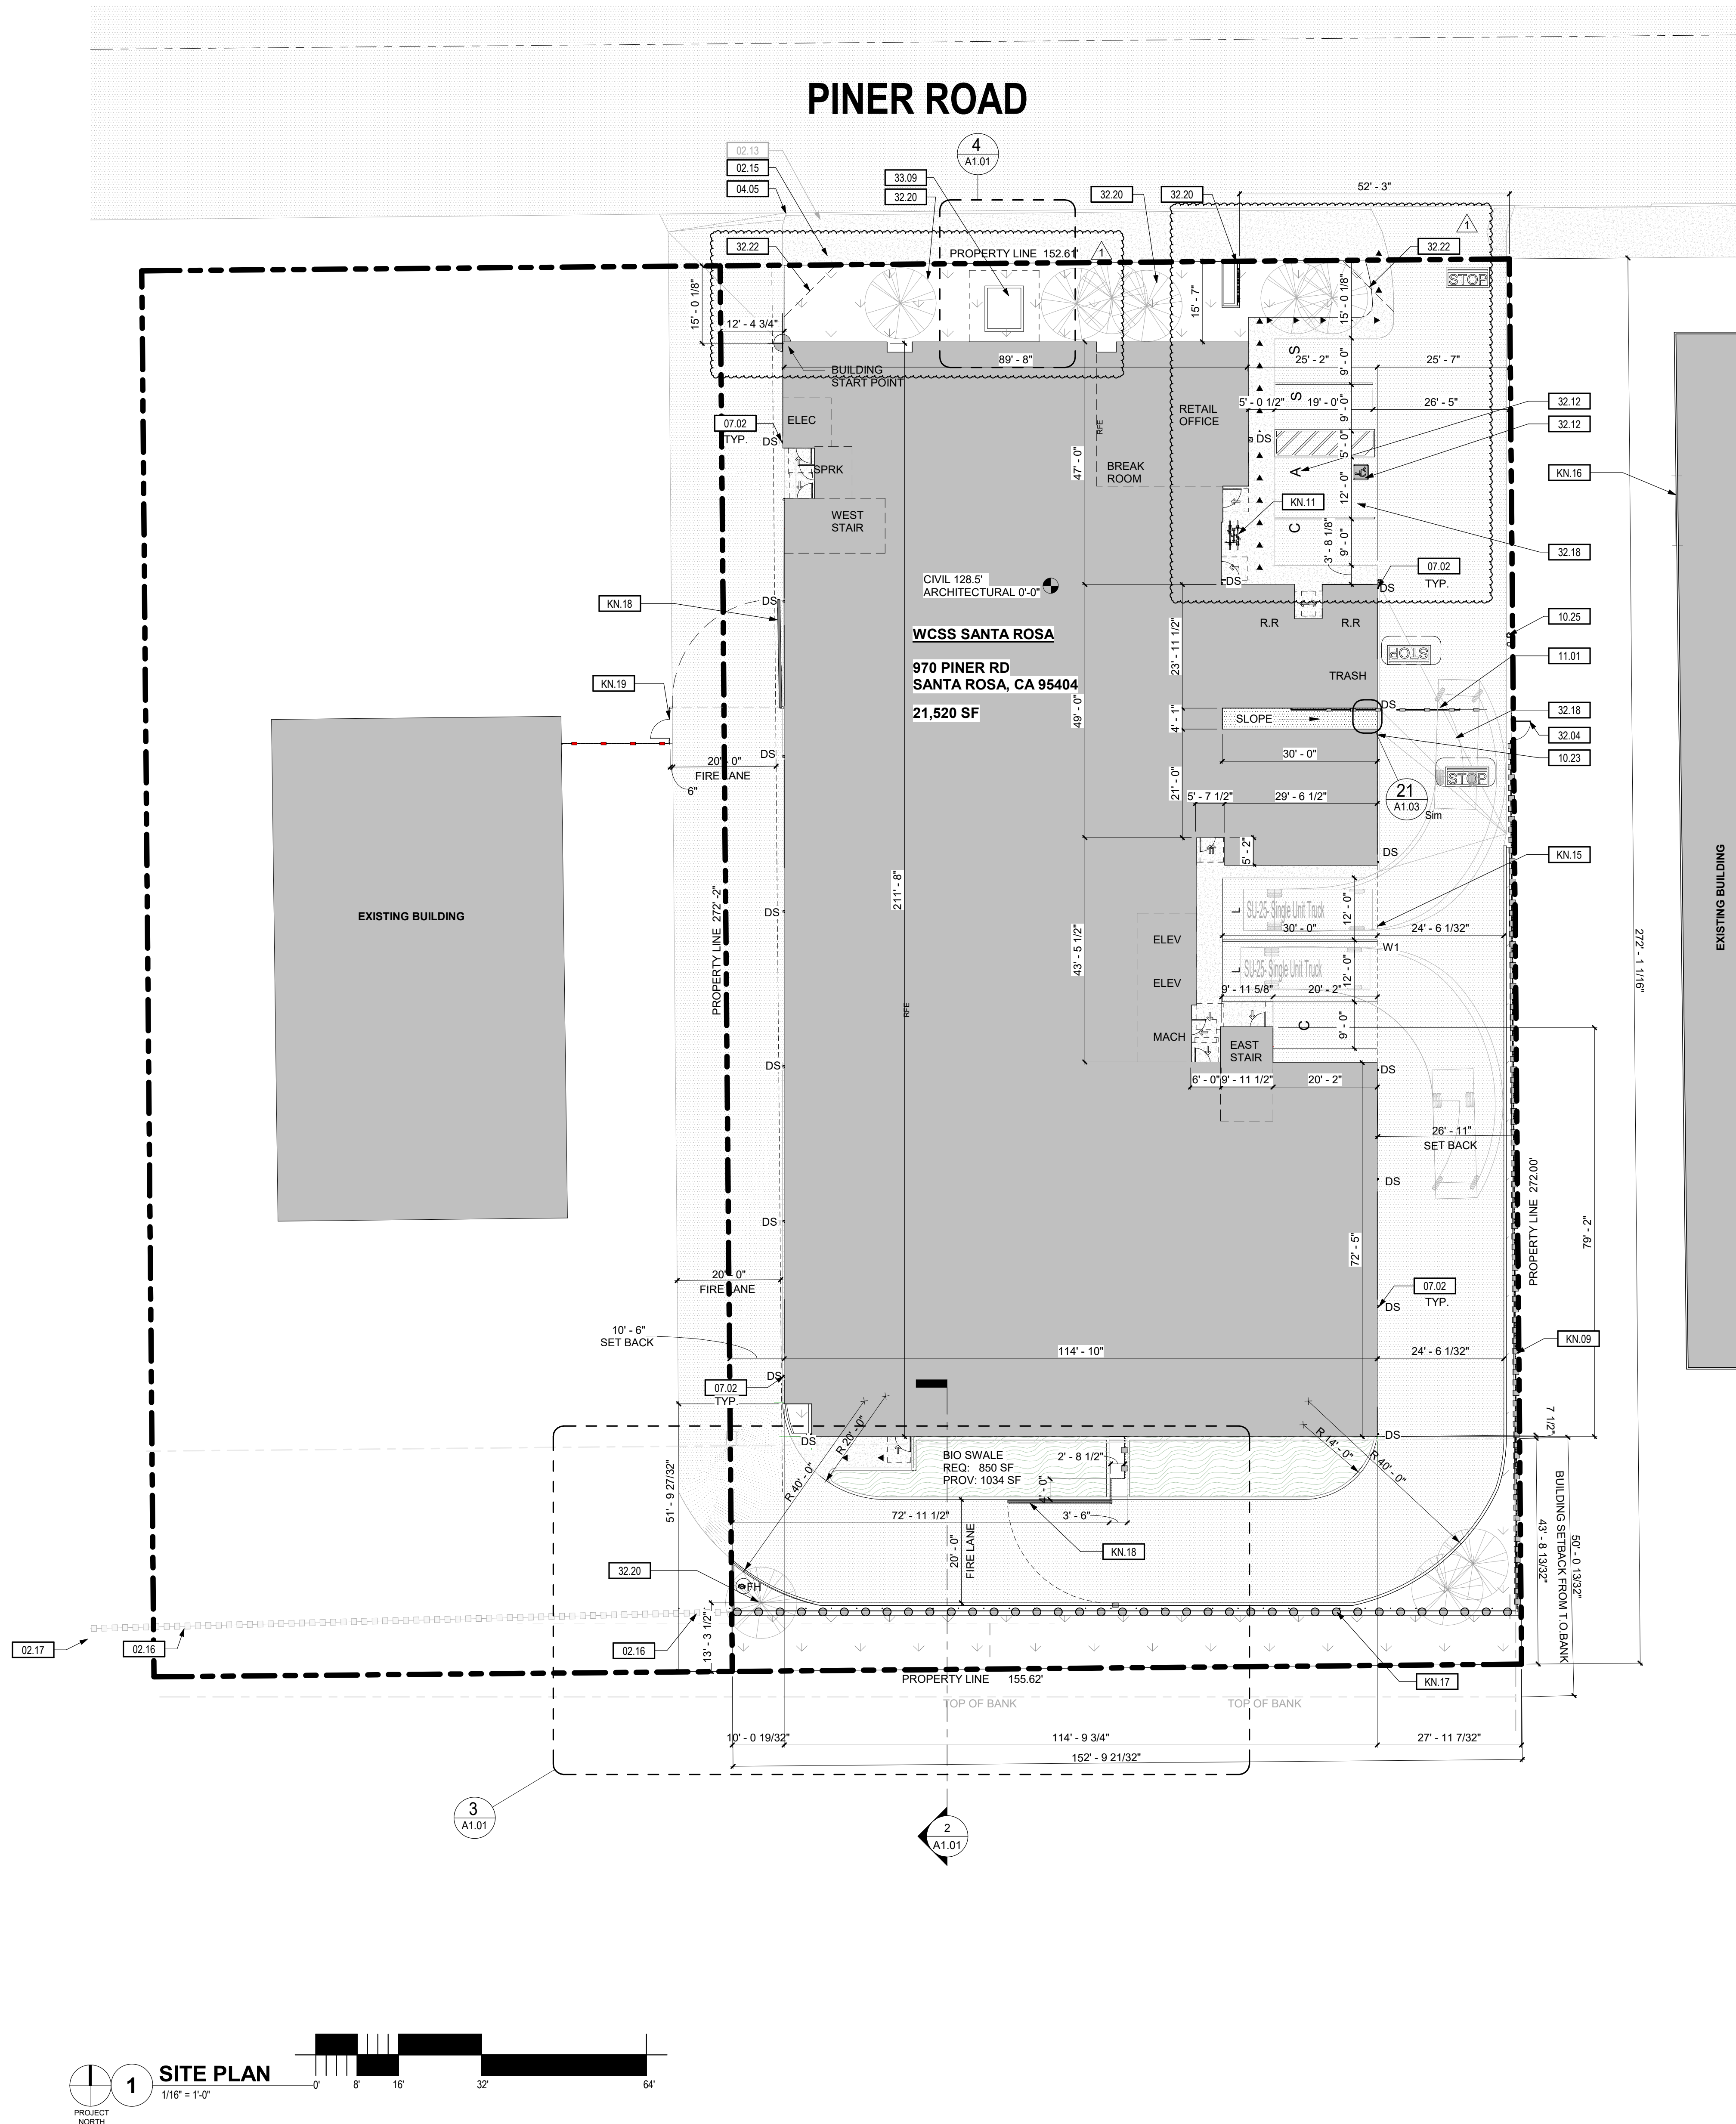

SHEET NOTES:

- A. LIMITS OF WORK ARE DEFINED WITHIN THE PROPERTY LINES AND ADJACENT RIGHT OF WAYS.
B. SITE CONTROLS ARE EXISTING PROPERTY CORNERS AS IDENTIFIED BY PROPERTY SURVEY.
C. REFER TO LANDSCAPE DRAWINGS FOR ADDITIONAL INFORMATION ON ALL LANDSCAPE FEATURES AND ELEMENTS.
D. REFER TO CIVIL DRAWINGS FOR SITE GRADING AND UTILITY LOCATIONS.
E. EXPANSION JOINTS ARE SHOWN ON SITE PLANS. ALL OTHER LINES WITHIN CONCRETE PAVING AREAS ARE TO BE CONTROL JOINTS UNLESS OTHERWISE NOTED. REFER TO CIVIL DRAWINGS.
F. SIDEWALKS TO MAINTAIN A SLOPE NO GREATER THAN 1:20 IN THE PRIMARY DIRECTION OF TRAVEL AND A SLOPE NO GREATER THAN 1:50 PERPENDICULAR TO THE PRIMARY DIRECTION OF TRAVEL. REFER TO CIVIL DRAWINGS.
G. CURB TO BE MEDIUM BROOM FINISH, PARALLEL TO GUTTER LINE, UNLESS OTHERWISE NOTED.
H. GRIDLINES CORRESPOND WITH BUILDING FLOOR PLAN GRIDLINES.
I. REFER TO ELECTRICAL DRAWINGS FOR SITE LIGHTING.
J. ARCHITECT SITE PLAN IS SHOWN FOR REFERENCE ONLY. REFER TO CIVIL AND LANDSCAPE DRAWINGS FOR PARAMETERS OF SITE INCLUDING ROADWORK, SITE STRIPING, LANDSCAPING AND CONTEXTUAL SITE INFORMATION.
K. REFER TO CIVIL FOR FINISH FLOOR ELEVATIONS (FFE) - THESE CORRESPOND TO ARCHITECTURAL 0'-0"

AREA CALCULATIONS:

BUILDING AREA:	ZONING:
LEVEL 1: 21,520 SF	LIGHT INDUSTRIAL (IL) SRMC
LEVEL 2: 21,650 SF	20-24.040
LEVEL 3: 22,910 SF	
TOTAL: 66,080 SF	
LOT AREA:	
+/- 41,382 SF	
BUILDING COVERAGE: 21,421 SF	
BUILDING LOT COVERAGE: 52%	

SETBACKS: REQ.	SETBACKS: PROPOSED
FRONT: NORTH (15')	NORTH (15')
REAR: SOUTH (50' FROM TOP OF BANK)	SOUTH (50' FROM TOP OF BANK)
SIDE: EAST (0' SETBACK REQ.) WEST (10' EASEMENT FROM P.L.)	EAST (26'-11" PROPOSED) WEST (10'-6" PROPOSED)

REQUIRED PARKING PER (SRMC :20-36.040):	PROPOSED PARKING SIZE PER (SRMC :20-36.070):
5 CUSTOMER	5 CUSTOMER
	2 (S) STANDARD (9x19')
	2 (C) STANDARD (9x16')
	1 ACCESSIBLE VAN (12x19') W/ 5ft-STRIPING
2 LOADING DOCKS	2 LOADING DOCKS (10x30')
0 BICYCLE	BICYCLE : 2 PROVIDED.

SITE PLAN LEGEND

	PROPERTY LINE
	BUILDING FOOTPRINT
	LANDSCAPING
	ASPHALT
	PROPOSED CONCRETE
	WROUGHT IRON FENCE
	CHAIN LINK FENCE
	TRAFFIC DIRECTIONAL ARROWS
	EGRESS PATH
	FIRE HYDRANT - REF. CIVIL
	BOLLARDS. REF. CIVIL
	DOWNSPOUT WITH BOOT PER. CIVIL

KEYNOTES:

#	NOTE
02.13	EXISTING POWER POLE WITH SERVICE DROP. TO BE RELOCATED.
02.15	EXISTING ELECTRICAL BOX
02.16	EXISTING FENCE TO REMAIN
02.17	EXISTING TREE TO BE REMOVED
04.05	NEW CURB CUT
07.02	18ga. PRE-FINISHED ALUMINUM DOWNSPOUT PER S.M.A.C.N.A. RECOMMENDATIONS. SIZED PER ROOF DRAINAGE CALCULATIONS; COLOR PER EXTERIOR ELEVATIONS. PROTECTION BOOT AT BASE REF. CIVIL
10.23	CONCRETE PAD FOR GATE CONTROL. B.O.D SHUGARD LINEAR GATE OPERATOR (SLIDING. SL SERIES. SWING; SWC SERIES)
10.25	ENTRY KEY PAD REF. SITE DETAILS
11.01	VEHICULAR ACCESS GATE PER SITE PLAN AND DETAILS; BASIS OF DESIGN: TELESCOPING ROLLING GATE WITH 20'-0" CLEAR OPENING (OR GREATER PER F.D.); MOTOR OPERATOR. KEY-PAD PANEL MOUNTED ON KEYPAD BOLLARD PER DETAIL; PROVIDE ELECTRICAL CONDUIT RUNS TO MOTOR OPERATOR AND BOLLARD LOCATIONS; REF. ELECTRICAL SITE PLAN
32.04	CHAIN-LINK PEDESTRIAN GATE. TUBULAR METAL. 36" WIDE EQUIPPED WITH ANSI A117-1 COMPLIANT HARDWARE AND MESH TO PREVENT ENTRY OR ACTUATION FROM EXTERIOR SIDE. MATERIALS AND COLOR TO MATCH CHAIN-LINK FENCING
32.12	ACCESSIBLE PARKING PER PLANS AND CIVIL;
32.18	STRIPING PER CIVIL TYP.
32.20	TREE. REF. LANDSCAPING PLANS
32.22	CITY REQUIRED VIEW ANGLE AT STREET (10x10')
33.08	ELECTRICAL TRANSFORMER. REF. ELECTRICAL DRAWINGS
KN.09	NEW 6'-0" WROUGHT IRON SECURITY FENCING. REF. SITE DETAILS;
KN.11	BICYCLE RACK/PARKING REF. SITE DETAILS;
KN.15	BUILDING OUTLINE ABOVE
KN.16	NEIGHBORS SHOP BAY DOOR
KN.17	NEW CHAIN-LINK FENCE 6'-0". REF. SITE DETAILS
KN.18	MANUALLY CONTROLLED GATE. AT OPEN POSITION. REF. SITE DETAILS
KN.19	PEDESTRIAN GATE. EXIT ONLY. REF. SITE DETAILS

DATE	NO.	DESCRIPTION
07/24/21	0	DESIGN REVIEW - DRL1-004
08/24/21	1	AND DR RESPONSE #1

NOT FOR CONSTRUCTION
FOR REVIEW ONLY


PROJECT NO.:	20143
PROJECT MGR.:	LH
DRAWN BY:	AK
CHECKED BY:	LH

SITE PLAN

A1.00




#	NOTE
32.10	FORMED CONCRETE CURB AND GUTTER PER PLANS; REF. CIVIL DRAWINGS FOR ADDITIONAL INFORMATION
32.19	6" CURB ALONG DRIVE ISLE
33.09	ELECTRICAL TRANSFORMER REF ELECTRICAL DRAWINGS

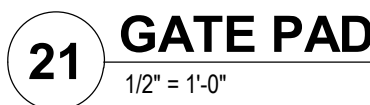

16 BICYCLE RACK - SINGLE LOOP STEEL TUBE
1/2" = 1'-0"



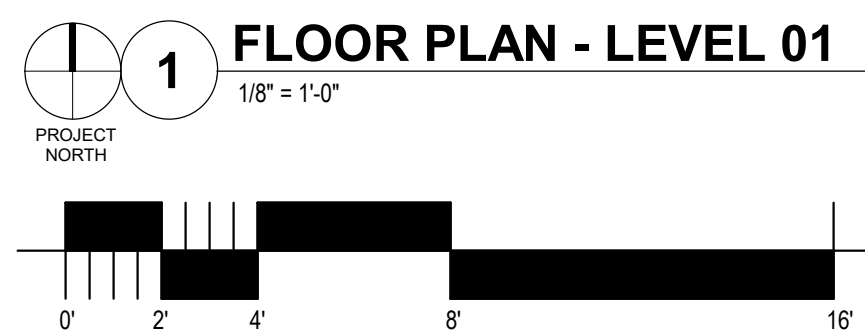









BUILDING AREA:	
LEVEL 1 :	21,520 SF
LEVEL 2 :	21,650 SF
LEVEL 3 :	22,910 SF
TOTAL	66,080 SF

#	NOTE
05.15	STEEL COLUMN, REF. STRUCTURAL PAINT TO MATCH AJEANT WALL FINISH IF EXPOSED.
07.02	18ga. PRE-FINISHED ALUMINUM DOWNPOUT PER S.M.A.C.N.A. RECOMMENDATIONS, SIZED PER ROOF DRAINAGE CALCULATIONS; COLOR PER EXTERIOR ELEVATIONS, PROTECTION BOLT AT BASE REF. CIVIL
10.28	GATE CONTROLLER PAD: B O D LINEAR SL SERIES. REF. WCSS SPECS
12.01	BICYCLE RACK SYSTEM, REF. 16A1.03
32.08	CATCH BASIN PER CIVIL PLANS
32.17	BOLLARD LOCATED PER PLANS, DETAIL PER CIVIL, TYP.
KN.15	BUILDING OUTLINE ABOVE



LEVEL 1 :	21,520 SF
LEVEL 2 :	21,650 SF
LEVEL 3 :	22,910 SF
TOTAL	66,080 SF

LEGEND- FLOOR PLAN

 FH	FIRE HYDRANT - REF. CIVIL.
	BOLLARDS. REF CIVIL..
 DS	DOWNSPOUT WITH BOOT PER. CIVIL.
	1HR RATED WALL. REF. A8,XX SERIES
	WALLS WITHIN 25FT OF ELEVATOR TO HAVE METAL WAINSCOT TO NEAREST CORNER
	INSULATED WALLS
	RECESSED FIRE EXTINGUISHER
	ACCESSIBLE UNITS.REF. 1/G0,04

KEYNOTES:

#	NOTE
05.12	STEEL COLUMN, REF. STRUCTURAL PAINT TO MATCH EXISTING WALL FINISH IF EXPOSED.
07.05	18ga. PRE-FINISHED ALUMINUM DOWNSPOUT PER S.M.A.C.N.A. RECOMMENDATIONS. SIZED PER ROOF DRAINAGE CALCULATIONS. COLOR PER EXTERIOR ELEVATIONS. PROTECTION BOOT AT BASE REF. CIVIL
10.29	SURFACE MOUNTED 3/8" FAULK ROOF-LIP DOOR. JUNIS ROYAL BLUE. SPACE EQUALLY ON WALL
10.30	MECHANICAL EQUIPMENT SCREENING WALL. REF EXTERIOR DETAILS
13.03	SURFACE MOUNTED FRAMING AND SPANDREL GLASS "WINDOW" MOUNTED 18" R.F. REF. FAULK WINDOW DETAILS AS A/FU FOR SIZING
26.05	SITE EXTERIOR LIGHTING. WALL MOUNT AT 9'-0" AFF. REF. ELECTRICAL

The logo for Jackson | Main Architecture features a large, stylized 'JM' in a bold, sans-serif font. The letters are white and set against a dark gray background. Below the 'JM', the words 'JACKSON | MAIN' are written in a smaller, all-caps, sans-serif font, followed by 'ARCHITECTURE' in a slightly larger, all-caps, sans-serif font. Below the company name, the address '311 FIRST AVENUE SOUTH SEATTLE, WA 98104' is listed, followed by the phone number 't 206.324.4800' and the website 'WWW.JACKSONMAIN.COM'.

**WEST COAST SELF STORAGE
GROUP**
808 134TH ST SW, BLDG.B, STE 211
EVERETT WA, 98204

WCSS - SANTA ROSA
970 PINER RD,
SANTA ROSA, CA 95404

[illegible]



NOT FOR CONSTRUCTION
FOR REVIEW ONLY

PROJECT NO.:	20143
PROJECT MGR.:	LH
DRAWN BY:	AK
CHECKED BY:	DM

FLOOR PLAN - LEVEL 02

A2.02

20143_WCSS Santa Rosa_detached.rvt 9/13/2021 12:56:30 PM

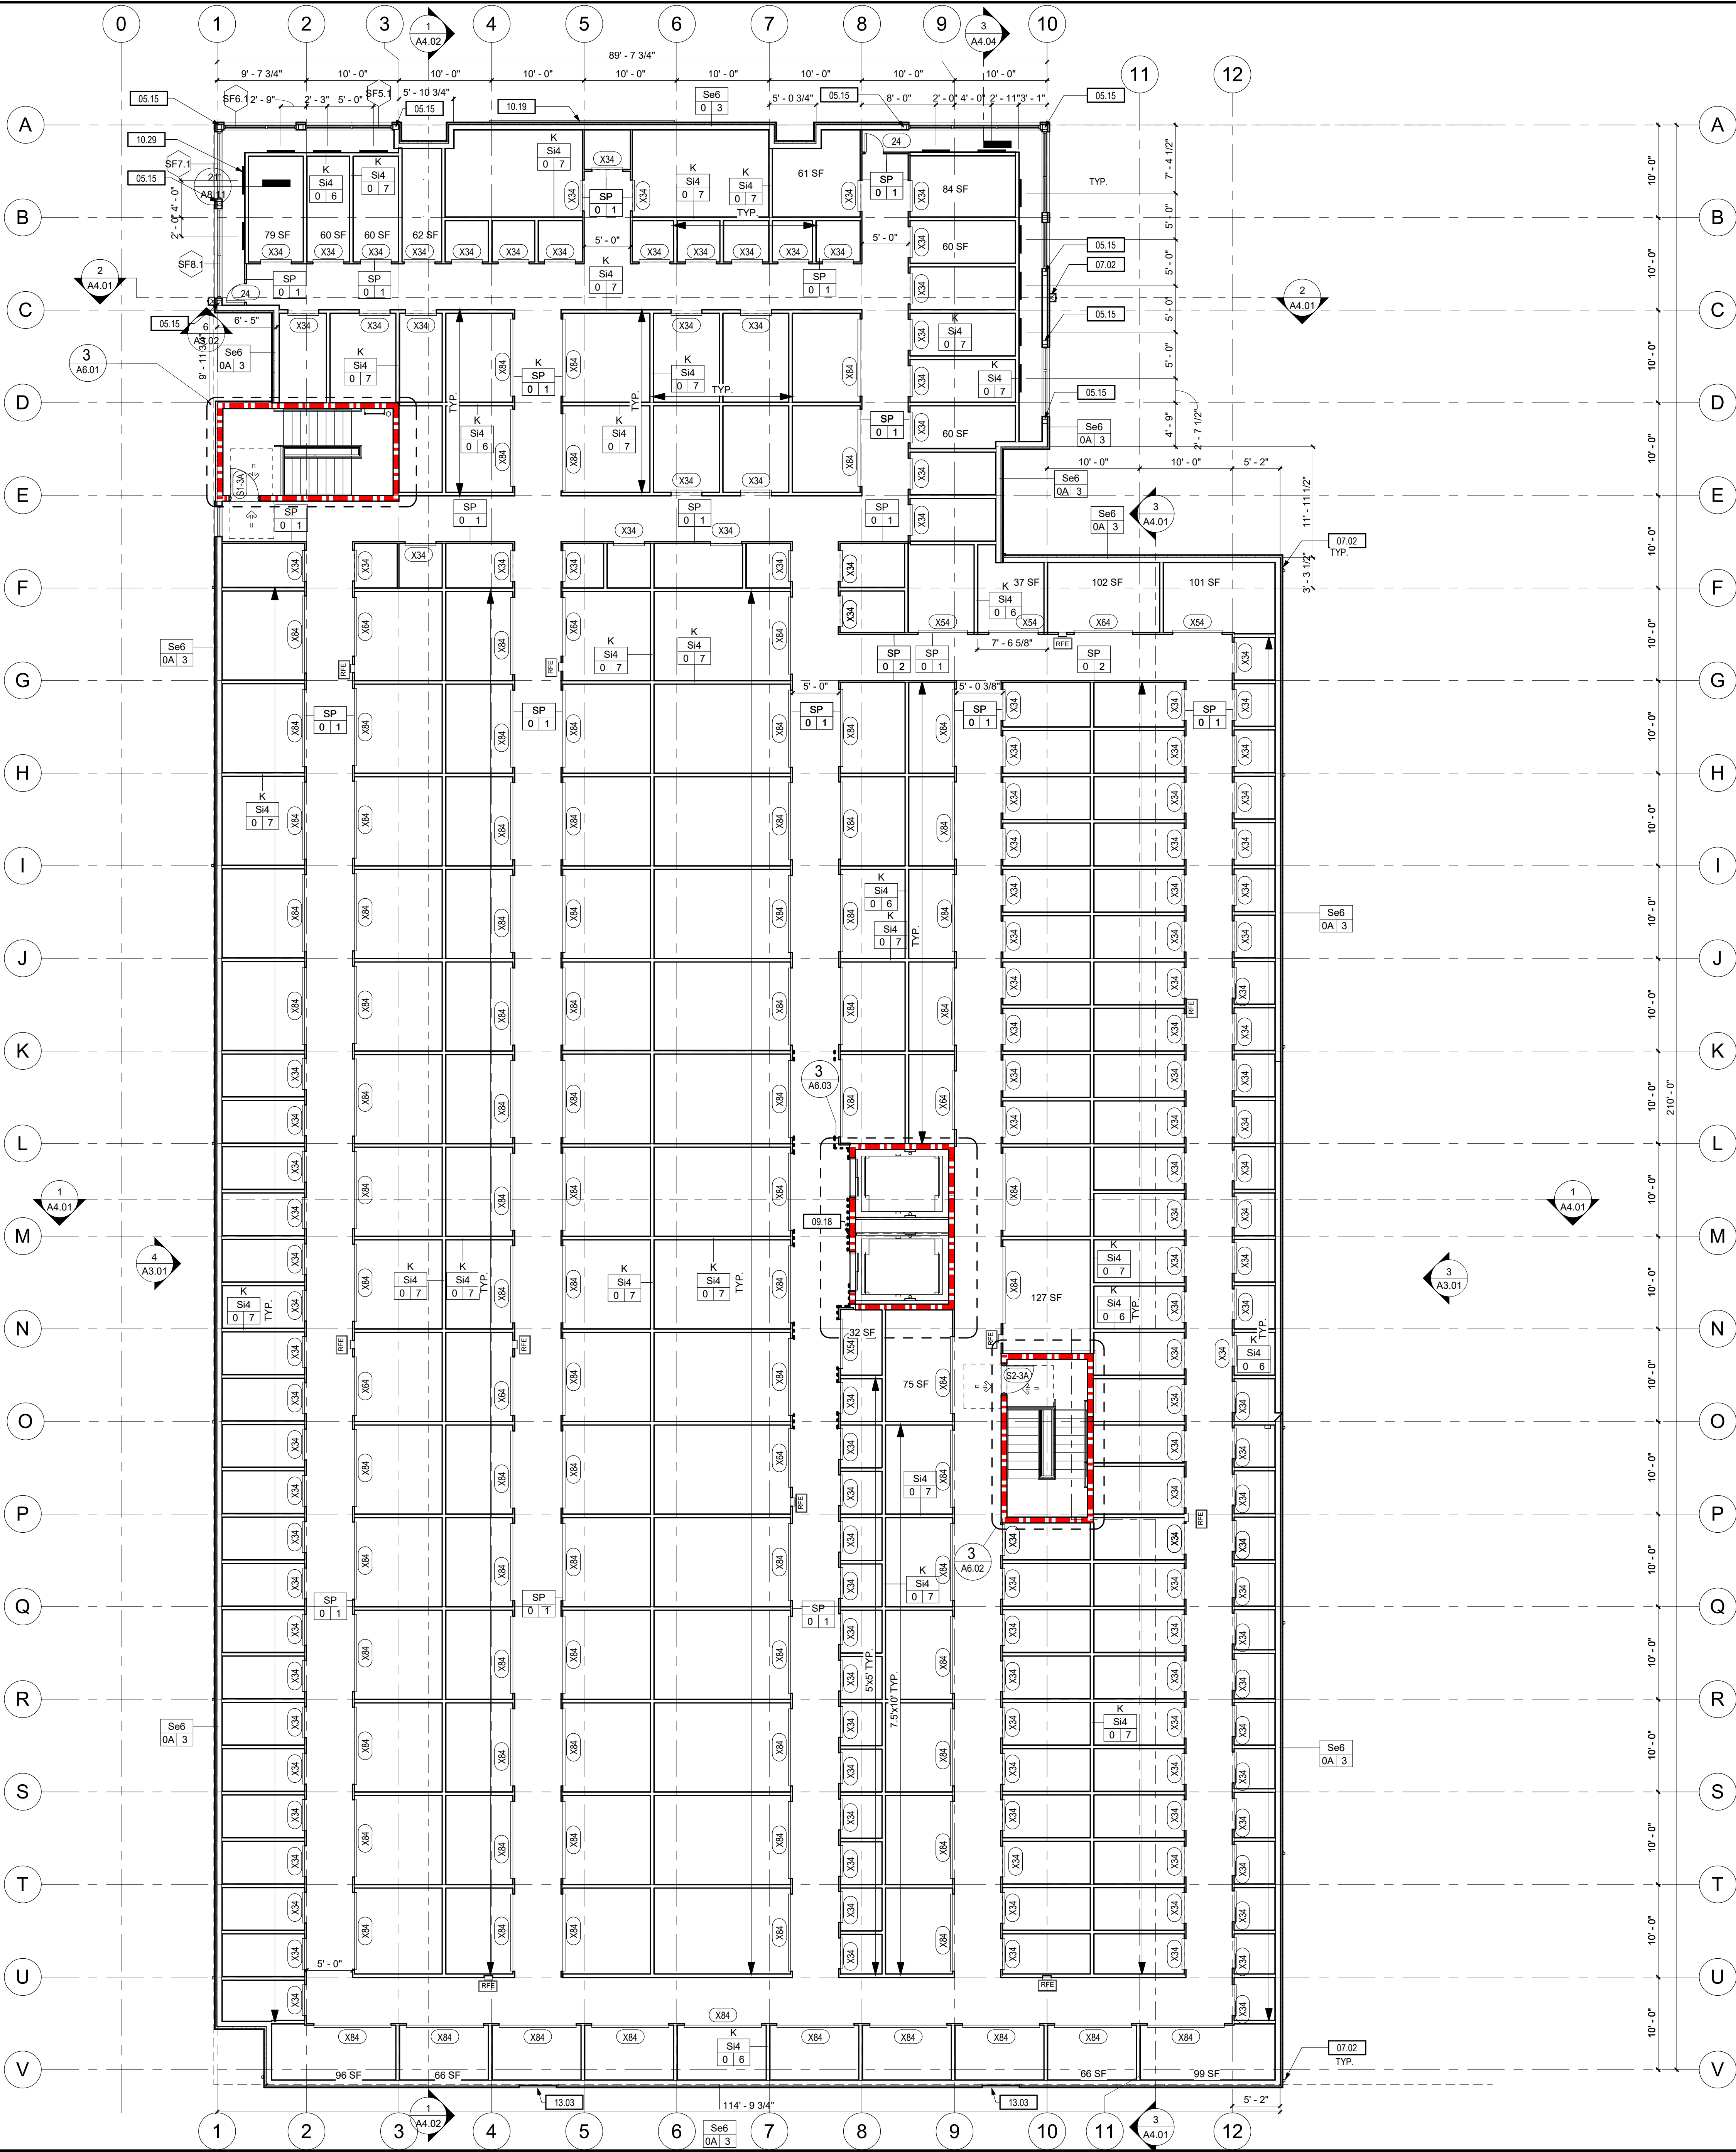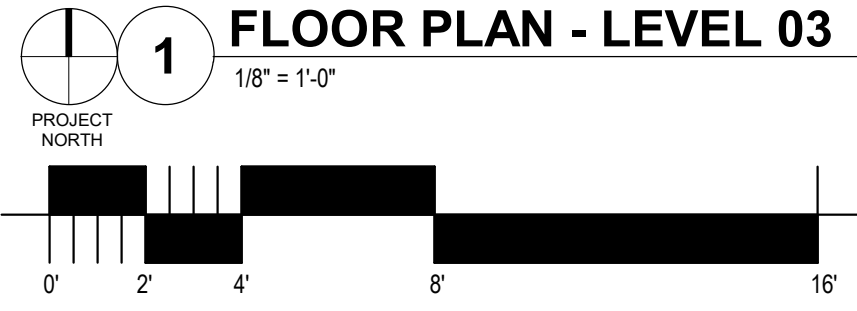

SHEET NOTES:

- A. REFER TO G0.01 FOR ABBREVIATIONS, SYMBOLS AND GENERAL PROJECT NOTES.
- B. REFER TO G SERIES SHEETS FOR CODE & ACCESSIBILITY STANDARDS.
- C. REFER TO A8 SERIES FOR SPECIFIC WALL ASSEMBLY INFORMATION
- D. REFER TO DOOR AND WINDOW MANUFACTURER SPECIFICATIONS FOR ACTUAL ROUGH OPENING SIZES.
- E. REFER TO STRUCTURAL DRAWINGS FOR SHEAR WALL, HOLD DOWN LOCATIONS, AND BEAM SIZES.
- F. PROVIDE WALL GUARDS AT ALL EXPOSED GYPSUM BOARD OUTSIDE CORNERS IN PUBLIC AREAS.
- G. FOR FRAMED WALLS- LOCATE HINGE SIDE OF ALL DOORS 4'-1/2' FROM PERPENDICULAR FRAMING U.N.O.
- H. FOR MASONRY WALLS- LOCATE HINGE SIDE OF DOOR 8" FROM PERPENDICULAR WALL U.N.O.
- I. GENERAL NOTES ON THIS PAGE DO NOT EXCLUDE NOTES ELSEWHERE; THIS DOCUMENT SET IS COMPLEMENTARY. NOTES ON OTHER SHEETS MAY HAVE BEARING/ APPLICATION TO WORK SHOWN ON THIS SHEET

LEGEND- FLOOR PLAN

- FH FIRE HYDRANT - REF. CIVIL
- BOLLARDS. REF. CIVIL.
- DS DOWNSPOUT WITH BOOT PER. CIVIL.
- 1HR RATED WALL. REF. A8.XX SERIES
- WALLS WITHIN 25FT OF ELEVATOR TO HAVE METAL WAINSCOT TO NEAREST CORNER
- INSULATED WALLS
- RECESSED FIRE EXTINGUISHER
- ACCESSIBLE UNITS. REF. 1/G0.04

KEYNOTES:

#	NOTE
05.15	STEEL COLUMN, REF. STRUCTURAL. PAINT TO MATCH AJECENT WALL FINISH IF EXPOSED.
07.02	18ga. PRE-FINISHED ALUMINUM DOWNSPOUT PER S.M.A.C.N.A. RECOMMENDATIONS, SIZED PER ROOF DRAINAGE CALCULATIONS; COLOR PER EXTERIOR ELEVATIONS. PROTECTION BOOT AT BASE. REF. CIVIL.
09.18	WALLS BY ELEVATOR HAVE STEEL WAINSCOT. REF. WCSS SPECS. TYP.
10.19	10x20 AREA FOR BUILDING SIGNAGE, REF. ELEVATIONS. SIGNAGE UNDER SEPARATE PERMIT
10.29	SURFACE MOUNTED 3x8' FAUX ROLL-UP DOOR. JUNUS ROYAL BLUE. SPACE EQUALLY ON WALL.
13.03	SURFACE MOUNTED FRAMING AND SPANDREL GLASS "WINDOW" MOUNTED OVER W.R.B. REF. FAUX WINDOW DETAILS (A8.04) FOR SIZING



WEST COAST SELF STORAGE GROUP
808 134TH ST SW, BLDG.B, STE 211
EVERETT WA, 98204

WCSS - SANTA ROSA
970 PINER RD.
SANTA ROSA, CA 95404

DATE	NO.	DESCRIPTION


NOT FOR CONSTRUCTION
FOR REVIEW ONLY

PROJECT NO.: 20143
PROJECT MGR.: LH
DRAWN BY: AK
CHECKED BY: DM

FLOOR PLAN - LEVEL 03

A2.03

JACKSON | MAIN ARCHITECTURE P.S. © 2021

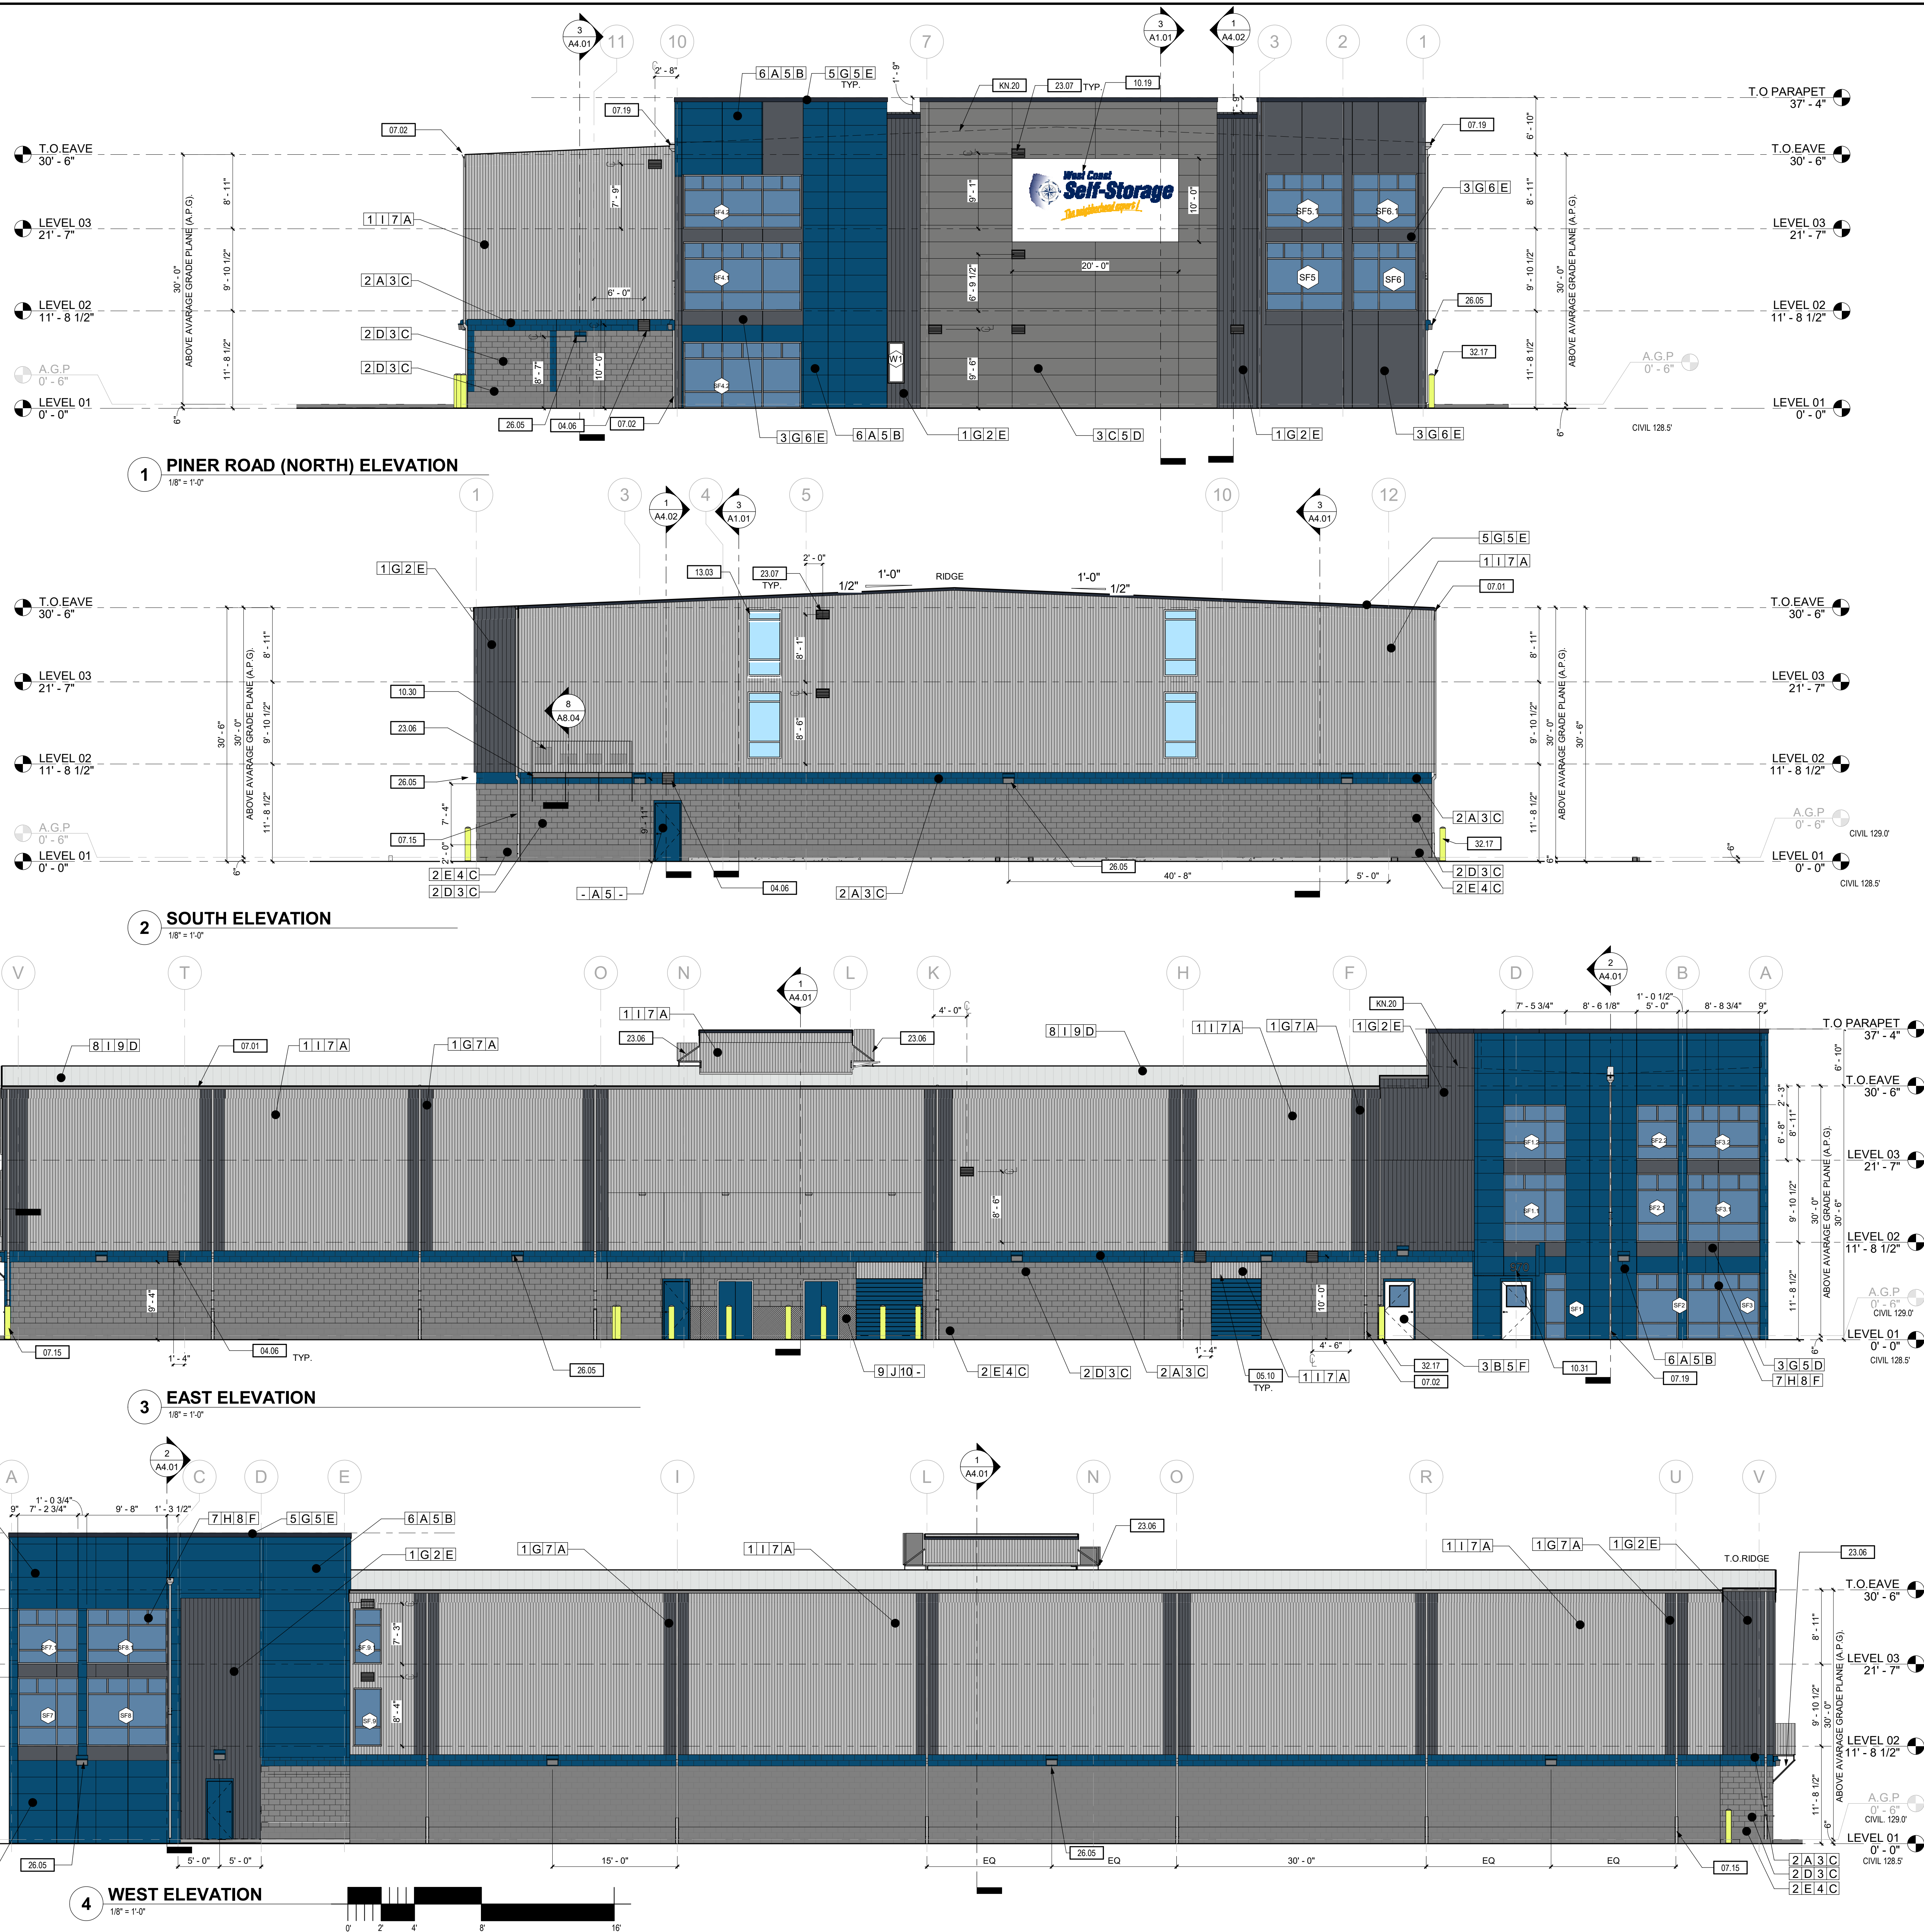

MATERIAL LEGEND

PRODUCT COLOR PROFILE MANUFACTURER

PRODUCTS

1. VERTICAL METAL SIDING
2. CONCRETE MASONRY UNITS
3. METAL PANELS
4. STANDING SEAM ROOFING
5. FLASHING
6. CEMENT BOARD PANEL (WI PAINTED ALUMINUM EXPOSURE PANEL)
7. K700 SERIES STOREFRONT
8. STANDING SEAM ROOF SYSTEM
9. WAINSCOT

PROFILE / TEXTURE

1. 24ga SINEWAVE 2" PANELS
2. 24ga 4" BOX RIB PROFILE
3. GROUND FACE C.M.U.
4. SPLIT FACE C.M.U.
5. SMOOTH PANEL
6. 12" SMOOTH FACE
7. 24" BOLD RIB
8. 24x4 MILLION
9. ULTRA DECK
10. DIAMOND PLATE

COLOR

- A. SHERWIN WILLIAMS - 6804 DIGNITY BLUE
- B. WHITE
- C. SHERWIN WILLIAMS - 2849 WESTCHESTER GRAY
- D. MURAL
- E. CHARCOAL
- F. OLD TOWN GRAY (COLOR W25)
- G. SLATE GRAY (COLOR W08)
- H. ANODIZED
- I. SLATE WHITE
- J. POLISHED ALUMINUM

MANUFACTURER

- A. CORRUGATED METALS INC.
- B. JAMES HARDIE
- C. MUTUAL MATERIALS
- D. HIBI - METAL PRODUCTS
- E. METAL SALES
- F. KAWNEER

KEYNOTES:

#	NOTE
04.06	MASONRY OPENING, REF. STRUCTURAL STANDARD MASONRY OPENING DETAIL.
05.01	METAL PANELS OVER C.M.U. AT EXTERIOR OVERHEAD DOORS, REF. DETAIL 61/47 40 FINISH PER SCHEDULE (OR EXTERIOR ELEVATIONS)
07.01	PRE-FINISHED ALUMINUM GUTTERS PER S.A.C.N.A. RECOMMENDATIONS, SIZED PER ROOF DRAINAGE CALCULATIONS, COLOR PER EXTERIOR ELEVATIONS
07.02	18ga. PRE-FINISHED ALUMINUM DOWNSPOUT PER S.A.C.N.A. RECOMMENDATIONS, SIZED PER ROOF DRAINAGE CALCULATIONS, COLOR PER EXTERIOR ELEVATIONS, PROTECTION BOOT AT BASE, REF. CIVIL
07.15	4x3" DOWNSPOUT WITH A PROTECTION BOOT AT BASE, REF. DETAIL ON (A8.04) PAINT TO MATCH BUILDING
07.16	PRE-FINISHED ALUMINUM DOWNSPOUT WITH 5x16" OVERFLOW SCUPPER (REF. 15/48.05) PER S.A.C.N.A. RECOMMENDATIONS, SIZED PER ROOF DRAINAGE CALCULATIONS, COLOR PER EXTERIOR ELEVATIONS, PROTECTION BOOT AT BASE OF SCUPPER, REF. DETAIL ON (A8.04)
10.19	10x20 AREA FOR BUILDING SIGNAGE, REF. ELEVATIONS, SIGNAGE UNDER SEPARATE PERMIT
13.03	MECHANICAL EQUIPMENT SCREENING WALL, REF. EXTERIOR DETAILS
13.04	PROJECT ADDRESS IN CONTRASTING COLORS, MIN LETTER HEIGHT 6", TO BE WITH FIRE MARSHAL PRIOR FOR APPROVAL, TO PURCHASE OR INSTALLATION
13.03	SURFACE MOUNTED FRAMING AND SPANDREL GLASS "WINDOW" MOUNTED OVER W.B. REF. FAUX WINDOW DETAIL ON (A8.04) FOR SIZING
13.06	HEAT PUMP EQUIPMENT MOUNTED ON WALL PLATFORM, REF. STRUCTURAL FOR DETAIL, SCREENING WALL TO MATCH BUILDING SIDING
23.05	LOUVER SIZES PER MECHANICAL PLANS
26.05	EXTERIOR LIGHTING WALL MOUNT AT 9'-0" AFF, REF. ELECTRICAL
32.17	BOLLARD LOCATED PER PLANS, DETAIL FOR CIVIL, TYP.
KN.20	ROOF OUTLINE BEYOND

The logo for Jackson | Main Architecture features a large, stylized 'JM' in a bold, sans-serif font. The letters are white and set against a dark gray background. A thin vertical line separates the 'J' and the 'M'. Below the 'JM' is the text 'JACKSON | MAIN' in a smaller, all-caps, sans-serif font, followed by 'ARCHITECTURE' in a slightly larger, all-caps, sans-serif font. Below this, the address '311 FIRST AVENUE SOUTH' and 'SEATTLE, WA 98104' are listed, followed by the phone number 't 206.324.4800' and the website 'WWW.JACKSONMAIN.COM'.

JM

JACKSON | MAIN
ARCHITECTURE

311 FIRST AVENUE SOUTH
SEATTLE, WA 98104
t 206.324.4800
WWW.JACKSONMAIN.COM

WEST COAST SELF STORAGE
GROUP
808 134TH ST SW, BLDG.B, STE 211
EVERETT WA. 98204






WCSS - SANTA ROSA
970 PINER RD,
SANTA ROSA, CA 95404

NOT FOR CONSTRUCTION
FOR REVIEW ONLY

PROJECT NO.:	20143
PROJECT MGR.:	LH
DRAWN BY:	AK
CHECKED BY:	DM

EXTERIOR ELEVATIONS

A3.01

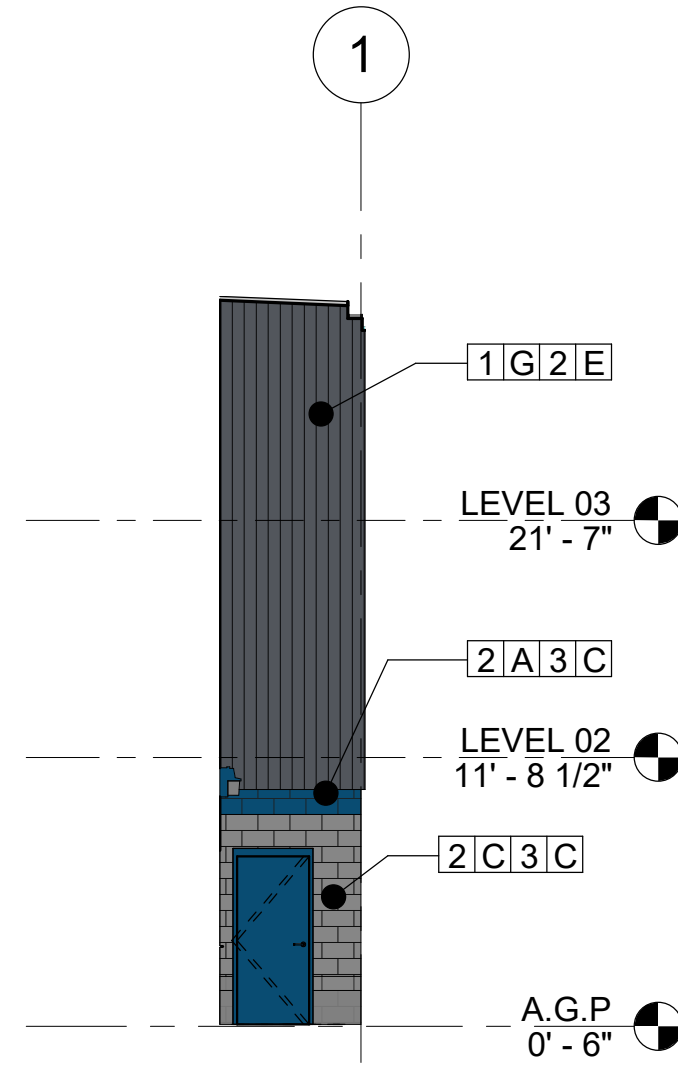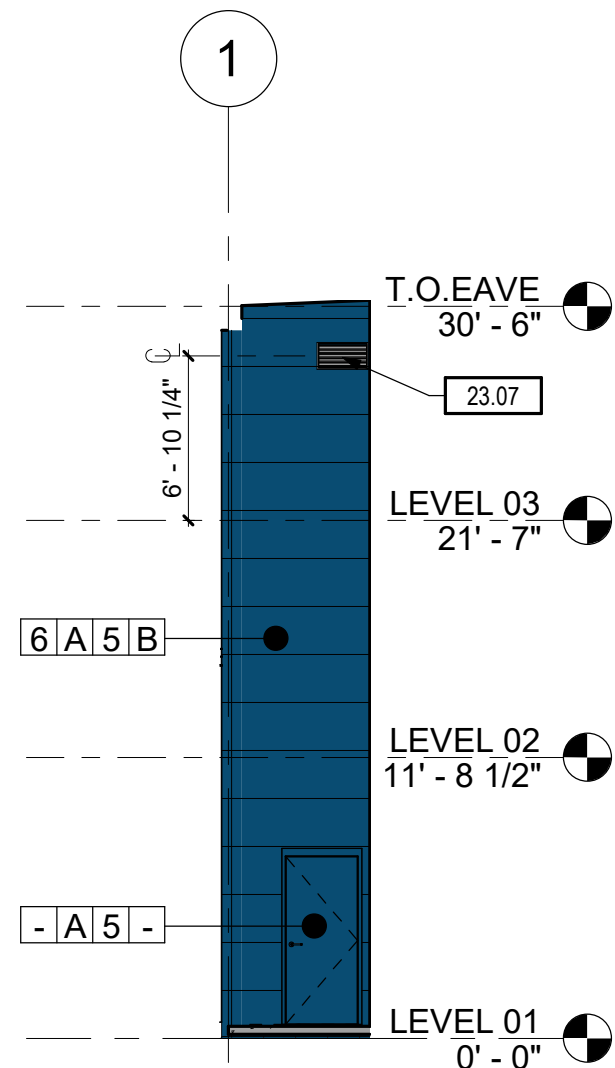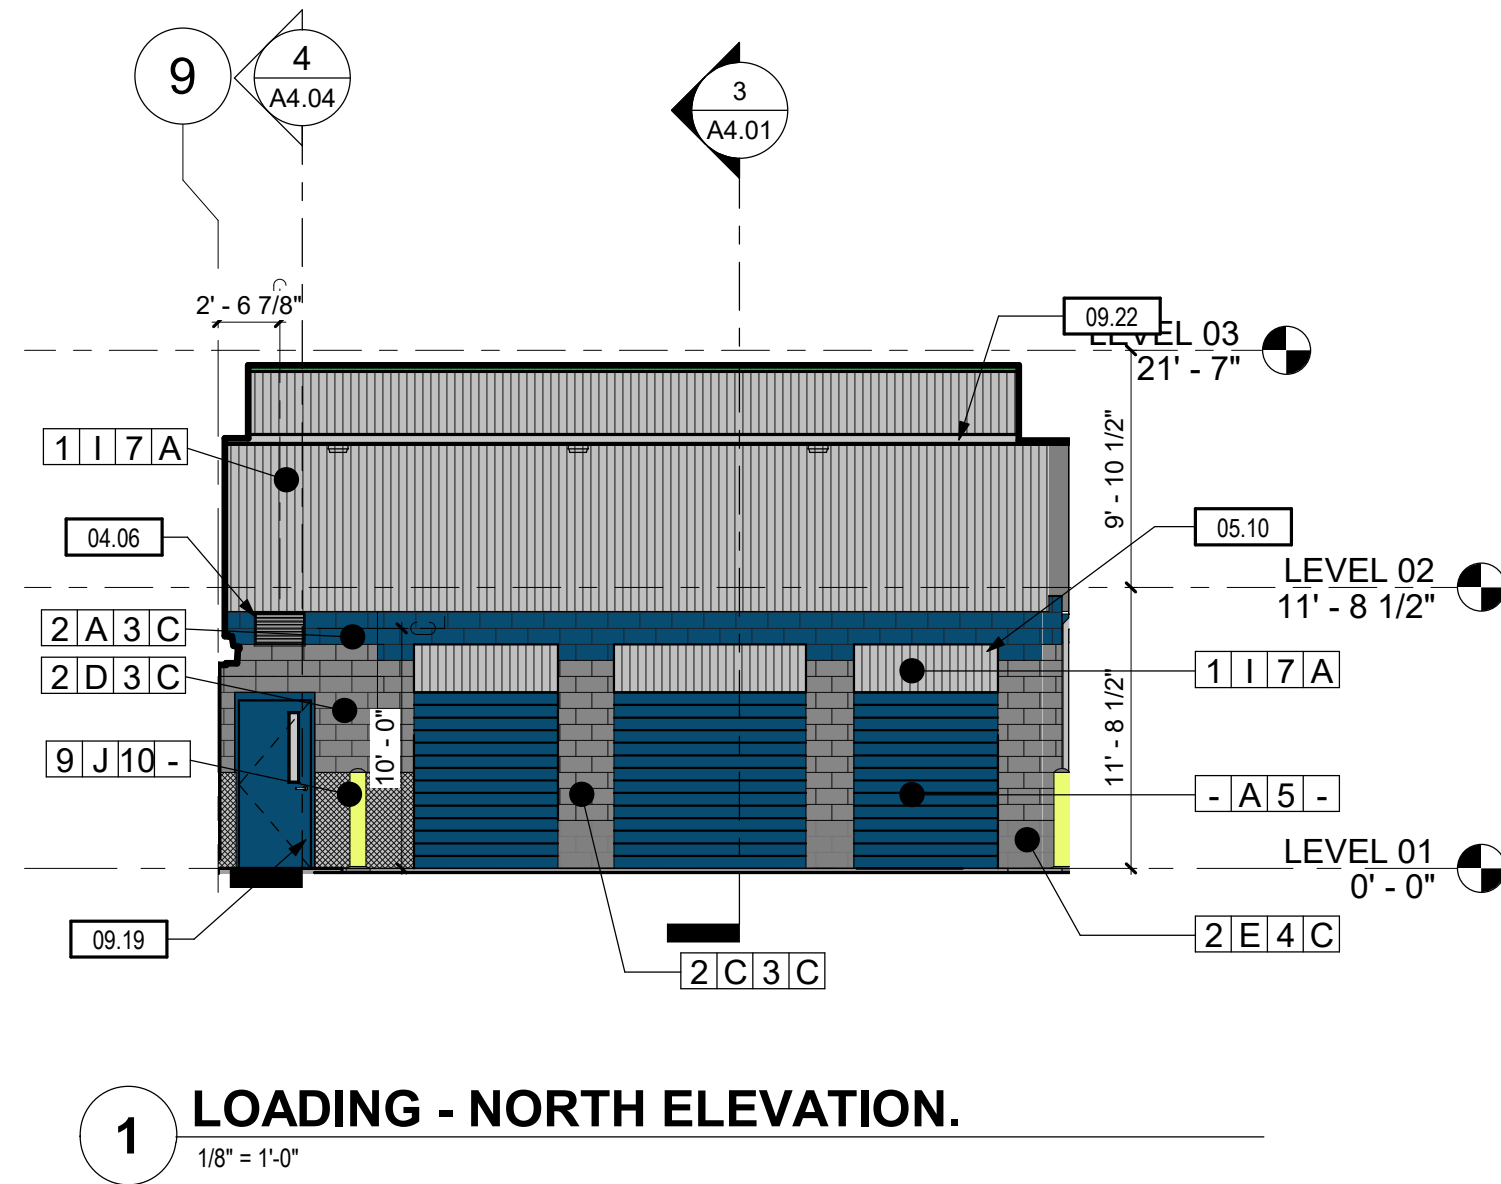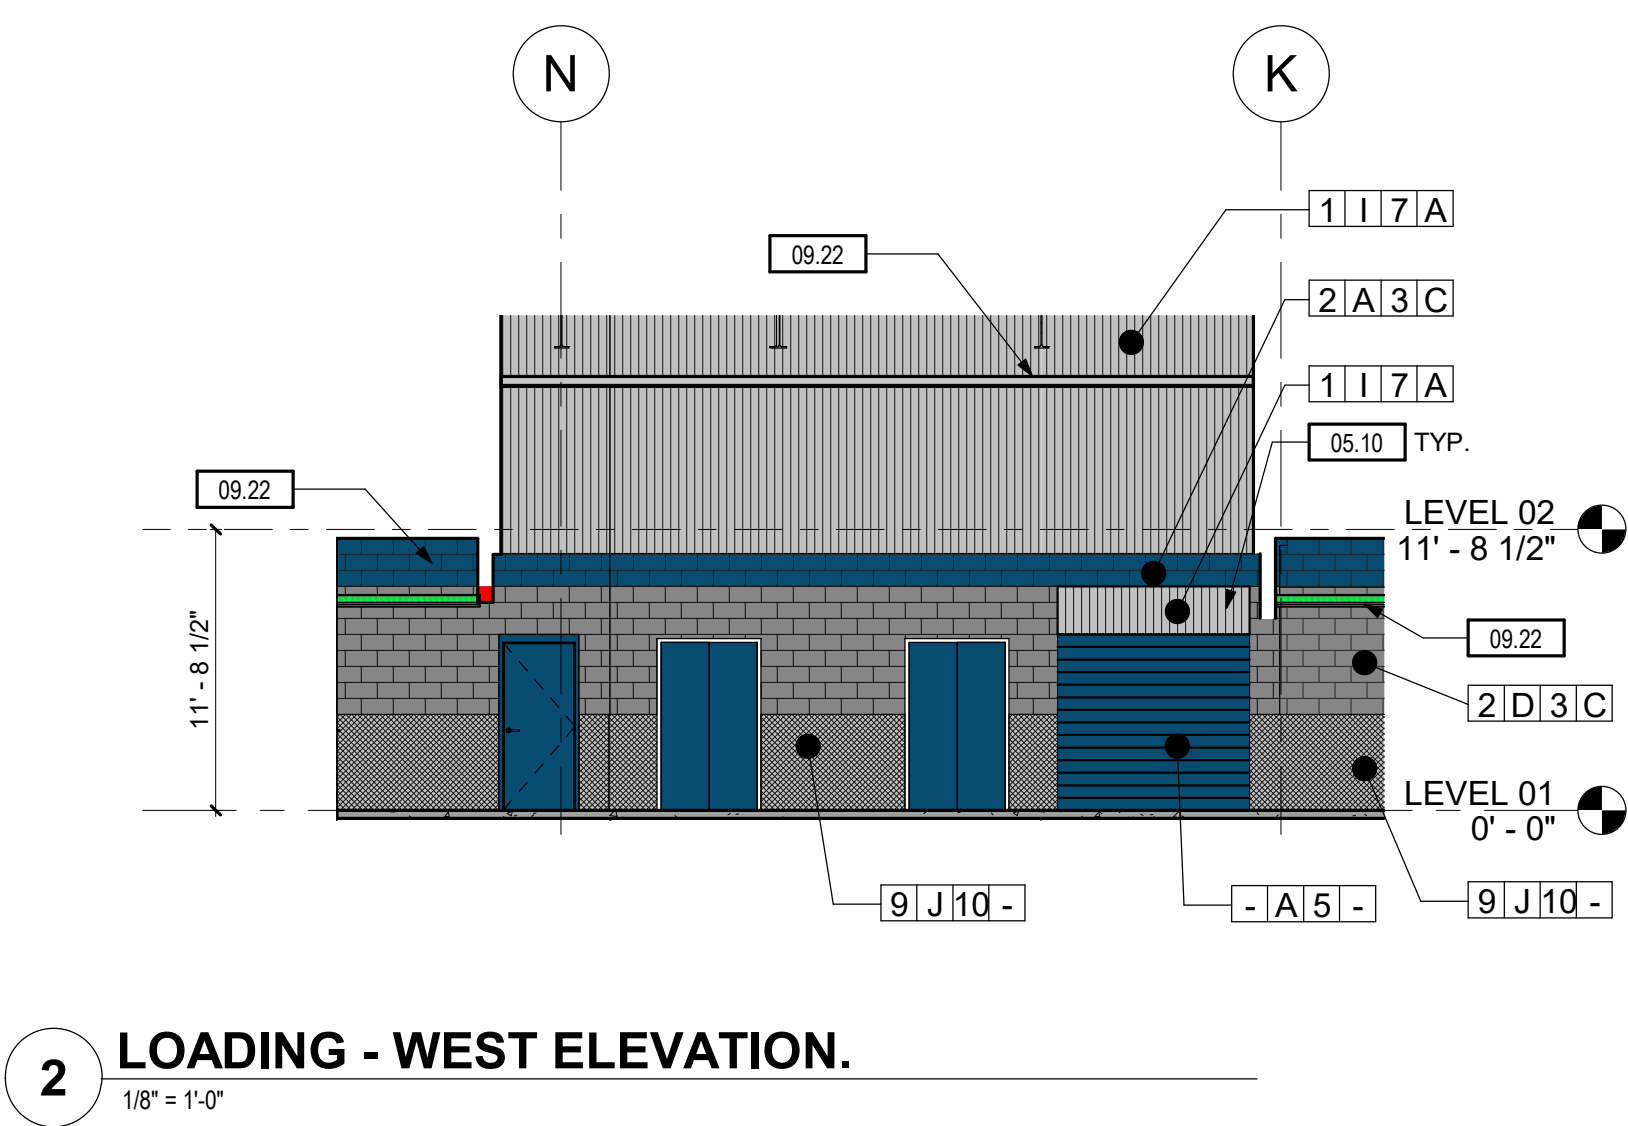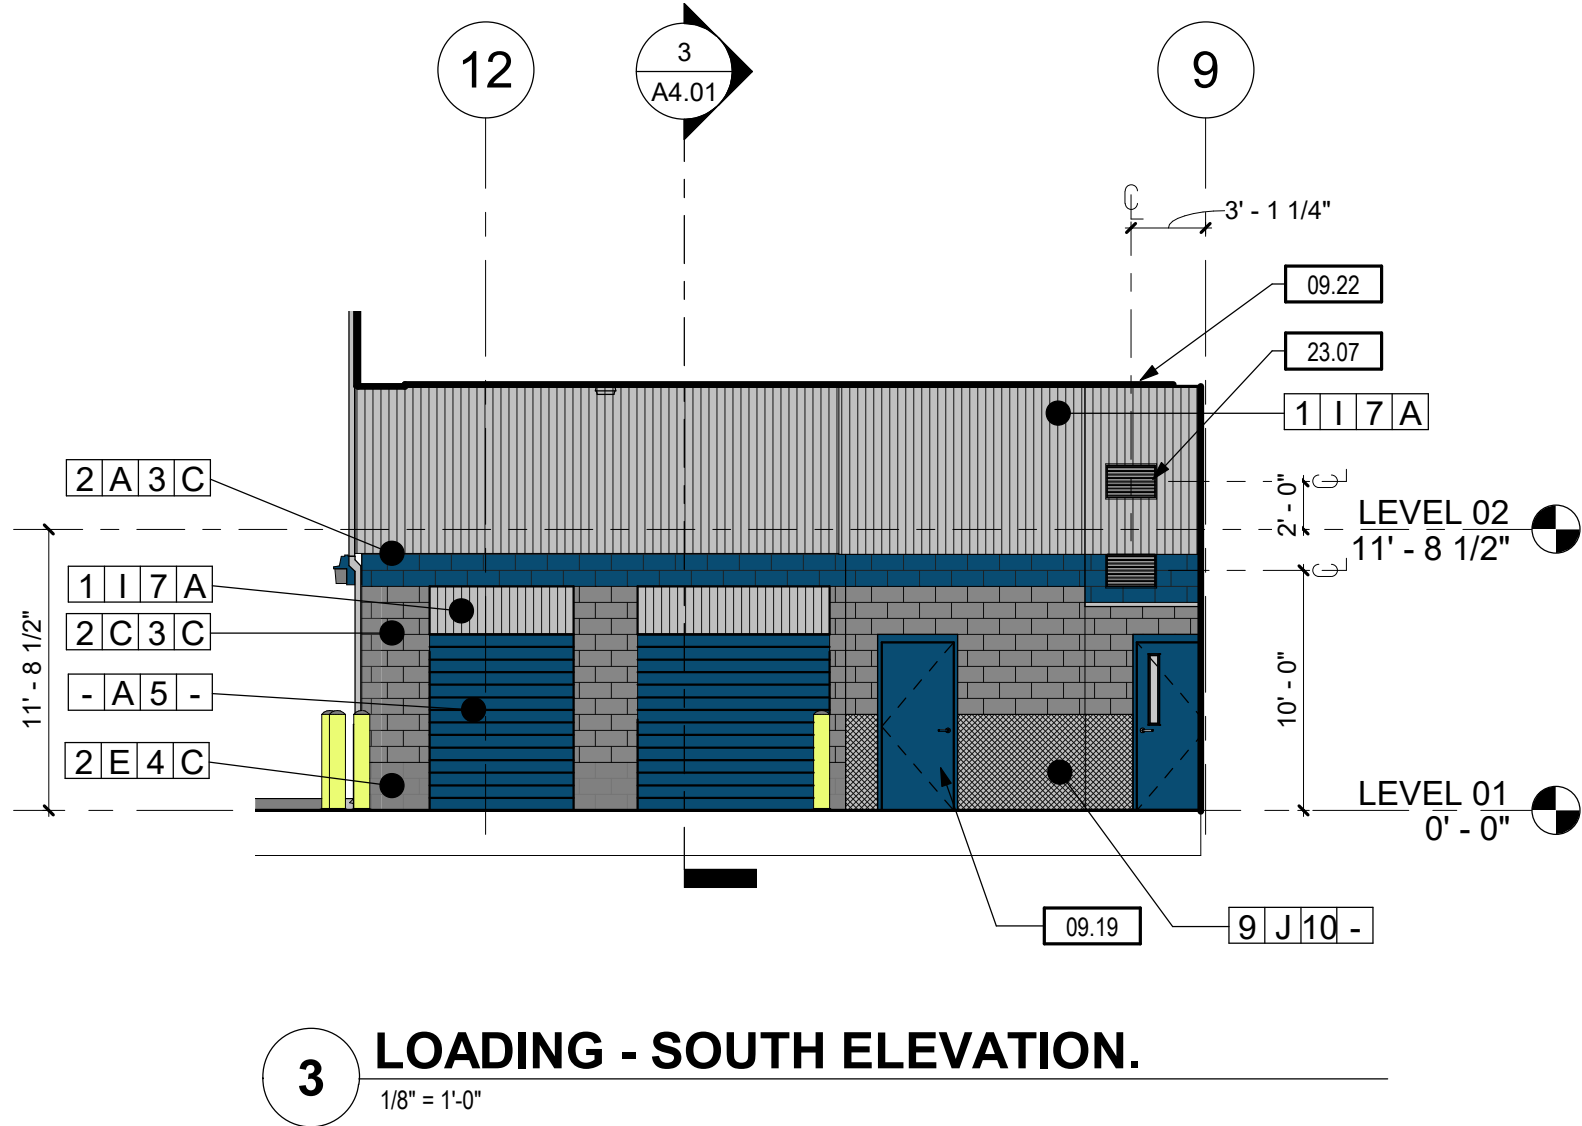

SHEET NOTES:

- A. REFER TO G0.01 FOR ABBREVIATIONS, SYMBOLS AND GENERAL PROJECT NOTES.
B. LOCATIONS OF DOORS AND WALLS PER PLAN. REFER TO SCHEDULES FOR ADDITIONAL INFORMATION.
C. COORDINATE ALL CONTROL JOINT LOCATIONS WITH ARCHITECT PRIOR TO INSTALL.
D. GALVANIZE EXPOSED EXTERIOR STEEL MEMBERS. SIZE PER STRUCTURAL TOUCH-UP WELD BURNS WITH GALVANIZING PAINT PRIOR TO APPLYING FINISH.
E. PROVIDE CONTINUOUS SUBSILLS WITH END DAMS, WELDED JOINTS AT ALL ALUMINUM FRAMING SYSTEMS.
F. AT JOINTS BETWEEN DISSIMILAR MATERIALS, PROVIDE CONTINUOUS MINIMUM 3/8\" BACKER ROD AND SEALANT.
G. SUBMIT ALL EXTERIOR MATERIAL SAMPLES IN SINGLE SUBMITTAL. MATERIALS SUBMITTED SEPARATELY SHALL BE REJECTED.
H. MAINTAIN CODE REQUIRED SEPARATION BETWEEN ALL EXHAUST DISCHARGES AND OPERABLE OPENINGS OR PROPERTY LINE.
I. MAINTAIN CODE REQUIRED SEPARATION BETWEEN ALL EXHAUST DISCHARGES AND MECHANICAL INTAKES.
J. ALL EXTERIOR FINISHES SHALL TERMINATE AT AN INTERIOR CORNER U.N.O.
K. COORDINATE WITH ARCHITECT, CONSULTANTS AS NECESSARY LOCATION AND HEIGHTS OF EXTERIOR LOUVERS, HORNS, LIGHT FIXTURES, FIRE ALARM DEVICES PRIOR TO INSTALL.
L. COORDINATE WITH MANUFACTURER ALL VERTICAL AND HORIZONTAL FIBER CEMENT PANELS JOINTS OR BATTENS PER EXTERIOR ELEVATIONS.
M. EXTERIOR SOFFITS FINISH IS TO MATCH FASCIA U.N.O.
N. DAMPROOFING TO BE TROWELED-ON U.N.O. IN SPECIFICATIONS.
O. EXPOSED CONCRETE WALL, COLUMNS, AND BEAMS FINISH CARBORUNDUM-RUBBED AND PAINTED, COLOR SELECTED BY ARCHITECT.
P. WITHIN MASONRY WALLS:
1. EXTEND STEEL LINTELS MINIMUM 8\" PAST EACH SIDE OF OPENING. PAINT ALL EXPOSED SURFACES BLACK
2. PROJECT ROWLOCK/ SOLDIER BRICK ACCENT BANDS 5/8\" FROM ADJACENT FINISH FACE OF FACADE.
3. MASONRY WEEP HOLES AT 24\" O.C., TYP. U.N.O. PER SPECIFICATIONS.
Q. GENERAL NOTES LISTED ON THIS PAGE ARE NOT INTENDED TO BE AT THE EXCLUSION OF NOTES LISTED ELSEWHERE; THIS DOCUMENT SET IS MEANT TO BE COMPLEMENTARY, AND NOTES LISTED ON OTHER SHEETS MAY HAVE BEARING/APPLICATION TO WORK SHOWN ON THIS SHEET.

MATERIAL LEGEND


PRODUCT	COLOR	MANUFACTURER	PROFILE
PRODUCTS			PROFILE/TEXTURE
1. VERTICAL METAL SIDING			1. 24ga SINEWAVE 2\" PANELS
2. CONCRETE MASONRY UNITS			2. 24ga 4\" BOX RIB PROFILE
3. METAL PANELS			3. GROUND FACE C.M.U.
4. STANDING SEAM ROOFING			4. SPLIT FACE C.M.U.
5. FLASHING			5. SMOOTH PANEL
6. CEMENT BOARD PANEL (W/ PAINTED ALUMINUM EXTRUSIONS)			6. 12\" SMOOTH FACE
7. K700 SERIES STOREFRONT			7. 24\" BOLD RIB I
8. STANDING SEAM ROOF SYSTEM			8. 24\" MULLION
9. WAINSCOT			9. ULTRA DECK
			10. DIAMOND PLATE
COLOR		MANUFACTURER	
A. SHERWIN WILLIAMS - 6804 DIGNITY BLUE		A. CORRUGATED METALS INC.	
B. WHITE		B. JAMES HARDIE	
C. SHERWIN WILLIAMS - 2849 WESTCHESTER GRAY		C. MUTUAL MATERIALS	
D. NATURAL		D. HBCI - METAL PRODUCTS	
E. CHARCOAL		E. METAL SALES	
F. OLD TOWN GRAY (COLOR W25)		F. KAWNEER	
G. SLATE GRAY (COLOR W38)			
H. ANODIZED			
I. SOLAR WHITE			
J. POLISHED ALUMINUM			

KEYNOTES:



#	NOTE
04.06	MASONRY OPENING, REF. STRUCTURAL STADANDARD MASONRY OPENING DETAIL
05.10	METAL PANELS OVER C.M.U. AT EXTERIOR OVERHEAD DOORS, REF. DETAIL 6/AT.04.FINISH PER SCHEDULE (OR EXTERIOR ELEVATIONS)
09.19	DOOR PAINT COLOR SHERWIN WILLIAMS DIGNITY BLUE
09.22	SOFFIT & FRAMING OVER LOADING, REF. RCP FOR SOFFIT DETAILS, REF. STRUCTURAL DRAWINGS FOR FRAMING DETAILS
23.07	LOUVER SIZES PER MECHANICAL PLANS.

MATERAIL PALLETTE

COLOR

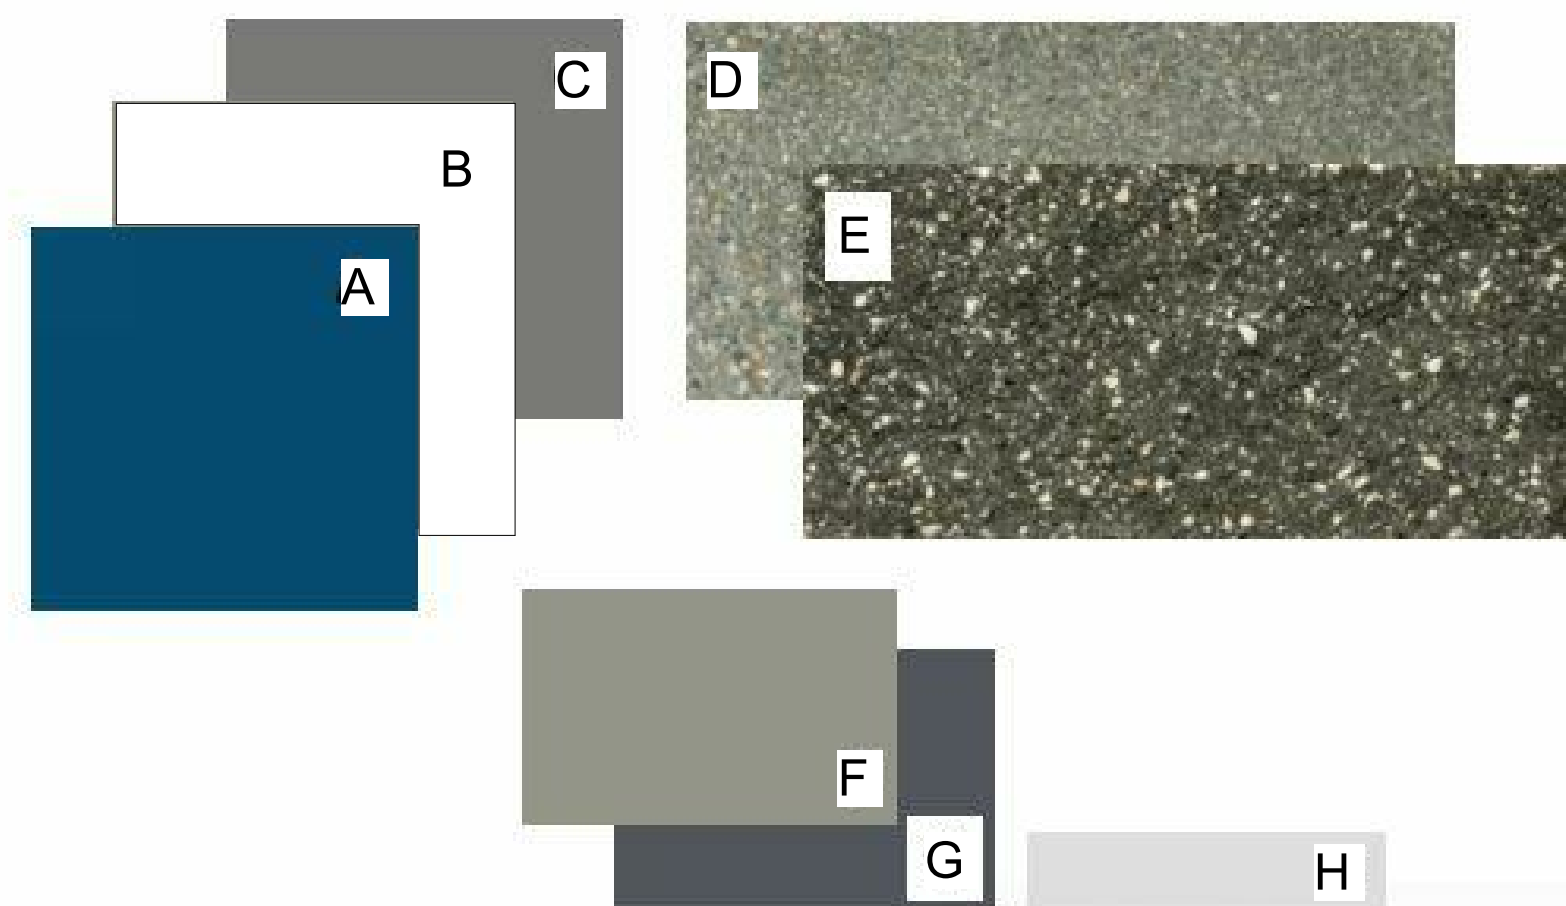

PROFILE/MATERIAL

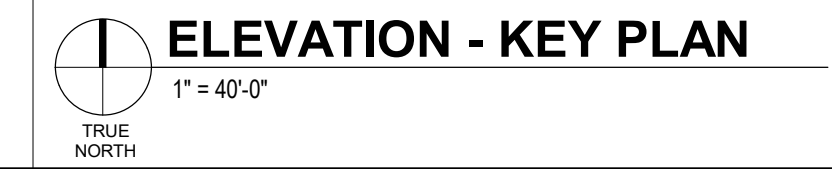
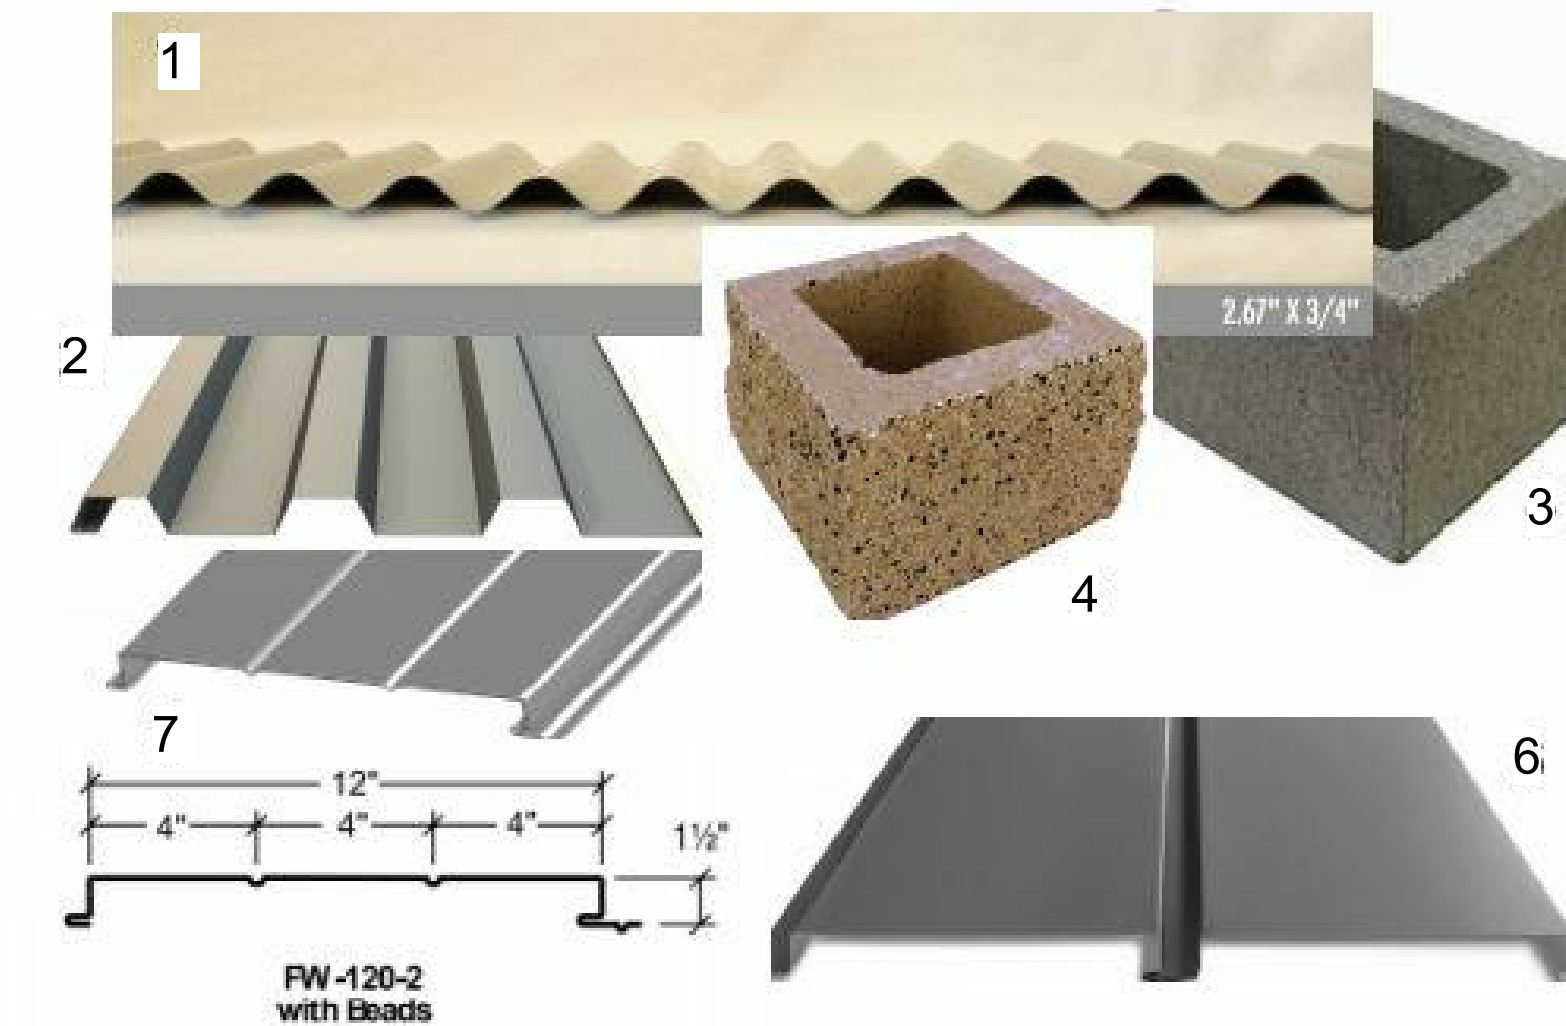


DATE	NO.	DESCRIPTION
07/24/21	2	DESIGN REVIEW - DRG1-004

NOT FOR CONSTRUCTION
FOR REVIEW ONLY

PROJECT NO.: 20143
PROJECT MGR.: LH
DRAWN BY: AK
CHECKED BY: D.M


EXTERIOR ELEVATIONS

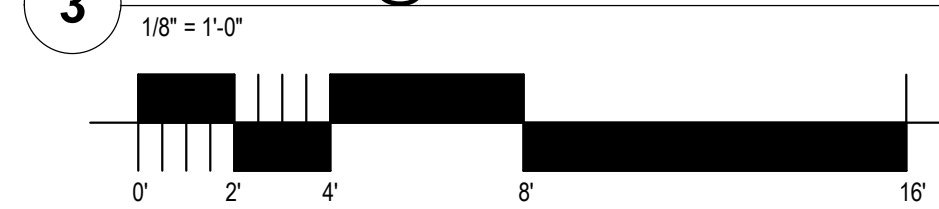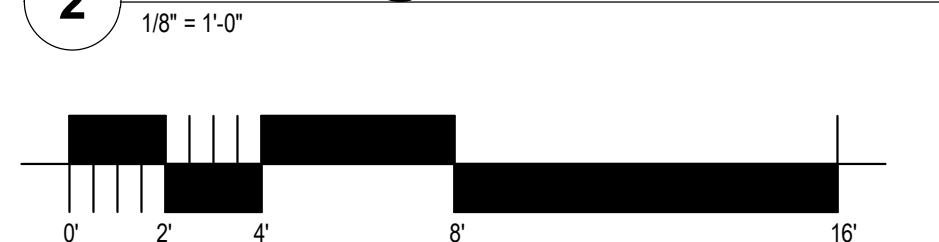


#	NOTE
05.22	ELEVATOR LADDER, REF AT 12 FOR LADDER DETAIL AND VERIFY ELEVATOR WITH MANUFACTURE FOR PLACEMENT LOCATION
07.13	ROOF ACCESS HATCH PER PLANS, 36x36" (U.N.O); THERMALLY BROKEN WITH INSULATED CURB BILCO TYPE E-50TB OR APPROVED EQUAL
07.15	4x3" DOWNSPOUT WITH A PROTECTION BOOT AT BASE. REF DETAIL ON (A8.04) PAINT TO MATCH BUILDING

[illegible]

A4.01

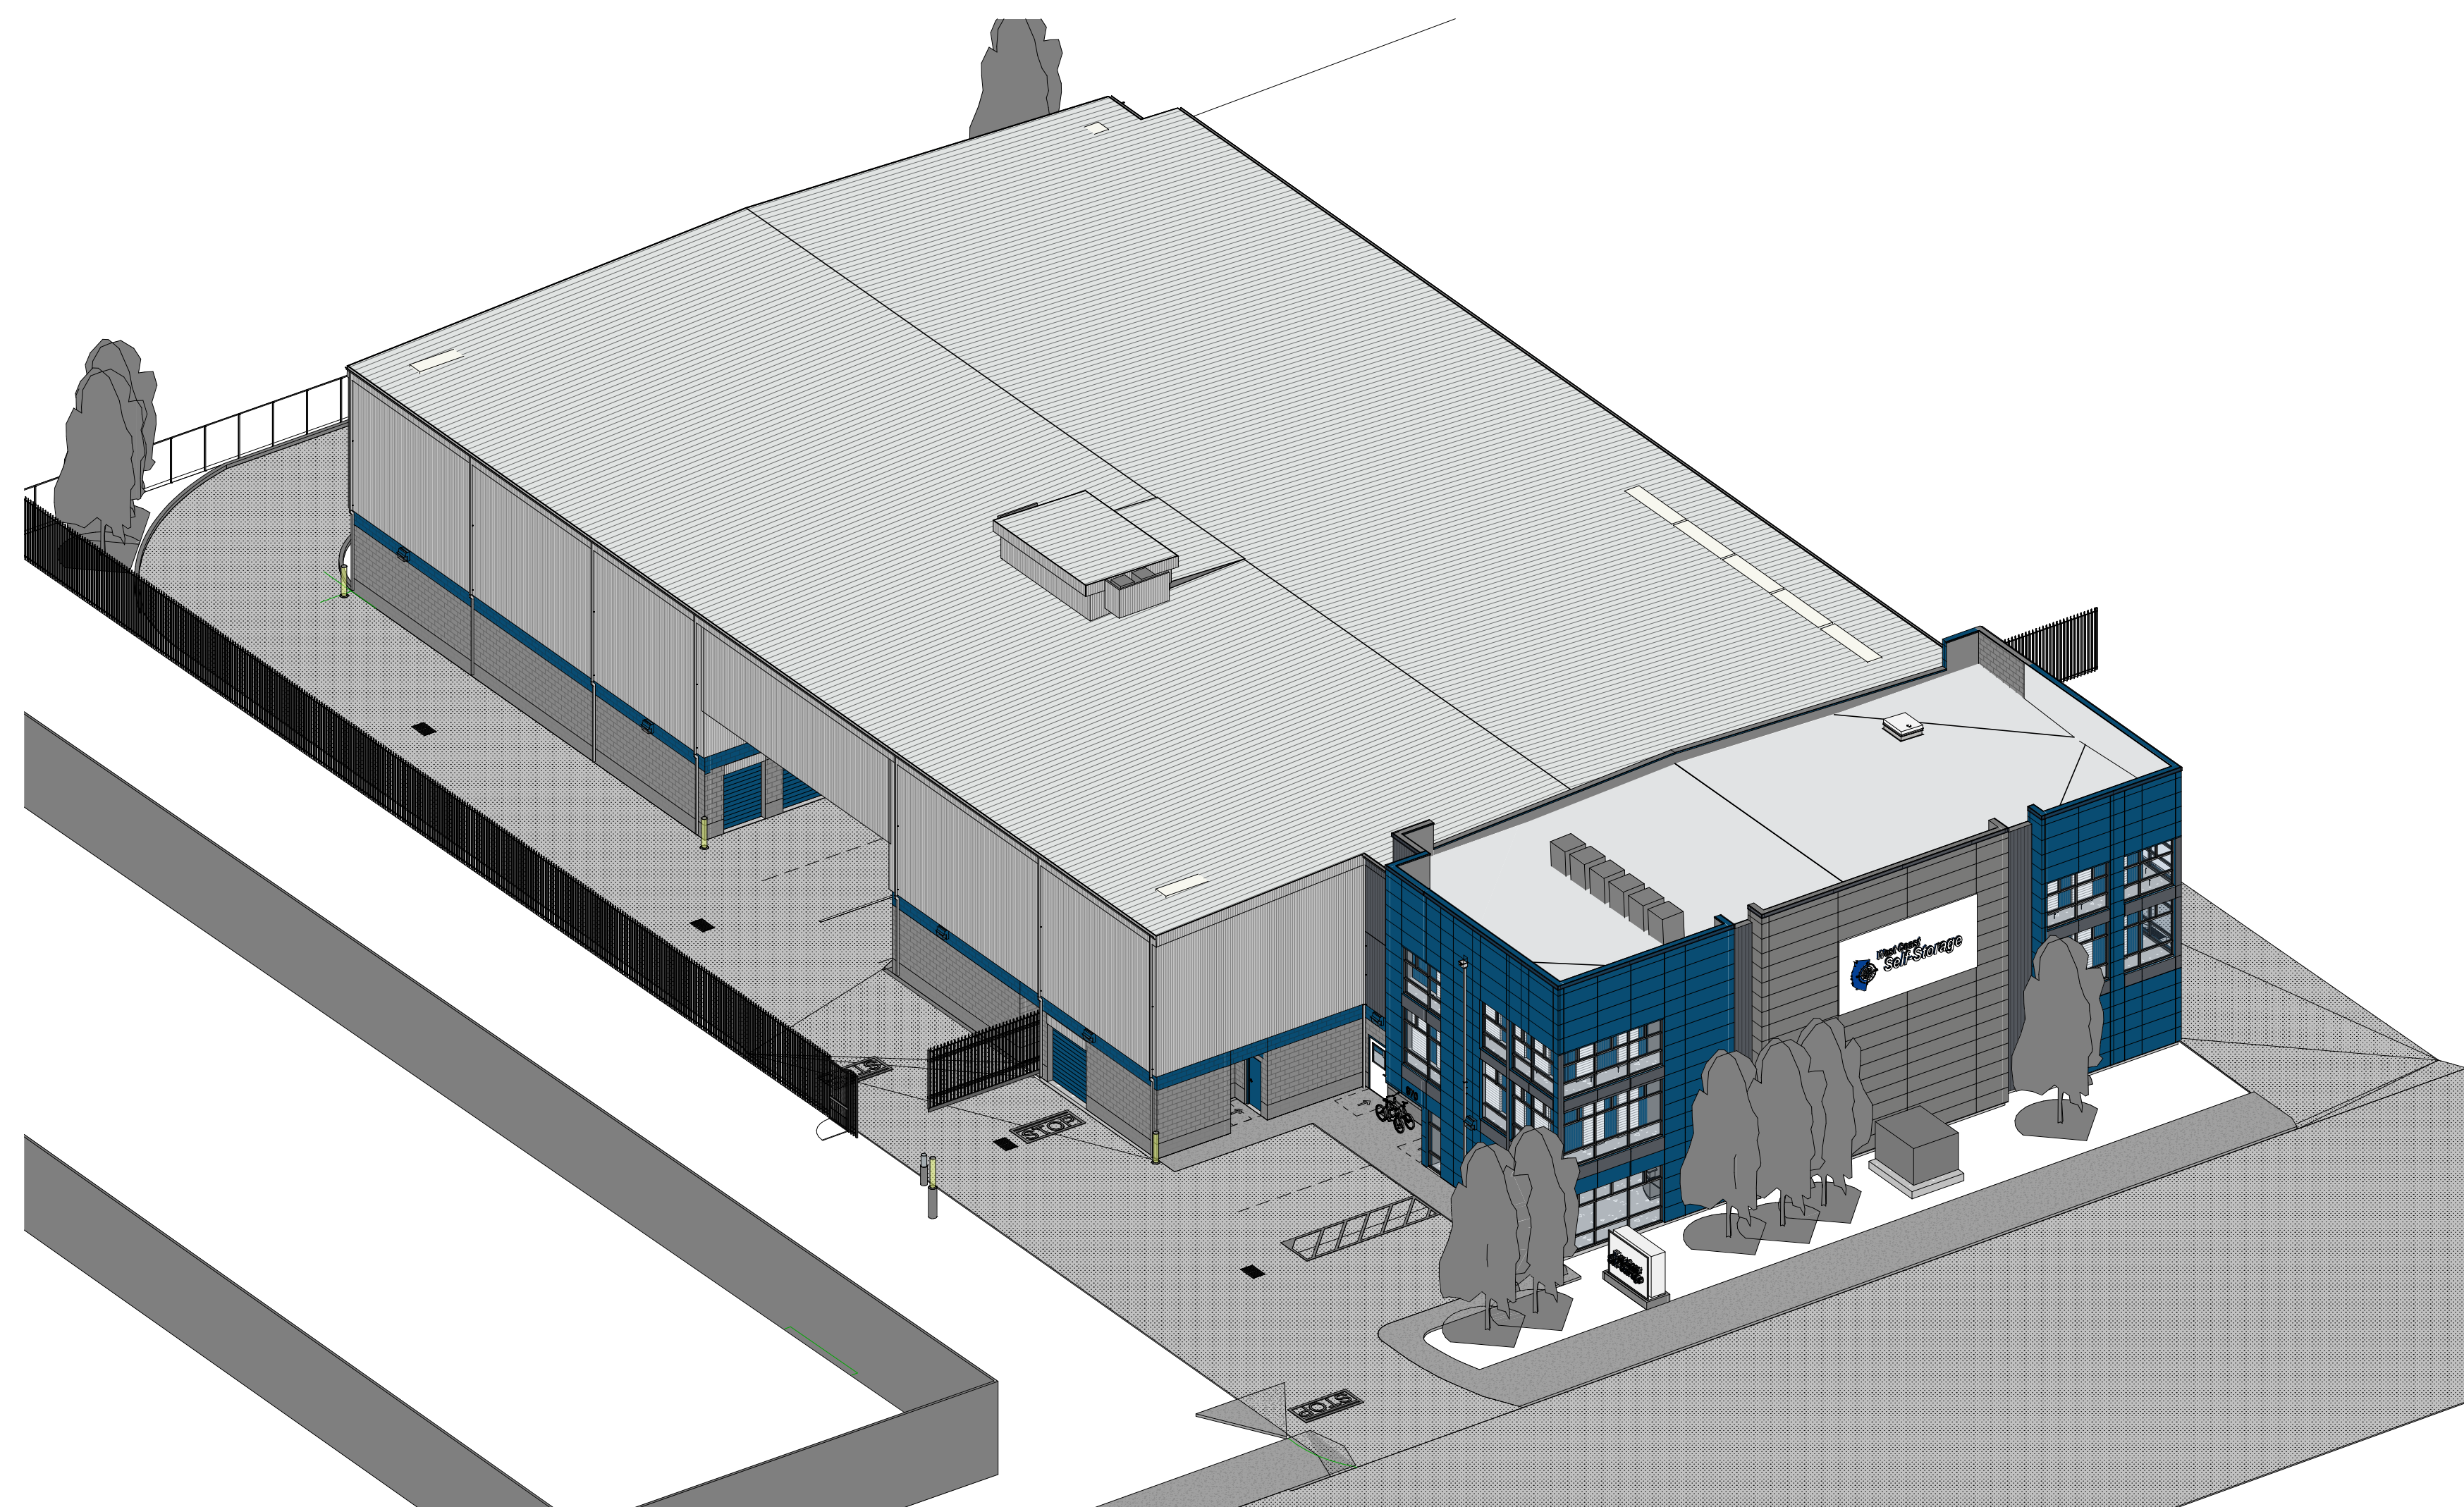

2 NORTH EAST - AERIAL VIEW

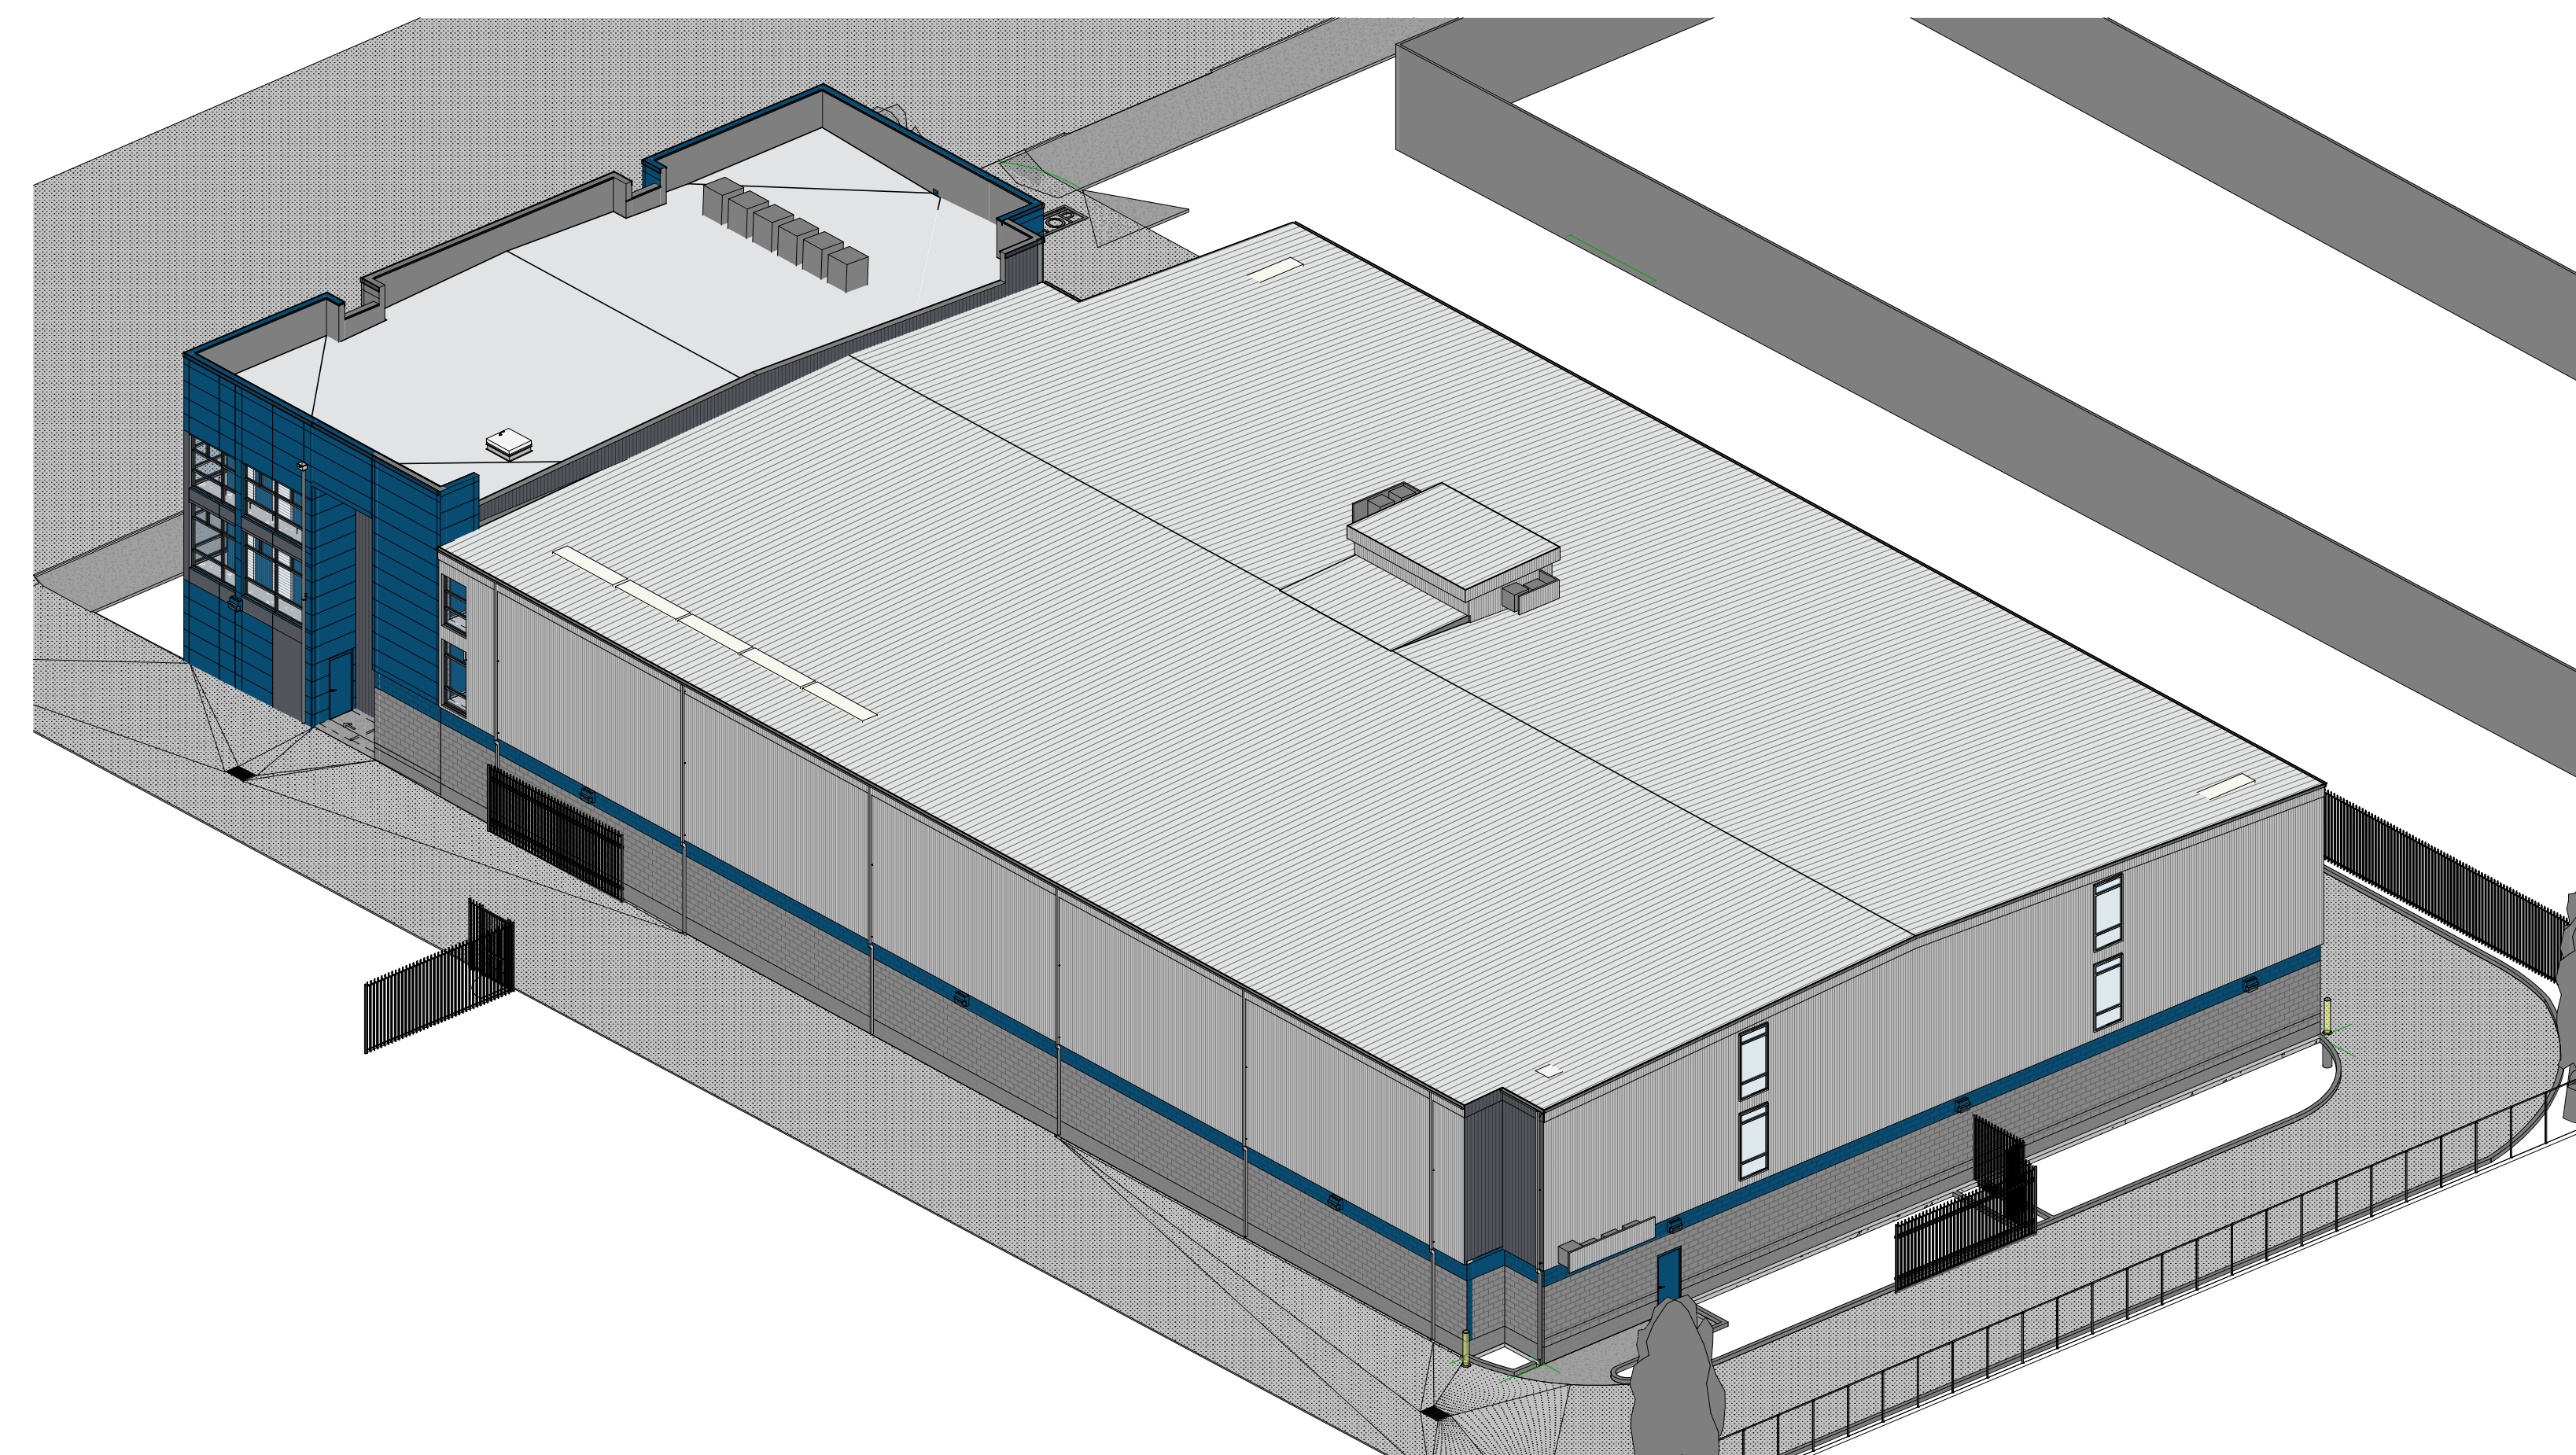


1 SOUTH WEST - AERIAL VIEW




4 NORTH EAST - PERSPECTIVE VIEW



3 NORTH WEST - PERSPECTIVE VIEW

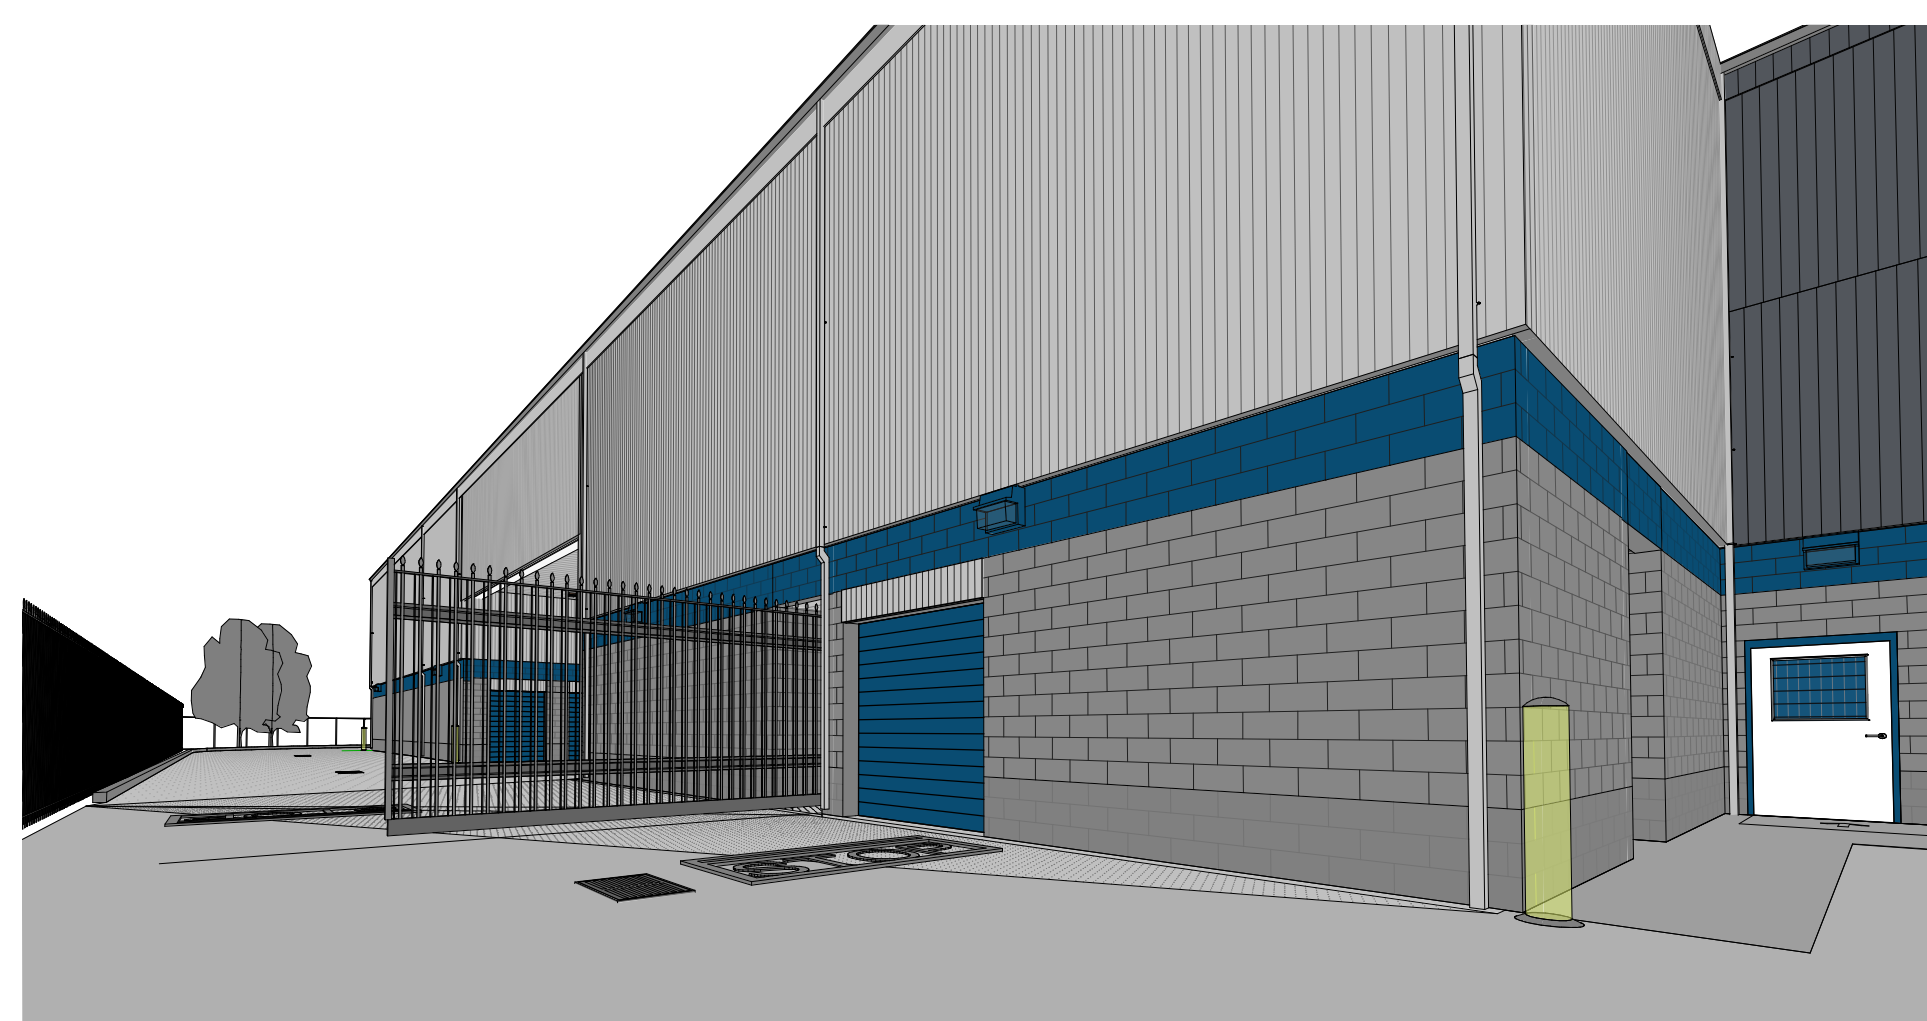

7 LOADING AT GATE

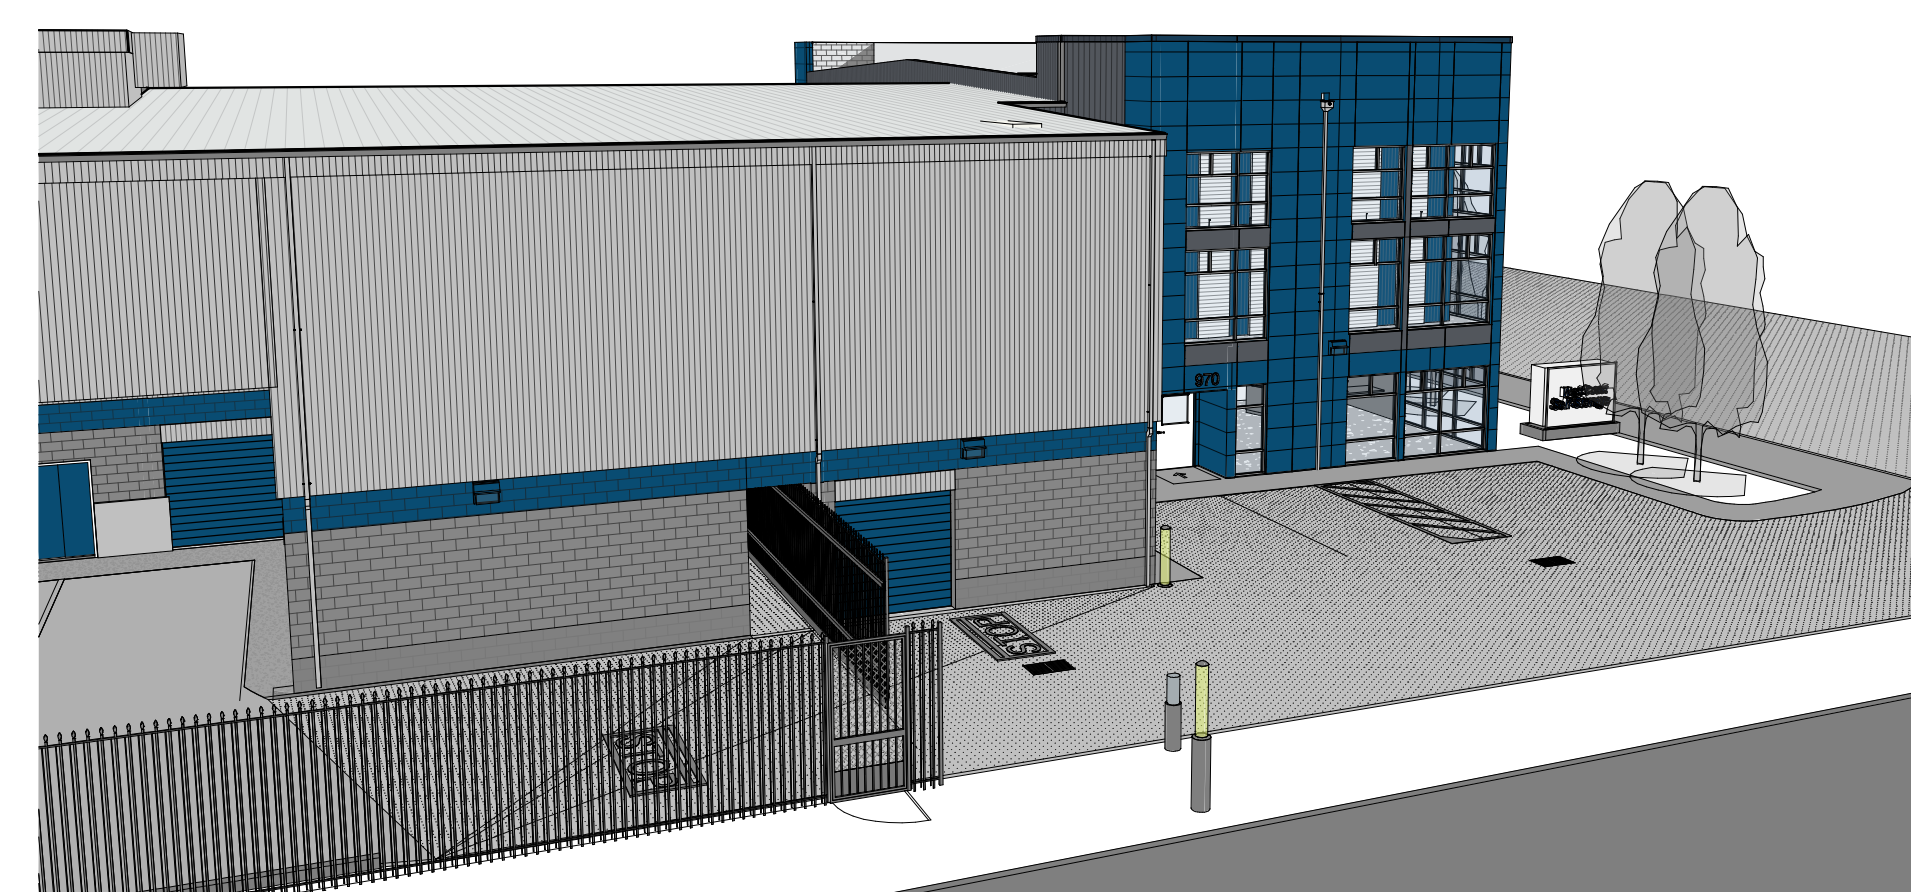

LOADING FROM THE EAST

[illegible]