CITY OF SANTA ROSA P.O. BOX 1678 SANTA ROSA, CA 95402

JUL 7 2015

DEPARTMENT OF COMMUNITY DEVELOPMENT

300' LINE



PLAYGROUND

RESTAURANT

MIXED USE

SF

SEBASTOPOL AVENUE

SF

SF

SF

SF

SF

SOUTH A STREET

SF

SF

SF

SF

MIXED

USE

OFFICE

SF

MIXED USE

RETAIL

SF

RETAIL

RETAIL COMMERCIAL



SITE PLAN
MARCH 31, 2015


SOUTH STREET A ZONING STUDY SANTA ROSA, CALIFORNIA 95401

REDWOOD HIGHWAY 101

PROJECT SITE


EXIT / ENTRANCE RAMPS

## **Matthew Cordone Architect PLLC**

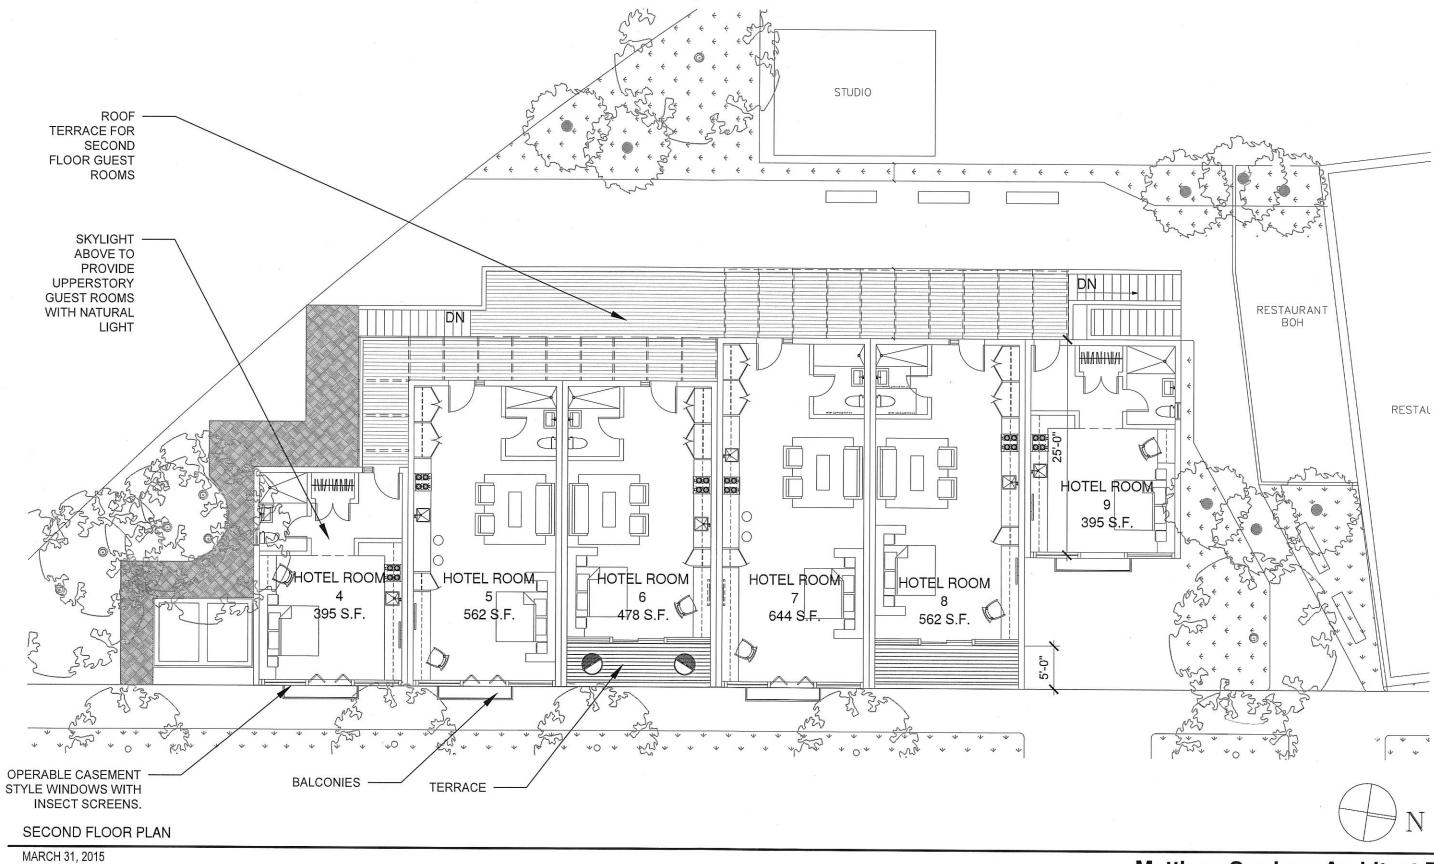

SOUTH STREET A ZONING STUDY **SANTA ROSA, CALIFORNIA 95401** 

## **Matthew Cordone Architect PLLC**

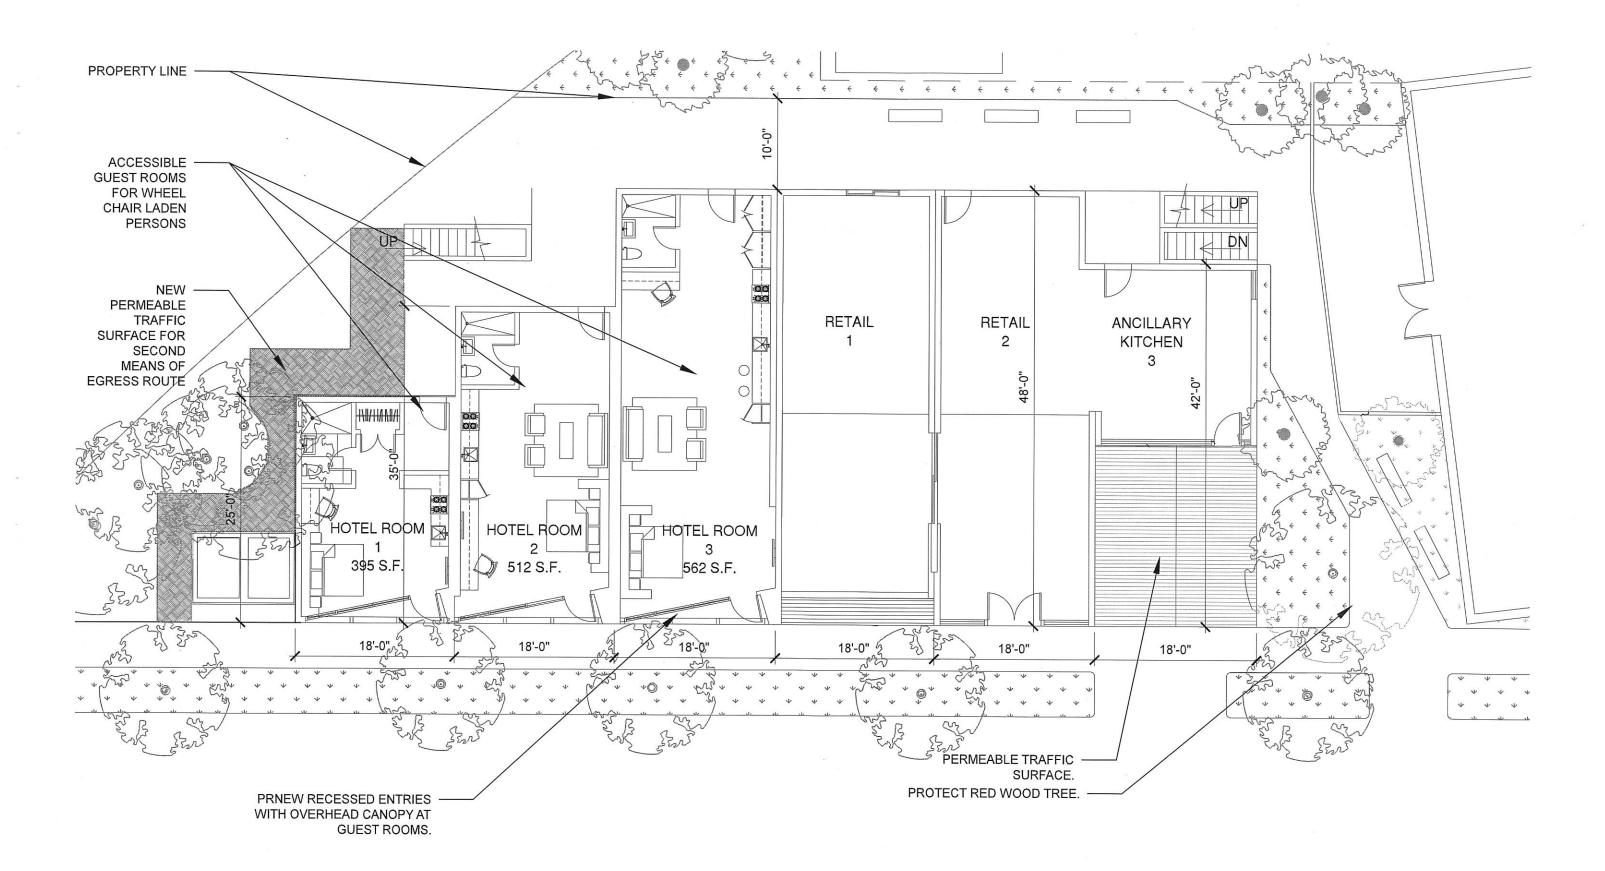

FIRST FLOOR PLAN


MARCH 31, 2015

SOUTH STREET A ZONING STUDY SANTA ROSA, CALIFORNIA 95401

## **Matthew Cordone Architect PLLC**

90 Hamilton Avenue, Hastings On Hudson, New York, 10706 phone: 917.749.8071

email: matthewcordone@gmail.com

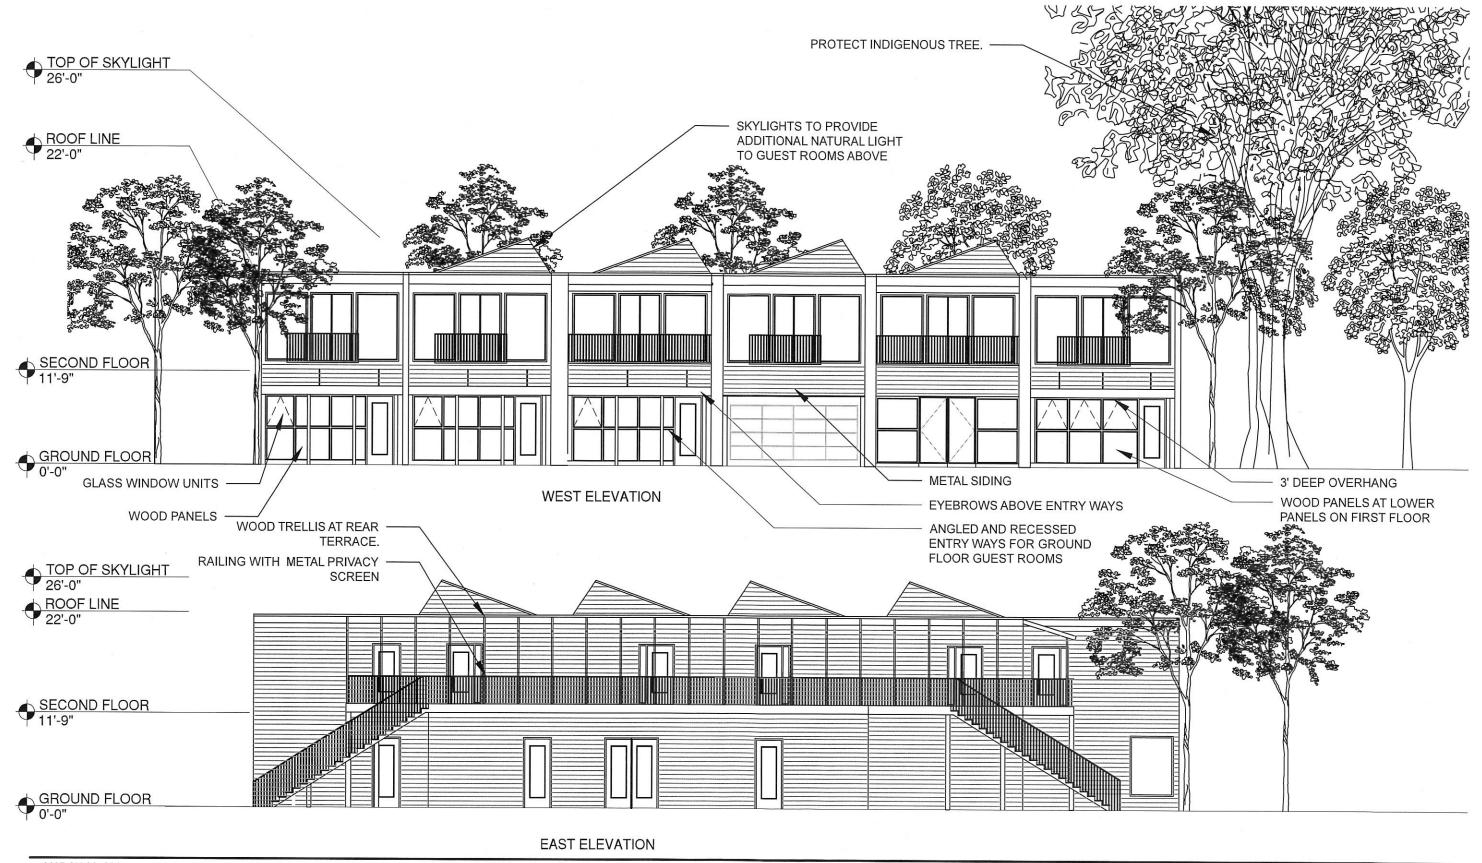

MARCH 31, 2015

SOUTH STREET A ZONING STUDY SANTA ROSA, CALIFORNIA 95401

## **Matthew Cordone Architect PLLC**

ZONING STUDY: ZONING DISTRICT "CG"

TWO STORY MIXED USED BUILDING COMMERCIAL (RETAIL) AND RESIDENTIAL (HOTEL)

SETBACKS:

REAR: 10'-0" SIDES (INTERIOR LOT): 5'-0"

FRONT:

7.5' ADJACENT TO A RES. ZONE

LOT SQUARE FOOTAGE: BUILDING COVERAGE:

TOTAL SQUARE FOOT OF BUILDING:

MAXIMUM BUILDING COVERAGE 100% PROPOSED 51%

8751 S.F. 4,430 S.F. 8,728 S. F.

BUILDING HEIGHT: 55' MAXIMUM PROPOSED 25'-0"


REQUIRED PARKING:


AUTOMOBILE: ONE PER GUEST

BICYCLE: ONE. ONE PER TEN GUEST ROOMS

REQUIRED LANDSCAPING::

PROVIDE LANDSCAPING AT ALL REQUIRED SET BACKS

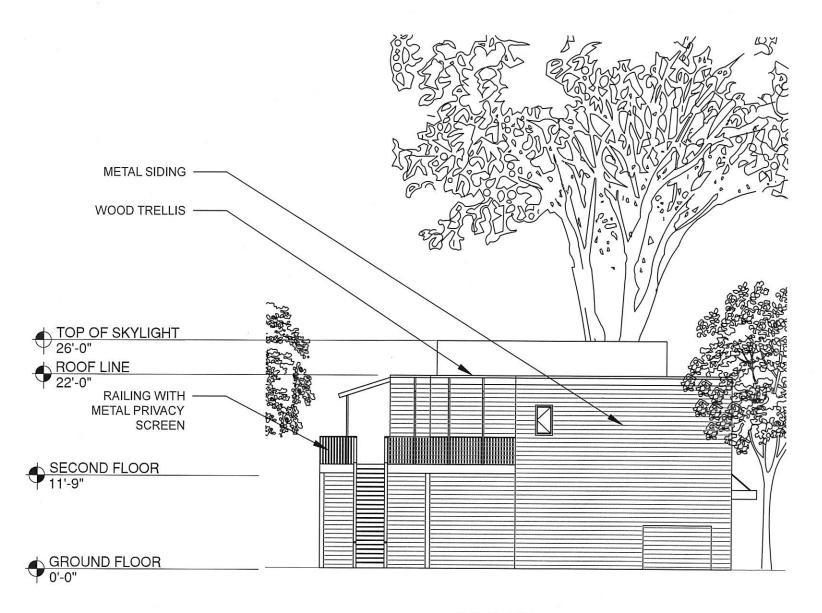

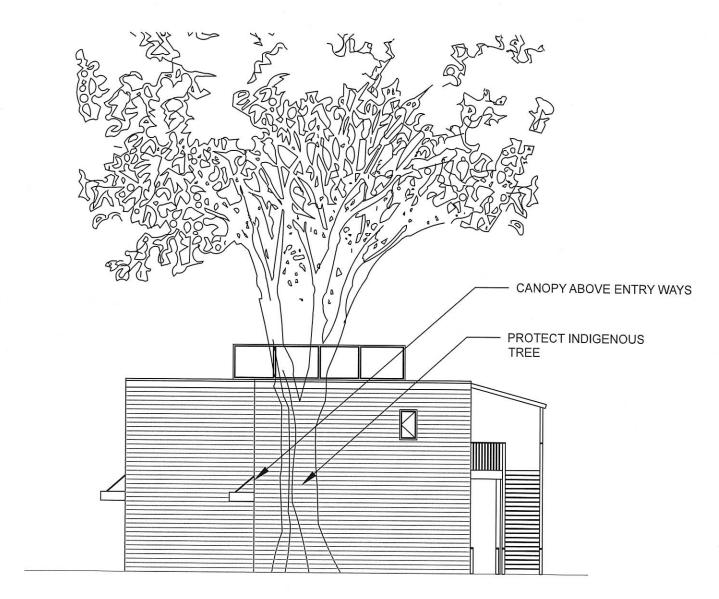


NORTH ELEVATION

SOUTH ELEVATION

MARCH 31, 2015

SOUTH STREET A ZONING STUDY SANTA ROSA, CALIFORNIA 95401


### **Matthew Cordone Architect PLLC**

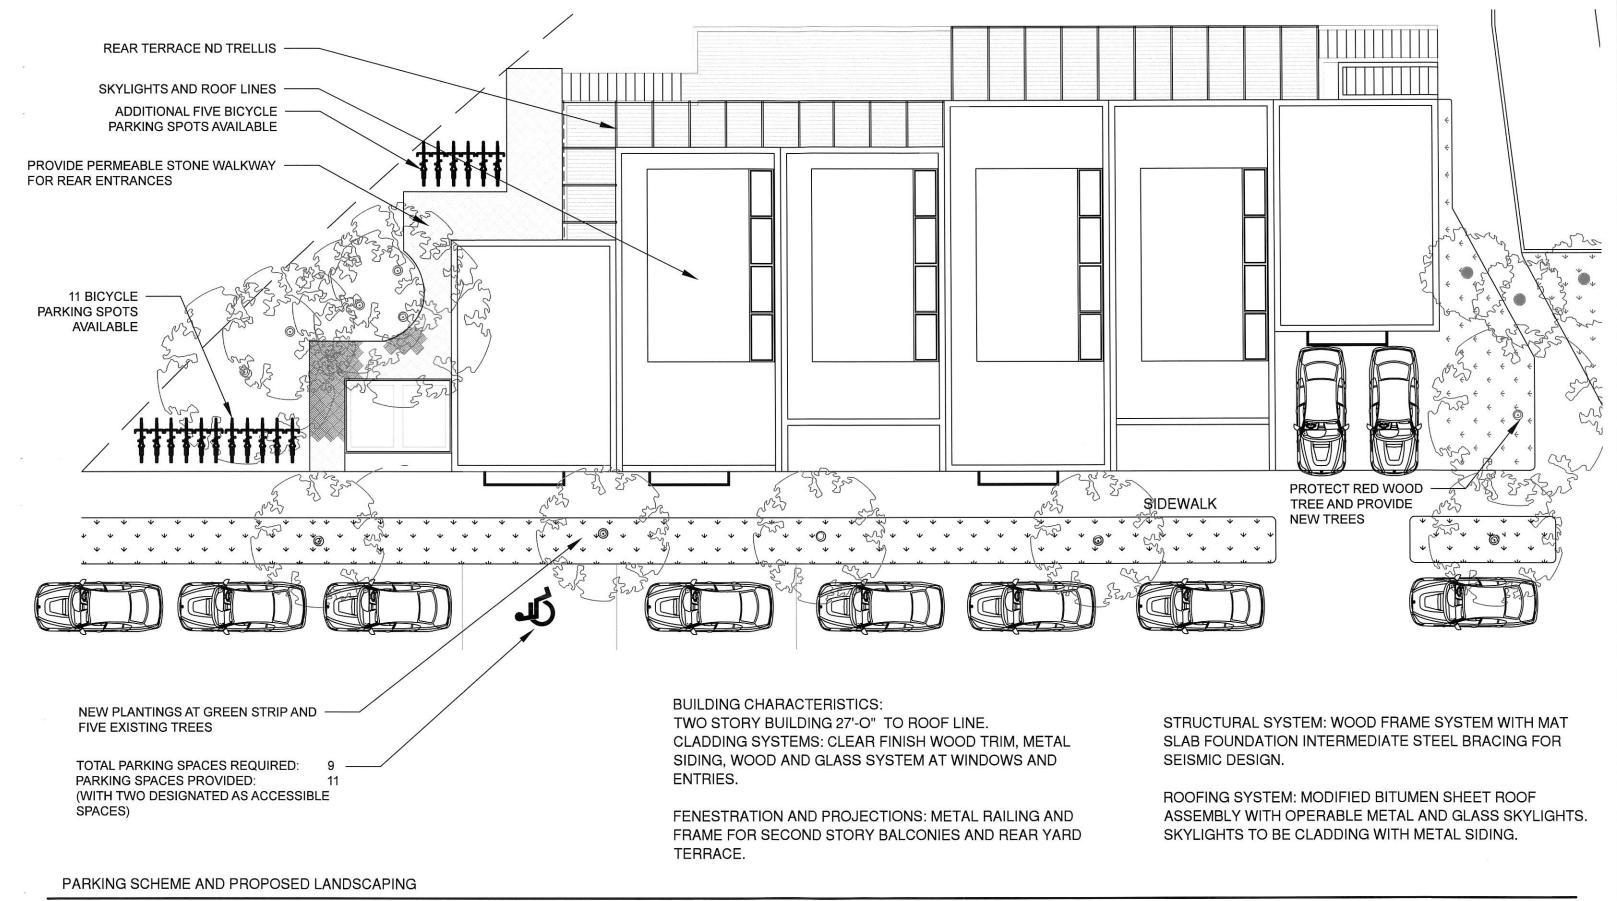

MARCH 31, 2015

SOUTH STREET A ZONING STUDY SANTA ROSA, CALIFORNIA 95401

## **Matthew Cordone Architect PLLC**

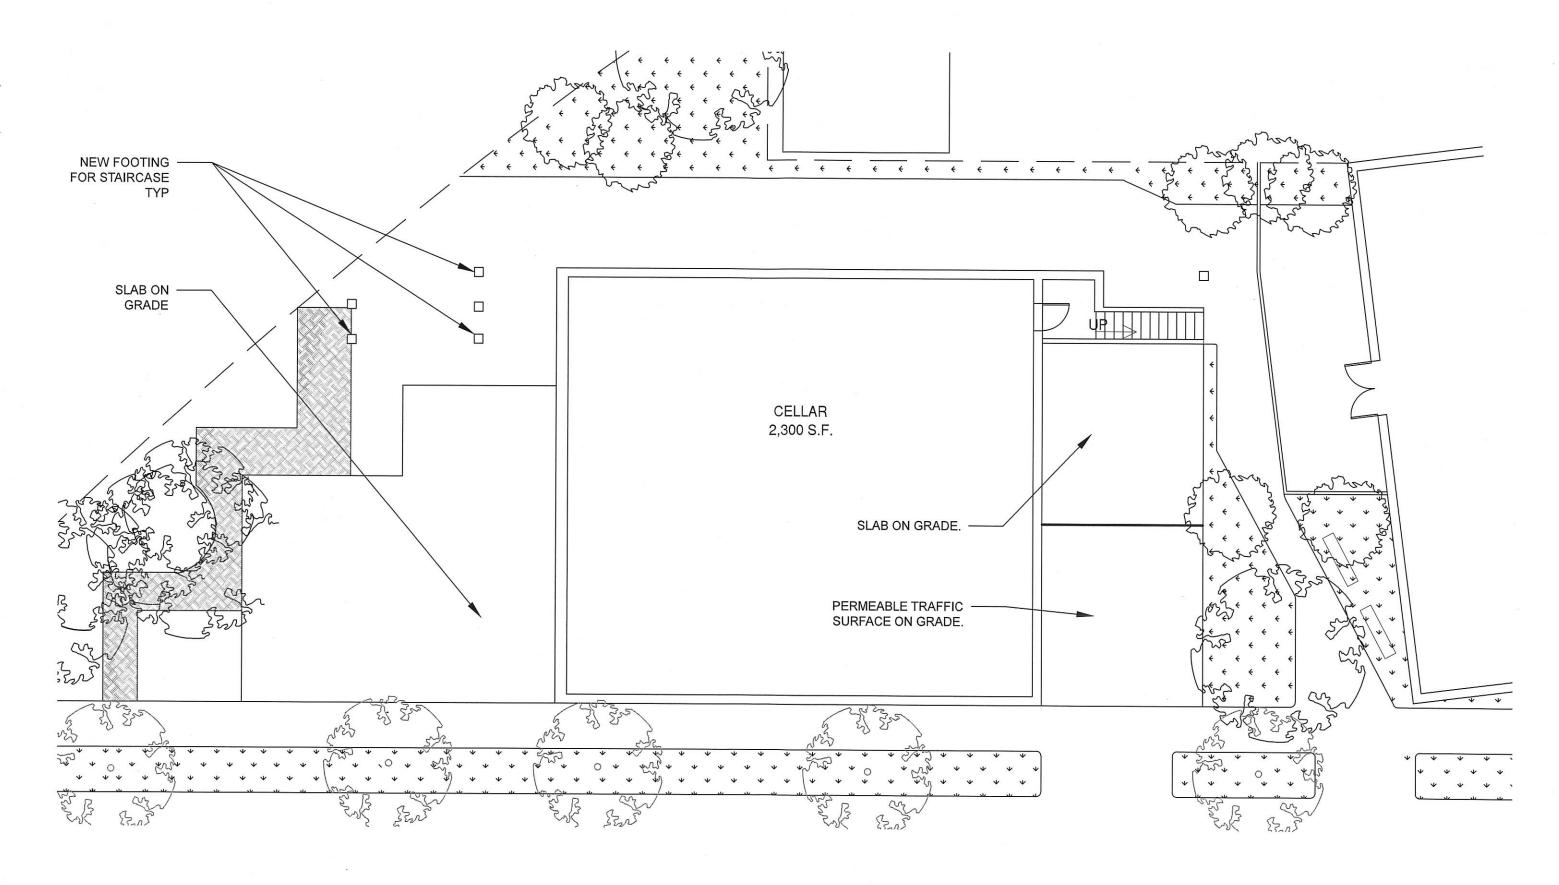

**CELLAR PLAN** 

MARCH 31, 2015

# **Matthew Cordone Architect PLLC**



MARCH 31, 2015

## **Matthew Cordone Architect PLLC**

### +R HWY RAMP **EXTENT OF VEGETATED** 424 SEBASTOPOL AVENUE SLOPE @ CALTRANS ROW APN: 010-221-013 PROPERTY BOUNDARY, TYP. S П BASTO FOOTPRINT OF FUTURE PROPOSED BLDG. PARAPET HEIGHT = 22' (E) FACE OF SPINSTER NOTE: TOP OF SLOPE @ SISTERS BUILDING APPROX. 30' ELEV. ABOVE FUTURE PROPOSED BLDG. POL OPTION: ANGLED BUILDING FOOTPRINT (HT. VARIES) WALL TO MATCH NEIGHBOR AVENU 407 SOUTH A STREET **401 SOUTH A STREET** 413 SOUTH A STREET APN: 010-221-016 APN: 010-221-018 APN: 010-221-017 (E) BACK OF SIDEWALK 30.-3" (E) PARKING (E) FACE OF CURB (E) BIKE LANE ROADV CENTERLINE A ST. ROW (E) TRAFFIC LANE (SB) m--09 (E) APPROX. SOUTH A STREET 10-01 (E) TRAFFIC LANE (NB) +-30.-3" (E) FACE OF CURB (E) PARKING 418SOUTH A STREET 414 SOUTH A STREET 400 SOUTH A STREET APN: 010-222-038 APN: 010-222-035 APN: 010-222-001 **OVERALL SITE PLAN**

1" = 20'-0"

# BISBEE

## ARCHITECTURE+DESIGN

Nate Bisbee, AIA 1212 Fourth Street, #K Santa Rosa, CA 95404 (707) 492-9960

## ZONING STUDY SUPPLEMENTAL INFORMATION

## SPINSTER INN

407 & 413 SOUTH A STREET SANTA ROSA, CA 95401 APN: 010-221-018 & 010-221-016

## **OVERALL SITE PLAN**


PROJECT NUMBER 15024.00


DATE Jun. 25, 2015

DRAWN BY NB

CHECKED BY

A1.0

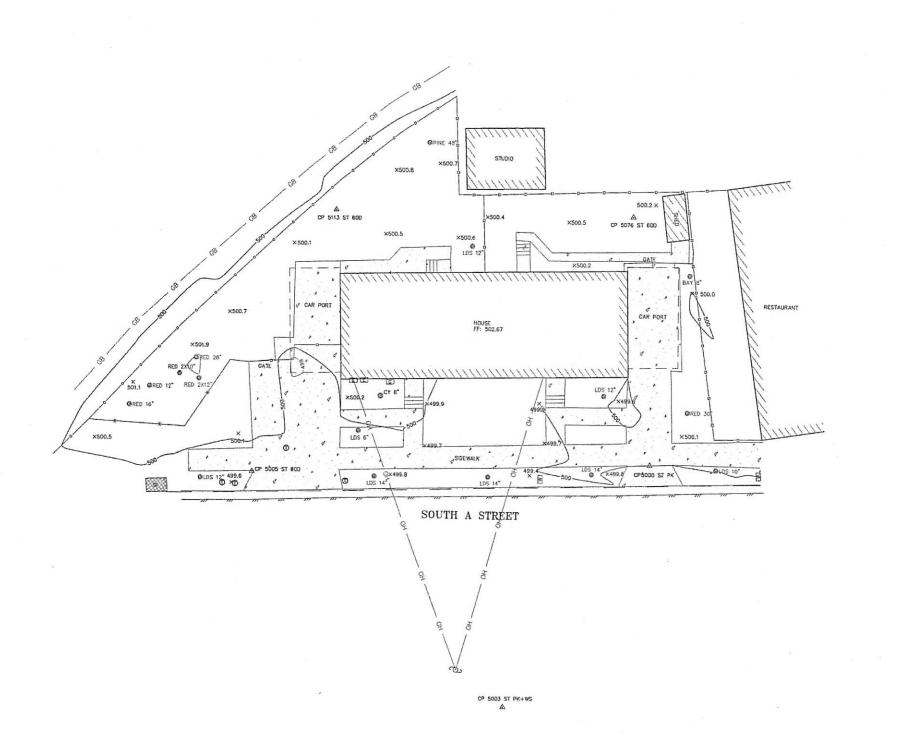

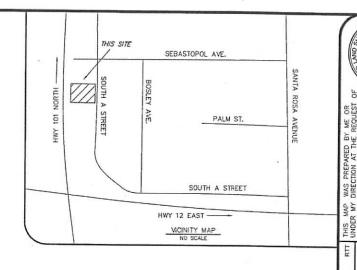

	FLOWLINE
***************************************	EDGE OF CONCRETE
	EDGE OF ASPHALT CONCRETE
—— GB ——	GRADE BREAK
Territion .	EDGE OF BUILDING
	BUILDING OVERHANG
	WOOD FENCE
×	WRE FENCE
00	CHAINLINK FENCE
— CH ——	OVERHEAD WIRE
_	MINOR CONTOUR
100	MAJOR CONTOUR
4 446 4	CONCRETE SURFACE


TMBULS	
വ	POWER POLE
CWD	WATER METER
	ELECTRIC METER
Φ.	STORM DRAIN MANHOLE
Ф	TELEPHONE MANHOLE
© <sub>CO</sub>	SEWER CLEAN OUT
<b>∆</b> 3	RANDOM CONTROL POINT W/#
× 143.2	SPOT ELEVATION
© <sup>80.24</sup> "	TREE TYPE & DIA.

#### ABBREVIATION

LEGEND

ABBREVIATIONS			
	OK/OAK	OAK TREE	
	RD/RW	REDWOOD TREE	
	PN/PINE	PINE TREE	
	CY	CYPRESS TREE	
	LDS	LANDSCAPE TREE	
	FF	FINISH FLOOR	
	DI	DROP INLET	
	SS	SANITARY SEWER	
	co	CLEAN OUT	



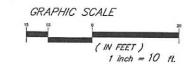

#### NOTES:

- HORIZONTAL CONTROL:
   COMPASS NORTH AZIMUTH FROM CP5000-CP5001 (350')
- VERTICAL CONTROL: ELEVATION DATUM IS ASSUMED AT CONTROL POINT #5000 (500.00')

HOGATH STREET
SANTABOSA CA GARGA CORPORATION
A CALIFORNIA CORPORATION
A

TOPOGRAPHIC MAP