PRELIMINARY / FINAL DESIGN REVIEW

5173 SONOMA HIGHWAY SANTA ROSA, CALIFORNIA



CITY OF SANTA ROSA 100 SANTA ROSA AVENUE RM 3 SANTA ROSA, CA 95404

MAY 09 2016


COMMUNITY DEVELOPMENT DEPARTMENT



2321 Bethards Drive

Fax 707 542 2328

LOCATION MAP

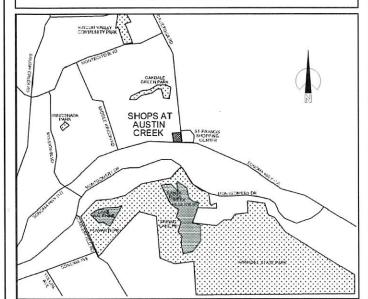

PROJECT INFORMATION

ZONING:	CG - General Commercial
ASSESSORS PARCEL #:	183-410-058 & 183-410-060
EXISTING SITE AREA: SITE AREA AFTER	+/- 5.32 AC. (231,894 S.F.)
ROW DEDICATION:	+/- 5.24 AC. (228,072 S.F.)
MAXIMUM LOT COVERAGE:	19%
MAXIMUM BUILDING HEIGH	T: 35 Feet
REQUIRED PARKING:	1 space / 250 Sq Ft x 43,206 Sq Ft 173 spaces required

PARKING PROVIDED: STANDARD SPACES: COMPACT SPACES: ACCESSIBLE SPACES:

REQUIRES A PARKING REDUCTION OF 9%

PARKING LOT SETBACK 15' FROM BACK OF SIDEWALK 30' FROM TOP OF BANK 10' FROM PROPERTY LINE

B / Commercial & M / Mercantile B / Commercial & M / Mercantile

CONSTRUCTION: Type V-B non- rated construction with Fire Suppression System

FLOOR AREAS: 8,424 Sq Ft Building #3 13,782 Sq Ft 16,645 Sq F 43,067 Sq F

2013 California Building Code APPLICABLE CODES: 2013 Plumbing Code 2013 California Mechanical Code 2013 California Electrical Code

2013 California Fire Code 2013 California Energy Code

ARCHITECT:

PROJECT TEAM

Hedgpeth Architects 3883 Airway Drive, Suite 210 Santa Rosa, CA 95403 707-523-7010 office 707-542-2328 fax Warren Hedgpeth warren @hedgpethare bob@hedgpetharchitects.com

LANDSCAPE ARCHITECT Tangram Landscape Architecture 944 Ripley Street Santa Rosa, CA 95401 (707) 527-7920 office robcox@tangramla.com

CIVIL ENGINEER: Civil Design Consultants, Inc. 2200 Range Avenue, Suite 204

Santa Rosa, CA 95403 707-542-4820 office 707-542-4535 fax Andy Bordessa Andy@CivilDesignConsultants.com

PLANNING CONSULTANT Jean Kapolchok & Associates

843 2nd Street Santa Rosa, CA 95404 (707) 526-8939 office

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1212


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AG.1




Looking West from Calistoga Road 1






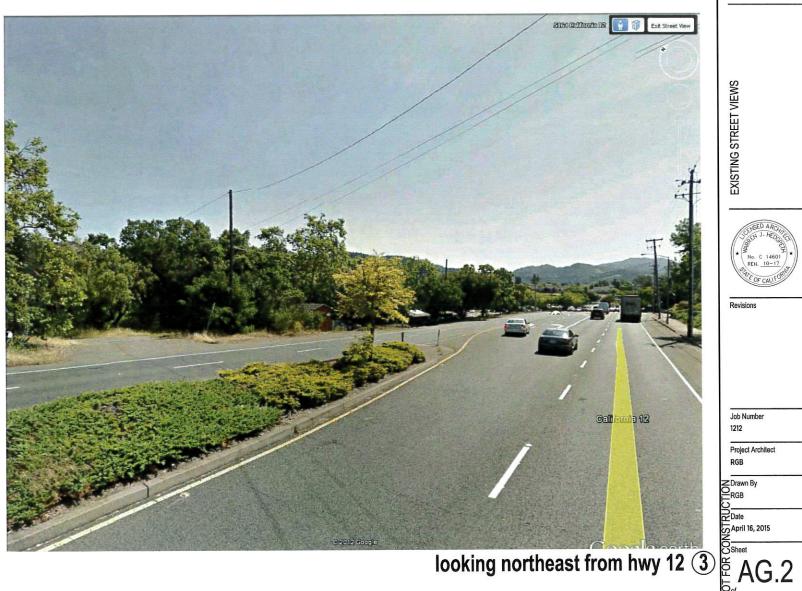

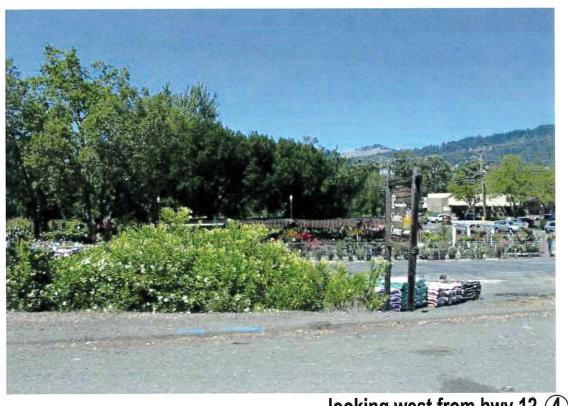


looking west from hwy 12 (4)

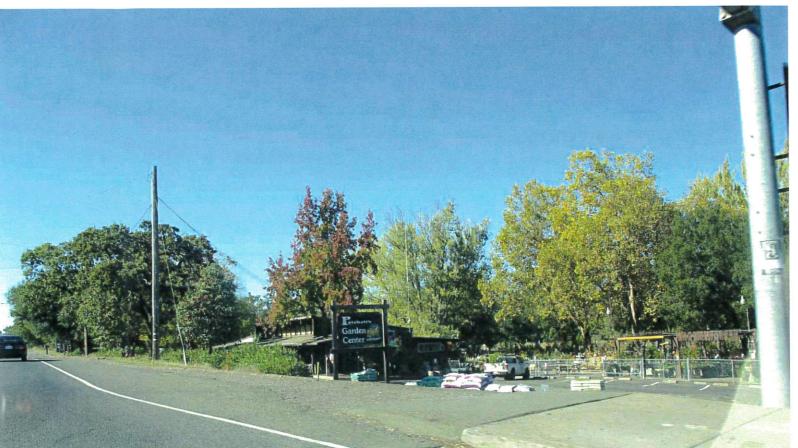

looking northwest from hwy 12 (5)



looking northwest from hwy 12 intersection (6)

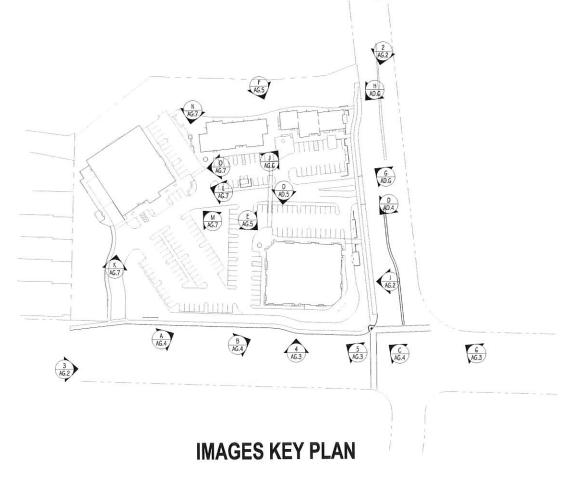


EXISTING STREET VIEWS



E AG.3



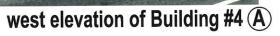



southeast corner of building #4 looking towards intersection B



northeast corner of building #4 , and pedestrian entry and monument sign ©



3D SITE & BUILDING IMAGES



EAG.4







northwest corner (main entry) of building #4 (E)



gathering area between buildings #1 & #2 (F)

w A R R E N
Hedgeth
A R C H I I E C I S

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THE SHOPS at AUSTIN CREEK ONE CALISTOGA ROAD ASSOCIATES

3D SITE & BUILDING IMAGES



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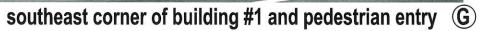
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Date

Sheet

AG.5







northeast corner of building #1 and pedestrian entry $\stackrel{\frown}{\mathbb{H}}$



southwest corner of building #1 ①



3D SITE & BUILDING IMAGES



Job Number

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AG.7



west corner of building #3 (L)



south corner of building #3 (K)



west corner of building #3 aerial (M)




north corner of building #3 (N)



A, A2, A3 and A4
POLE MOUNTED AREA LIGHTING



B and C WALL MOUNTED AREA LIGHTING

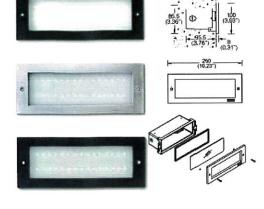

D RECESSED LOW LEVEL LIGHTING






RECESSED CANOPY LIGHTING



POLE MOUNTED AREA LIGHTING

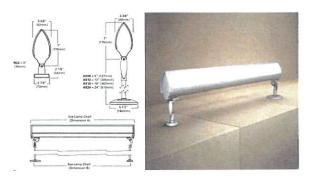

GROUND MOUNTED MONUMENT SIGN LIGHTING



STRING LIGHTING
BETWEEN BUILDINGS #1 and BUILDING #2



TREE at WOOD DECK



POSSIBLE SITE ART




TREE GRATE

SIGN LETTERING ON CANOPY EDGE



VINE COVERD LOW WALLS

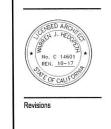

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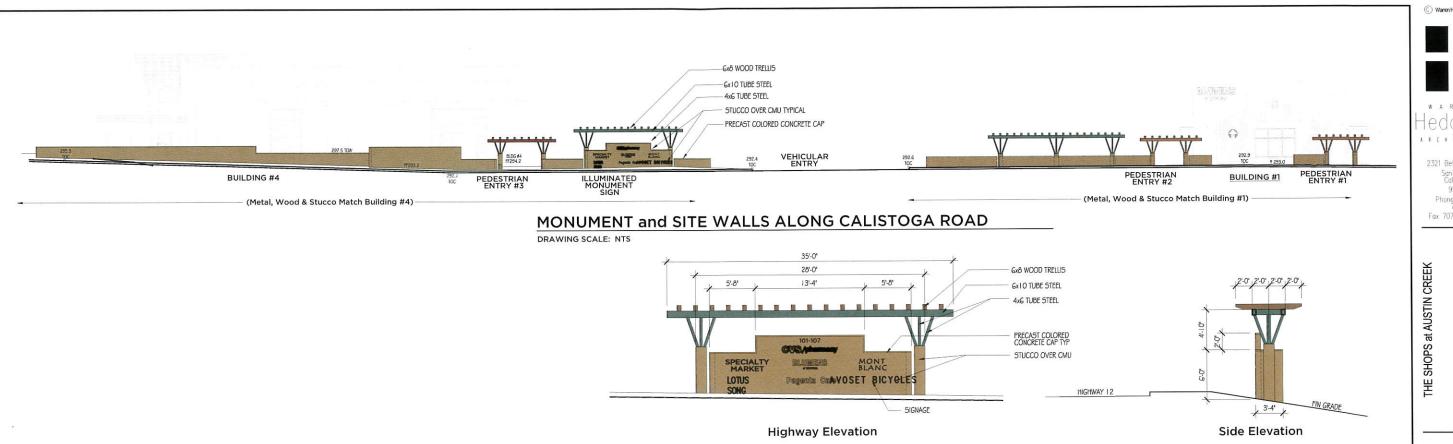
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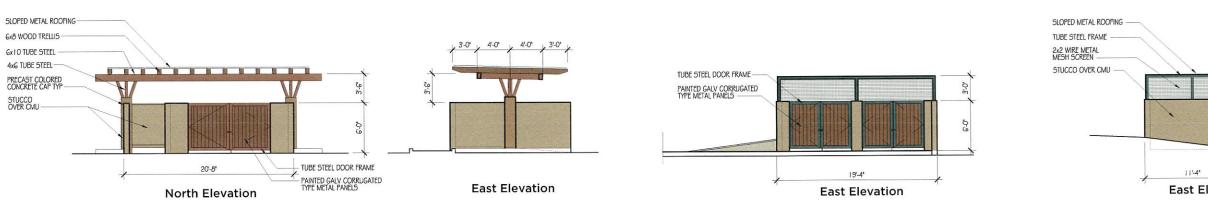
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Date

Sheet A1.3




ILLUMINATED MONUMENT SIGN ALONG HIGHWAY 12 DRAWING SCALE: 3/16" =1'-0"




TRASH ENCLOSURE #1 - at Building #2

DRAWING SCALE: 3/16" =1'-0"

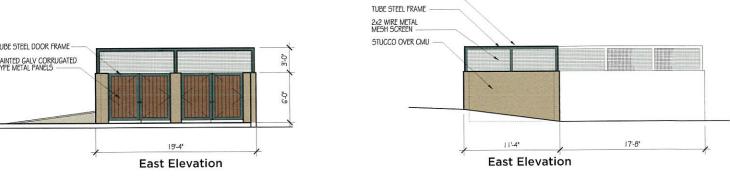

TRASH ENCLOSURE #2 - at Market Building #3

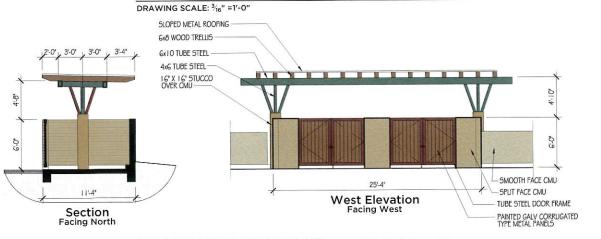

TRASH ENCLOSURE #3 - at CVS Building #4

DRAWING SCALE: 3/16" =1'-0"



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MONUMENTS SIGNS & TRASH ENCLOSURES




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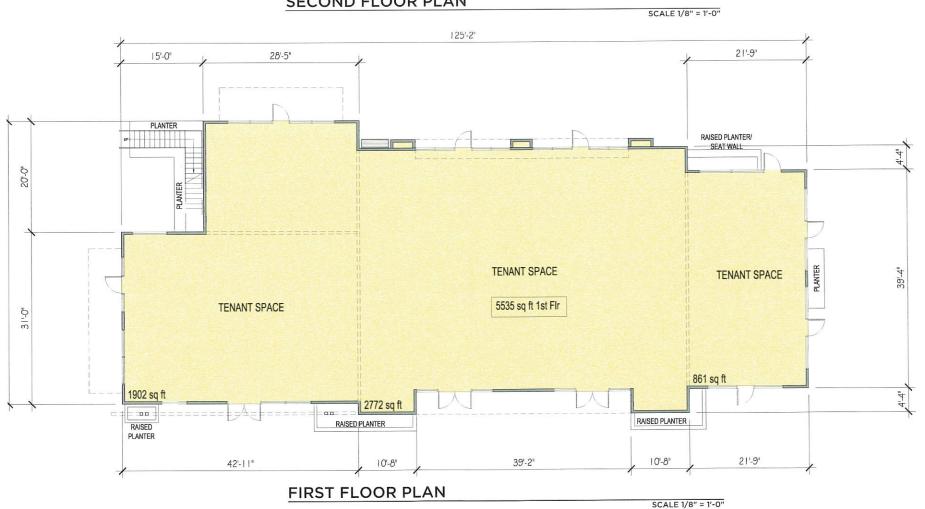
Job Number 1212

Project Archite

April 16, 2015





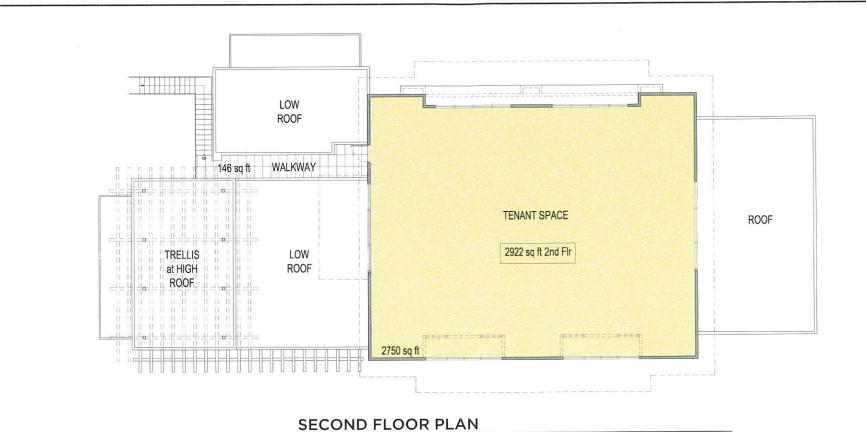

AUSTIN CREEK FLOOR PLANS - BUILDING #2

DRAWING SCALE 1/8" = 1'-0"



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THE SHOPS at AUSTIN CREEK

BUILDING 2 1st AND 2nd FLOOR PLANS



Job Number 1212

Project Architect RGB

ORGB

April 16, 2015





SOUTH ELEVATION

4x6 TUBE STEEL

5PLIT FACE PLANTERS TYPICAL-

SCALE 1/8" = 1'-0"

AUSTIN CREEK EXTERIOR ELEVATIONS - BUILDING #2

DRAWING SCALE 1/8" = 1'-0" 0' 8' 16' 24' 32' 40'

w A R R E N Hedgpeth

> 2321 Bethards Drive Santa Rosa, California 95405 Phone 707 523 7010

Phone 707 523 7010 Fax 707 542 2328

THE SHOPS at AUSTIN CREEK
ONE CALISTOGA ROAD ASSOCIATES

BUILDING 2 EXTERIOR ELEVATIONS



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Job Number 1212


Project Architect RGB

Drawn By

Dale April 16, 2015

EBldg2



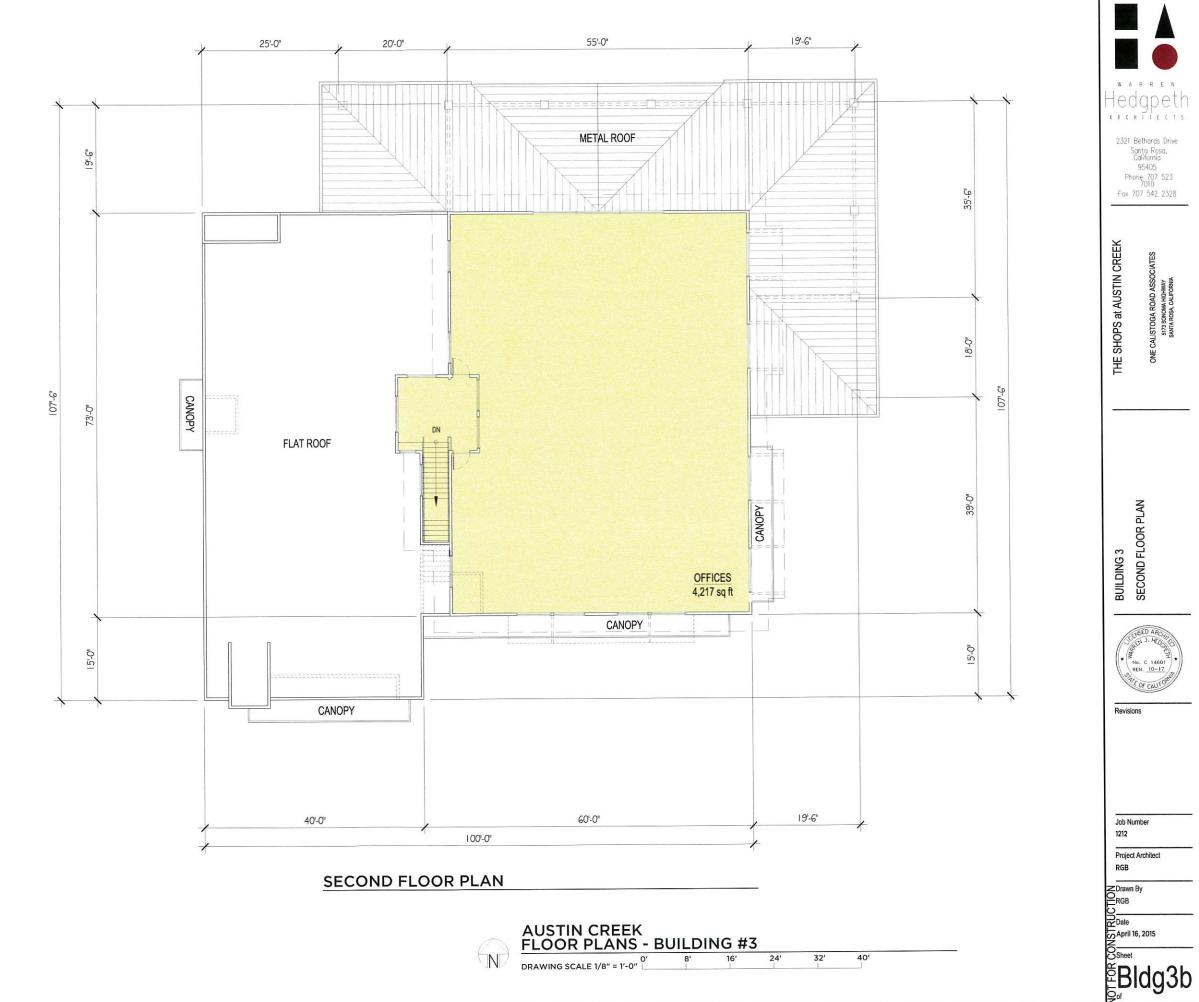



SOUTH ELEVATION

SCALE 1/8" = 1'-0"



WEST ELEVATION

SCALE 1/8" = 1'-0"

AUSTIN CREEK EXTERIOR ELEVATIONS - BUILDING #3

DRAWING SCALE 1/8" = 1'-0"

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THE SHOPS AT AUSTIN CREEK

BUILDING 3 EXTERIOR ELEVATIONS

Job Number 1223

Project Architect

Drawn By RGB

Date APRIL 16, 2015

Bldg3c



NORTH ELEVATION

SCALE 1/8" = 1'-0"



EAST ELEVATION

SCALE 1/8" = 1'-0"

AUSTIN CREEK EXTERIOR ELEVATIONS - BUILDING #3

0' 8' 16' 24' 32' 40'
AWING SCALE 1/8" = 1'-0"

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THE SHOPS AT AUSTIN CREEK
ONE CALISTOGA ROAD ASSOCIATES
5173 SONOMA HIGHWAY

BUILDING #3
EXTERIOR ELEVATIONS

Job Number

Project Architect


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Date
APRIL 16, 2015

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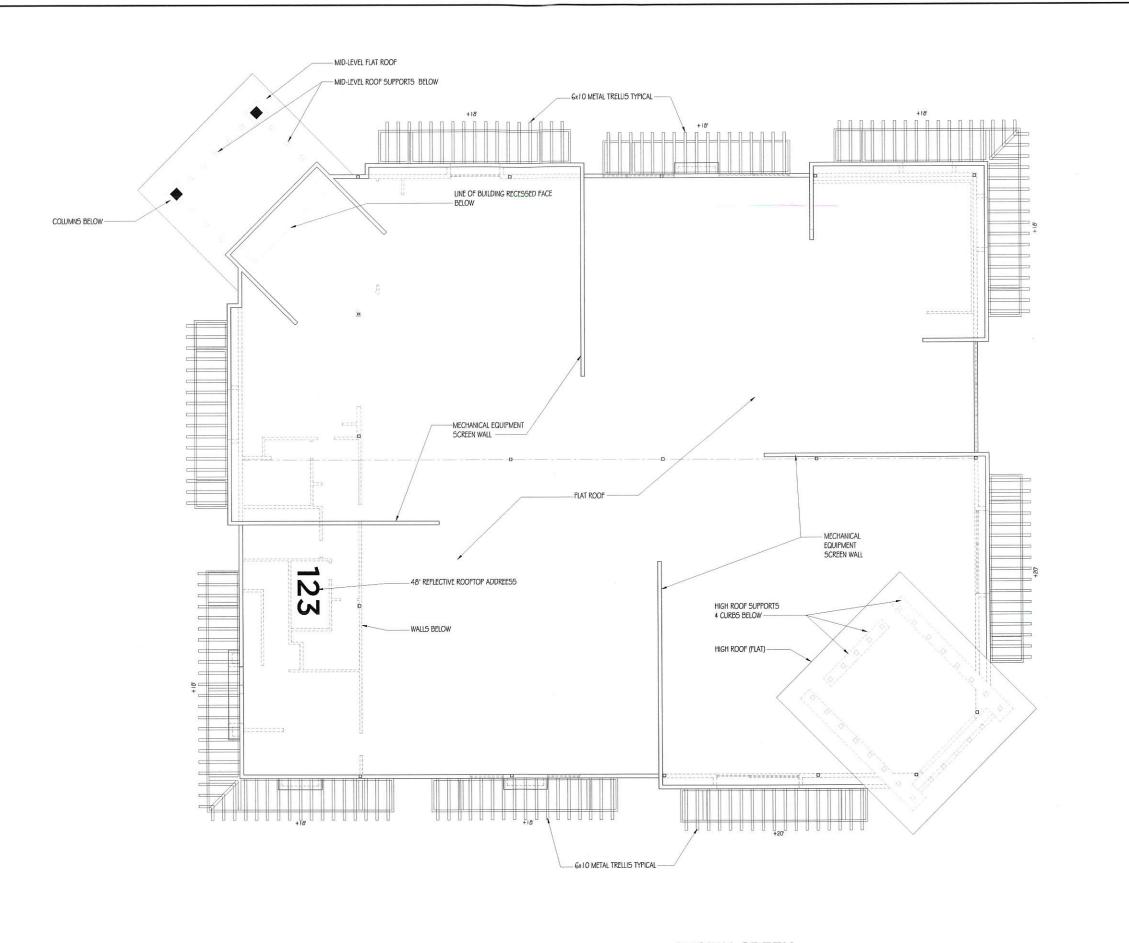
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THE SHOPS at AUSTIN CREEK

BUILDING #4 CVS / PHARMACY ROOF PLAN



Revisions

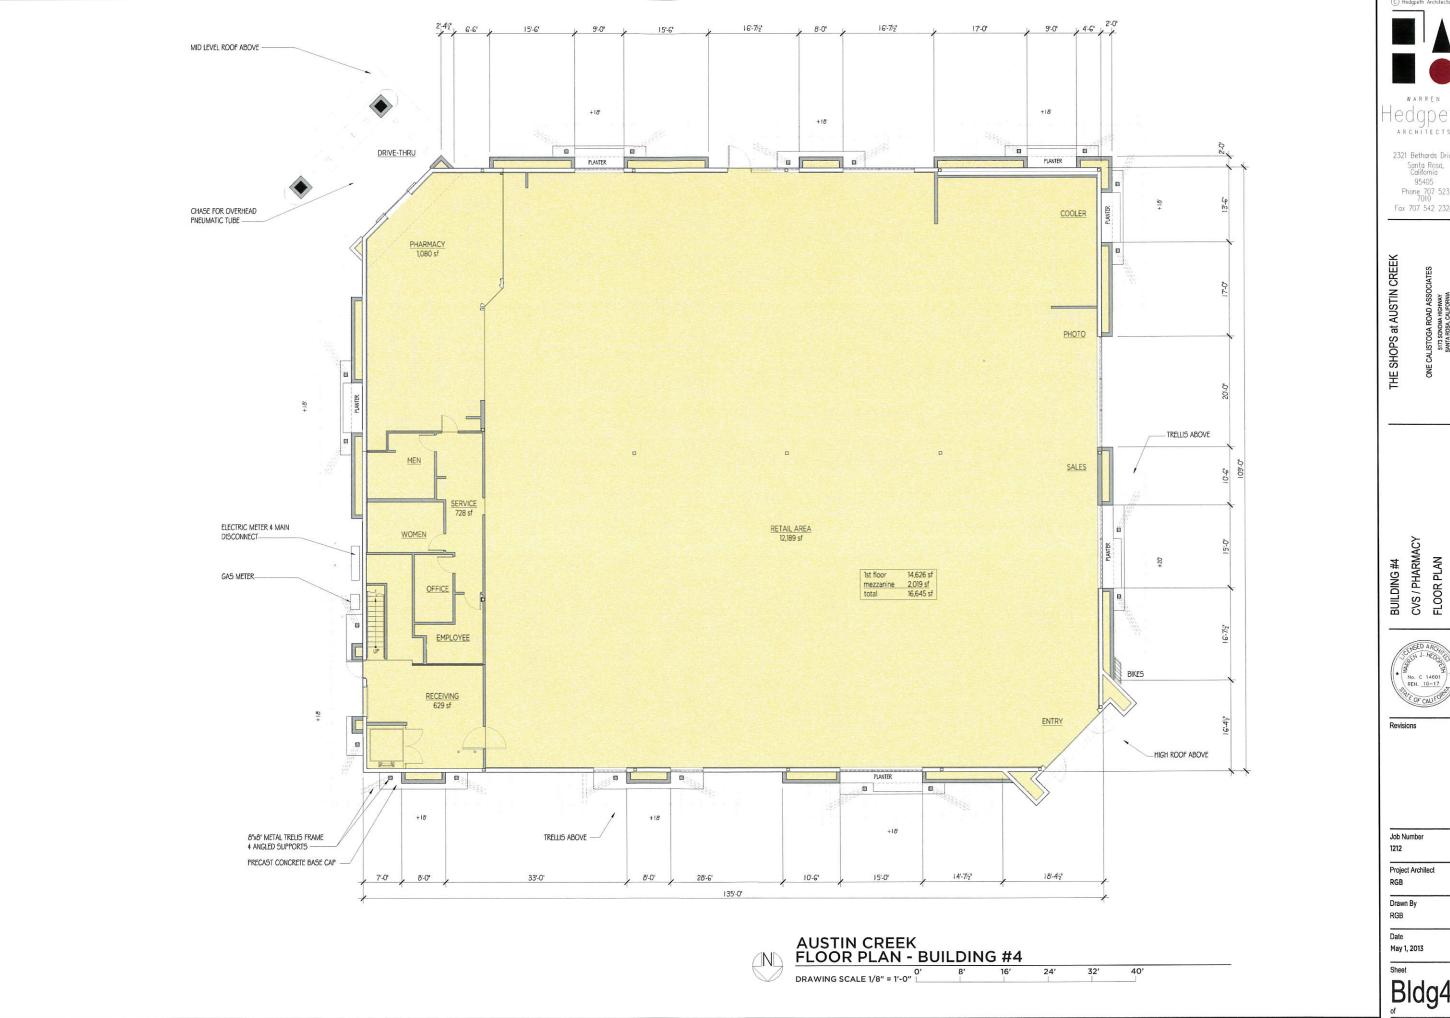Job Number 1212

Project Architect

Drawn By

RGB

Date May 1, 2013

Sheet

AUSTIN CREEK ROOF PLAN - BUILDING #4

DRAWING SCALE 1/8" = 1'-0" 32' 40' CANDIDATE PLANT LEGEND



LANDSCAPE DESIGN CRITERIA

PLANTING AREAS SHALL CONSIST OF A MIXTURE OF TREES, SHRUBS, AND GROUNDCOVER SUITABLE TO LOCAL SITE CONDITIONS INCLUDING CLIMATE, SOILS, AND HYDROLOGY.

PLANTINGS SHALL BE APPLIED IN SINGLE LAYERS WITH ATTENTION GIVEN TO TEXTURE, COLOR, AND FORM IN ORDER TO MAXIMIZE THE EFFECT OF AVAILABLE PLANTING AREAS.

PLANTS SHALL BE SELECTED SUITED TO THE SIZE AND LOCATION OF THE SPACES THEY WILL OCCUPY. NO TREES SHALL BE PLANTED UNDER ANY POWER LINES.

PLANTERS HAVE BEEN INCORPORATED INTO THE PARKING AREAS TO SOFTEN THE HARDSCAPE EFFECT. THIS PLAN REFLECTS THE CITY OF SANTA ROSA'S ORCHARD PARKING RECOMMENDATIONS

ORNAMENTAL PLANTINGS SHALL BE CONCENTRATED AROUND THE PEDESTRIAN AND VEHICULAR ENTRANCES, AS WELL AS OTHER AREAS WHERE THEY WILL HAVE THE GREATEST VISUAL IMPACT.

DENSE PLANTINGS SHALL BE USED TO HELP SCREEN UTILITIES AND OTHER UNDESIRABLE VISUAL ELEMENTS.

THE OVERALL PLANTING SCHEME SHALL FOLLOW THE CITY OF SANTA ROSA'S ESTABLISHED LANDSCAPE DESIGN STANDARDS, AS WELL AS OTHER COMMONLY ACCEPTED LANDSCAPE DESIGN PRACTICES NOT SPECIFICALLY LISTED IN ORDER TO CREATE A HEALTHY, VIABLE, AND CONTEXT SENSITIVE PROJECT.

ALL PLANTING AND IRRIGATION WILL ADHERE TO SANTA ROSA'S $\underline{\textit{WATER EFFICIENT LANDSCAPE}}$ $\underline{\textit{ORDINANCE}}$ (WELO).

PEDESTRIAN PAVING

CONCRETE SIDEWALKS AND PAVING THROUGHOUT, ALTERNATING COLORS OF "SAN DIEGO BUFF" AND "YOSEMITE BROWN" (DAVIS COLORS, www.daviscolors.com) OR SIMILAR COLORS.



TRAFFIC RATED PERMEABLE PAVERS.
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707 527 7920

AUSTIN CREEK

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SHOP

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Santa

5171

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HIGHWAY 12 SONOMA HEGHWAY

VICINITY MAP

PROJECT NO.	1404
DRAWN BY	RLC
SCALE	1" = 30 - 0
DATE	APRIL 2015
PHASE	SCHEMATIC
	DESIGN

SHEET TITLE

LANDSCAPE PLAN

SHEET NO.

L2



PREPARED BY D. KELLY CERTIFIED ARBORIST WE #1469-A. RCA 477

DEMOLITION AND SITE CLEARING

Provide pre-construction meeting with landscape architect, project arborist, developer and equipment operators to review work procedures, access and haul routes, and tree protection measures.

- Provide all tree protection zones with 6' tall chain link fence sections that are securely fastened together with posts driven into the ground. fence must be in place prior to delivery of equipment and any demolition or grading of the site. project arborist to check location of fencing prior to start of work.
- Identify trees to be removed and verify in the field with project arborist/ landscape architect. trees to be removed at this site are numbered and numbers correspond to graphic field plan. only specifically tagged trees are to be removed.
- Trees to be removed that have branches extending into the canopy of trees to remain must be removed by a qualified arborist and not by demolition or construction contractors, the qualified arborist must remove the tree in a manner that causes no damage to the
- 5. Stump grinding is mandatory to reduce impacts to adjacent trees remaining on the site. tree, root, or stump pulling is not allowed adjacent to preserved trees. root pruning to be performed by hand, with a carbide-tipped chain saw, sharp-bladed trencher or rock
- 6. Trees to be removed shall be felled away from tree protection zones; avoid pulling and breaking of roots of trees to remain.
- Trees removed within the protection zones shall be removed by a certified arborist or certified tree worker. the trees shall be cut near ground level and the stumps ground out.
- Any brush clearing required within the protected zone shall be accomplished with hand-operated equipment, heavy equipment operating from outside the protected zone is not allowed.
- Project arborist to work with selected tree service to provide safety clearance pruning on preserved trees. clearance pruning may involve ground clearance trimming or directional pruning of side branches to avoid damage to trees by equipment and reduce the potential obstruction hazard to equipment operators. trees must be pruned in accordance with the provided pruning specifications
- 10. Provide 8-inch layer of chipped site-generated mulch or purchased mulch for the tree protection zones.
- 11. Underground features, structures, paving, etc. removed within the tree protection zone shall use the smallest equipment possible. and operate from outside the tree protection zone. project arborist to monitor demolition activity.
- 12. Any damage to trees due to demolition activities shall be reported to the project arborist within 4 hours so that timely remedial action can be taken.
- 13. If temporary access is required over the root area of trees, a roadbed of 8 inches of mulch or gravel (underlain with filter fabric) shall be created to protect the roots and soil. the mulch shall be replenished as necessary to maintain an 8-inch depth.


PRUNING SPECIFICATIONS

Preserved trees within the project area shall be pruned to clear the crown of diseased, crossing, weak, or dead branches; minimum size of 1.5 inches in diameter, maximum size of 3 inches in diameter. interior branches shall not be stripped out.

- 2. If temporary access is required near conifers, branches may be carefully tied back to hold them out of the clearance zone.
- All pruning shall be performed by an isa-certified arborist or certified tree worker. all pruning shall be in accordance with most recent isa tree pruning guidelines and the ansi pruning standard.
- Pruning cuts larger than 2 inches in diameter, except for dead branches, shall be avoided. flush cuts (cuts that expose heartwood) are forbidden.
- No more than 20% of live foliage in a given tree shall be removed.
- 6. brush shall be chipped on site and spread underneath the tree protection zone to a maximum depth of 6 inches, leaving the trunk
- C. CONSTRUCTION SPECIFICATIONS ADJACENT TO PRESERVED TREES
- Fences erected to define protection zones for trees may not be removed until all site work has been completed, fences may not be relocated or removed without written permission from the landscape architect.
- Construction trailers, trucks, equipment, and storage areas must remain outside of protection zones at all times.
- All underground utilities, drains, and irrigation lines shall be routed outside of the tree protection zones.. if lines must traverse the protection area, they shall be tunneled or bored under the tree, not trenched.
- No materials, spoils, waste or washout water may be deposited, stored or parked within the tree protection zone.
- 5. Additional tree pruning, if required, must be performed by a certified arborist and not by construction personnel.
- Any herbicides placed under paving materials must be safe for use around trees, and labeled for that use.
- Any grading, construction, demolition, or other work expected to encounter tree roots must be monitored by the project arborist. All impacted trees shall be watered on a two-week schedule. each irrigation event shall wet the soil within the protection zone to a depth of 30 inches. water and cover exposed roots daily until trenches are backfilled or hardscape has been constructed and
- 9. If necessary, erosion control devices such as silt fencing or debris basins shall be installed to prevent siltation or water diversion
- 10. Before grading, pad preparation, or excavation for foundations, footings, walls or trenching, trees shall be root pruned one foot outside the tree protection zone by cutting all roots cleanly to the indicated depth. roots shall be cut by exposing with an air spade (or manually digging a trench) and cutting exposed roots with a saw, rock saw, narrow trencher with sharp blades, or carbide-tipped
- 11. Any roots damaged during grading or construction shall be exposed to sound tissue and cut cleanly with a saw.
- 12. Spoils from trenches and other excavations shall not be placed within the tree protection zone, either temporarily or permanently.
- 13. No burn piles, trash or debris shall be located within the tree protection zone.
- 14. No smoking or heat sources allowed near mulch of trees
- 15. Fill soil adjacent to existing trees must be of similar texture (percentage of sand, silt, and clay). no fill soils allowed within driplines of preserved trees. (except as shown on plans). no alteration of grade or hydrology within or impacting tree protection zones without
- 16. All trees designated for removal shall be clearly marked with surveyor's flagging and reviewed prior to removal.


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KEY

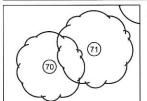

EXISTING TREE TO BE RETAINED SEE FOLLOWING SHEET FOR

INFORMATION PERTAINING TO SPECIFIC TREES

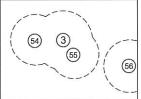

EXISTING TREE TO BE REMOVED

SEE FOLLOWING SHEET FOR INFORMATION PERTAINING TO SPECIFIC TREES



AND 7173 Santa Ros APN 183-4 AND



VICINITY MAP

1404	PROJECT NO.
RLC	DRAWN BY
AS SHOWN	SCALE
APRIL 2015	DATE
SCHEMATIC	PHASE
DESIGN	

SHEET TITLE

ARBORIST REPORT PLAN

Prickett's Family Shopping Center 5173 Sonoma Highway Santa Rosa, CA

TREE #	SPECIES	TRUNK DIAMETER (in.) @ 4.5 ' above grade	HEALTH & VIGOR	STRUCTUR AL INTEGRITY	COMMENTS	RECOMMENDATION
1	silver maple / Acer saccharinum	56*	fair-good	poor	Over-mature	Shown as within development footprint
2	Oregon white oak / Quercus garryana	92* (5 trunks)	fair-good	fair	Radius 40' S into proposed project; over-mature	Within creek setback
3	London plane / Platanus x acerifolia	26*	good	fair-good		Shown as within development footprint.
4	valley cak / Quercus lobata	19*	fair	very good	Several dead brs & twigs; galls	20' radius canopy. Cut'fill must be minimal or lon term stability will be compromised. See report.
5	sweet gum / Liquidambar styraciflua	21*	good	fair		Shown as within development footprint
6	coast live oak / Quercus agrifolia	19*	good	fair	Co-dominant trunks @ 15'	Shown as within development footprint
7	coast live oak / Quercus agrifolia	14*	good	fair	Co-dominant trunks @ 6'	Shown as within development footprint
8	silver maple / Acer saccharinum	43*	good	poor	Over-mature	Shown as within development footprint
9	coast live oak / Quercus agrifolia	27*@3	very good	poor	Borer frass near 16" pruning cut E side, co-dom trks	Shown as within development footprint
10	silver maple / Acer saccharinum	53*	good	very poor	Over-mature	Remove.
11	honey locust / Gleditsia triacanthos	15*	fair	poor-fair		Remove.
12	missing					Not found,
13	sweet gum / Liquidambar styraciflua	19*	good	fair		Shown as within development footprint.
14	missing					Not found.
15	coast live oak / Quercus agrifolia	16* (2 trunks)	excellent	excellent		Shown as within development footprint
16	honey locust / Gleditsia triacanthos	17*	poor	poor		Shown as within development footprint.
17	Oregon white oak / Quercus garryana	24*	excellent	fair	Co-dom. trunks @ 7" wi ind bark, prune to 1 leader	30' radius canopy. Cut'fill must be minimal or lon- term stability will be compromised. See report.
18	London plane / Piatanus x acerifolia	23*	excellent	excellent		25' radius canopy. Cut'fill must be minimal or lon term stability will be compromised. See report.
19	coast live oak / Quercus agrifolia	26"	excellent	very poor	Co-dominant trunks @ 6', soil at base, needs ext	Shown as within development footprint
20	valley cak / Quercus iobata	25" (2 trunks)	dead	dead	Long crack from base & borers.	Remove.
21	Oregon white oak / Quercus garryana	22*	good	fair	Himalayan blackberries, no tag.	Engineered fill and aeration system to be used over root zones where fill is required, prune tree
	coast live oak / Quercus agrifolia	24*	excellent	good	Co-dominant trunks @ 12*	Engineered fill and aeration system to be used over root zones where fill is required, prune tree
23	coast live oak / Quercus agrifolia	23" (2 trunks)	good	fair	Poor pruning cuts.	Shown as within development footprint.
24	Oregon ash / Fraxinus latifolia	10°	good	good	Small valley oaks wi this tree	Shown as within development footprint.
25	Oregon white oak / Quercus garryana	46° @ 2	fair	fair		Shown as within development footprint

TREE #	SPECIES	TRUNK DIAMETER (in.) @ 4.5 * above grade	HEALTH & VIGOR	STRUCTUR AL INTEGRITY	COMMENTS	RECOMMENDATION
26	coast live oak / Quercus agrifolia	16*	excellent	very good		Shown as within development footprint
27	Oregon white oak / Quercus garryana	13"	good	fair	No tag, poison oak.	Shown as within development footprint.
28	Oregon white oak / Quercus garryana	16"	fair	good		Shown as within development footprint.
29	coast live oak / Quercus agrifolia	9"	good	fair	Suppressed by close trees	Shown as within development footprint
30	coast live oak / Quercus agrifolia	6" cluster	good	good	Several small oaks here.	Shown as within development footprint.
31	valley oak / Quercus lobata	9"	good	good		Preserve, no grading or planting within dripline, mulch only.
32	valley oak / Quercus lobata	n/a -poison oak	good	good		Shown as within development footprint
33	Oregon white oak / Quercus garryana	19°	good	good	lvy up trunk	Shown as within development footprint
34	Oregon white oak / Quercus garryana	21*	good	good	Nice tree, poison oak	No grading or planting within dripline, mulch only
35	Oregon white oak / Quercus garryana	14*	good	good	Poison oak	No grading or planting within dripline, mulch only
36	London plane / Platanus x acerifolia	14*	very poor	very poor		Remove.
37	Japanese privet / Ligustrum japonicum	15" (3 trunks)	poor	poor	Weedy species	Remove.
38	mayten / Maytenus boaria	23" (2 trunks)	poor	poor		Remove.
39	coast live oak / Quercus agrifolia	36" (3 trunks)	good	fair	Co-dom. trunks; R=10° E,S, N	No grading or planting within dripline, mulch only
40	London plane / Platanus x acerifolia	24*	very good	fair		Shown as within development footprint.
41	red ironbark / Eucalyptus sideroxylon	22*	very poor	very poor	Poor pruning cuts, topping	Shown as within development footprint.
42	Oregon white oak / Quercus garryana	18" (2 trunks)	fair	fair	Co-dominant trunks @ 2*	Shown as within development footprint.
43	coast live oak / Quercus agrifolia	16" (2 trunks)	good	fair	Co-dominant trunks @ 4'	Shown as within development footprint.
44	valley oak / Quercus lobata	9"	good	fair		Shown as within development footprint.
45	sweet gum / Liquidambar styraciflua	15*	good	poor	1.5' from curb, surface roots	Shown as within development footprint.
46A	madrone / Arbutus menziesii	6"	good	good		Remove to provide turn lane and sidewalk.
46B	Oregon white oak / Quercus garryana	19*	very good	very good		Remove to provide turn lane and sidewalk
47	madrone / Arbutus menziesii	21" (3 trunks)	very good	very good	OH lines	Remove to provide turn lane and sidewalk.
48	Oregon white oak / Quercus garryana	30*	good	good	OH lines	Remove to provide turn lane and sidewalk

TREE #	SPECIES	TRUNK DIAMETER (in.) @ 4.5 'above grade	HEALTH & VIGOR	STRUCTUR AL INTEGRITY	COMMENTS	RECOMMENDATION
49	coast live oak / Quercus agrifolia	43" (4 trunks)	good	fair	OH power lines; co-dom. trnk	Remove to provide turn lane and sidewalk.
50	coast live oak / Quercus agrifolia	23" (2 trunks)	good	fair	Co-dominant trunks @ 1'	Remove to provide turn lane and sidewalk.
51	Chinese elm / Ulmus parvifolia	21*	fair	poor-fair		Shown as within development footprint
52	London plane / Platanus x acerifolia	23*	good	good		Shown as within development footprint
53	silver maple / Acer saccharinum	37*	good	poor	Over-mature	Shown as within development footprint
54	London plane / Platanus x acerifolia	27*	good	fair-good		Shown as within development footprint
55	London plane / Platanus x acerifolia	261	good	fair-good		Shown as within development footprint
56	coast live oak / Quercus agritolia	48" (3 trunks)	fair	poor	18' pruning cut N side	Shown as within development footprint
57	Oregon white oak / Quercus garryana	44" (3 trunks)	good	fair-good	OH power lines	Remove to provide turn lane and sidewalk
58	coast live oak / Quercus agrifolia	15"	good	fair	OH power lines	Remove to provide turn lane and sidewalk.
59	coast live oak / Quercus agrifolia	11*	good	fair-good	OH power lines; co-dom. trnk	Remove to provide turn lane and sidewalk.
60	coast live oak / Quercus agrifolia	17*	good	good	OH power lines	Remove to provide turn lane and sidewalk.
61	Oregon white oak / Quercus garryana	17*	good	fair	J' trunk shape	eserve. no grading/planting within dripline, mulch
62	Oregon white oak / Quercus garryana	9"	good	good	Forked @ 12	eserve, no grading/planting within dripline, mulch
63	coast live oak / Quercus agrifolia	17*	good	fair-poor	Co-dominant trunks@base	eserve, no grading/planting within dripline, mulch
64	coast live oak / Quercus agrifolia	13"	good	good		No grading or planting within dripline, mulch on
65	California pepper tree! Schinus molle	40*	fair	ext. poor		Remove.
66	coast live oak / Quercus agrifolia	27" (3 trunks)	good	fair	Co-dominant trunks @ 1' & 4'	eserve, no grading/planting within dripline, mulch
67	Oregon white oak / Quercus garryana	14*	good	fair	Co-dominant trunks @ 5' & 8'	eserve, no grading/planting within dripline, mulch
68	coast live oak / Quercus agrifolia	20*	very good	very poor	Co-dominant trunks	Shown as within development footprint.
69	coast live oak / Quercus agrifolia	15*	good	good		No grading or planting within dripline, mulch on
70	valley oak / Quercus tobata	60"+	poor	poor	Over-mature, R=60-70'E	Within creek setback
71	valley oak / Quercus lobata	30*	poor	v poor	broken apart	Within creek setback
72	Oregon white oak / Quercus garryana	16" + 14"	good	good	R= 30' S into project	Within creek setback

TREE #	SPECIES	TRUNK DIAMETER (in.) @ 4.5 ' above grade	HEALTH & VIGOR	STRUCTUR AL INTEGRITY	COMMENTS	RECOMMENDATION
73	Oregon white oak / Quercus garryana	13*	good	good	Co-dom. trunks @ 8'; R= 25'	Within creek setback
74	Oregon white oak / Quercus garryana	12*	good	good	R=30' S into project	Within creek setback.
75	Oregon white oak / Quercus garryana	9*	fair	fair	Poison oak	Within creek setback
76	valley oak / Quercus lobata	12"	fair	fair	Leaning 40' S into project	Within creek setback
77	valley oak / Quercus lobata	15*	good	good	Upright crown	Within creek setback
78	valley oak / Quercus lobata	13"	fair-good	fair-good	R= 30° S into project	Within creek setback.
79	valley oak / <i>Quercus lobata</i>	26*	fair-good	fair-good	Over-mature; debris @ base	Within creek setback.
80	red ironbark / Eucalyptus sideroxylon	14*	poor	very poor	Sprout from dead base	Remove.
81	cherry plum / Prunus cerasilera	19" (4 trunks)	fair	poor	Weedy, escaped species	Remove.
82	Oregon ash / Fraxinus latifolia	70° (7 trunks)	good	fair-good	R= 10' S into project	Within creek setback.
83	bay laurel / Umbellularia californica	41" (7 stems)	good	fair	On creek bank	Within creek setback
84	valley oak / Quercus lobata	20"	good	fair	On creek bank	Within creek setback.
85	valley oak / Quercus lobata	19*	good	fair	Entangled wi #85, poison oak	Within creek setback
86	valley oak / Quercus lobata	19*	good	fair		Within creek setback.
87	valley oak / Quercus lobata	18"	good	fair		Within creek setback.
88	valley oak / Quercus lobata	17"	good	fair	Poison oak, untagged	Within creek setback
89	Lombadry poplar / Populus nigra 'Italiq	12" @ 1"	Ext poor	Ext. poor	Dead	Remove.
90	London plane / Platanus x acerifolia	16"	good	fair		Remove to provide turn lane and sidewalk.
91	coast live oak / Quercus agrifolia	13° (2 trunks)	fair	fair	Grading over rootzone shown	Shown as within development footprint
92	valley oak / Quercus lobata	7*	good	good		No grading or planting within dripline, mulch only
93	incense cedar / Calocedrus decurrens	29*	fair	good		No grading or planting within dripline, mulch only
94	coast live oak / Quercus agrifolia	111*	good	fair		No grading or planting within dripline, mulch only
95	Oregon white oak / Quercus garryana	15"	good	very good	Poison oak, untagged	No grading or planting within dripline, mulch only
96	Oregon white oak / Quercus garryana	7*	good	fair-good		No grading or planting within dripline, mulch only

Performance of Services - Arborist's Disclosure:

Arborists are tree specialists who use their education, knowledge, training and experience to examine trees, recommend measures to enhance the beauty and health of the trees and attempt to reduce the risk of living near trees. Arborists cannot detect every condition that could possibly lead to the structural or root failure of a tree. Since trees are living organisms, conditions are often hidden within the tree and below ground. Arborists cannot guarantee that a tree will be healthy and safe under all circumstance, or for a specific period of time. Likewise, remedial treatments cannot be guaranteed. Trees can be managed but they cannot be controlled. To live near trees is to accept some degree of risk and the only way to eliminate all risk associated with trees is to eliminate all of the trees. Trees were visually evaluated only; no aerial inspections or soil excavations were performed as part of this inspection. Only trees designated for removal were evaluated. No warranty, shall perform services in a manner consistent with the standard of care and skill ordinarily exercised by members of the profession practicing under similar circumstances in the geographic vicinity and at the time the services are performed, and use reasonable efforts to comply with all laws, rules and regulations of any governmental or regulatory agency applicable to the Services. No warranty, representation of guarantee, express or implied, is intended by this Agreement. Arborist is not responsible for the completion or quality of work that is dependent upon or performed by Client or third parties not under the direct control of Arborist or for their acts or omissions or for any damages resulting therefrom.



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CONCEPT LANDSCAPE PLAN
SHOPS AT AUSTIN CREEK 1 AND 7173 Sanoma Highw Santa Rosa, CA 95402 APN 183-410-058, 060




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VICINITY MAP

PROJECT NO.	1404
DRAWN BY	RLC
SCALE	AS SHOWN
DATE	APRIL 2015
PHASE	SCHEMATIC
	DESIGN

ARBORIST DATA

SHEET NO.



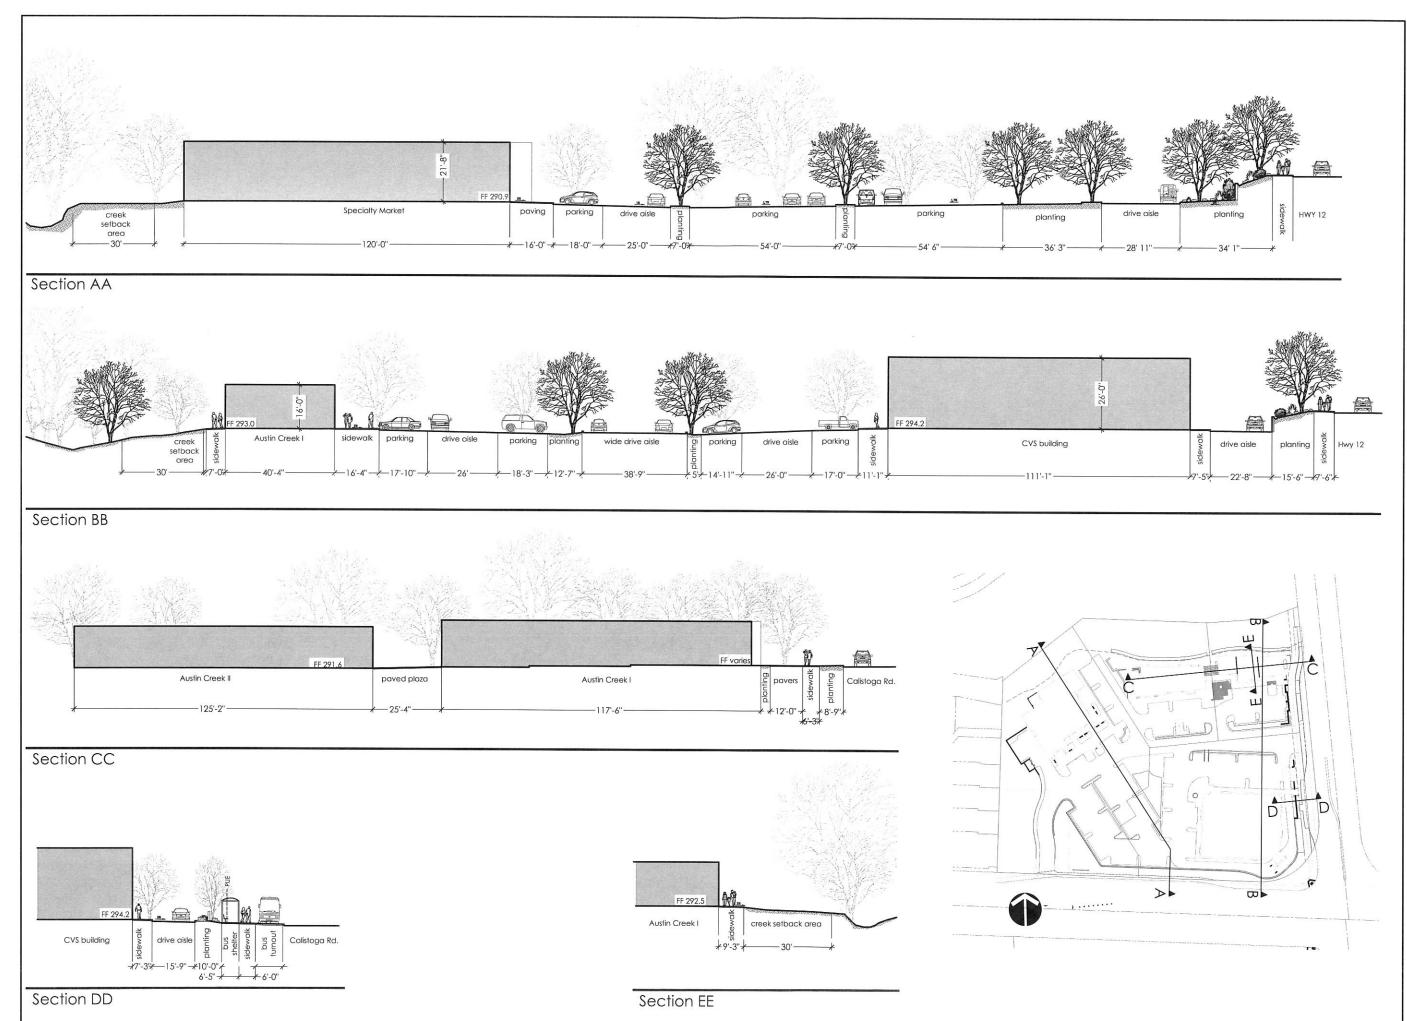

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CONCEPT LANDSCAPE PLAN
THE SHOPS AT AUSTIN CREEK



VICINITY MAP

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SHEET TITLE

SITE SECTIONS

L6