GENERAL NOTES

REGULATORY AGENCIES

AGENCY REQUIREMENTS.

ALL WORK SHALL CONFORM TO THE MOST CURRENT APPLICABLE CALIFORNIA CODE OF REGULATIONS (TITLE 24) PART SI-12, INCLUDING BUT NOT LIMITED TO: CALIFORNIA ADMINISTRATIVE CODE, 2016 CALIFORNIA BUILDING CODE, 2016 CALIFORNIA RESIDENTIAL CODE, 2016 CALIFORNIA ELECTRICAL CODE, 2016 CALIFORNIA MECHANICAL CODE, 2016 CALIFORNIA PLUMBING CODE, 2016 CALIFORNIA ENERGY CODE, 2016 CALIFORNIA HISTORICAL BUILDING CODE, 2016 CALIFORNIA GREEN BUILDING STANDARDS CODE, & 2016 CALIFORNIA REFERENCED STANDARDS CODE.

SEPARATE DRAWINGS, CALCULATIONS AND SUBMITTAL MATERIALS SHALL BE PROVIDED FOR REVIEW AND APPROVAL OF SIGNAGE. IT SHALL BE THE RESPONSIBILITY OF THE CONTRACTOR, AS HOLDER OF PERMITS TO NOTIFY THE BUILDING OFFICIAL WHEN WORK IS READY FOR INSPECTION. INSPECTION REQUESTS SHALL BE IN ACCORDANCE WITH

REGULATORY AGENCIES' REQUIREMENTS. INSPECTORS SHALL HAVE COMPLETE ACCESS TO ALL WORK. A RECORD OF INSPECTIONS SHALL BE MAINTAINED ON THE JOB SITE IN ACCORDANCE WITH REGULATORY

APPROVED PLANS SHALL BE KEPT IN A PLAN BOX AND SHALL NOT BE USED BY ANY WORKMEN. ALL CONSTRUCTION SETS SHALL REFLECT THE SAME INFORMATION. THE CONTRACTOR SHALL ALSO MAINTAIN IN GOOD CONDITION, ONE COMPLETE SET OF PLANS WITH ALL REVISIONS, ADDENDA, AND CHANGE ORDERS, ON THE PREMISES AT ALL TIMES WHICH ARE TO BE UNDER THE CARE OF THE JOB SUPERINTENDENT. A REPRODUCIBLE AS-BUILT SET SHALL BE PROVIDED TO THE OWNER WHEN COMPLETE.

PREPARATION FOR CONSTRUCTION

IT SHALL BE THE CONTRACTOR'S RESPONSIBILITY TO COMPLETELY FAMILIARIZE HIMSELF/HERSELF WITH THESE DRAWINGS AND THE SITE CONDITIONS, AND TO VERIFY ALL DETAILS WITH THE OWNER PRIOR TO THE START OF CONSTRUCTION. DO NOT SCALE DRAWINGS.

DIMENSIONS ARE TO FACE LINE OF STUD (F.O.S.) UNLESS OTHERWISE NOTED. WHERE REQUIRED, MINIMUM CLEAR DIMENSIONS HAVE BEEN NOTED. SEE COVER SHEET FOR GRAPHIC EXPLANATION. ANY DISCREPANCY OR ERROR IN DRAWINGS SHALL BE BROUGHT TO THE ATTENTION OF THE ARCHITECT AND OWNER PRIOR TO THE COMMENCEMENT OF WORK.

THE DRAWINGS DO NOT ILLUSTRATE EVERY CONDITION. THE DRAWINGS INDICATE LOCATIONS, DIMENSIONS, AND TYPICAL DETAILS OF CONSTRUCTION. WORK NOT EXPRESSLY DETAILED SHALL BE OF CONSTRUCTION SIMILAR TO PARTS THAT ARE DETAILED.

THE CONTRACT DRAWINGS AND SPECIFICATIONS REPRESENT THE FINISHED STRUCTURE. UNLESS OTHERWISE SHOWN, THEY DO NOT INDICATE THE METHOD OF CONSTRUCTION. THE GENERAL CONTRACTOR SHALL SUPERVISE AND DIRECT THE WORK AND HE/SHE SHALL BE SOLELY RESPONSIBLE FOR ALL CONSTRUCTION MEANS, METHODS, TECHNIQUES, SEQUENCES, AND PROCEDURES. OBSERVATION VISITS TO THE SITE BY FIELD REPRESENTATIVES OF THE ARCHITECT AND HIS CONSULTANTS DO NOT INCLUDE INSPECTION OF THE PROTECTIVE MEASURES OR THE PROCEDURES FOR SUCH METHODS OF CONSTRUCTION. ANY SUPPORT SERVICES PROVIDED BY THE ARCHITECT AND HIS CONSULTANTS DURING CONSTRUCTION SHALL BE DISTINGUISHED FROM CONTINUOUS AND DETAILED INSPECTION SERVICES WHICH ARE FURNISHED BY OTHERS. THESE SUPPORT SERVICES, WHICH ARE FURNISHED BY THE ARCHITECT AND HIS CONSULTANTS, WHETHER OF MATERIAL OR WORK AND WHETHER PERFORMED PRIOR TO, DURING, OR AFTER COMPLETION OF CONSTRUCTION, ARE PERFORMED SOLELY FOR THE PURPOSE OF ASSISTING IN QUALITY CONTROL AND IN ACHIEVING CONFORMANCE WITH CONTRACT DRAWINGS AND SPECIFICATIONS, BUT THEY DO NOT GUARANTEE CONTRACTOR'S PERFORMANCE AND SHALL NOT BE CONSTRUED AS SUPERVISION OF CONSTRUCTION.

THE ARCHITECT AND OWNER WILL NOT BE RESPONSIBLE FOR AMBIGUITIES AND OMISSIONS NOT BROUGHT TO THEIR ATTENTION.

BY SUBMITTING A BID, THE BIDDER AGREES AND WARRANTS THAT HE/SHE HAS EXAMINED THE DRAWINGS AND FOUND THAT THEY ARE ADEQUATE FOR COMPLETION OF THE PROJECT.

THE CONTRACTOR SHALL BE RESPONSIBLE FOR VERIFYING FIELD MEASUREMENTS BEFORE ORDERING MATERIALS AND PREFABRICATED ITEMS. ANY NECESSARY ADJUSTMENTS BETWEEN FIELD MEASUREMENTS AND DRAWINGS SHALL BE MADE IN ACCORDANCE WITH THE DECISION OF THE ARCHITECT AND/OR OWNER.

CONTRACTOR'S SCOPE OF WORK: ALL LABOR, MATERIALS, FABRICATION, EQUIPMENT, APPLIANCES, APPURTENANCES, TRANSPORTATION AND SERVICES REQUIRED FOR CONSTRUCTION, ERECTION, AND INSTALLATION OF ALL OF THE VARIOUS WORK INDICATED ON THE DRAWINGS AND/OR SPECIFIED UNDER EACH OF THE SPECIFICATION SECTIONS; ANY SITE DEMOLITION AND REMOVAL OF ANY MATERIAL, RUBBISH, OR DEBRIS ABOVE OR BELOW GRADE; ALL EARTHWORK AND FOUNDATION WORK.

THE CONTRACTOR SHALL BE RESPONSIBLE FOR LOCATING THE WORK IN ACCORDANCE WITH THE PROPERTY LINES AND ELEVATIONS PER THE SURVEY DRAWING AND GRADING/DRAINAGE PLAN.

CONTRACTOR TO COORDINATE ALL PLUMBING, GAS, ELECTRICAL, SPRINKLER, AND HVAC SYSTEMS FOR COMPATIBILITY WITH THE PROPOSED DESIGN PRIOR TO COMMENCEMENT OF CONSTRUCTION.

CONTRACTOR TO VERIFY ALL ELECTRICAL, PLUMBING, AND HVAC REQUIREMENTS FOR EXISTING OR SPECIFIED EQUIPMENT PRIOR TO CONSTRUCTION. ADDITIONALLY, CONTRACTOR SHALL CONFIRM EQUIPMENT LIST WITH THE ARCHITECT BEFORE COMMENCEMENT OF WORK.

RUFF + ASSOCIATES, INC. SHALL HAVE NO RESPONSIBILITY FOR THE DISCOVERY, HANDLING, PRESENCE, DISPOSAL, REMOVAL OF, OR EXPOSURE OF PERSONS TO HAZARDOUS MATERIALS IN ANY FORM AT THE PROJECT SITE, INCLUDING BUT NOT LIMITED TO ASBESTOS, ASBESTOS PRODUCTS. POLYCHLORINATED BIPHENYL (PCB), OR OTHER TOXIC SUBSTANCES. SUCH WORK, IF REQUIRED, SHALL BE COMPLETED UNDER SEPARATE CONTRACT.

GENERAL NOTES

ALL ITEMS OF MILLWORK SHALL BE CAREFULLY ERECTED WITH TIGHT-FITTING JOINTS, CAREFULLY CUT AND SECURED. EXPOSED NAILS OR SCREWS SHALL BE SET IN PUTTY. BACK PRIME ALL MILLWORK BEFORE INSTALLATION AND PROTECT AGAINST DAMPNESS. MOLDS AND FACES SHALL BE CLEAN CUT AND TRUE PATTERN. ALL WORK SHALL BE THOROUGHLY CLEANED AND SANDED TO RECEIVE THE FINISH. SHARP CORNERS OF SMALL MEMBERS OF FINISH WOODWORK SHALL BE SLIGHTLY ROUNDED.

3. ALL FRAMING SHALL BE INSTALLED CLOSELY FITTED, ACCURATELY SET IN PLACE TO THE REQUIRED LINES AND LEVELS, AND SHALL BE OF THE DIMENSIONS SHOWN ON DRAWINGS. DO NOT IMPAIR STRUCTURAL MEMBERS BY CUTTING OR DRILLING - CONSULT ARCHITECT.

4. ALL PROPRIETARY PRODUCTS NOTED ON THE DRAWINGS SHALL BE INSTALLED IN ACCORDANCE WITH THE MANUFACTURER'S RECOMMENDATIONS AND HAVE PRIOR APPROVAL FROM THE LOCAL GOVERNING AGENCIES.

5. THE ARCHITECT AND THE ENGINEER WILL MAKE PERIODIC VISITS TO THE JOB SITE TO OBSERVE THE PROGRESS OF THE WORK. THE ARCHITECT AND ENGINEER SHALL NOT HAVE CONTROL OR CHARGE OF, AND SHALL NOT BE RESPONSIBLE FOR, CONSTRUCTION MEANS, METHODS, TECHNIQUES, SEQUENCES OR PROCEDURES, FOR SAFETY PRECAUTIONS AND PROGRAMS IN CONNECTION WITH THE WORK, FOR ACTS OR OMISSIONS OF THE CONTRACTOR, SUBCONTRACTORS OR ANY PERSONS PERFORMING ANY OF THE WORK OR FOR FAILURE OF ANY OF THOSE PARTIES TO CARRY OUT THE WORK IN CONFORMANCE WITH CONTRACT DOCUMENTS.

6. CUTTING & PATCHING: AVOID DAMAGING ADJACENT EXISTING WORK. REPAIR OR REPLACE AT NO COST TO OWNER ANY DAMAGE CAUSED BY CONSTRUCTION.

7. TEMPORARY SHORING: STRUCTURALLY BRACE AND SUPPORT ALL MATERIALS REQUIRING THE SAME FOR THE WORK TO OCCUR SAFELY AND IN COMPLIANCE WITH JURISDICTIONAL REGULATIONS.

CHANGES TO WORK & SUBMITTALS

I. CHANGES OR MODIFICATIONS TO THE WORK DURING CONSTRUCTION SHALL BE RECORDED WITH THE APPROPRIATE REGULATORY AGENCIES, AND APPROVALS FROM SUCH AGENCIES SHALL BE OBTAINED PRIOR TO MAKING SUCH CHANGES. REGULATORY AGENCIES SHALL BE NOTIFIED BY THE CONTRACTOR OF ALL SUCH CONSTRUCTION CONTRACT CHANGES AFTER PERMITS ARE ISSUED.

2. THE ARCHITECT SHALL BE INFORMED, IN WRITING, OF ALL CHANGES OR SUBSTITUTIONS MADE TO THESE PLANS AND SPECIFICATIONS. THE ARCHITECT SHALL HAVE NO IMPLIED OR ASSUMED RESPONSIBILITY FOR CHANGES IMPLEMENTED WITHOUT THE ARCHITECT'S PRIOR APPROVAL.

3. SHOP DRAWINGS: SHOP DRAWINGS ARE AN AID FOR FIELD PLACEMENT AND ARE SUPERSEDED BY THE ARCHITECTURAL DRAWINGS. IT SHALL BE THE RESPONSIBILITY OF THE GENERAL CONTRACTOR TO MAKE CERTAIN THAT ALL CONSTRUCTION IS IN FULL AGREEMENT WITH THE LATEST ARCHITECTURAL DRAWINGS. THE CONTRACTOR SHALL SUPPLY THE ARCHITECT/ENGINEER WITH A MINIMUM OF TWO (2) COPIES OF CHECKED SHOP DRAWINGS BEARING THE CONTRACTOR'S STAMP OF APPROVAL AND SIGNATURE, A MINIMUM OF THREE (3) WEEKS PRIOR TO FABRICATION. THE REVIEW OF SHOP DRAWINGS AND SPECIFICATIONS BY THE ARCHITECT/ENGINEER IS ONLY FOR GENERAL COMPLIANCE WITH THE ARCHITECTURAL AND/OR STRUCTURAL DRAWINGS AND SPECIFICATIONS. THIS REVIEW DOES NOT GUARANTEE IN ANY WAY THAT THE SHOP DRAWINGS ARE CORRECT, COMPLETE, NOR DOES IT INFER THAT THEY SUPERSEDE THE ARCHITECTURAL AND/OR STRUCTURAL DRAWINGS.

SUBSTITUTIONS: PROPRIETARY ARTICLES MAY BE SUBSTITUTED IF, IN THE OPINION OF THE ARCHITECT AND OWNER, THE MATERIAL OR ARTICLE IS EQUAL TO THAT SPECIFIED. REQUEST FOR SUBSTITUTIONS SHALL NOT DELAY WORK.CONTRACTOR SHALL COORDINATE ACCEPTED SUBSTITUTIONS WITHOUT ADDITIONAL COST TO OWNER. ALL SUBSTITUTIONS MUST HAVE WRITTEN PERMISSION. COLOR SAMPLES OF ALL MATERIALS THAT AFFECT THE AESTHETICS OF THE DESIGN MUST BE SUBMITTED. WHEN A MANUFACTURED PRODUCT IS NOT SPECIFIED, CONTRACTOR WILL UTILIZE THE HIGHEST QUALITY PRODUCT AVAILABLE ON THE MARKET IN THE MIDDLE PRICE RANGE. CONTRACTOR SHALL ON NO ACCOUNT USE LOWER-END PRODUCTS AT THE BOTTOM PRICE RANGE WHEN BETTER QUALITY PRODUCT IN THE MIDDLE PRICE RANGE EXISTS.

5. ONLY DRAWINGS, SPECIFICATIONS, ADDENDA AND CHANGE ORDERS BEARING APPROVAL OF OWNER SHALL BE USED IN THE EXECUTION OF WORK PERMITTED ON JOB SITE.

6. ADDENDA WILL BE ISSUED DURING BIDDING TO CLARIFY DRAWINGS (AND SPECIFICATIONS) AS REQUIRED. THESE WILL BECOME A PART OF THE CONTRACT - CONSULT ARCHITECT.

7 THERE SHALL BE NO DEVIATIONS WHATSOEVER FROM THE CONTRACT DOCUMENTS WITHOUT THE ARCHITECT'S WRITTEN APPROVAL THEREOF. THE CONTRACTOR AGREES TO DEFEND, INDEMNIFY AND HOLD THE ARCHITECT HARMLESS FROM ANY CLAIMS ARISING AS A RESULT OF UNAPPROVED CHANGES.

COMPLETION

ALL WORK SHALL BE CLEAN AND READY FOR USE UPON COMPLETION. EXPOSED AND SEMI-EXPOSED SURFACES BE DUSTED, MOPPED, WASHED, WIPED AND BUFFED AS NECESSARY TO LEAVE WORK IN A NEW, CLEAN, IMMACULATE CONDITION.

2. CONTRACTOR IS RESPONSIBLE FOR PROVIDING OWNER(S) WITH RECORD CONSTRUCTION/AS-BUILT SET OF DRAWINGS AND ALL WARRANTIES FOR PRODUCTS USED AFTER COMPLETION OF PROJECT.

SYMBOLS AND ARREVIATIONS

SI	MDULS	AINL	HODKE	VIF	VIIONS
<u>ABBREVIA</u>	ATION TERM:	ГГ	FINISH FLOOR	P.T.	PRESSURE TREATED
8	AND	F.FL. FIN.	FINISH FLOOR FINISH	PTD.	PAINTED
L @	ANGLE AT	FLR.	FLOOR	PTN.	PARTITION
		FLOUR.	FLUORESCENT	R.	RISER
A.B.	ANCHOR BOLTS	F.O.	FACE OF	R.D.	ROOF DRAIN
ABV.	ABOVE	F.O.F.	FACE OF FINISH	REF.	REFRIGERATOR
A.C.	AIR CONDITIONING	F.O.S.	FACE OF STUD	REG.	REGISTER
A.C.T.	ACOUSTICAL CEILING TILE	F.R.P.	FIBERGLASS REINFORCED PANEL	REG. REQ.	REQUIRED
ACOUS.	ACOUSTIC	F.S.E.C.	FOOD SERVICE EQUIPMENT	RM.	ROOM
ADJ.	ADJUSTABLE OR ADJACENT		CONTRACTOR	R.O.	ROUGH OPENING
A.F.FL.	ABOVE FINISHED	FTG.	FOOTING	R.S.	ROUGH SAWN
A.I .I L.	FLOOR	FT.	FOOT OR FEET	RWD.	REDWOOD
AL.	ALUMINUM	GA.	GAUGE	R.W.L.	RAIN WATER LEADER
ALT.	ALTERNATE	GALV G.F.R.C.	GALVANIZED GLASS FIBER	SCH.	SCHEDULE
A.P.	ACCESS PANEL	0.7 .74.6.	REINFORCED CONCRETE	SECT.	SECTION
APPL.	APPLIANCE	G.B.	GRAB BAR	S.F.	SQUARE FEET
APPROX.	APPROXIMATELY	G.C.	GENERAL	SH.	SHELF
ARCH.	ARCHITECT	GL.	CONTRACTOR GLASS	SHR.	SHOWER
BD.	BOARD	GL. GND.	GROUND	SHTG.	SHEATHING
BLDG.	BUILDING	G.S.M.	GALVANIZED	SHT.	SHEET
BLKG.	BLOCKING	0.147.5	SHEET METAL	SIM.	SIMILAR
ВМ.	BEAM	G.W.B. GYP.	GYPSUM WALL BOARD GYPSUM	SPEC.	SPECIFICATION
B.N.	BOUNDARY NAILING	G Т Р. Н.В.	HOSE BIBB	SQ.	SQUARE
вот.	BOTTOM	HDWD.	HARDWOOD	STD.	STANDARD
C.G.	CORNER GUARD	HDWR	HARDWARE	STD. STL.	STEEL
C.J.	CONTROL JOINT	HGT.	HEIGHT	S.S.	STAINLESS STEEL
C.L.	CENTER LINE	HORIZ.	HORIZONTAL	S.S.D.	SEE STRUCTURAL
CLG.	CEILING	HR. INSUL.	HOUR, HOURS INSULATION	S.S.D.	DRAWINGS
CLO.	CLOSET	INT.	INTERIOR	OTOD	
CLR.	CLEAR			STOR.	STORAGE
C.M.U.	CONCRETE MASONRY	JAN.	JANITOR	STR.	STRUCTURE
C.11.O.	UNIT	JT. K.E.C.	JOINT KITCHEN EQUIPMENT	SUSP.	SUSPENDED
CNTR.	COUNTER	N.E.C.	CONTRACTOR	S.W.	SHEAR WALL
COL.	COLUMN	KIT.	KITCHEN	T	TREAD
CONC.	CONCRETE	LAV.	LAVATORY	T.B.	TOWEL BAR
CONST.	CONSTRUCTION	MAX.	MAXIMUM	T.B.D.	TO BE DETERMINED
CONT.	CONTINUOUS	MECH. MIN.	MECHANICAL MINIMUM	TEMP.	TEMPERED
CPT.	CARPET	MISC.	MISCELLANEOUS	T.O.C.	TOP OF CURB
CTT.	CENTER	MTD.	MOUNTED	T&G	TONGUE AND GROOV
CTSK.	COUNTERSINK	MTL.	METAL	THK.	THICK
DBL.	DOUBLE	MTRL.	MATERIAL	T.N.	TOE NAIL
DK.F.	DRINKING FOUNTAIN	(N)	NEW	T.O.B.	TOP OF BEAM
UIV.1 .	DIVIDATIO I CONTAIN	(11)	1 V L V V	1.0.0.	

NOT IN CONTRACT

OVERFLOW DRAIN

OWNER SUPPLIED,

PERIMETER EDGE

PERPENDICULAR

PROPERTY LINE

PLASTIC LAMINATE

POUNDS PER SQUARE

POUNDS PER SQUARE

CONTRACTOR

INSTALLED

P.B.O. PROVIDED BY OWNER

PLATE

PLASTER

PLYWOOD

NOT TO SCALE

ON CENTER

OVERHEAD

NUMBER

NOMINAL

T.O.CONC. TOP OF CONCRETE

T.O.P. TOP OF PAVEMENT

T.O.PL. TOP OF PLATE

T.O.W. TOP OF WALL

U.N.O. UNLESS NOTED

OTHERWISE

WATER CLOSET

WATER HEATER

WATER PROOF

WATER RESISTANT

VERTICAL

V.I.F. VERIFY IN FIELD

WITH

WOOD

WINDOW

WITHIN

WITHOUT

WAINSCOT

DETAIL NO.

SHEET NO.

SHEET NO.

SHEET NO.

EQUIPMENT No.

- REVISION NO.

ROOM NO.

ROOM IDENTIFICATION

XXX

DRAWING NO.

DRAWING NO.

DETAIL REFERENCE

ELEVATION REFERENCE

SECTION REFERENCE

INTERIOR ELEV. NO.

INT. ELEV. REFERENCE

TYP. TYPICAL

VERT.

W/

W.H.

W.R.

N.I.C.

NO.

NOM.

N.T.S.

PLAS.

PLYWD.

P.LAM.

P.S.F.

P.S.I.

DIA.

DIM.

DISP.

DIST.

DN.

D.F.

DR.

DS

DTL.

DWG.

ELEC.

ELEV.

EMRGY

ENG.

E.P.

EQUIP.

F.F.

DIAMETER

DIMENSION

DISPENSER

DISTANCE

DOUGLAS FIR

DOWNSPOUT

ELECTRICAL

EMERGENCY

ENGINEERED

ELECTRICAL

EQUIPMENT

EQUAL

EXCEPT

EXTERIOR

PANELBOARD

FLOOR DRAIN

FOUNDATION FINISH TO FINISH

DOOR No.

WINDOW No.

SHEET NOTES

KEY NOTE

DATUM REFERENCE:

F.O.S. OR MASONRY

CENTERLINE

FACE OF FINISH (CLR./MINIMUM CLR.)

ALIGN FINISH SURFACES

FFI + FF2 CHANGE IN FINISH FLOOR MATERIALS

- SIGNAGE DETAIL NO.

SIGNAGE KEYNOTE

SHEAR WALL NUMBER SHEAR WALL REFERENCE

SIGNAGE SYMBOL

☐ ☐ ☐ ☐ EXISTING TO BE REMOVED

V///// NEW CONSTRUCTION

EXISTING CONSTRUCTION TO REMAIN

ELEVATION, WORK OR CONTROL

FINISH NOTE REFERENCE <u>DIMENSIONS</u>

XX WALL TYPE

FURNISHED BY OTHERS

DOWN

DOOR

DETAIL

EACH

DRAWING

DRAWING INDEX

ARCHITECTURAL

TI.I PROJECT TITLE SHEET

TI.2 CONSTRUCTION WASTE MANGEMENT PLAN

TI.3 NON-RESIDENTIAL CAL GREEN REQUIREMENTS

AI SITE PLAN

A2.0 EXISTING FLOOR PLAN

A2.1 PROPOSED FLOOR PLAN A3.0 ELEVATIONS

PROJECT TEAM

<u>ARCHITECT</u>

RUFF + ASSOCIATES INC. ARCHITECTURE & PLANNING RICHARD P. RUFF ARCHITECT C-11736 100 WEST STANDLEY ST., UKIAH, CA.95482 707-472-0525 FAX 707-472-0527

PROPOSED PARCEL DATA

...3 @ 36" MIN

LOCATION: · 1010 SANTA ROSA AVE SANTA ROSA, CA 95404 038-101-04 ZONING: C-2-P LOT SIZE: 18,359 S.F BUILDING AREA: 3,782 S.F. CODE ANALYSIS FI,BI. S2 OCCUPANCY TYPE: OCCUPANCY MAXIMUM: CONSTRUCTION TYPE:..

PROPERTY LINE CONSTRUCTION: PROPOSED (ALLOWED)

NORTH SETBACK: SOUTH SETBACK: EAST SIDE SETBACK. 66'0" WEST SIDE SETBACK:

NUMBER OF REQUIRED EXITS (130/49 TABLE 1015.1) ...

SITE SUPPORT DATA SANTA ROSA FIRE DEP SEWER CITY OF SANTA ROSA CITY OF SANTA ROSA WATER . ELECTRIC. PHONE. XXXCABLETV.....

VICINITY MAP



ERATIONS NAN M E K

|RUFF + ASSOCIATI

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CA License # C11736

B597217

 $\stackrel{\square}{\times}$ \triangleleft Z BUILDING \triangleleft \bigcirc $\bigcirc \vdash$ O A


SHEET TITLE


TITLE SHEET

DRAWN BY 4-16-18 SUBMITTED 4-16-18 CREATED SCALE AS NOTED PAGE

WEST ELEVATION

N.T.S.

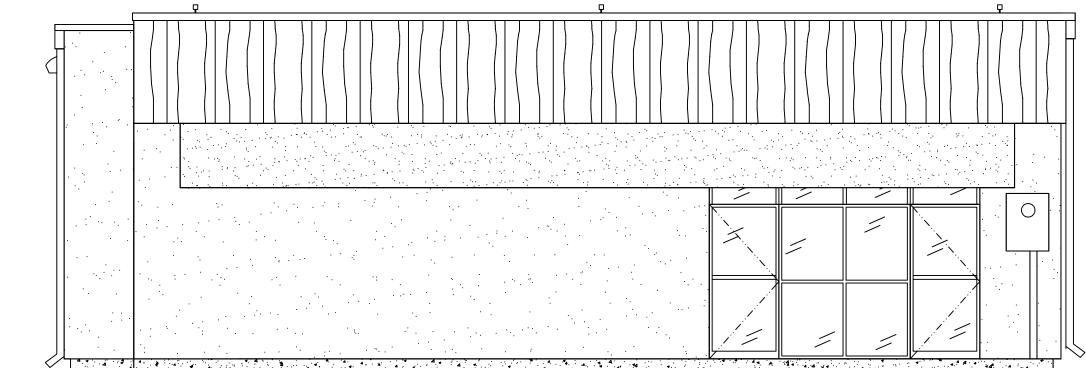

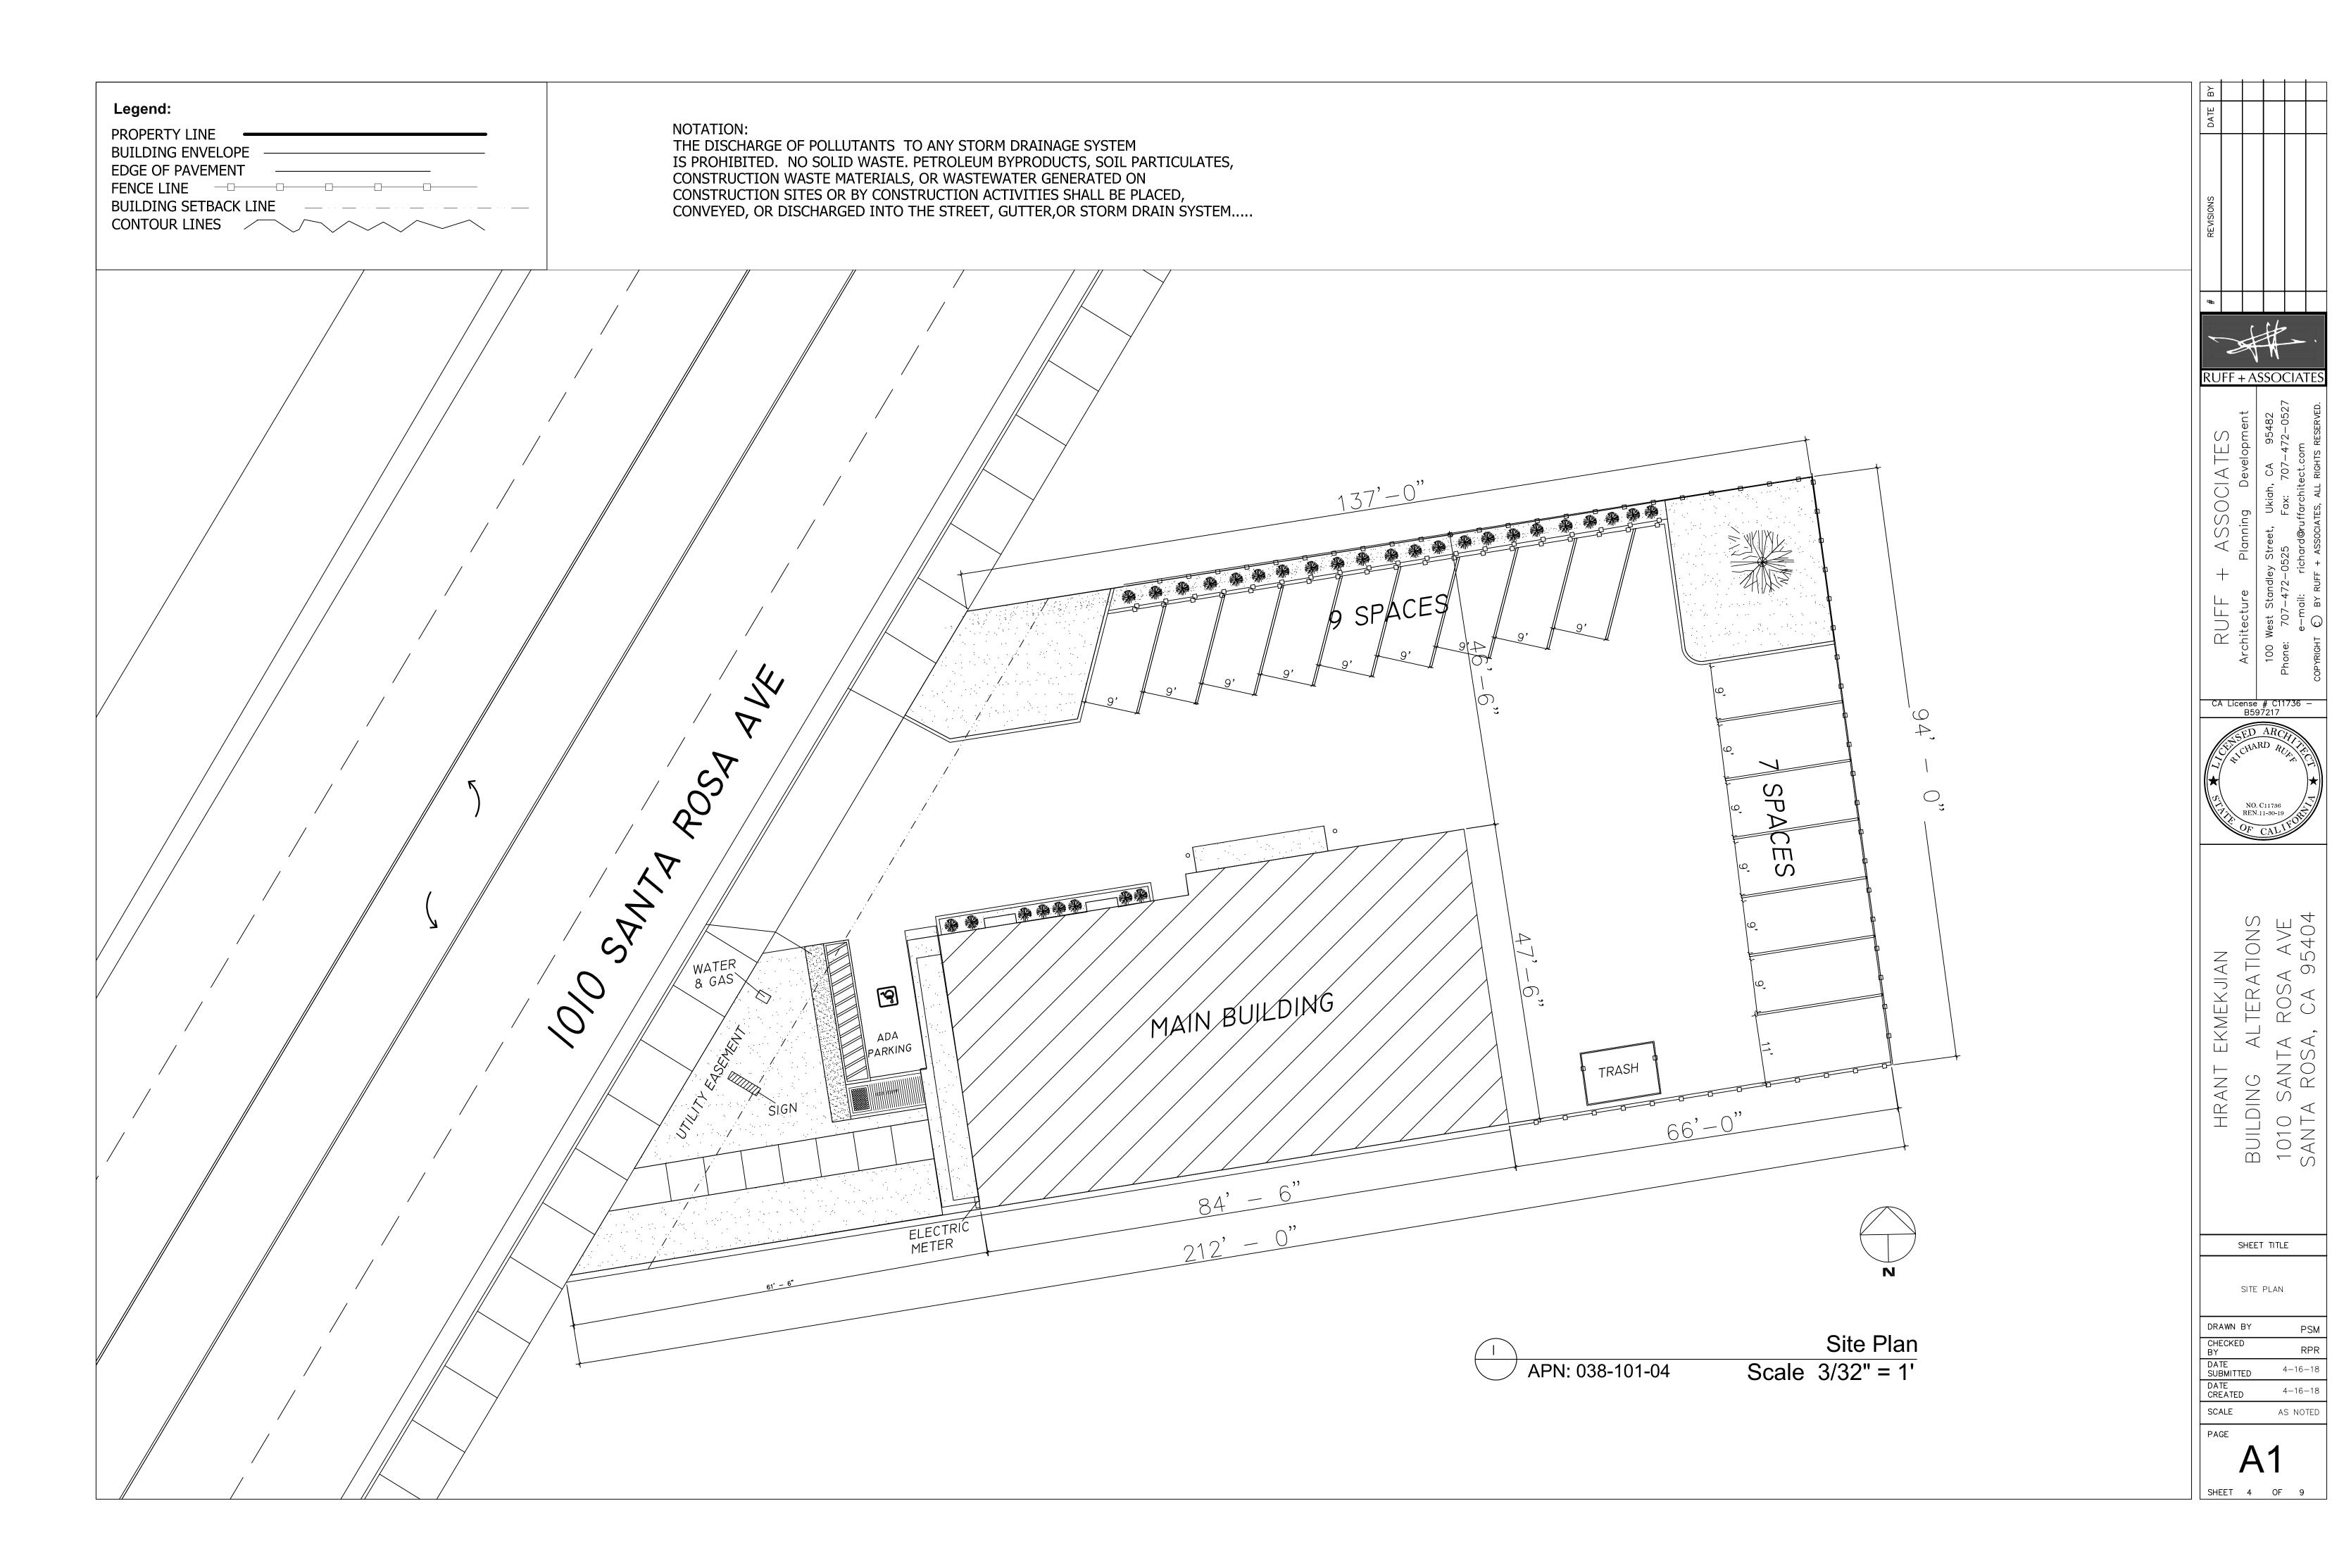

SQUARE FOOTAGE 3872	Door Schedule 101 - 3'0" x 6'8" - Exterior Glass Single Pane 102 - 3'0" x 6'8" - Exterior Metal Clad Solid Core Fire Rated 103 - 3'0" x 6'8" - Exterior Metal Clad Solid Core Fire Rated 104 - 3'0" x 6'8" - Exterior Metal Clad Solid Core Fire Rated 105 - 3'0" x 6'8" - Interior Wood Solid Core Lockable 106 - 3'0" x 6'8" - Interior Wood Solid Core Lockable Window Schedule 101 - 8'0" x 8'0" - 4 Pane Fixed Plate Glass 102 - 4'0" x 3'0" - Dual pane slider 103 - 4'0" x 4'0" - Dual Pane Slider	Note: ALL exterior glazing to meet the requirements of CRC Section R337 All exterior doors to meet the requirements of CRC Section R337.8.3 Door Opening Force. Fire doors shall have the minimum opening force allowable by the a administrative authority. The force for pushing or pulling doors other Fire Doors shall be as follows: 1. Interior hinged door 5.0 pounds (22.2 N) maximum 2.Sliding or Folding Door 5.0 pounds (22.2 N) maximum These forces do not apply to the force required to retract latch bolts or disengage other devices that hold the door in a closed position	Doors: These forces apply only to opening the door, not to the retract latch bolts or disengage other devices that may hold the A.Exterior Hinged Door 5 pounds B.Interior Hinged Door 5 pounds C. Sliding or Folding Doors 5 pounds Exception: Fire Doors shall have the minimum force allowable b Compensating Devices: Doors requiring greater force shall be excepted to the operating force or shall be equipped with automatic	e effort required to e door in a closed position. by the apropriate administrative authority equipped with compensating devices to	# REVISIONS DATE BY
	ACY - O" EXTERIOR GRILLED LIGHT NUMBER # UNITS' OFFICE STORAGE STORAGE RECENT LIGHTS NUMBER # UNITS' RECENT LIGHTS RECENT LIGHTS NUMBER # UNITS' RECENT LIGHTS NUMBER # UNITS' RECENT LIGHTS RECENT LIGHTS RECENT LIGHTS NUMBER # UNITS' RECENT LIGHTS RECENT LIGHT	STORAGE STORAGE STORAGE	WAREHOUSE WAREHOUSE RETAIL	HPIT GETTIND WORBELKE WORBELKE 23'-4" 47'-0"	HRANT EKMEKUIAN BUILDING ALTERATIONS 1010 SANTA ROSA AVE SANTA ROSA, CA 95404 SANTA ROSA, CA 95404
		84'-6"			EXISTING FLOOR PLAN DRAWN BY PSM CHECKED BY RPR
		Existing Floor Plan Scale 1/4" = 1'			DATE SUBMITTED 4-16-18 DATE CREATED 4-16-18 SCALE AS NOTED PAGE A2.0 SHEET 5 OF 9

SQUARE FOOTAGE TOTAL SQUARE FOOTAGE OCCUPANCY SQARE FOOTAGE MERCHANTILE SQ FT BUSINESS SQ FT STORAGE / PROCESS SQ FT MAXIMUM OCCUPANCY LOAD	SQ FT 3872 1520 712 1640 3872	@ 60 100 300	MOL 25.3 7.12 5.4 37	Door Schedule 101 - 3'0" x 6'8" - Exterior Glass Single Pane Retail Entry 115 - 3'0" x 6'8" - Interior Commercial Grade 2 Hour Fire Rated 102 - 3'0" x 6'8" - Exterior Glass Single Pane Retail Entry 103 - 3'0" x 6'8" - Exterior Metal Clad Solid Core Fire Rated Card Entry 104 - 3'0" x 6'8" - Exterior Metal Clad Solid Core Fire Rated Card Entry 105 - 3'0" x 6'8" - Interior Commercial Grade 2 Hour Fire Rated 107 - 3'0" x 6'8" - Interior Commercial Grade Card Entry 108 - 3'0" x 6'8" - Interior Commercial Grade Card Entry 109 - 3'0" x 6'8" - Interior Commercial Grade Lockable 109 - 3'0" x 6'8" - Interior Commercial Grade Lockable 109 - 3'0" x 6'8" - Interior Commercial Grade Lockable 109 - 3'0" x 6'8" - Interior Commercial Grade Lockable 100 - 3'0" x 6'8" - Interior Commercial Grade Lockable 101 - 8'0" x 8'0" - 4 Pane Fixed Plate Glass 102 - 4'0" x 3'0" - Dual Pane Slider 103 - 4'0" x 3'0" - Dual Pane Slider 103 - 4'0" x 4'0" - Dual Pane Slider 104 - 4'0" x 4'0" - Dual Pane Slider 105 - 4'0" x 4'0" - Dual Pane Slider 106 - 3'0" x 6'8" - Interior Commercial Grade Lockable 119 - 3'0" x 6'8" - Interior Commercial Grade Lockable 119 - 3'0" x 6'8" - Interior Commercial Grade Lockable 120 - 3'0" x 6'8" - Interior Commercial Grade Lockable 121 - 3'0" x 6'8" - Interior Commercial Grade Lockable 122 - 3'0" x 6'8" - Interior Commercial Grade Lockable 123 - 3'0" x 6'8" - Interior Commercial Grade Lockable 124 - 2'6" x 6'8" - Interior Commercial Grade Lockable 125 - 3'0" x 6'8" - Interior Commercial Grade Lockable 126 - 3'0" x 6'8" - Interior Self Closing Air Lock Transfer Room Style 127 - 3'0" x 6'8" - Interior Commercial Grade Card Entry 128 - 3'0" x 6'8" - Interior Self Closing Air Lock Transfer Room Style 130 - X 6'8" - Interior Commercial Grade Card Entry 140 - X 6'8" - Interior Commercial Grade Card Entry 150 - X 6'8" - Interior Commercial Grade Card Entry 150 - X 6'8" - Interior Commercial Grade Card Entry 150 - X 6'8" - Interior Commercial Grade Card Entry 150 - X 6'8" - Interior Commercial Grade Card Entry 150 - X 6'8"	# REVISIONS DATE BY
				84'-6"	RNED + ASSOCIATES
WALKWAY	9' -0' ARAMP PER FOOTS	" IN	OURESCENT UN	STANDAY OF THE PROPERTY OF THE	HRANT EKMEKUIAN HRANT EKMEKUIAN BUILDING ALTERATIONS Architecture Planning Developme Architectu
				Proposed Floor Plan Scale 1/4" = 1'	A2.1

SHEET 5 OF 9

