TENANT IMPROVEMENTS BEAR FLAG SUPPLY, INC.

ABBREVIATIONS

| @ AB ACC ADJ ADO AFF ALT ALUM AP APPROX ARCH ASTM | AT ANCHOR BOLT ACCESSIBLE ACQUSTICAL CEILING TILE ADJACENT, ADJUSTABLE AUTOMATIC DOOR OPENER ABOVE FINISHED FLOOR ALTERNATIVE ALUMINUM ACCESS PANEL APPROXIMATE ARCHITECTURAL AMERICAN SOCIETY FOR TESTING AND MATERIALS |
|---|---|
| BD BLDG BOT | BOARD BUILDING BOTTOM |
| CAB CANT CBC CFCI CFOI CL CLG CLR CNTR COL CONC CONN CONT CPT CUP CRC CTR | CABINET CANTILEVERED CAPACITY CALIFORNIA BUILDING CODE CONTRACTOR-FURNISHED, CONTRACTOR-INSTALLED CONTRACTOR-FURNISHED, OWNER-INSTALLED CENTER LINE CEILING CLEAR COUNTER COUNTER COLUMN CONCRETE CONNECTION CONNECTION CONTINUOUS CARPET CENTRAL UTILITY PLANT COLD ROLLED CHANNEL CENTER |
| DBL DEMO DET DF DH DIA, Ø DIM DN DWG | |
| ELEV EMBED EP EQ EQPT ESR EXH | ELECTRIC ELEVATOR EMBEDMENT, EMBEDDED ELECTRICAL PANEL EQUIAL EQUIPMENT EVALUATION SERVICE REPORT EXHAUST EXPANSION |
| FD FE FFC FHS FIN FL FO FP FS FT | FLAT HEAD SCREWS FINISH FLOOR |
| GA GALV GB GEN GFCI GL GR GYP | GAUGE GALVANIZED GYPSUM BOARD GENERAL GROUND FAULT CIRCUIT INTERRUPT GLASS GRADE GYPSUM |
| hmf hnom horiz | HOLLOW METAL FRAME NOMINAL EMBEDMENT DEPTH HORIZONTAL |
| icc In Insul Int | INTERNATIONAL CODE COUNCIL INCH(ES) INSULATION INTERIOR |
| JT | JOINTS |
| KD | KNOCK DOWN |

| | | G | SEN |
|--|---|-----|--|
| LAM LB | LAMINATE POUND | 1. | GENERAL |
| LBS # LT | POUNDS POUND(S) LIGHT | 2. | WORK SH GOVERNII |
| MACH | MACHINE | 3. | OBTAIN R |
| MAX MB MECH MET MFR MIN MIR | MAXIMUM MACHINE BOLT MECHANICAL METAL MANUFACTURER MINIMUM MIRROR | 4. | THE EXIST GUARANT AND CON IMMEDIAT TO COMM |
| MISC MTD | MISCELLANEOUS MOUNTED | 5. | PROTECT RESPONS ACTIVITIE |
| (N) N/A | NEW NOT APPLICABLE | 6. | LIMIT THE PROJECT |
| NIC NO., # NTS OC OD OFCI OFOI OH OPNG | NOT IN CONTRACT NUMBER NOT TO SCALE ON CENTER OUTSIDE DIAMETER OWNER-FURNISHED, CONTRACTOR-INSTALLED OWNER-FURNISHED, OWNER-INSTALLED OPPOSITE HAND OPENING | 7. | ALLOW O' ENTIRE CO OWNER D CONTINUO MAINTAIN SERVING INTERRUF OWNER'S |
| PA PARTN PLAM PLF PLBG | OPPOSITE PROJECT AUTHORIZATION PARTITION PLASTIC LAMINATE POUNDS PER LINEAR FOOT PLUMBING | 8. | SECURE 1 PROPERT TEMPORA FACILITY. MEASURE MEMBERS |
| POT PT PTD | PATH OF TRAVEL PAINT PAPER TOWEL DISPENSER | 9. | deliver, Loss, inc Storing |
| QTY | QUANTITY | 10. | DO NOT U MATERIAL WORK ON |
| RAD RB RCP RECEPT REF REINF REQD | REFERENCE REINFORCE, REINFORCEMENT REQUIRED | 11. | MAINTAIN DISPOSE AND DEBF LESS THA AREAS AF |
| REV RM R0 | REVISE, REVISION ROOM ROUGH OPENING | 12. | immediat Allowed Material |
| SC SCHED SD | SMOKE COMPARTMENT SCHEDULE SOAP DISPENSER | 13. | CONSTRU RESPONS |
| SECT SEOR SQ. FT. SHT SIM | SQUARE FOOT, SQUARE FEET SHEET SIMILAR | 14. | INSTALL \ PROPERL THAT IS D ACCEPTA |
| SM SPEC SPKR | SHEET METAL SPECIFICATIONS SPEAKER | 15. | DO NOT S |
| SPR SQ SSD | SPRINKLER SQUARE | 16. | DRAWING RESPONS |
| SST ST STD STL STOR | | 17. | PROVIDE MATERIAI ARCHITEC ADEQUAT PER PROD ORIGINAL COMPARA WHEN RE |
| THK T/O TOL | THICK TOP OF TOLERANCE | 18. | SHOULD T MATERIAL |
| ТҮР | | 19. | ALL CONE |
| UC UON UT | UNDER CABINET/COUNTER UNLESS OTHERWISE NOTED UTILITY | 20. | A FIRE WA |
| VCT VER VERT VIF VM VOC | VINYL COMPOSITE TILE VERIFY VERTICAL VERIFY IN FIELD VENDING MACHINE VOLATILE ORGANIC COMPOUNDS | | |
| W/ W/O WI WP WT | WITH WITHOUT WOODWORK INSTITUTE WATERPROOF, WATERPROOFING WEIGHT | | |
| | | | |

GENERAL NOTE

- L NOTES APPLY TO ALL DRAWINGS, UNLESS SPECIFICALLY NOTED OTHERWISE. SHALL COMPLY WITH THE PROJECT DOCUN VING AGENCIES HAVING JURISDICTION.
- REQUIRED PERMITS FROM THE AGENCY HAVING JURISDICTION. OWNER WILL PAY FOR REQUIRED PERMITS.
- STENCE AND LOCATION OF UNDERGROUND UTILITIES AND CONSTRUCTION INDICATED AS EXISTING ARE NOT ITEED. EXAMINE THE SITE, INVESTIGATE AND VERIFY THE EXISTENCE AND LOCATION OF UNDERGROUND UTILITIES INSTRUCTION. COMPARE EXISTING CONDITIONS TO THE PROJECT DOCUMENTS PRIOR TO COMMENCING WORK. ATELY NOTIFY THE ARCHITECT IN WRITING OF ANY DISCREPANCIES AND OBTAIN CLARIFICATION/DECISION PRIOR IMENCING AFFECTED WORK
- EXISTING FACILITIES FROM DAMAGE DUE TO CONSTRUCTION ACTIVITIES. CONTRACTOR IS SOLELY ISIBLE FOR COSTS AND REPAIR OF DAMAGED PROPERTY TO EXISTING CONDITIONS CAUSED BY CONSTRUCTION
- HE USE OF PREMISES TO AREAS WITHIN THE CONTRACT LIMITS INDICATED. DO NOT DISTURB PORTIONS OF THE T SITE BEYOND AREAS WITHIN THE CONTRACT LIMITS.
- OWNER OCCUPANCY AND PUBLIC USE OF THE PROJECT SITE. OWNER WILL OCCUPY THE PREMISES DURING TH CONSTRUCTION PERIOD. WITH THE EXCEPTION OF THE AREAS UNDER CONSTRUCTION. COOPERATE WITH THE DURING CONSTRUCTION TO MINIMIZE CONFLICTS, NOISE, MALODOROUS FUMES AND FACILITATE THE OWNER'S UOUS USE OF THE FACILITY PERFORM THE WORK WITHOUT THE INTERFERENCE TO THE OWNER'S OPERATIONS N EXISTING EXITS AND ACCESS WAYS FREE OF ENCUMBRANCES. DO NOT INTERRUPT EXISTING UTILITIES OWNER'S FACILITIES WITHOUT PRIOR WRITTEN APPROVAL BY THE OWNER, PROVIDE WRITTEN REQUEST FOR JPTION 48 HOURS MINIMUM IN ADVANCE OF REQUESTED INTERRUPTION. DELIVER WRITTEN REQUEST TO THE 'S ON-SITE DIRECTOR OF FACILITIES AND OPERATIONS.
- E THE WORK AREA AND PROVIDE SAFETY MEASURES TO PREVENT INJURY TO PERSONS OR DAMAGE TO RTY ON-SITE, OFF-SITE OR DURING CONSTRUCTION RELATED TO THE WORK, PROVIDE PROTECTION DEVICES. ARY BARRIERS AND ENCLOSURES AS NECESSARY TO PERFORM THE WORK AND ALLOW OWNER'S USE OF THE COMPLY WITH SAFETY REQUIREMENTS OF THE GOVERNING AGENCIES HAVING JURISDICTION. SAFETY RES ARE SOLELY THE CONTRACTOR'S RESPONSIBILITY. SITE VISIT OBSERVATIONS BY THE DESIGN TEAM RS OR THE OWNER DO NOT INCLUDE REVIEW OF THE CONTRACTOR'S SAFETY MEASURES.
- , STORE AND HANDLE PRODUCTS USING MEANS AND METHODS THAT PREVENT DAMAGE, DETERIORATION AND VCLUDING THEFT. COMPLY WITH THE MATERIAL MANUFACTURER'S WRITTEN INSTRUCTIONS FOR HANDLING, AND PROTECTING MATERIALS.
- USE PRODUCTS CONTAINING ASBESTOS. WHEN DISCOVERING EXISTING MATERIALS CONTAINING HAZARDOUS ALS. IMMEDIATELY NOTIFY THE OWNER IN WRITING AND OBTAIN DECISION/DIRECTION REFORE PROCEEDING TO ON THE AFFECTED AREA.
- N PROJECT SITE FREE OF WASTE MATERIALS AND DEBRIS. PROVIDE APPROPRIATE WASTE CONTAINERS AND E OF WASTE LEGALLY ACCORDING TO REGULATION OF AUTHORITIES HAVING JURISDICTION. CLEAN DUST, DIRT BRIS CAUSED BY CONSTRUCTION ACTIVITIES FROM PAVEMENTS ON-SITE AND OFF-SITE AS NECESSARY. BUT NO HAN 1 TIME PER WEEK. COMPLY WITH AGENCIES HAVING JURISDICTION REQUIREMENTS FOR CLEANING OFF-SITE AFFECTED BY CONSTRUCTION ACTIVITIES.
- RUCTION FIELD ENGINEERING, SURVEYING, LAYOUT AND COORDINATION ARE SOLELY THE CONTRACTOR'S **ISIBII ITY**
- WORK PLUMB, LEVEL, ALIGN AND PLACE ACCURATELY. TEST AND ADJUST INSTALLED WORK TO FUNCTION RLY. PROTECT INSTALLED WORK FROM DAMAGE PRIOR TO OWNER'S ACCEPTANCE. REPAIR INSTALLED WORK DAMAGED PRIOR TO OWNER'S ACCEPTANCE. COST FOR REPAIR OF WORK DAMAGED PRIOR TO OWNER'S ANCE IS SOLELY THE CONTRACTOR'S RESPONSIBILITY.
- SCALE FROM DRAWINGS.
- IGS ARE BASED ON DOCUMENTS AND REPORTS OBTAINED FROM THE OWNER. THE ARCHITECT ASSUMES NO SIBILITY FOR THE ACCURACY OF THE OWNER'S DOCUMENTS OR REPORTS PROVIDED.
- PRODUCTS AND MATERIALS SPECIFIED. CONTRACTOR MAY REQUEST SUBSTITUTION OF PRODUCTS AND ALS FOR COMPARABLE QUALITY AND PERFORMANCE. SUBSTITUTION REQUESTS MUST BE SUBMITTED TO THE ECT FOR REVIEW AND ACCEPTANCE. SUBMIT SUBSTITUTION REQUESTS IN A TIMELY MANNER TO ALLOW ATE TIME FOR THE ARCHITECT TO REVIEW. ARCHITECT WILL REVIEW NO MORE THAN 1 SUBSTITUTION REQUEST ODUCT MATERIAL. SUBSTITUTIONS SUBMITTED LATE WILL NOT BE REVIEWED BY THE ARCHITECT. INSTEAD. THE L SPECIFIED PRODUCT/MATERIAL WILL BE PROVIDED BY CONTRACTOR. ARCHITECT'S DECISION REGARDING RABLE QUALITY OF REQUESTED SUBSTITUTION IS CONSIDERED FINAL. PROVIDE SPECIFIED PRODUCT/MATERIAL EQUESTED SUBSTITUTION IS REJECTED BY THE ARCHITECT.
- THE CONTRACTOR ENCOUNTER THE PRESENCE, OR POSSIBLE PRESENCE, OF POTENTIALLY HAZARDOUS ALS, THE CONTRACTOR SHALL NOTIFY THE OWNER FOR INSTRUCTIONS PRIOR TO CONTINUING WORK.
- NDUITS AND PIPING SHALL BE CONCEALED UNLESS OTHERWISE NOTED.
- NATCH SHALL BE PROVIDED DURING AND AFTER ANY WELDING OPERATION AS REQUIRED PER CFC 3304. ACTOR SHALL OBTAIN APPROVAL FROM FIELD FIRE MARSHALL PRIOR TO START OF WORK.

ACCESSIBILITY

950 PINER RD SANTA ROSA, CA 95403


| С | | |
|---|---|--|
| Ĵ |) | |
| | | |

SYMBOLS

| MENTS | AND | WITH | APPL | ICABL | e la | WS, | CODES | S AND | ORDI | NANCES | 0F | TH |
|-------|-----|------|------|-------|------|-----|-------|-------|------|--------|----|----|
| | | | | | | | | | | | | |


ATELY REMOVE DEMOLITION MATERIALS FROM SITE. STORAGE OF DEMOLITION MATERIALS ON SITE WILL NOT BE ED. COMPLY WITH THE GOVERNING AGENCY REQUIREMENTS FOR REMOVAL AND DISPOSAL OF DEMOLITION


| STIMBC | JLS |
|-------------------|-------------------------------|
| TAGS AND SYMBOLS | |
| 0.5 | STRUCTURAL GRID IDENTIFIER |
| A3 | PARTITION TAG (TYPE) |
| <u><204A</u> > | DOOR TAG (SEQUENCE) |
| B8 | WINDOW TAG (TYPE) |
| A | CEILING TAG (TYPE) |
| A 8'-0") | CEILING TAG (TYPE AND HEIGHT) |
| LA | LIGHTING FIXTURE TAG (TYPE) |
| WCA | PLUMBING FIXTURE TAG (TYPE) |
| ? | MATERIAL TAG |
| G | SIGNAGE TAG (TYPE) |
| (EM1) | EQUIPMENT TAG |
| <u> </u> | FURNITURE TAG |
| | PLANTING TAG |
| /# \ | REVISION TAG |
| | REFERENCE KEYNOTE |
| | REFERENCE KEYNOTE |
| #> | SHEET KEYNOTE |
| XX | ACCESSIBLE FEATURE (SEE LEGEN |
| Æ | CENTERLINE |
| \bigcirc | NORTH ARROW |
| _ | |
| CASEWORK TAG | |
| | -W.I. MODEL NUMBER |

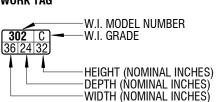



| R <u>oom nam</u> e | |
|--------------------------------|--------------|
| 1204 - | -ROOM NUMBER |

ROOM TAGS

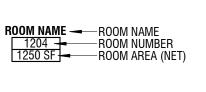

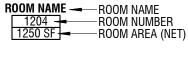

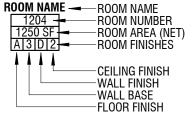


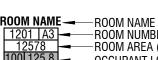


1201 A3 - ROOM NUMBER / OCCUPANCY GROUP 12578 - ROOM AREA (NET) 100125.8 - OCCUPANT LOAD FACTOR / OCCUPANT LOAD 2000 62.9 - OCCUPANT LOAD 1 2) (CBC TABLE 1004.1.2) OCCUPANT LOAD FACTOR / OCCUPANT LOAD (CPC TABLE A)


CUMULATIVE OCCUPANT LOAD


(150) - OCCUPANT LOAD (CBC 1004.1.2)

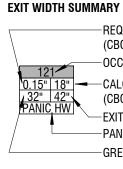


-REQUIRED EXIT WIDTH PER OCCUPANT (CBC 1005.3) -OCCUPANT LOAD (CBC 1004.1.2) (CBC 1005.3) -EXIT WIDTH PROVIDED - PANIC HARDWARE REQUIRED (CBC 1010.1.10) -GREATEST REQUIRED EXIT WIDTH

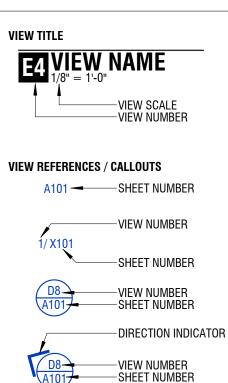


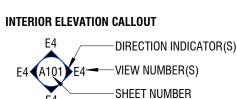

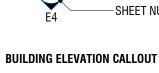

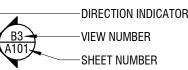


-VIEW NUMBER -SHEET NUMBER

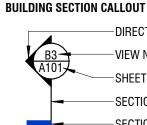

-DIRECTION INDICATOR -VIEW NUMBER -SHEET NUMBER -SECTION CUT LINE -SECTION TAIL

WALL SECTION CALLOUT

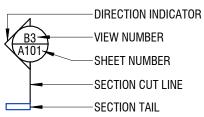

-SECTION CUT LINE -SECTION TAIL DETAIL CALLOUT

| NUMB |
|--------|
| NUM |
| L CUT |
| L TAIL |
| L CU |

BER ЛBER T LINE

EXISTING BUILDING DATA

| PROJECT LOCATION |
|------------------------|
| ASSESSOR PARCEL NUMBER |
| L OT SIZE |
| ZONING |
| OCCUPANCY |
| |
| GROSS BUILDING AREA |
| GROSS PROJECT AREA |
| NET PROJECT AREA |
| CONSTRUCTION |
| FIRE SPRINKLER |
| YEAR CONSTRUCTED |
| NUMBER OF FLOORS |
| FLOOR AREA CHANGE |
| PARKING |
| |

APPLICABLE CODES

BUILDING CODES AND STANDARDS TITLE 24, PART 1

2016 CALIFORNIA BUILDING CODE (CBC). CALIFORNIA CODE OF REGULATIONS, TITLE 24, PART 2. BASED ON 2015 INTERNATIONAL BUILDING CODE (IBC). 2016 CALIFORNIA BUILDING CODE (CBC) APPENDIX CHAPTER 1 105.3. 2016 CALIFORNIA RESIDENTIAL CODE (CRC). CALIFORNIA CODE OF REGULATIONS, TITLE 24 PART 2.5. BASED ON THE 2015 INTERNATIONAL RESIDENTIAL CODE (IRC)

2016 CALIFORNIA ELECTRICAL CODE (CEC), CALIFORNIA CODE OF REGULATIONS, TITLE 24. PART 3. BASED ON 2014 NATIONAL ELECTRICAL CODE (NEC) 2016 CALIFORNIA MECHANICAL CODE (CMC). CALIFORNIA CODE OF REGULATIONS, TITLE 24, PART 4. BASED ON 2015 UNIFORM MECHANICAL CODE (UMC). 2016 CALIFORNIA PLUMBING CODE (CPC). CALIFORNIA CODE OF REGULATIONS, TITLE 24, PART 5. BASED ON 2015 UNTERNATIONAL PLUMBING CODE (UPC). 2016 CALIFORNIA ENERGY CODE. CALIFORNIA CODE OF REGULATIONS, TITLE 24, PART 6. 2016 CALIFORNIA FIRE CODE (CFC) CALIFORNIA CODE OF REGULATIONS, TITLE 24, PART 9. BASED ON 2015 INTERNATIONAL FIRE CODE (IFC).

2016 CALIFORNIA GREEN BUILDING STANDARDS CODE (CALGreen). CALIFORNIA CODE OF REGULATIONS, TITLE 24, PART 11.

TITLE 24, PART 12.

NATIONAL REFERENCE STANDARDS NFPA 13, 2016 EDITION, INSTALLATION OF AUTOMATIC SPRINKLER SYSTEMS

NFPA 72, 2016 EDITION, NATIONAL FIRE ALARM CODE ADA (AMERICANS WITH DISABILITIES ACT, 1990)





1653 FINLAW ST. SANTA ROSA, CA 95404 TEL: 707.478.4949

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950 PINER ROAD, SANTA ROSA, CA 015-680-020

0.87 ACRES F-1, M, S-1 20,000 SF 10.000 SF

IL

V-B

1968

NONE

9,469 SF

YES, WILL BE INSTALLED AS PART OF THIS PROJECT

NO CHANGE

2016 CALIFORNIA ADMINISTRATIVE CODE (CAC). CALIFORNIA CODE OF REGULATIONS (CCR)

2016 CALIFORNIA REFERENCED STANDARDS CODE. CALIFORNIA CODE OF REGULATIONS,

SHEET INDEX

ARCHITECTURAL CUP1 TITLE SHEET CUP2 CONTEXT MAP CUP3 SITE PLAN CUP4 FLOOR PLAN CUP5 EXISTING ELEVATIONS CUP6 PROPOSED ELEVATIONS TOTAL: 6

SUMMARY OF WORK

INTERIOR TENANT IMPROVEMENT INSTALLATION OF NEW AUTOMATIC FIRE SPRINKLER SYSTEM

PROJECT TEAM

PROPERTY OWNER CHARLES EVANS (707) 321-7800 CHASEVANS3@GMAIL.COM

CONTRACTOR

STRUCTURAL ENGINEER MKM & ASSOCIATES 5880 COMMERCE BLVD. ROHNERT PARK, CA 94928 JOSH WALLACE (707) 578-8185 JOSH@MKMASSOCIATES.COM

<u>Electrical engineer</u> BROKAW DESIGN 6060 DAWN DR ROHNERT PARK, CA 94928 COURTNEY CHUENYANE (707) 799-6822 COURTNEY.CHUENYANE@BROKAWDESIGN.COM FESC@COMCAST.NET

CLIENT / TENANT CANNA BERRY FARMS FINLEY AVE. SANTA ROSA, CA 95407 AMOS FLINT (707) 696-4800 FLINTGE@GMAIL.COM

<u>Architect</u> SCHWARTZ ARCHITECTURE MIKE SCHWARTZ (707) 478-4949 MSCHWARTZ.ARCH@GMAIL.COM


MECHANICAL ENGINEER WARNER MECHANICAL ENGINEERING JEFF WARNER (707) 322-0676 JWARNER@WME-CONSULTING.COM

FIRE AND EMERGENCY SERVICES CONSULTANT FIRE AND EMERGENCY SERVICES CONSULTING 703 2ND ST., STE 354 SANTA ROSA, CA 95404 BRIAN ELLIOT (707) 757-8205

DEFERRED APPROVALS

1. FIRE SPRINKLERS

TITLE SHEET Project No.: 17-045 Drawn By: S/A Issue Date: 6/5/2018 Sheet

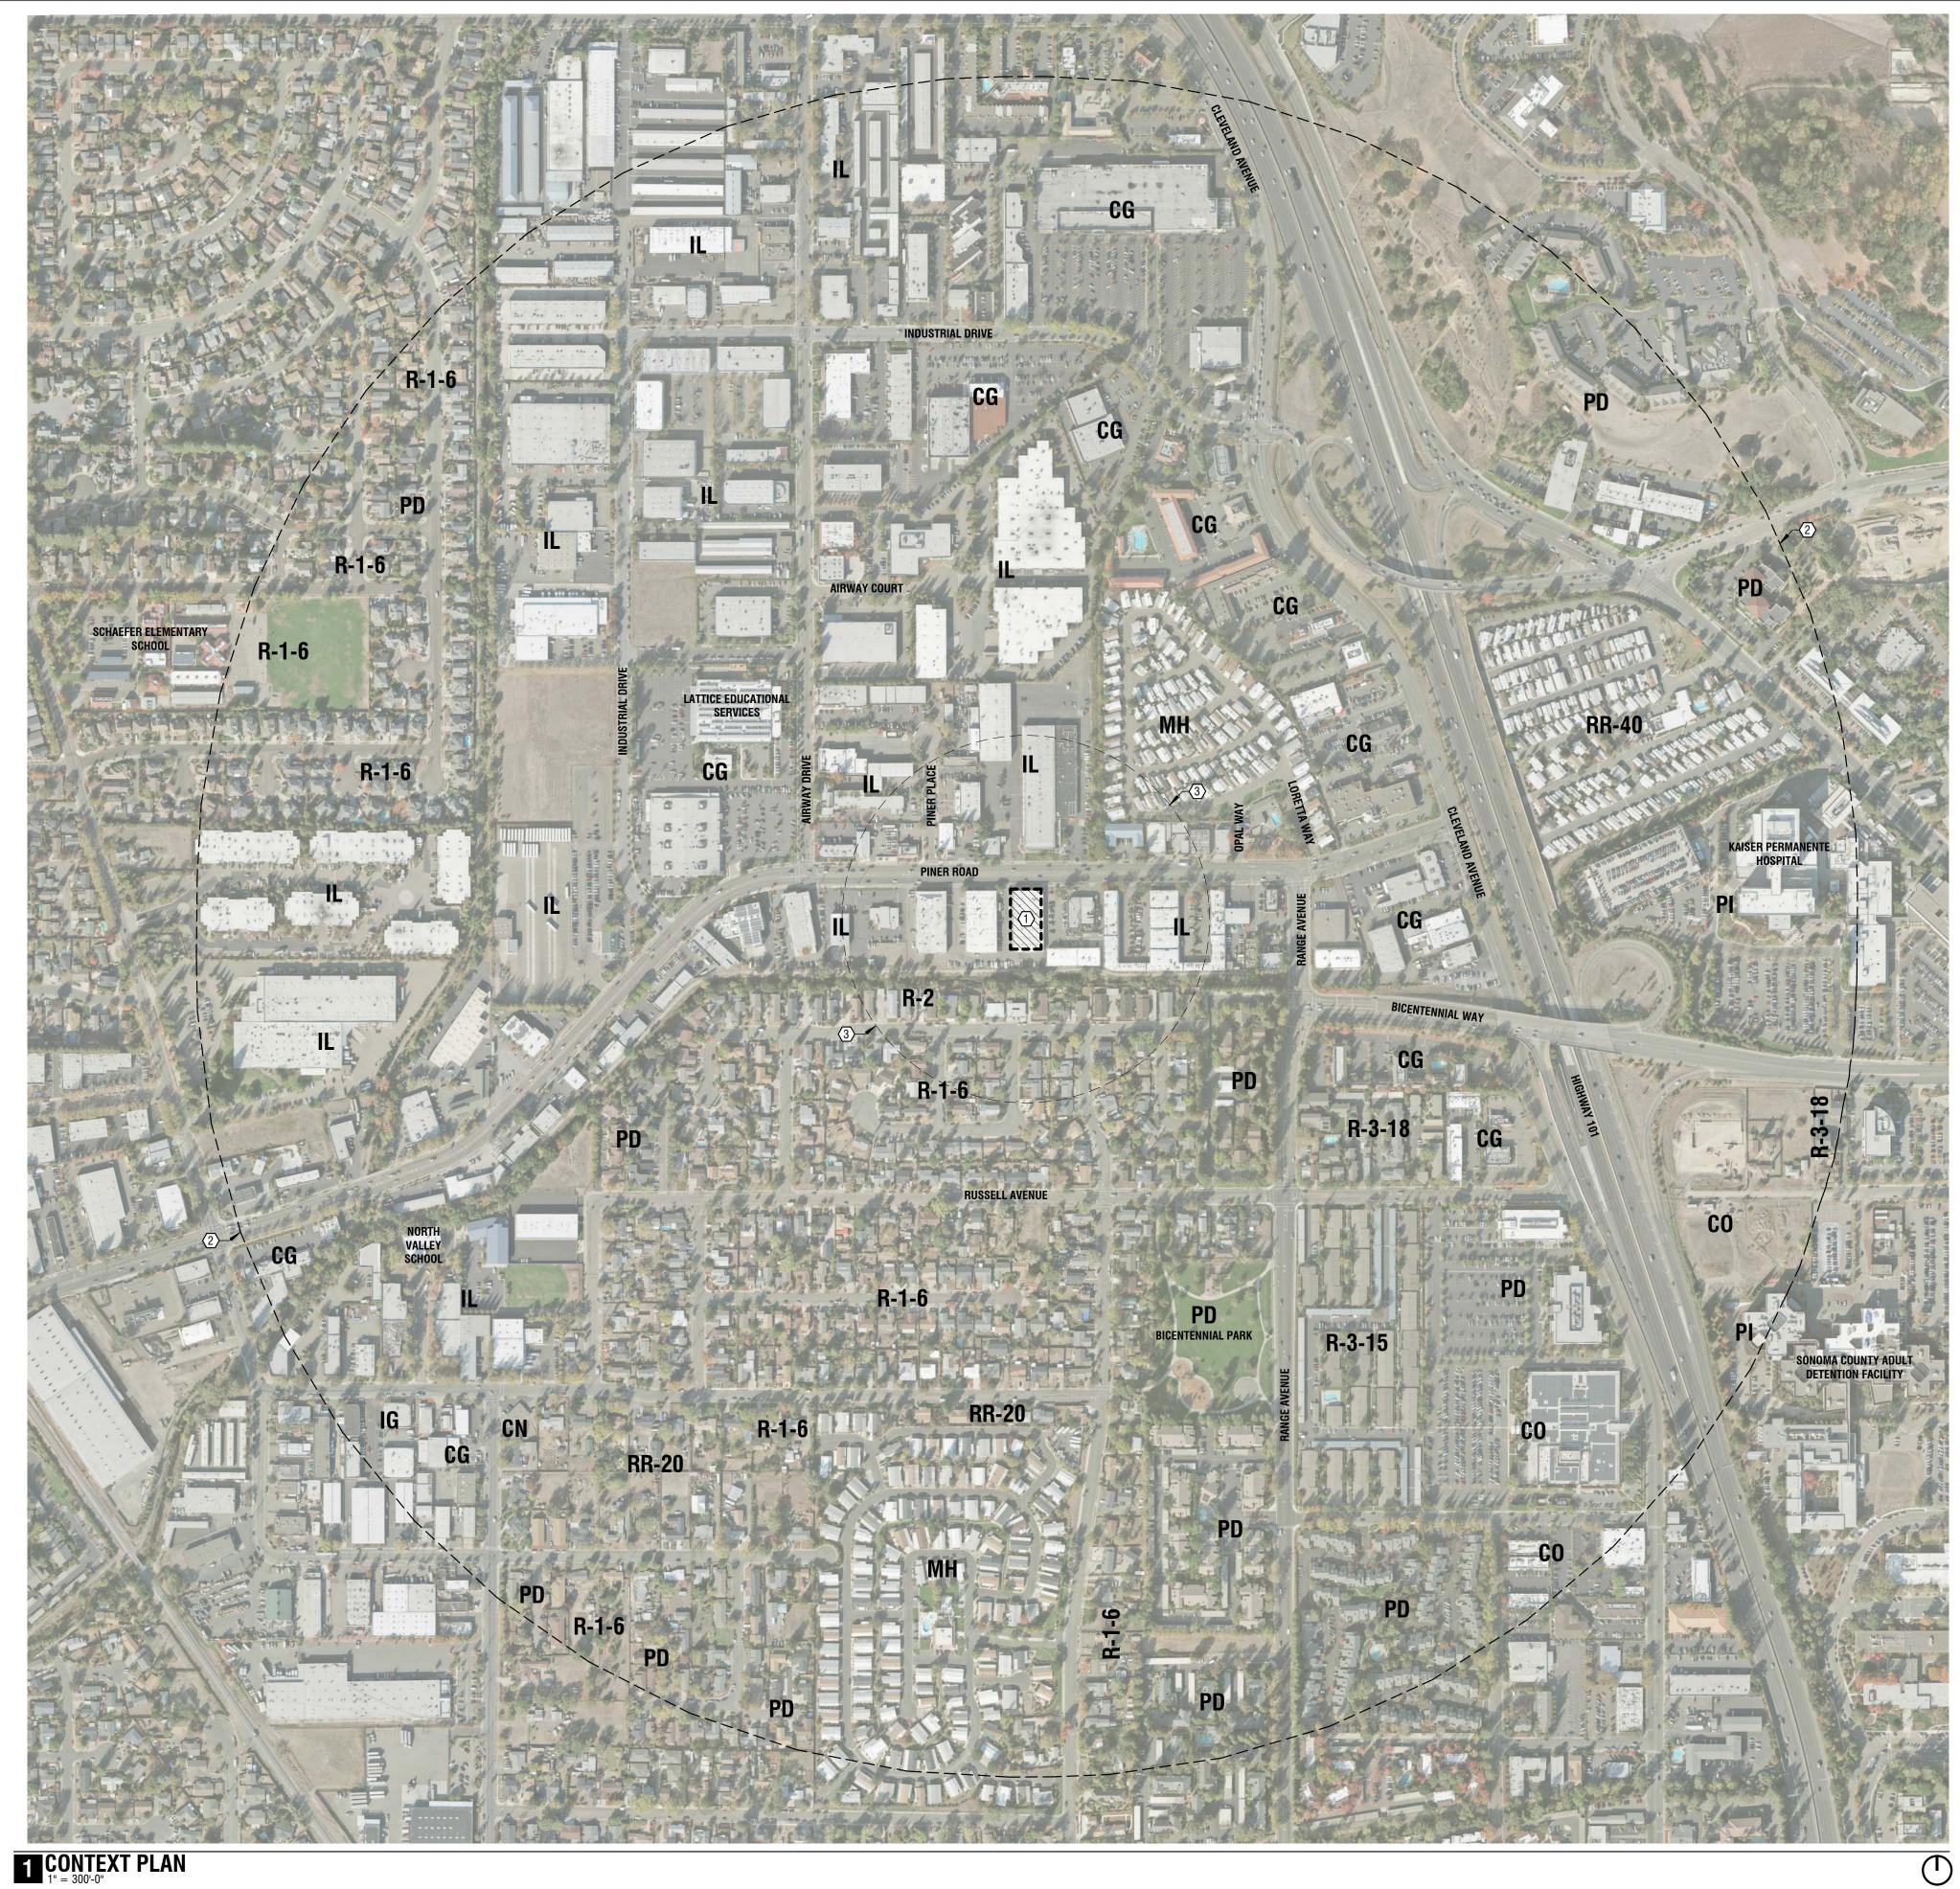


SHEET KEYNOTES

1 PROJECT SITE


2 1/2 MILE RADIUS FROM PROPERTY LINE (3) 600 FOOT RADIUS FROM PROPERTY LINE




S/A

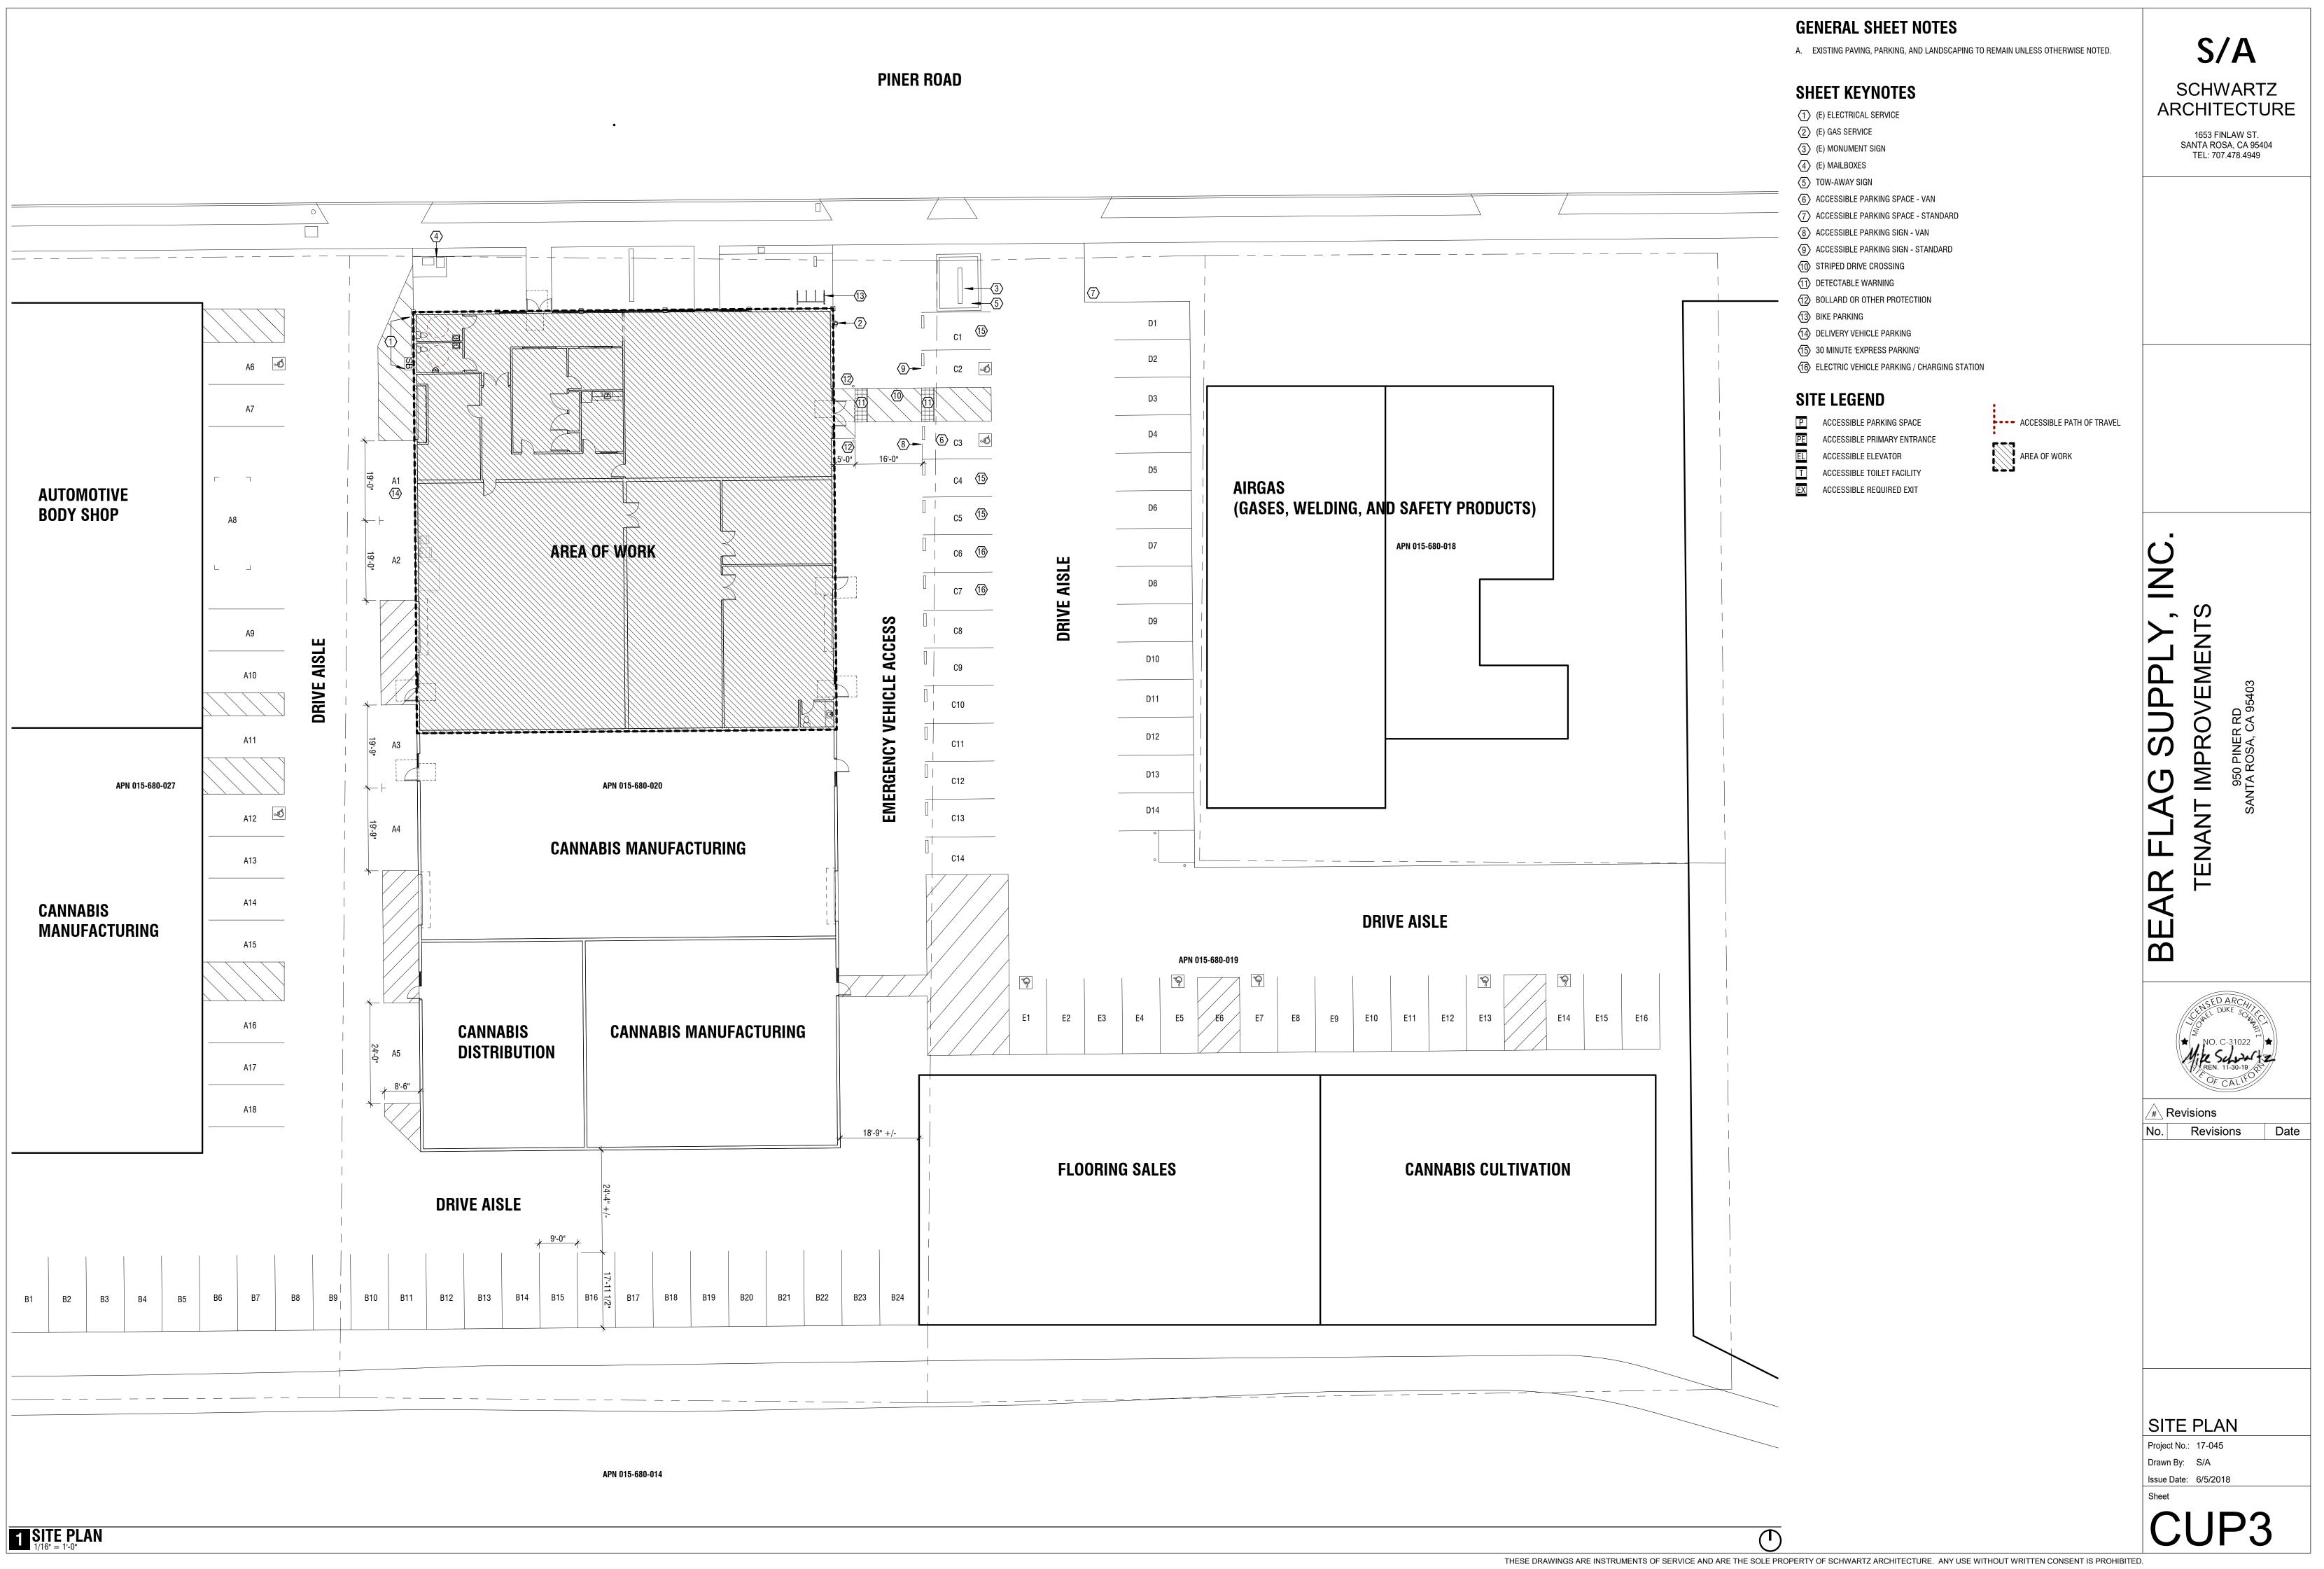





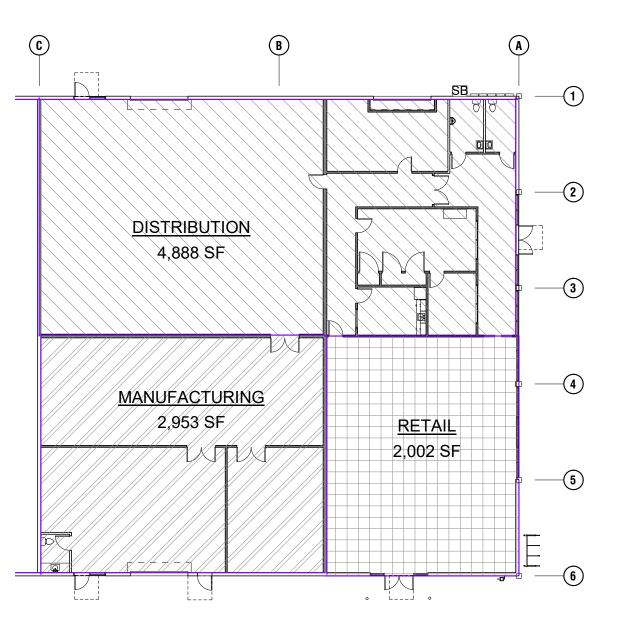


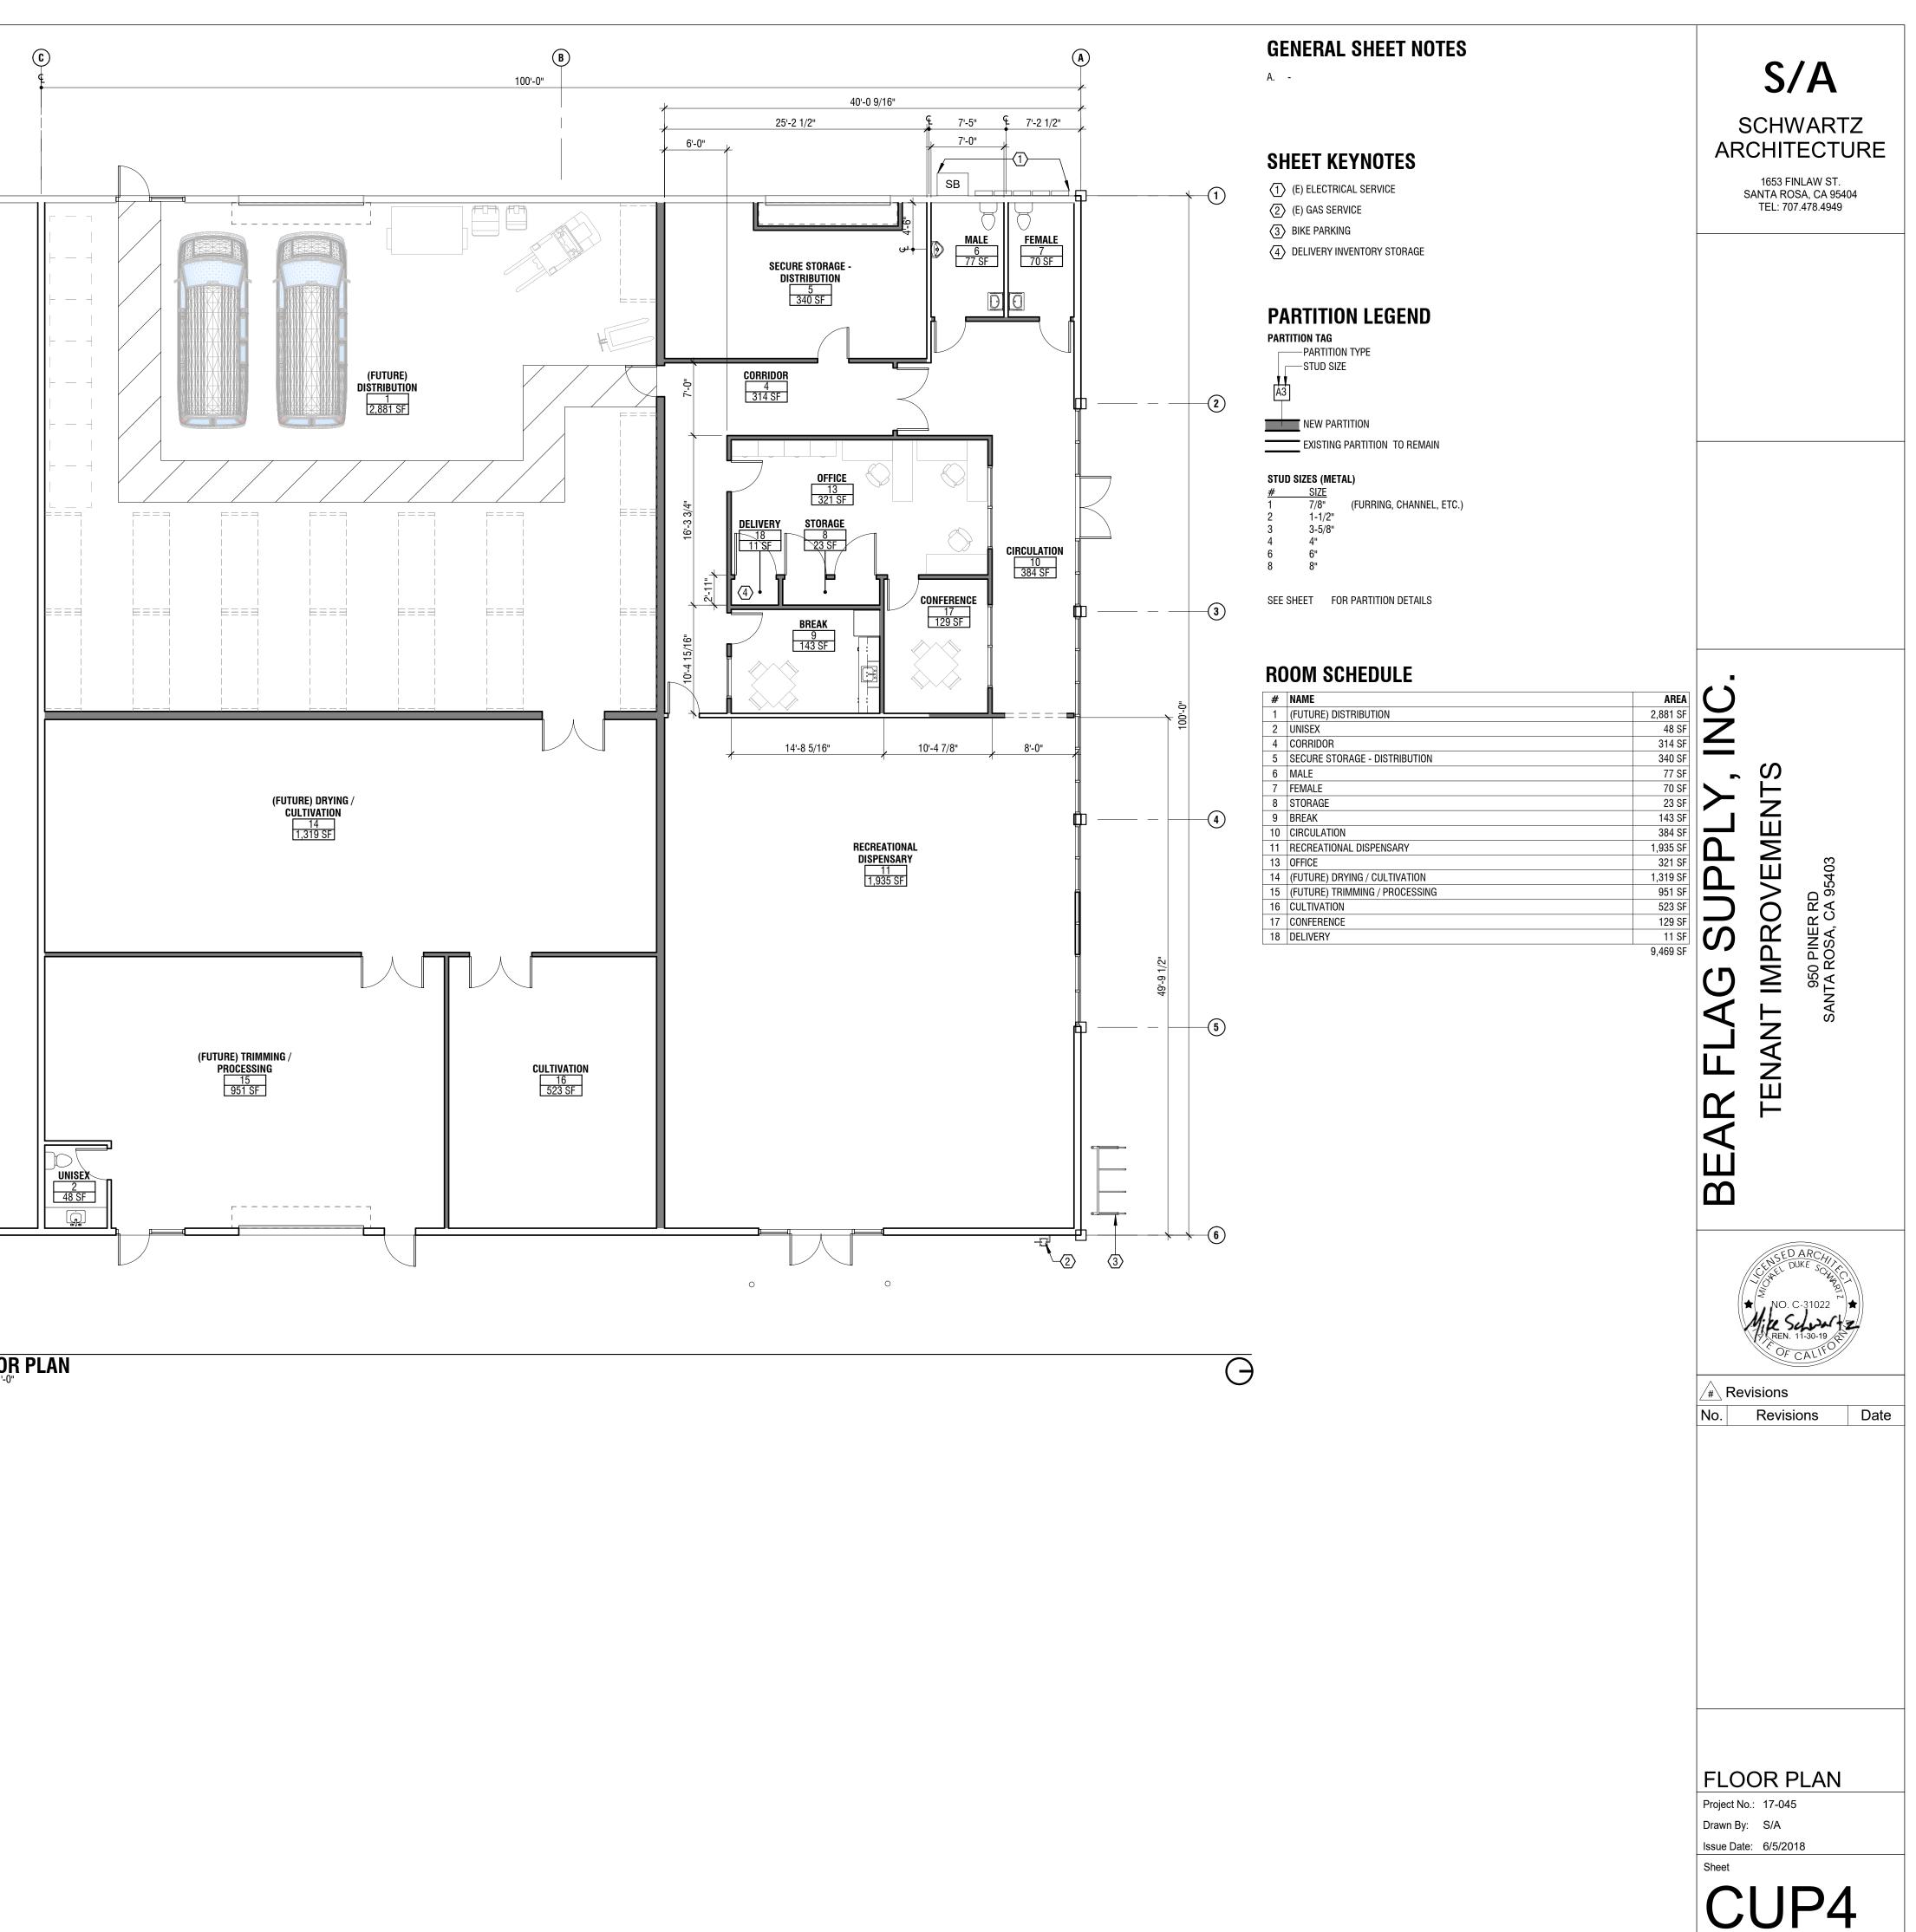


1 FLOOR PLAN 1/8" = 1'-0"

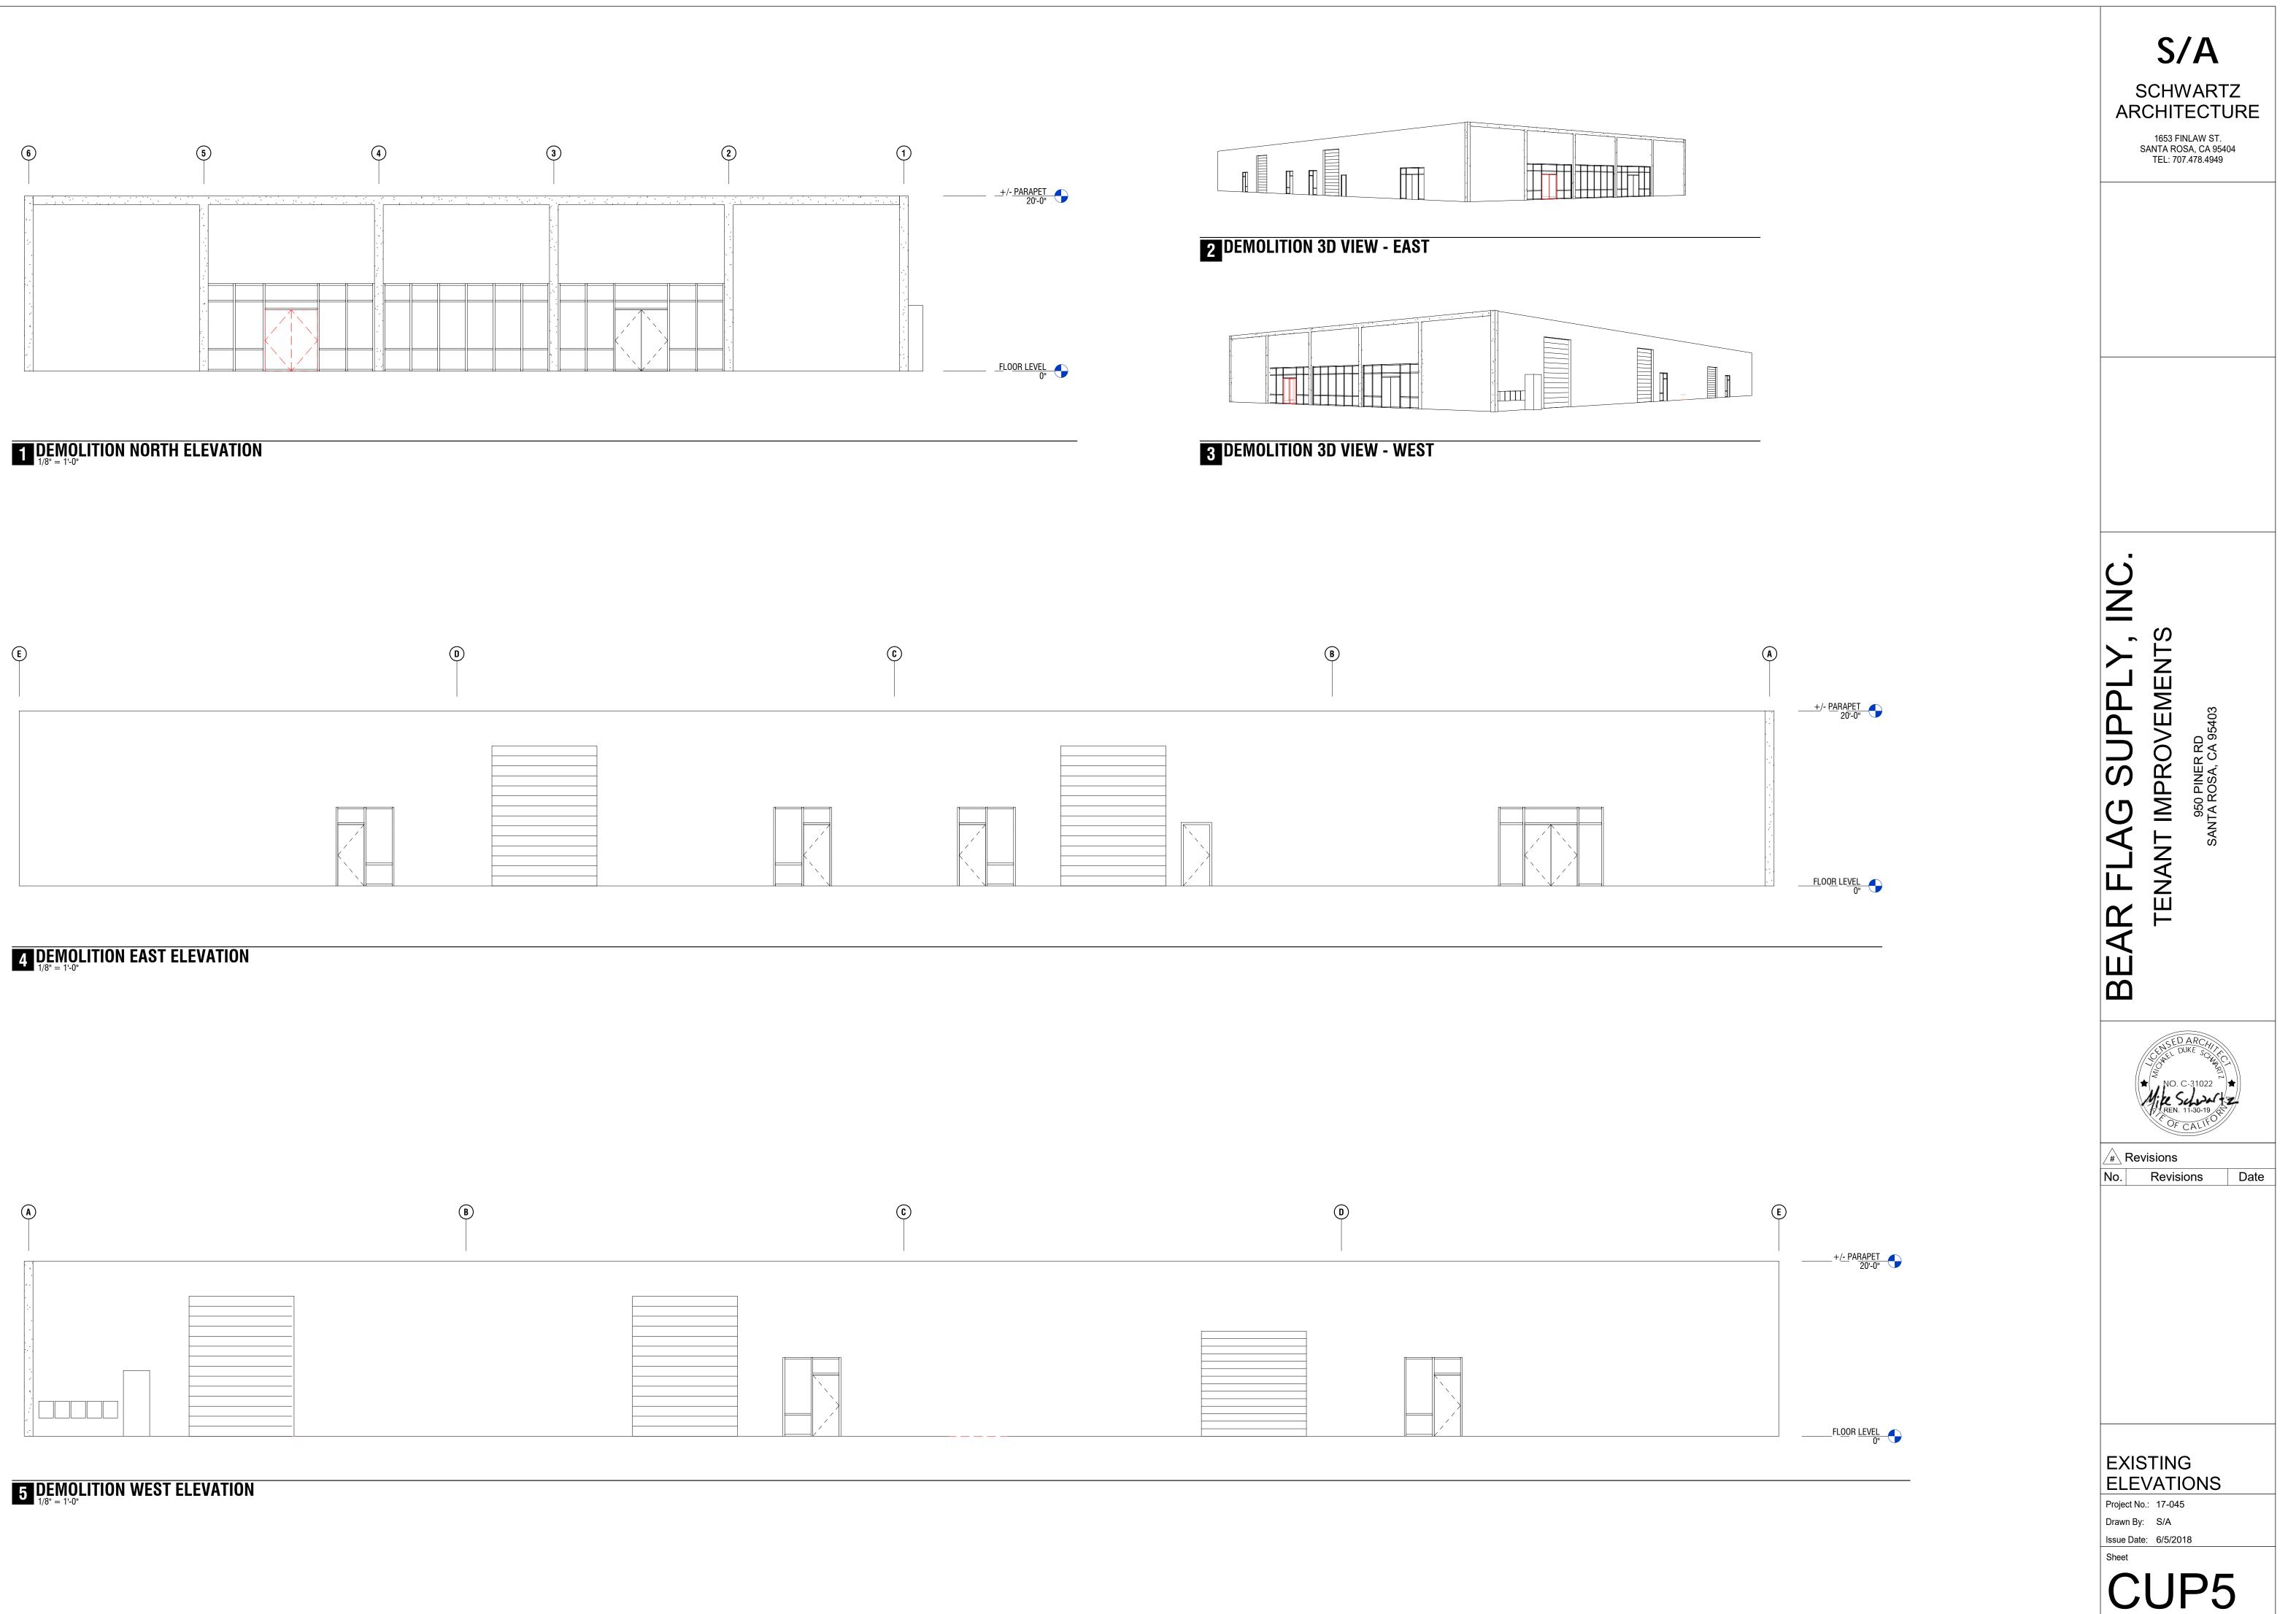


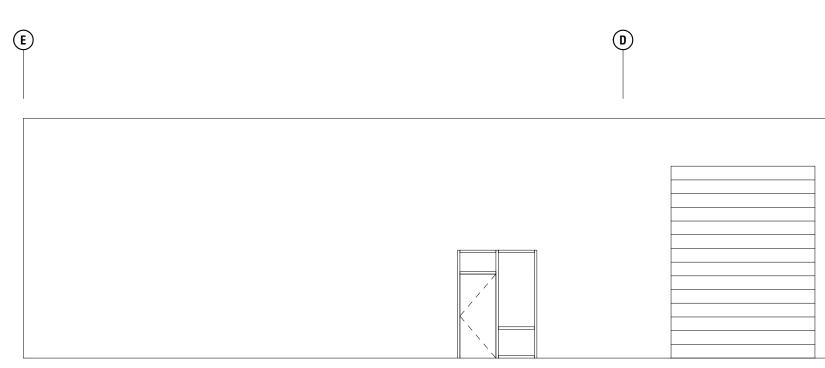

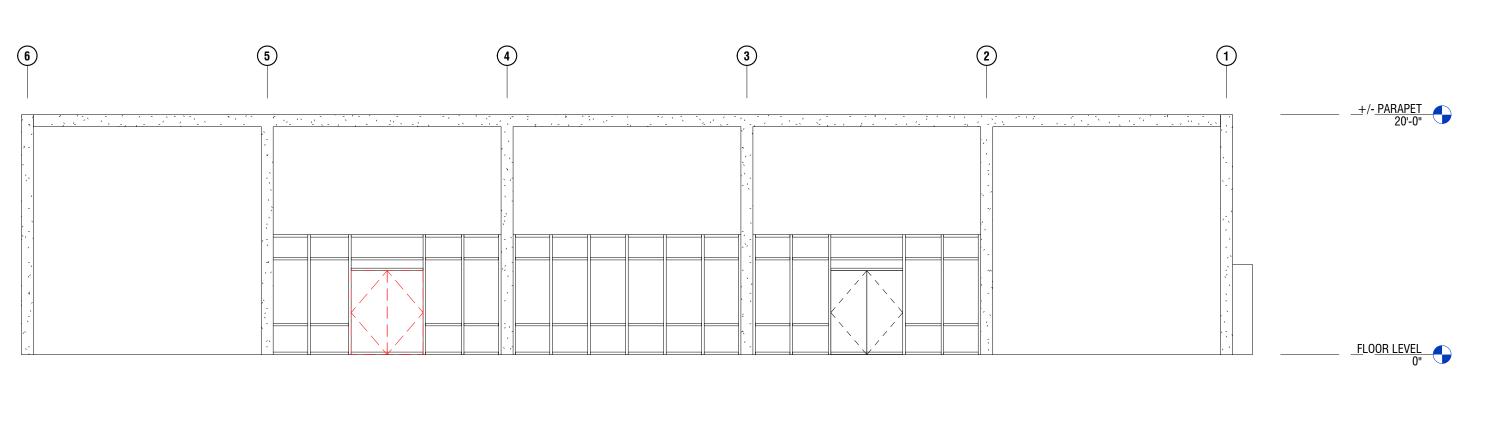

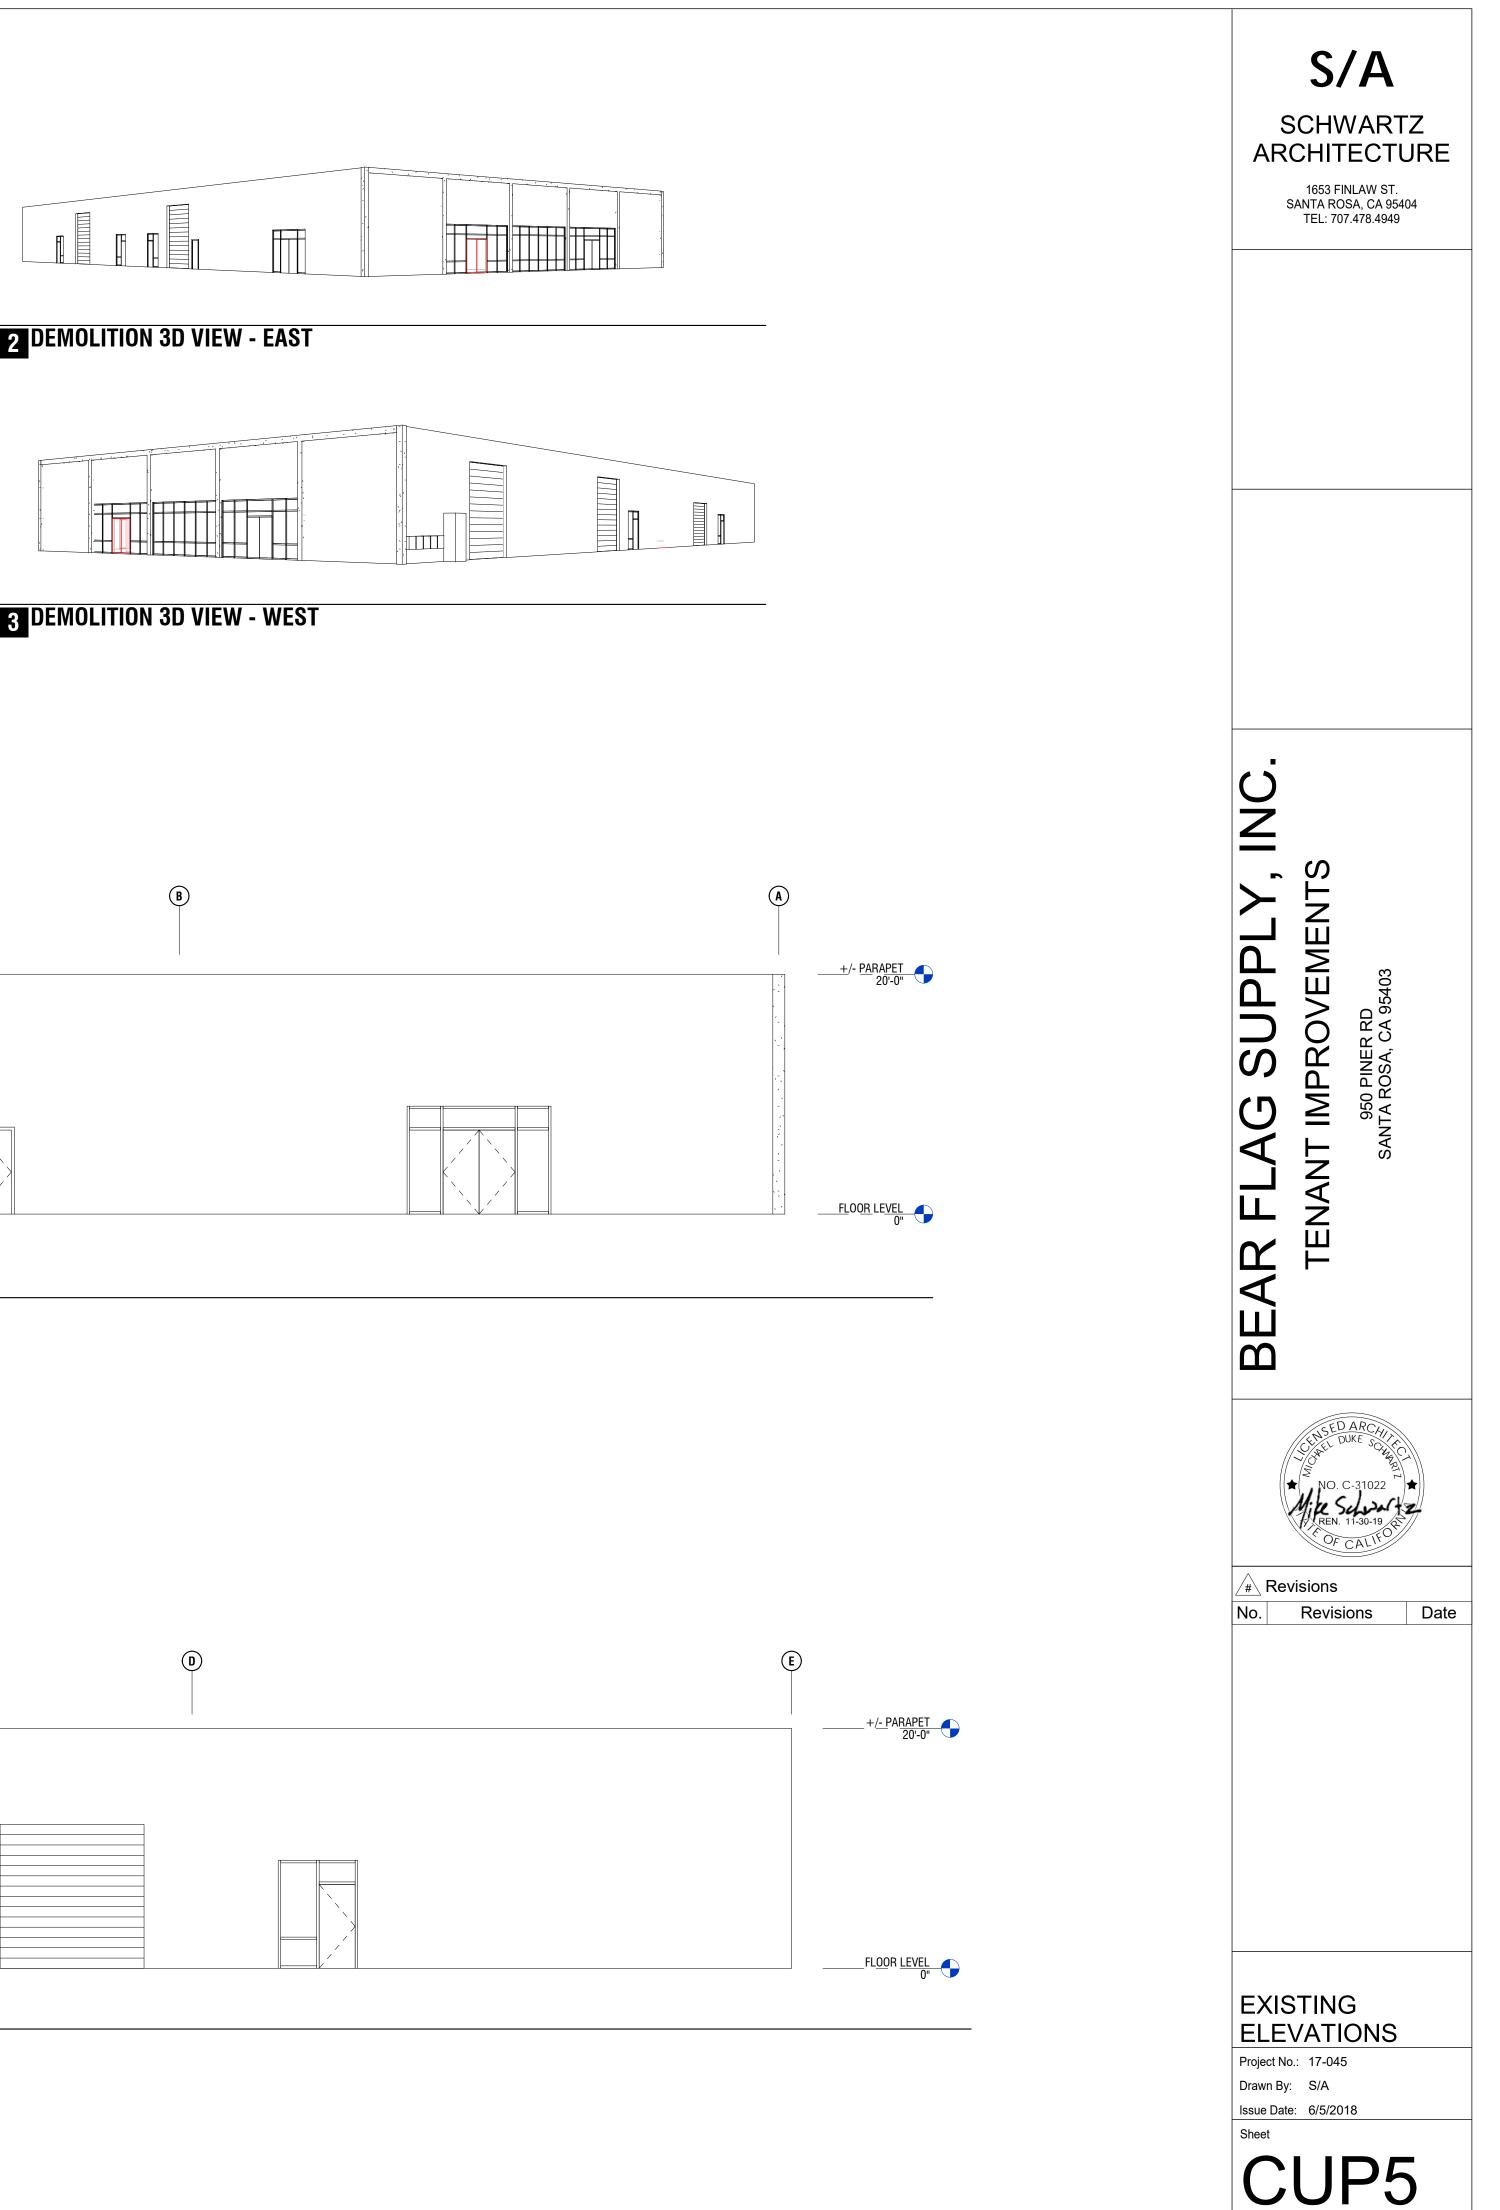


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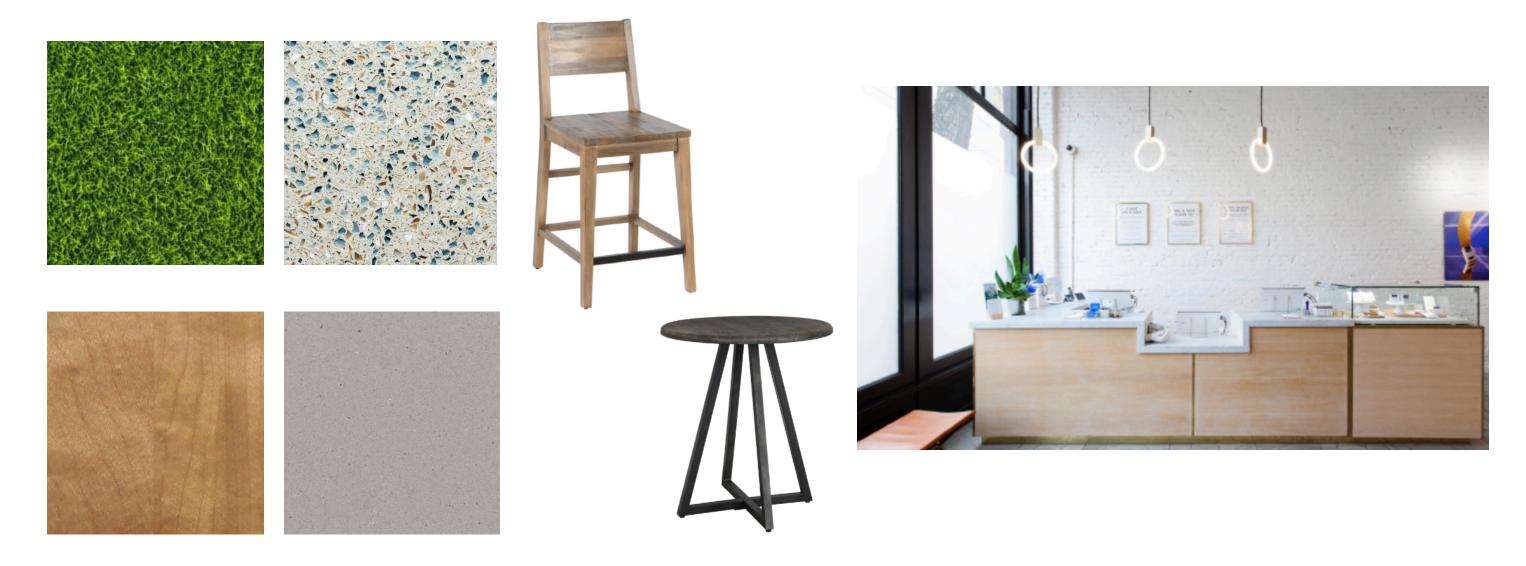


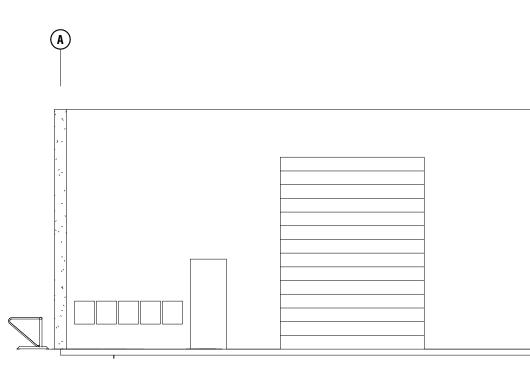





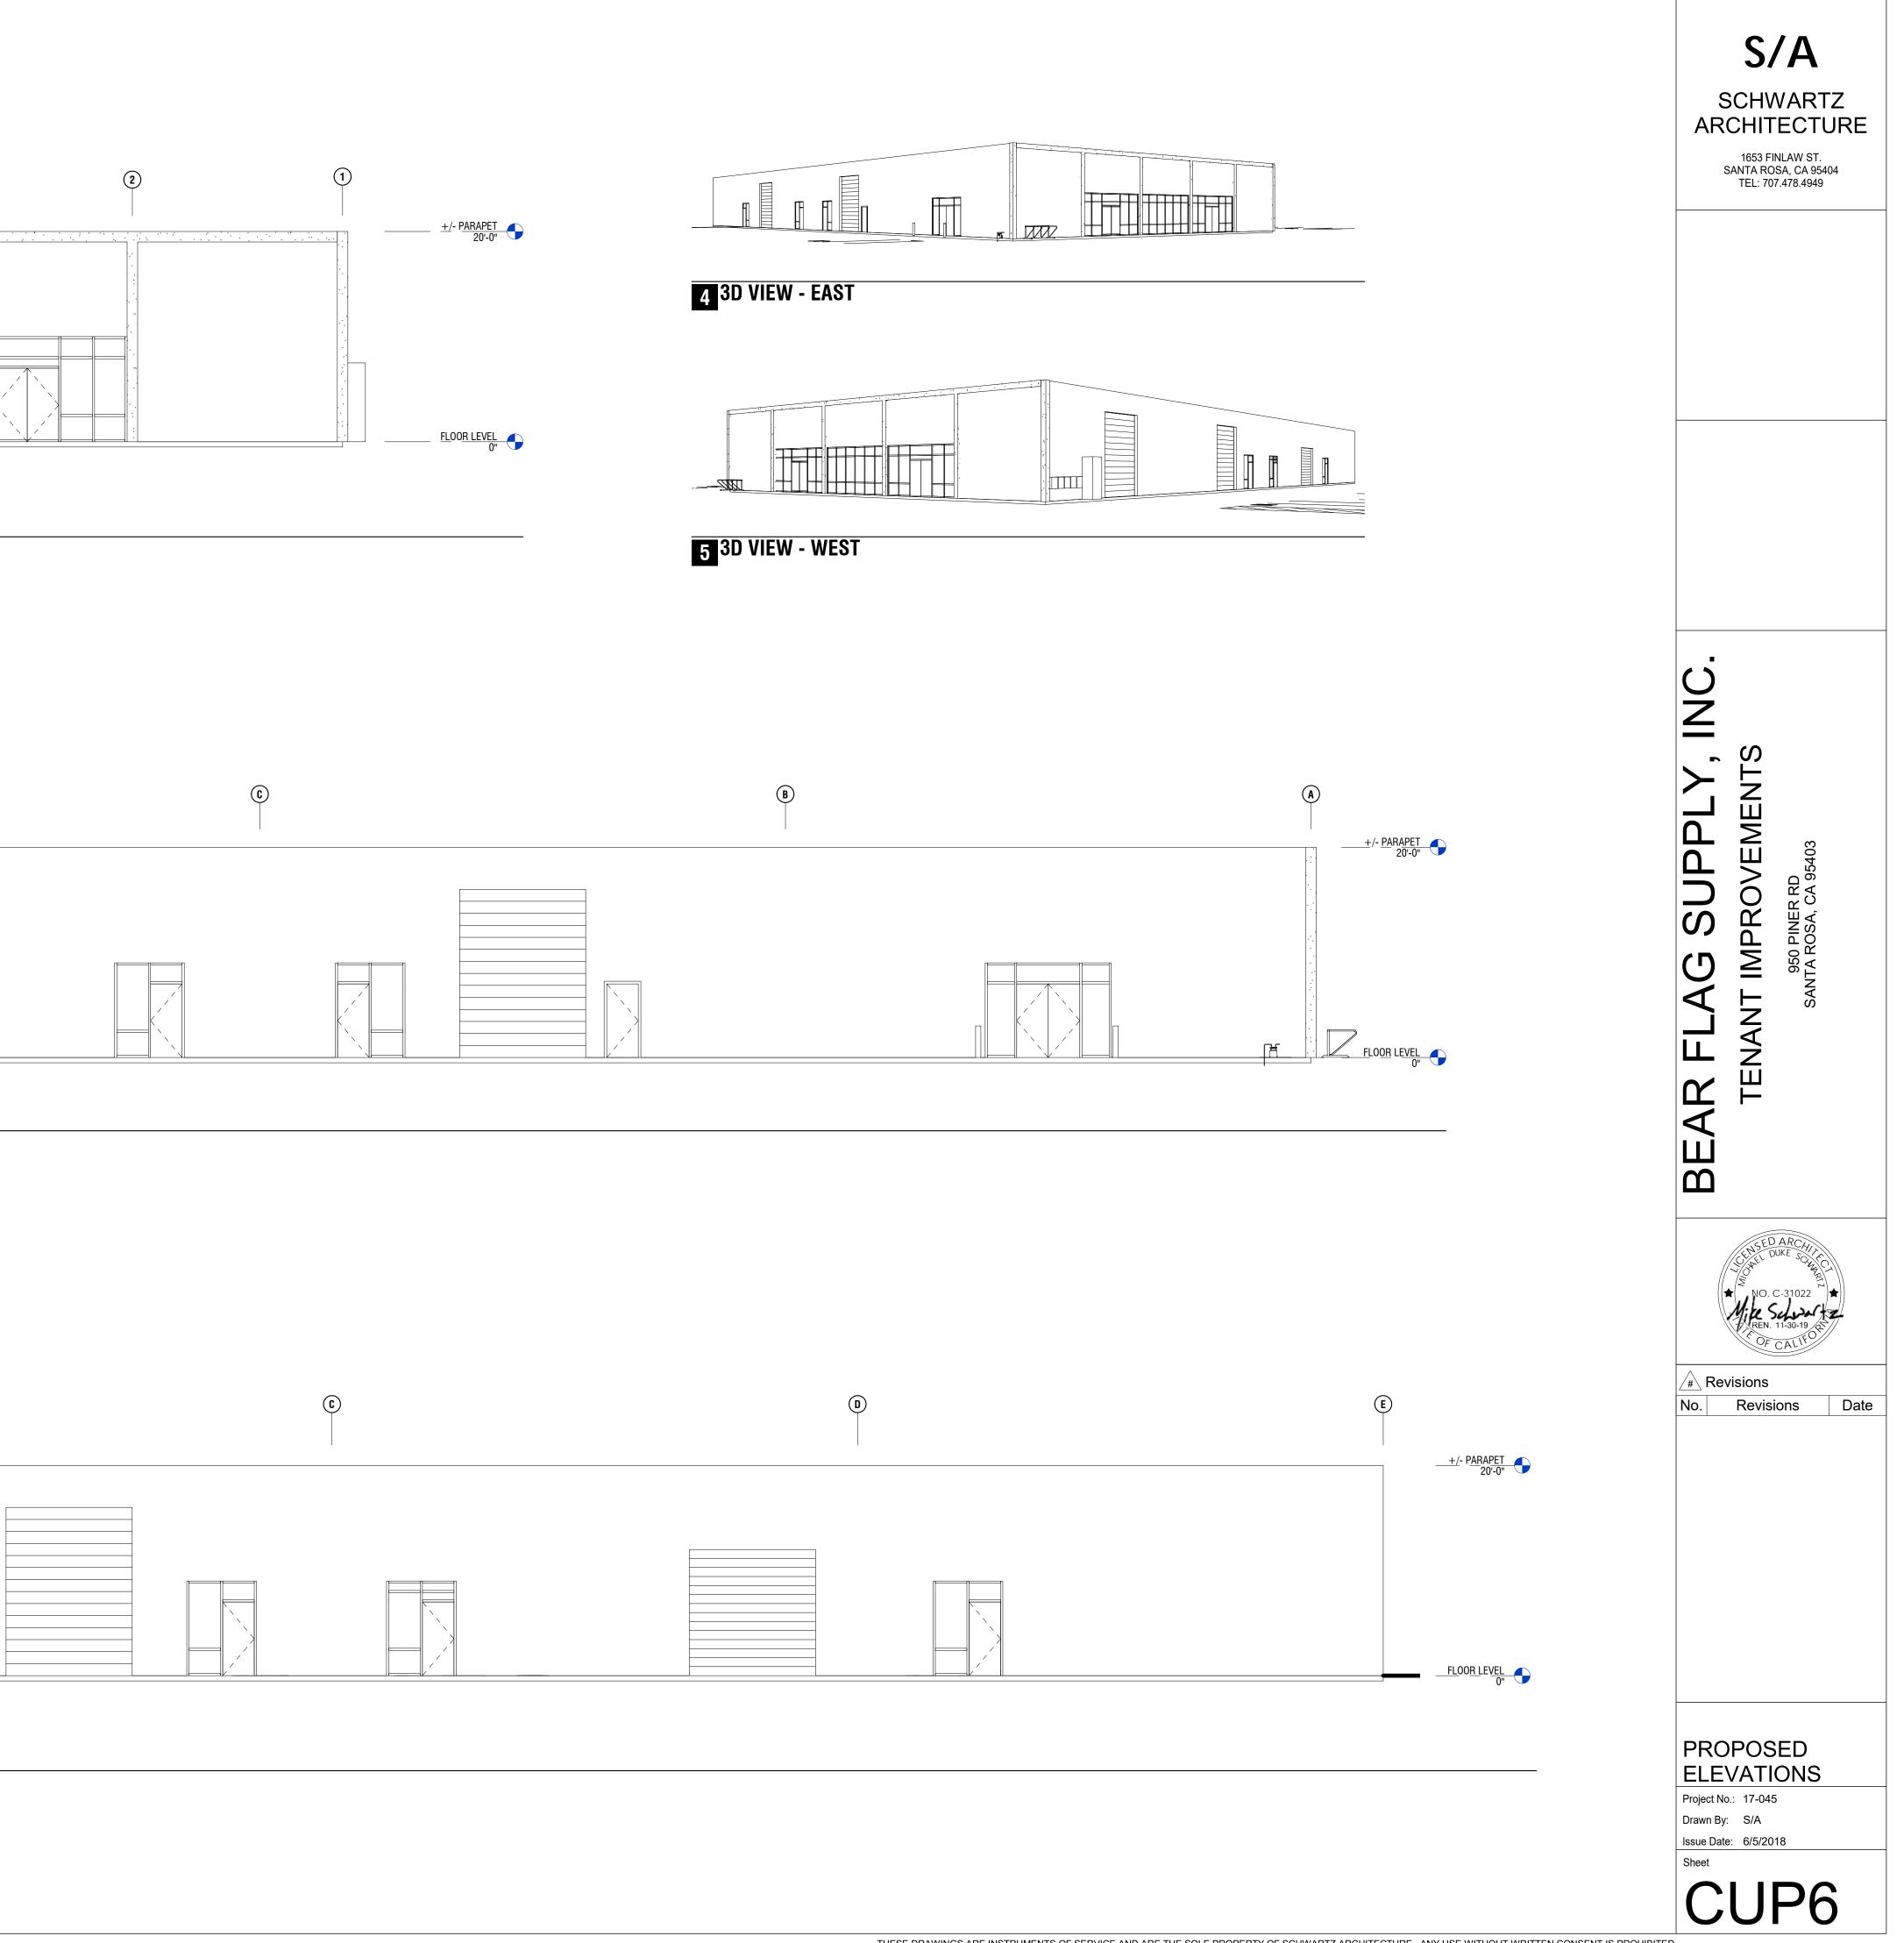




Dispensary Concepts

Lauren Brandwein Design





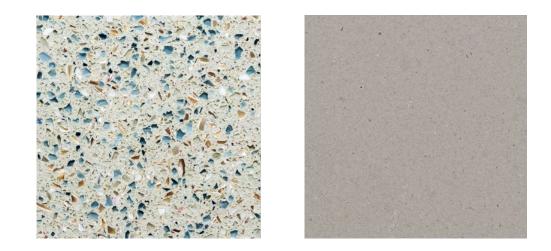













Dispensary Concepts

Dispensary

Lauren Brandwein Design







Dispensary Concepts

Cannabis Viewing Gallery





Lauren Brandwein Design