

1 ARCHITECTURAL SITE PLAN
1/16" = 1'-0"

ROWELL BROKAW

1203 Willamette Street Suite 210 Eugene, Oregon 97401 541 485 1003 rowellbrokaw.com

Architecture. Design. Strategy.



FOR DESIGN REVIEW-NOT FOR CONSTRUCTION

REVISIONS TO THIS SHEET
REV. DATE

SHEET ISSUE DATE

05/13/2019 50% SCHEMATIC DESIGN

PROJECT TRACKING

P.I.C: JOHN ROWELL
PM / PA: FRANK VISCONTI


DANCO

Project Name
HOUSING FIRST | SANTA
ROSA

Project Address 80 COLLEGE AVENUE SANTA ROSA, CA

ARCHITECTURAL SITE PLAN

A-100

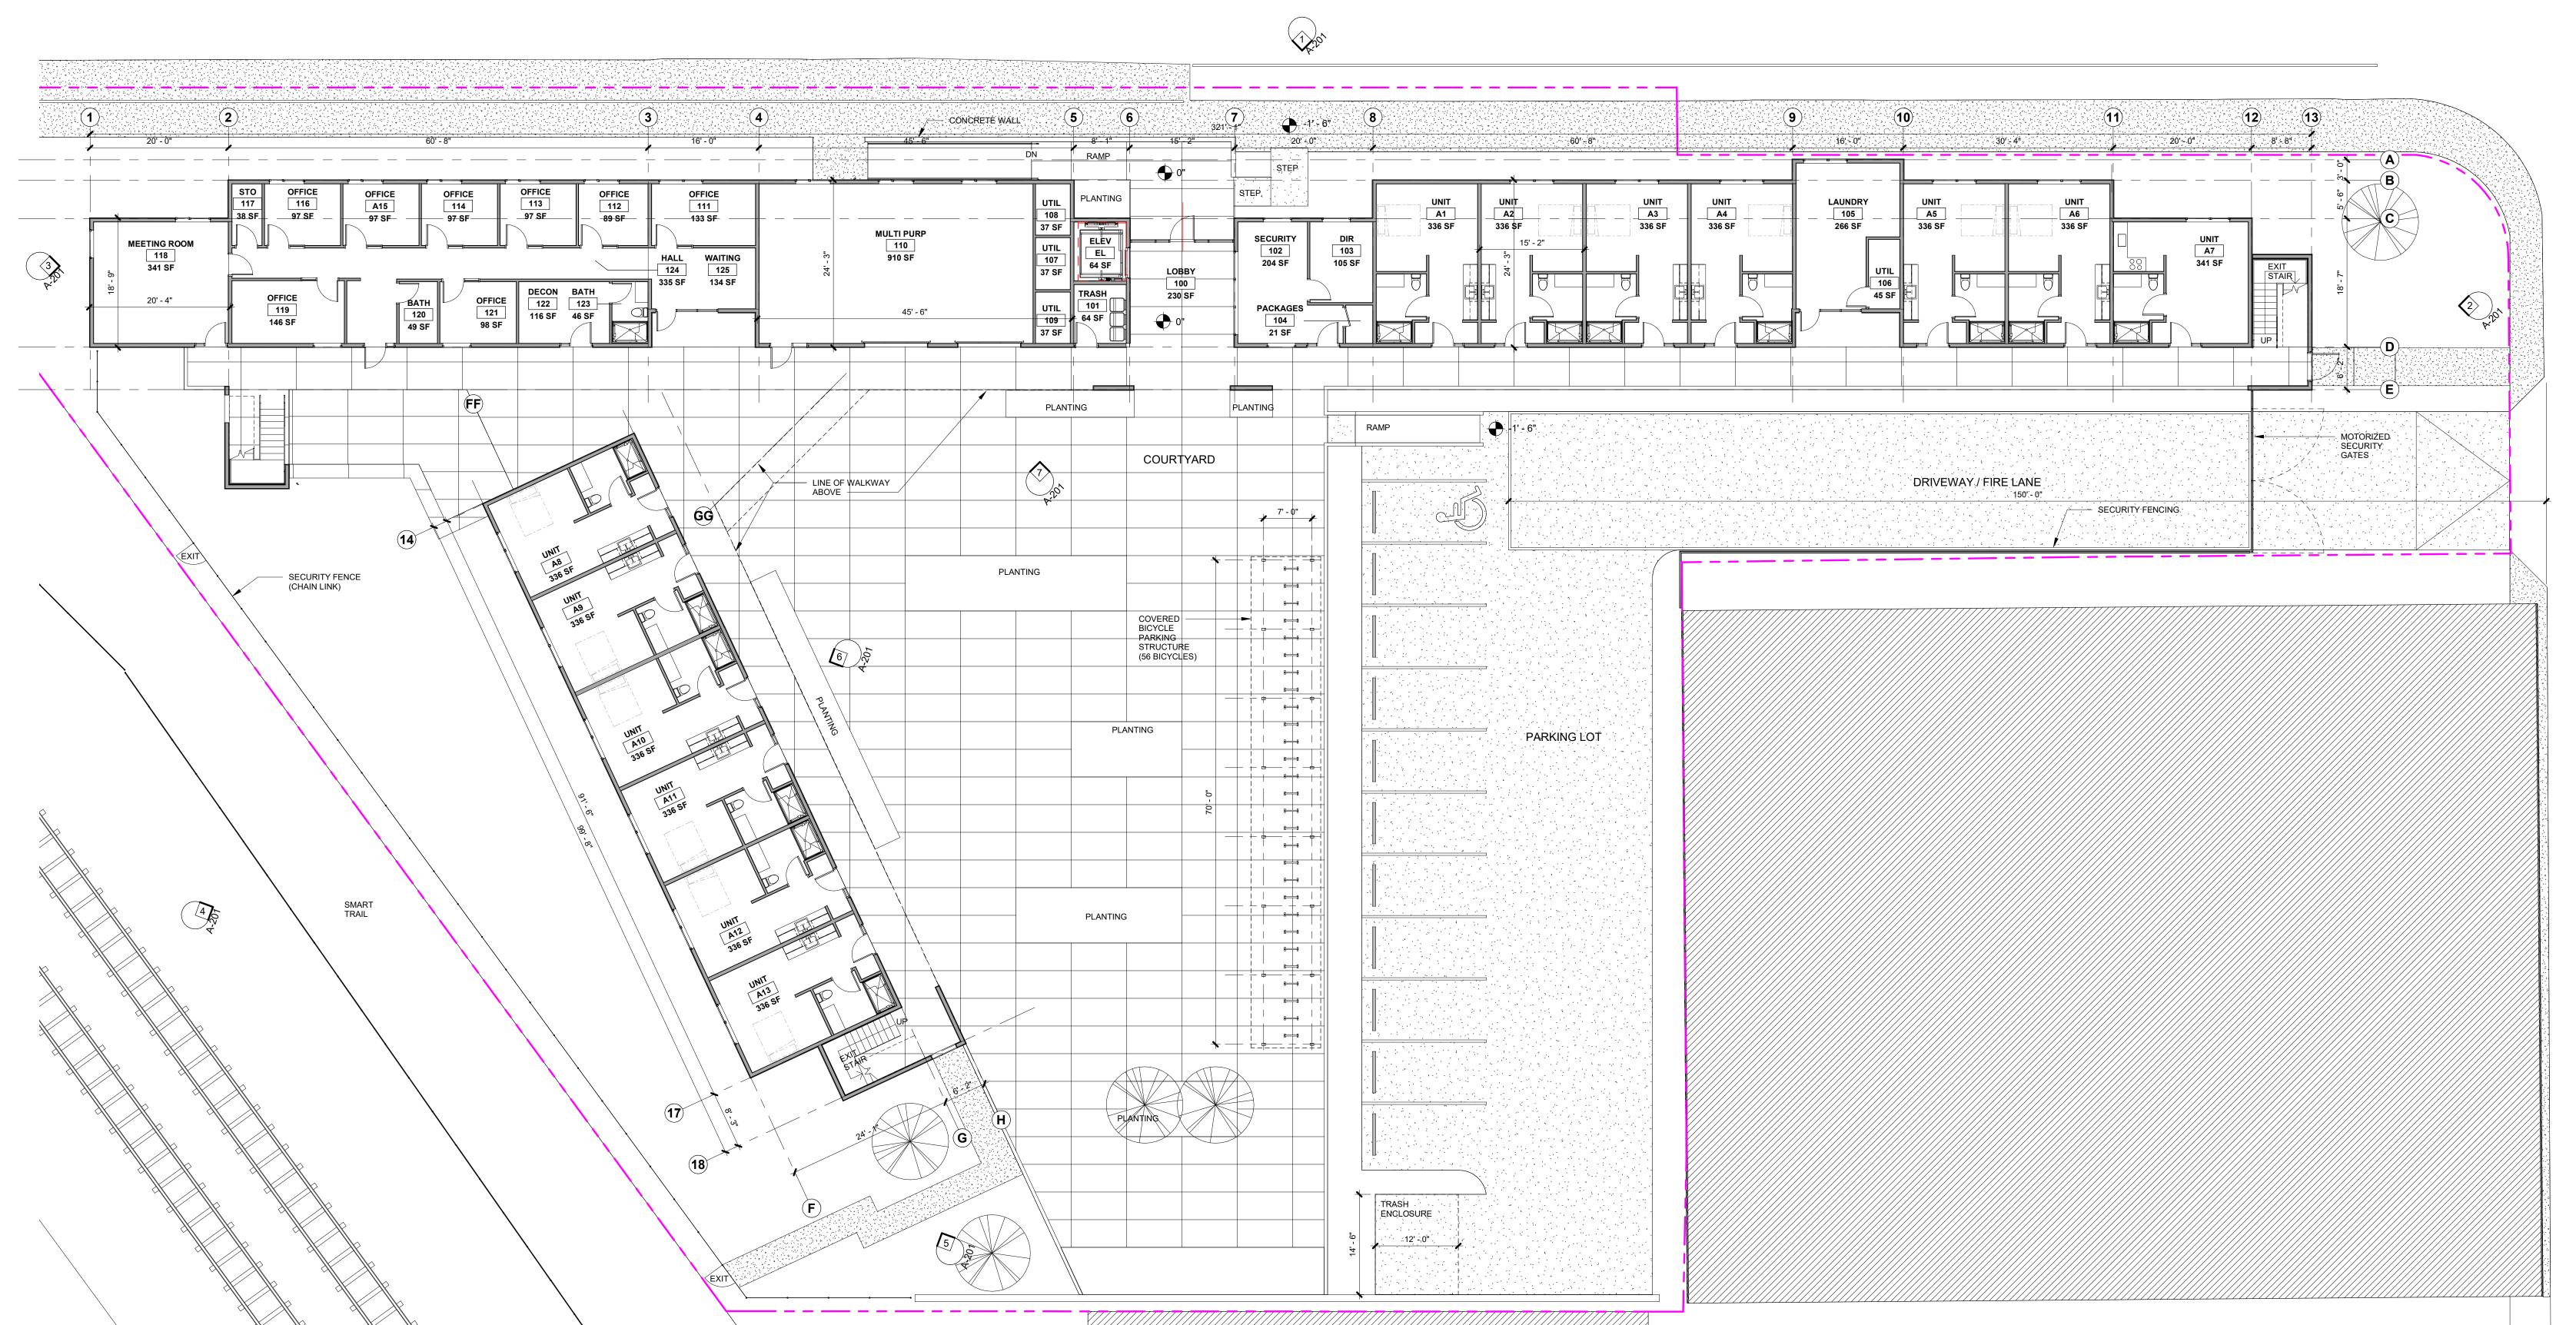

1 1ST FLOOR
3/32" = 1'-0"

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RBA #: 1843


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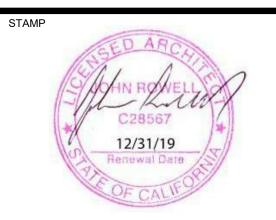
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1ST FLOOR PLAN



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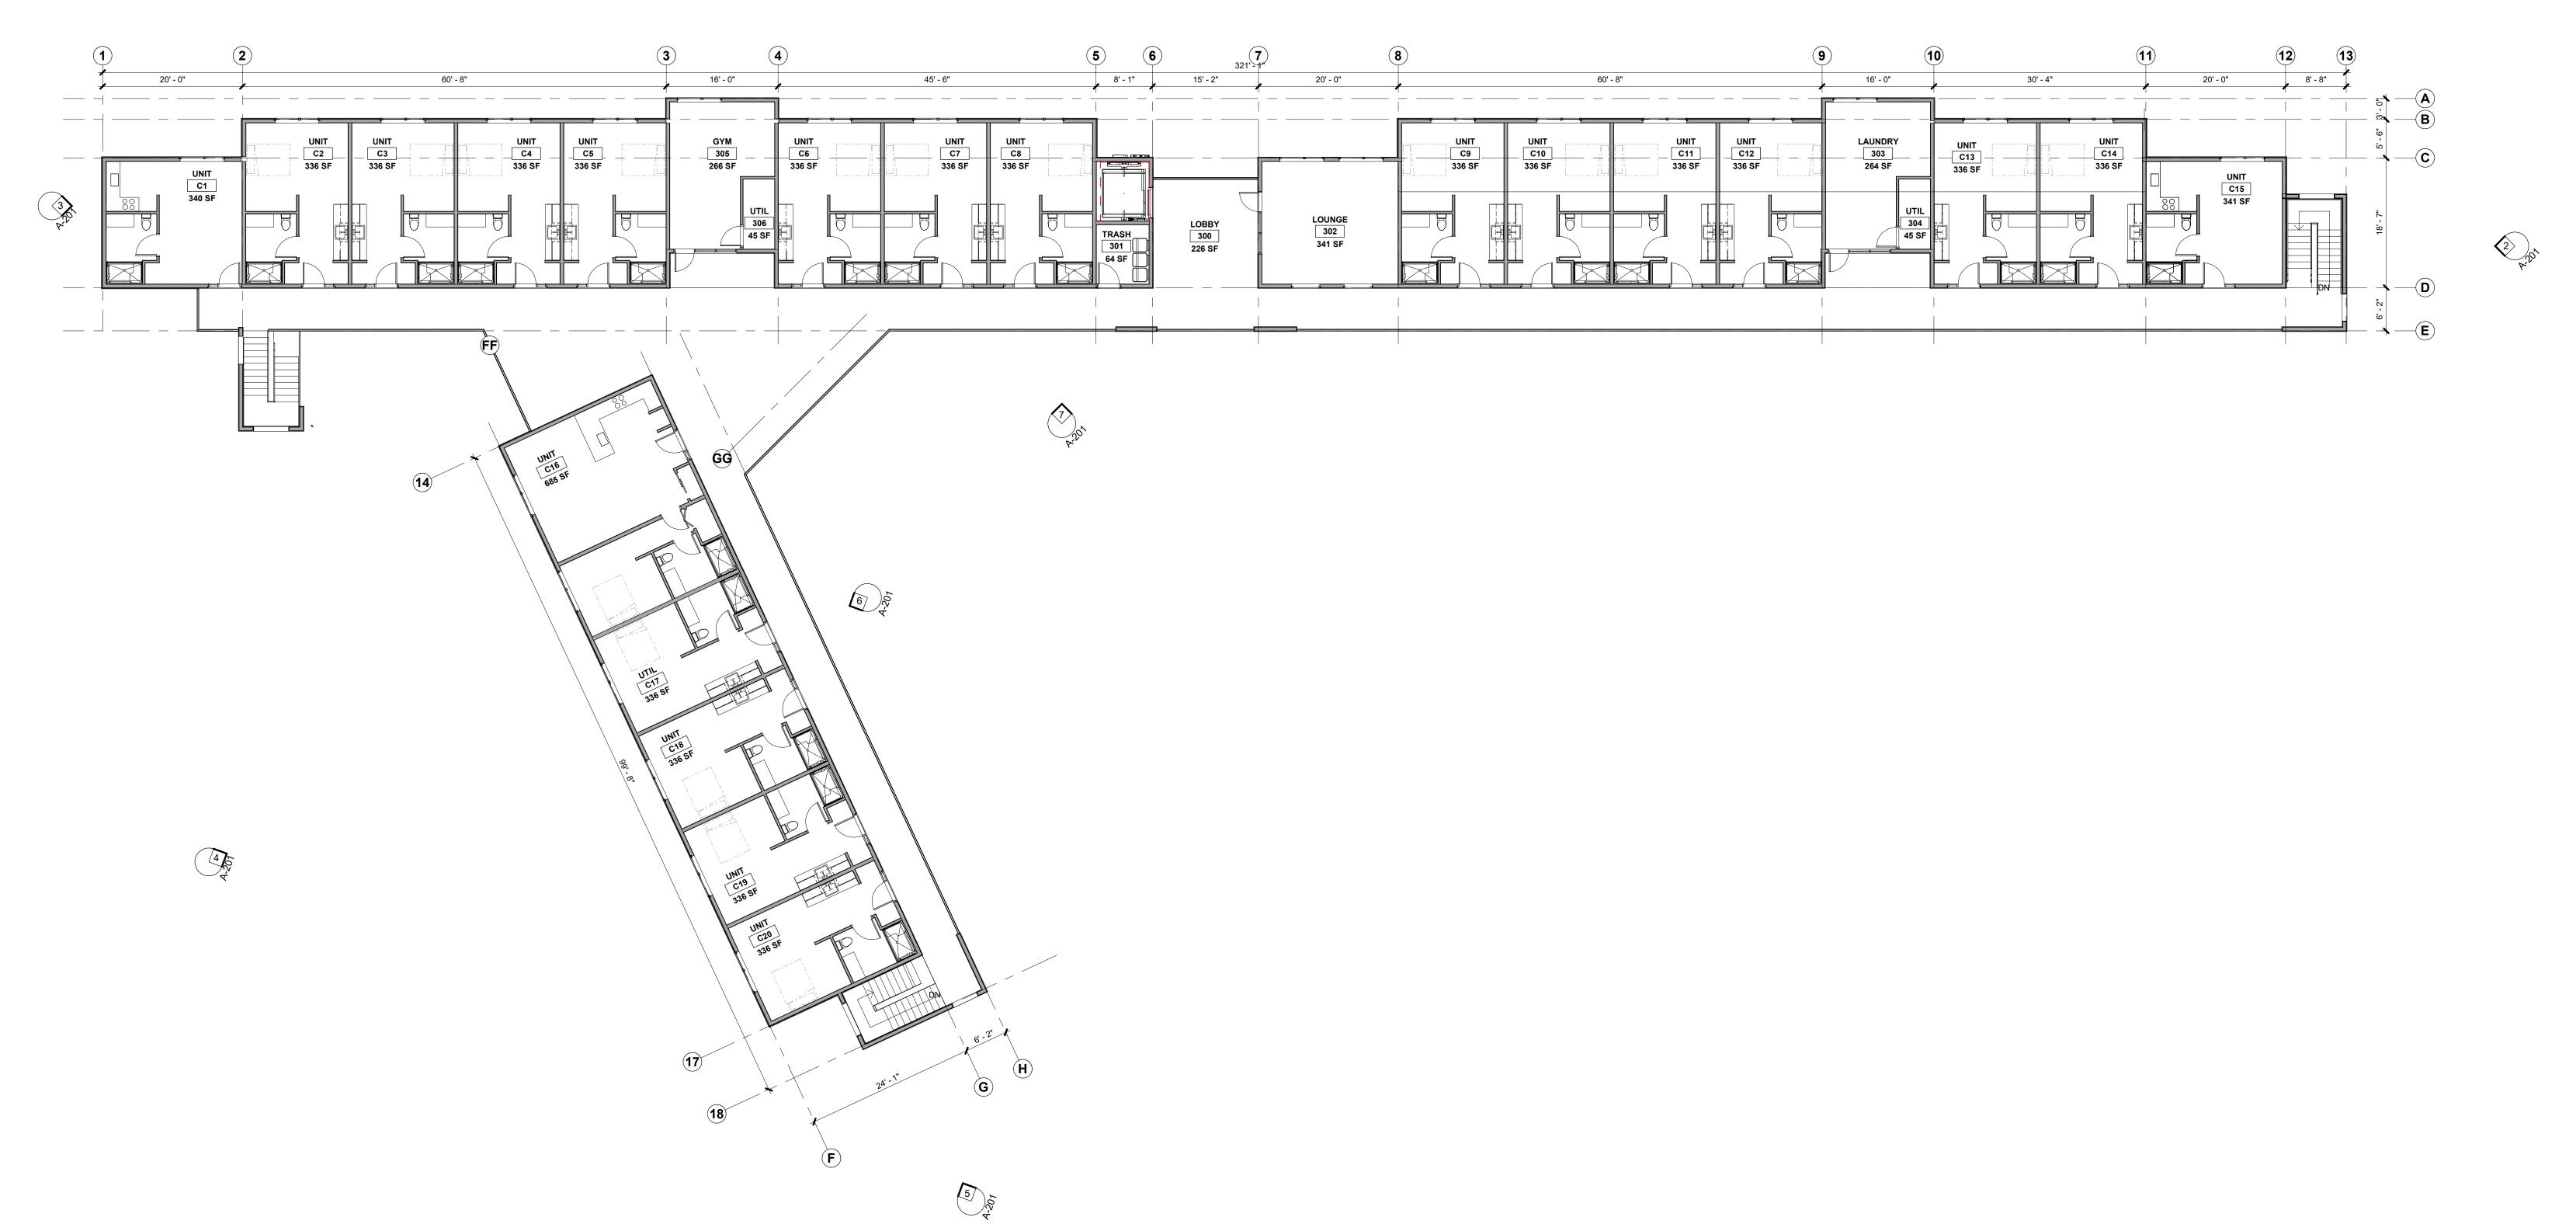
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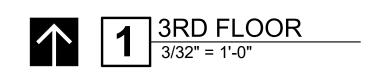
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2ND FLOOR PLAN

1 2ND FLOOR 3/32" = 1'-0"



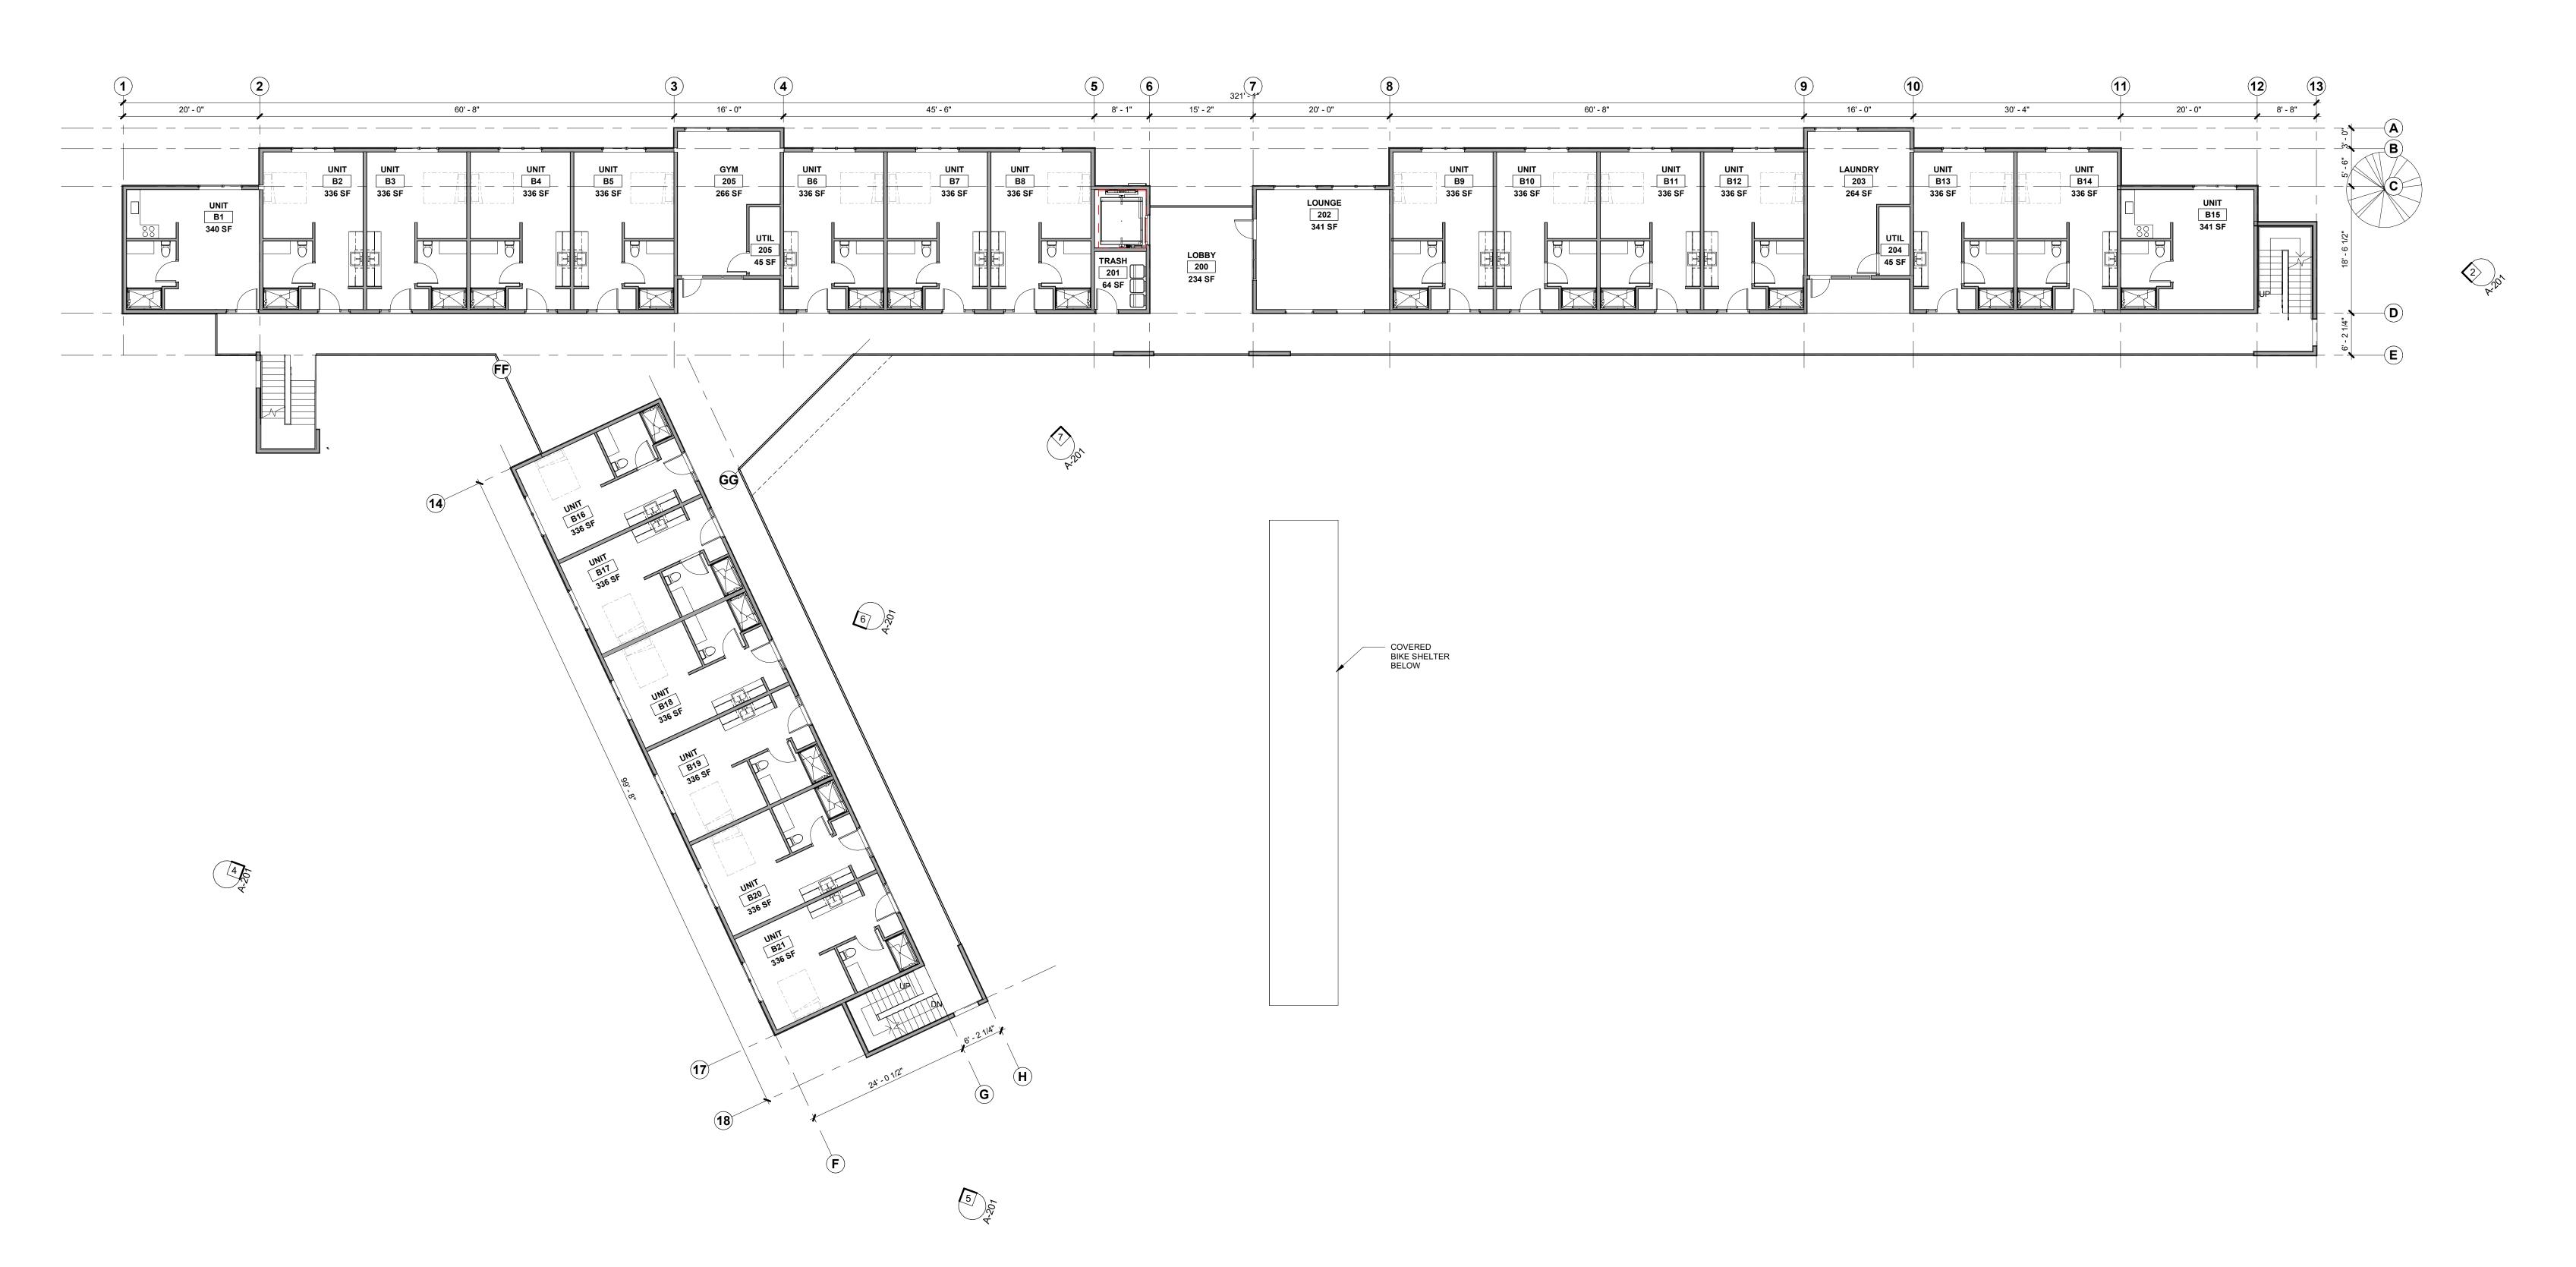



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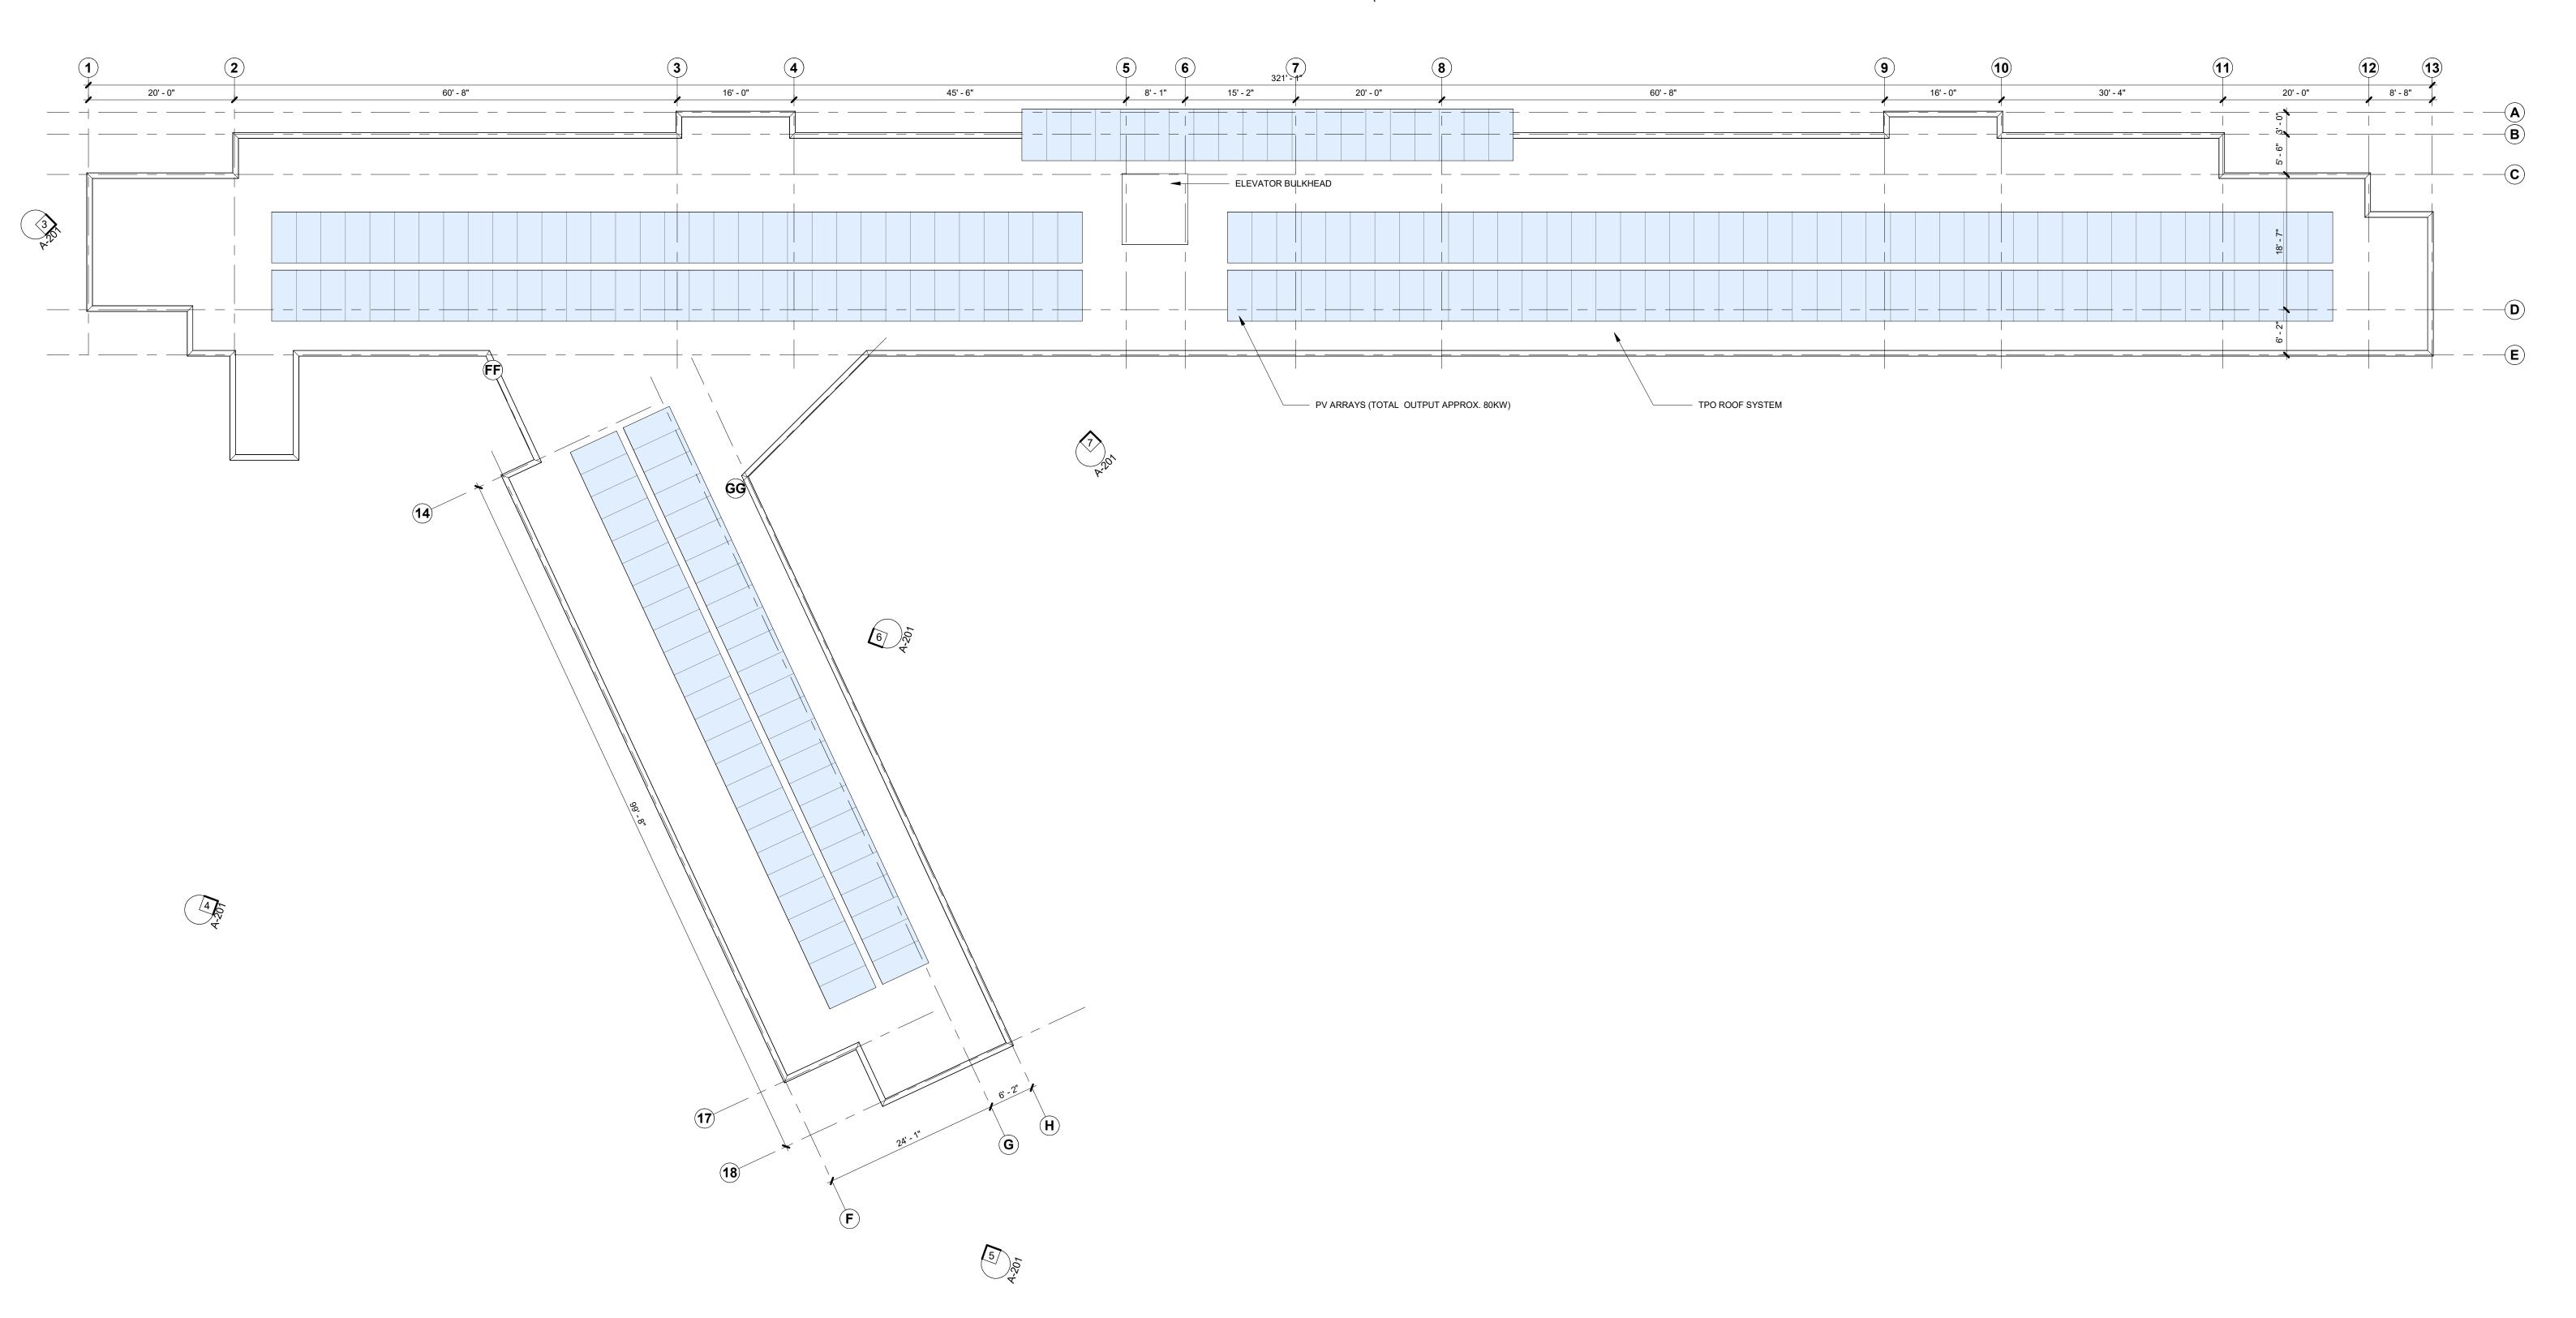
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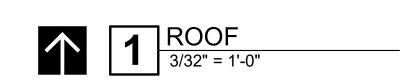
Project Address 80 COLLEGE AVENUE SANTA ROSA, CA

3RD FLOOR PLAN

A-113








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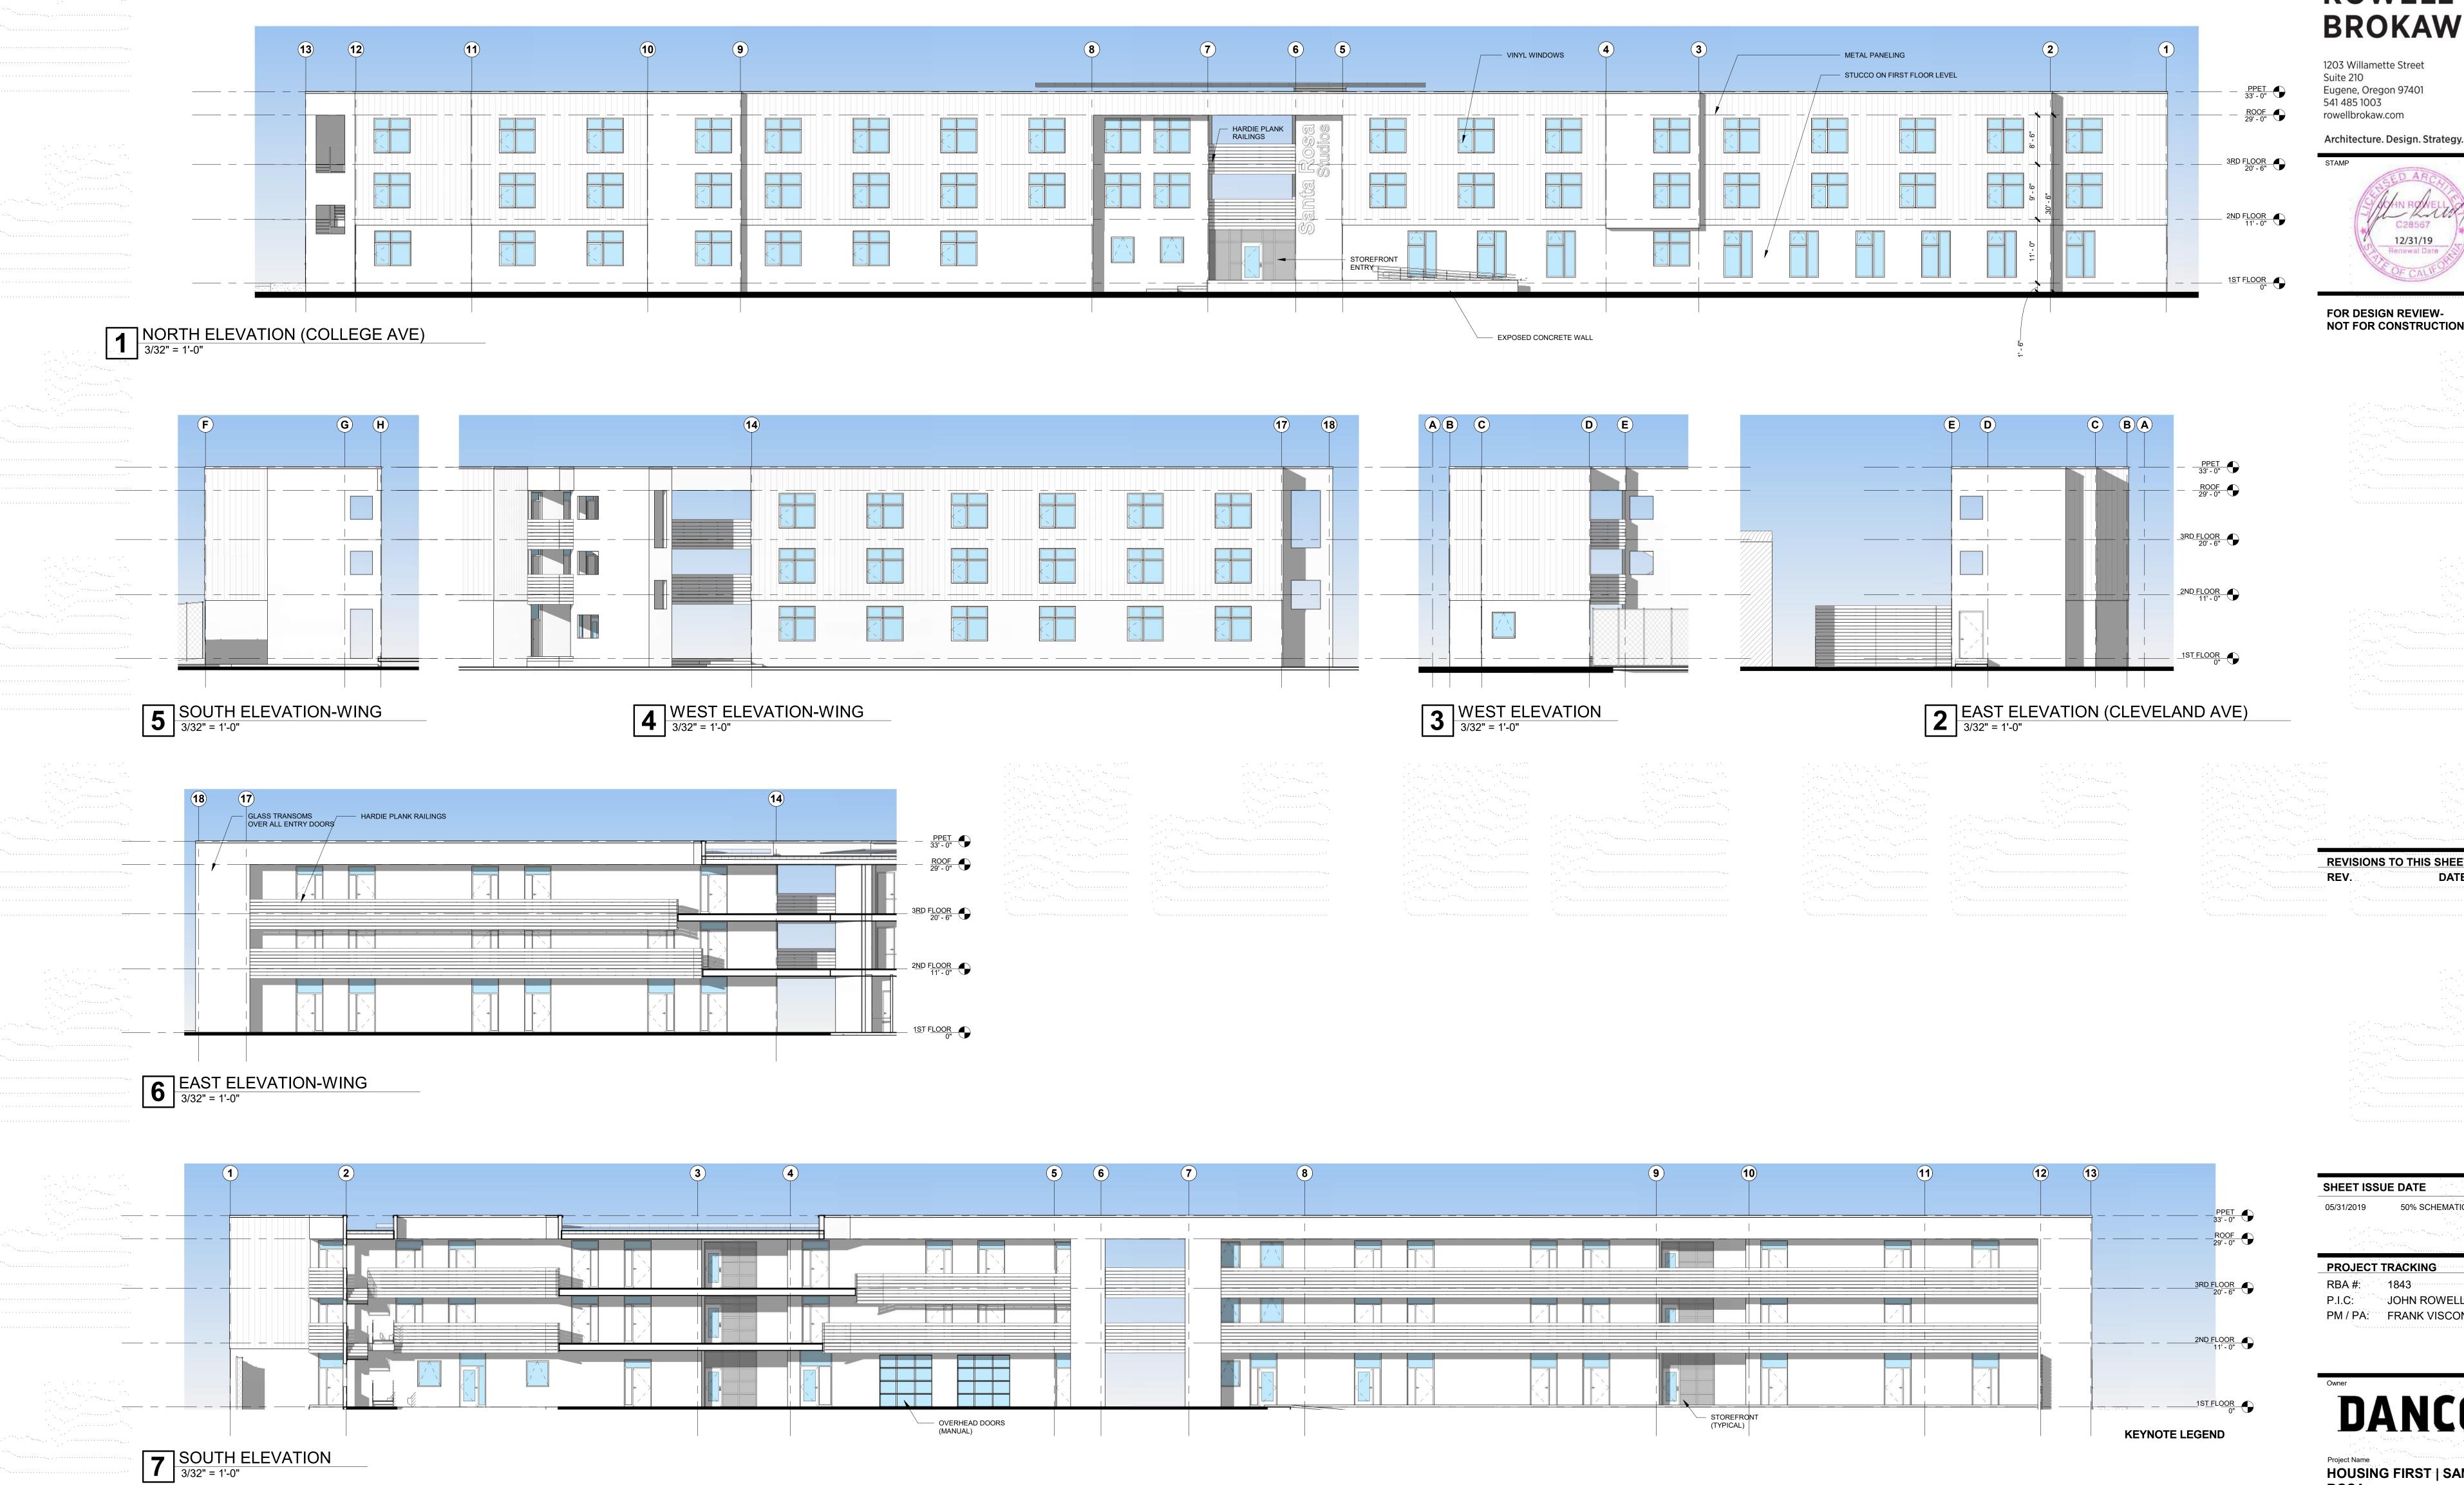
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Project Name
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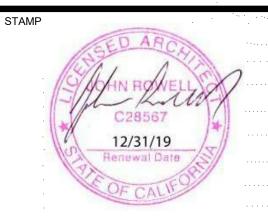
ROOF PLAN

A-114

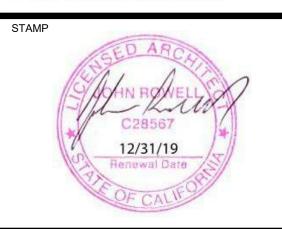

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PROJECT TRACKING

JOHN ROWELL PM / PA: FRANK VISCONTI

HOUSING FIRST | SANTA

Project Address 80 COLLEGE AVENUE SANTA ROSA, CA

BUILDING **ELEVATIONS**


TPO ROOF SYSTEM WITH TAPERED INSULATION PV ARRAY CANTILEVERS PV PANELS ON ROOF Architecture. Design. Strategy - ROOF 29' - 0" VINYL WINDOWS TJI FLOOR SYSTEM WITH GYPCRETE TOPPING HARDIE PLANK GUARDRAIL SYSTEM TJI FLOOR SYSTEM WITH GYPCRETE TOPPING 2ND FLOOR CANTILEVERED WALKWAY DECK SLAB ON GRADE (NOTE FIRST FLOOR IS 18" ABOVE SIDEWALK LEVEL) **—** TYPICAL CROSS SECTION

1/4" = 1'-0" REVISIONS TO THIS SHEET

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Project Address 80 COLLEGE AVENUE SANTA ROSA, CA

BUILDING SECTIONS

SANTA ROSA HOUSING FIRST

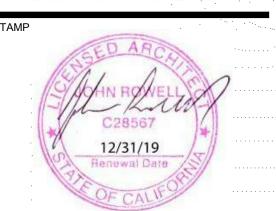ISSUED FOR 50% SCHEMATIC DESIGN / CONCEPT DESIGN REVIEW- 2019-05-31

ISO VIEW TO WEST

ARCATA, CA 95532 TEL: 707-825-1531 CBARNHART@DANCO-GROUP.COM

1203 WILLAMETTE STREET, SUITE 210 **EUGENE OR, 97401** PH: 541-485-1003

JOHN@ROWELLBROKAW.COM FRANK VISCONTI, AIA - ARCHITEC

PROJECT DESCRIPTION:

THE PROPOSED PROJECT IS FOR A NEW 3-STORY BUILDING THAT INCLUDES (54) DWELLING UNITS AND SUPPORTIVE SERVICES ON A DOWNTOWN URBAN SITE.

THERE ARE (53) STUDIO UNITS FOR FORMERLY HOMELESS TENANTS AS PART OF A PERMANENT SUPPORTIVE HOUSING PROGRAM. THERE WILL ALSO BE (1) ONE BEDROOM ON-SITE MANAGER'S DWELLING UNIT. THE FACILITY WILL BE 100% ACCESSIBLE ("UNIVERSAL DESIGN").

IN ADDITION TO THE UNITS, THERE WILL BE OFFICES, MEETING AND THERAPY ROOMS FOR AN ON-SITE SERVICE PROVIDER. AT EACH LEVEL THERE WILL BE A COMMON LAUNDRY ROOM, GYM AND LOUNGE

THERE WILL BE ONE ELEVATOR AND A PAIR OF EGRESS STAIRS ORGANIZED OFF A OPEN EGRESS BALCONY OVERLOOKING A PRIVATE

SITE DEVELOPMENT INCLUDES REPLACEMENT OF SIDEWALKS AND A NEW ACCESS DRIVEWAY WITH PARKING FOR 11 CARS. A COVERED BIKE SHELTER IS PROPOSED AS WELL AS A COVERED TRASH AND RECYCLING ENCLOSURE. THE COURTYARD WILL INCLUDE GARDENING BEDS, LANDSCAPING, AND STORMWATER TREATMENT.

COMPLY WITH ALL PROVISIONS OF THE LATEST ADOPTED CODES AS APPLICABLE PER THE AHJ UPON BUILDING PERMIT APPROVAL:

2016 CA BUILDING CODE, TITLE 24, PART 2 2016 CA RESIDENTIAL CODE, TITLE 24, PART 2.5 2016 CA ELECTRICAL CODE, TITLE 24, PART 3 2016 CA MECHANICAL CODE, TITLE 24, PART 4 2016 CA PLUMBING CODE, TITLE 24, PART 5 2016 CA ENERGY CODE, TITLE 24, PART 6 2016 CA FIRE CODE, TITLE 24, PART 9 2016 CA GREEN BUILDING STANDARDS CODE, TITLE 24,

2016 CA REFERENCED STANDARDS CODE, TITLE 24,

APPLICABLE CODES AND REGULATIONS OF THE CITY OF SANTA ROSA

CONSTRUCTION TYPE: TYPE V-A **OCCUPANCY TYPE:** APARTMENTS - GROUP R-2 BUSINESS COMMON AREAS - GROUP B AND A3

STRUCTURAL SYSTEMS: CONCRETE SLAB-ON-GRADE, WOOD LIGHT FRAME, WITH STRUCTURAL STEEL SECTIONS, PREMANUFACTURED TRUSSES AND/OR

GEOTECHNICAL REPORT: ENGINEERING GEOLOGIC FOUNDATION AND SOILS REPORT APPLICABLE TO THIS PROJECT MUST BE FURNISHED BY OWNER. THE RECOMMENDATIONS INCLUDED IN THAT REPORT MUST BE ADHERED TO, WITH SPECIAL ATTENTION TO LISTED LIMITATIONS AND FOR FOUNDATION DESIGN, TESTING AND INSPECTION

AUTOMATIC FIRE SPRINKLERS: INCLUDED FOR ENTIRE BUILDING (DESIGN BY OTHERS) IN ACCORDANCE WITH CBC 903.3.1.2. NFPA 13R AS AMENDED IN CBC CH. 35.

PROVIDE UL & CA SFM LISTED SMOKE DETECTION & NOTIFICATION SYSTEM PER NFPA 72. SMOKE ALARMS SHALL HAVE PRIMARY POWER FROM PERMANENT BUILDING WIRING AND EQUIPPED WITH A 10 YEAR LIFETIME BATTERY BACKUP. THE ALARM DEVICES SHALL BE INTERCONNECTED SO ACTUATION OF ONE ALARM WILL ACTIVATE ALL ALARMS IN THAT DWELLING UNIT. INSTALL ALARMS IN THE FOLLOWING LOCATIONS PER MANUFACTURER'S WRITTEN INSTRUCTIONS:

1). IN EACH SLEEPING ROOM. 2). OUTSIDE EACH SEPARATE SLEEPING AREA IN THE IMMEDIATE VICINITY. 3. ON EACH ADDITIONAL STORY OF THE DWELLING AND HABITABLE ATTICS BUT NOT INCLUDING CRAWL SPACES OR UNINHABITABLE ATTICS.

CARBON MONOXIDE ALARMS: PROVIDE CARBON MONOXIDE ALARMS PER OFFICE OF THE STATE FIRE MARSHALL. THESE MAY BE IN THE FORM OF COMBINATION WITH SMOKE ALARMS OR AS SEPARATE UNITS. INSTALL PER MANUFACTURER'S WRITTEN INSTRUCTIONS.

PARCEL/ZONING INFORMATION:

PROJECT TITLE:

(PER 2009-002)

SANTA ROSA HOUSING FIRST 80 COLLEGE AVENUE, SANTA ROSA CALIFORNIA

APN: 010-121-020, 024, 025 TOTAL PARCEL AREA: 0.983 ACRES (42,850 SF) JURISDICTION: CITY SANTA ROSA

FIRE DISTRICT: CITY OF SANTA ROSA **ZONING:** CG (GENERAL COMMERCIAL) - SA (STATION

HOUSING CODE: IN ACCORDANCE WITH CA GOV. CODE

DWELLING UNITS: 53 STUDIO UNITS, 1 ONE-BEDROOM UNIT (FOR RESIDENT MANAGER)

DENSITY (GROSS): 30 UNITS PER ACRE LOT COVERAGE: 46% INCLUDING COURTYARD TOTAL COMBINED LOT AREA = 42,850 SF

-CG ZONE ALLOWS 30 UNITS/ACRE -SA ZONE/SUPPLEMENTAL DENSITY BONUS ALLOWS FOR 80% DENSITY BONUS TO 54 UNITS/ACRE

-REQUESTING PARKING CONCESSION FOR 11 SPACES (18 REQUIRED IN STATION AREA PER CODE @ .3/UNIT)

MAX ZONING HEIGHT: CG - 55 FEET PROPOSED HEIGHT: 33 FEET (CONTINGENT ON UNDERGROUNDING HIGH VOLTAGE OVERHEAD CABLES AND ELIMINATING UTILITY POLES ON COLLEGE AVENUE) PROPOSED STORIES: 3 STORIES

1ST FLOOR: 8,750 + 3,520 COVERED AREA 2ND FLOOR: 8,780 + 3,490 COVERED AREA 3RD FLOOR: 8,800 + 3,575 COVERED AREA TOTAL: **26,330** + 10,585 COVERED WALKWAY = **36,915 SF**

SPECIAL ZONE DESIGNATIONS: COASTAL ZONE: NO 100 YR FLOOD ZONE: NO TIGER SALAMANDER ZONE: NO SRA / HIGH FIRE ZONE: NO WETLANDS WPCZ: NO URBAN SERVICES: YES

DEFERRED SUBMITTALS: 1. ELEVATOR (BY OTIS ELEVATOR) 2. SOLAR PANELS (BY ROGER SOLAR) 3. TRANSFORMER (BY PG&E)

DRAWING INDEX			
SHEET NUMBER	SHEET NAME	SHEET ISSUE DATE:	CURRENT REVISION ISSUED:
GENERAL		the state of the s	1
GENERAL G-001	COVER	05/31/2019	No
ARCHITE	 	03/31/2019	INO
A-100	ARCHITECTURAL SITE PLAN	05/13/2019	No
A-111	1ST FLOOR PLAN	05/31/2019	No
A-112	2ND FLOOR PLAN	05/31/2019	No
A-113	3RD FLOOR PLAN	05/13/2019	No
A-114	ROOF PLAN	05/31/2019	No
A-201	BUILDING ELEVATIONS	05/31/2019	No
A-211	BUILDING SECTIONS	05/31/2019	No

ROWELL

BROKAW

Eugene, Oregon 9740

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FOR DESIGN REVIEW-

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SHEET ISSUE DATE

50% SCHEMATIC DESIGN

Project Address 80 COLLEGE AVENUE SANTA ROSA, CA

COVER

ISO VIEW TO EAST