


NEIGHBORHOOD CONTEXT MAP

NOT TO SCALE








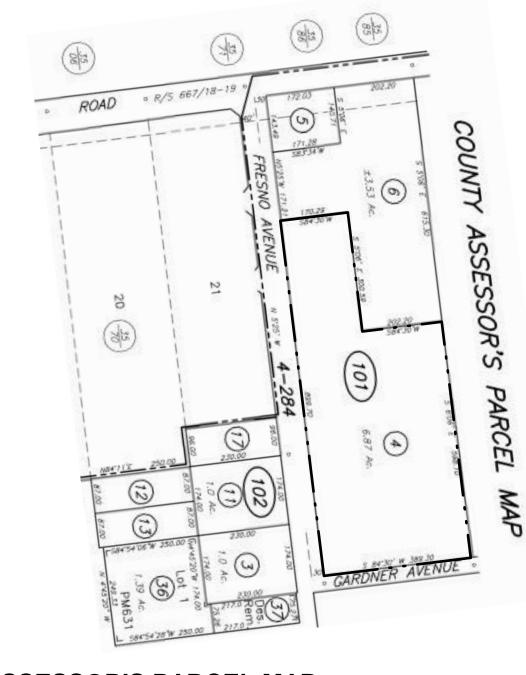

ASSESSOR'S PARCEL MAP



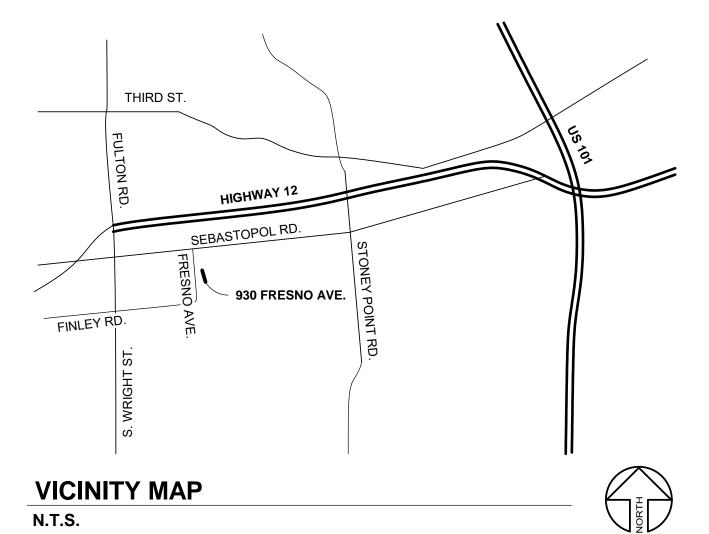

SITE ANALYSIS MAP

NOT TO SCALE



### CHERRY RANCH

ARCHITECTS
APRIL 24, 2020



UNIT A1 - FRONT ELEVATION

1/8" = 1'-0"



UNIT A1 - SIDE ELEVATION, TYP.

1/8" = 1'-0"



UNIT A1 - REAR ELEVATION

1/8" = 1'-0"




UNIT A2 - FRONT ELEVATION

1/8" = 1'-0"



**UNIT A3 - FRONT ELEVATION** 

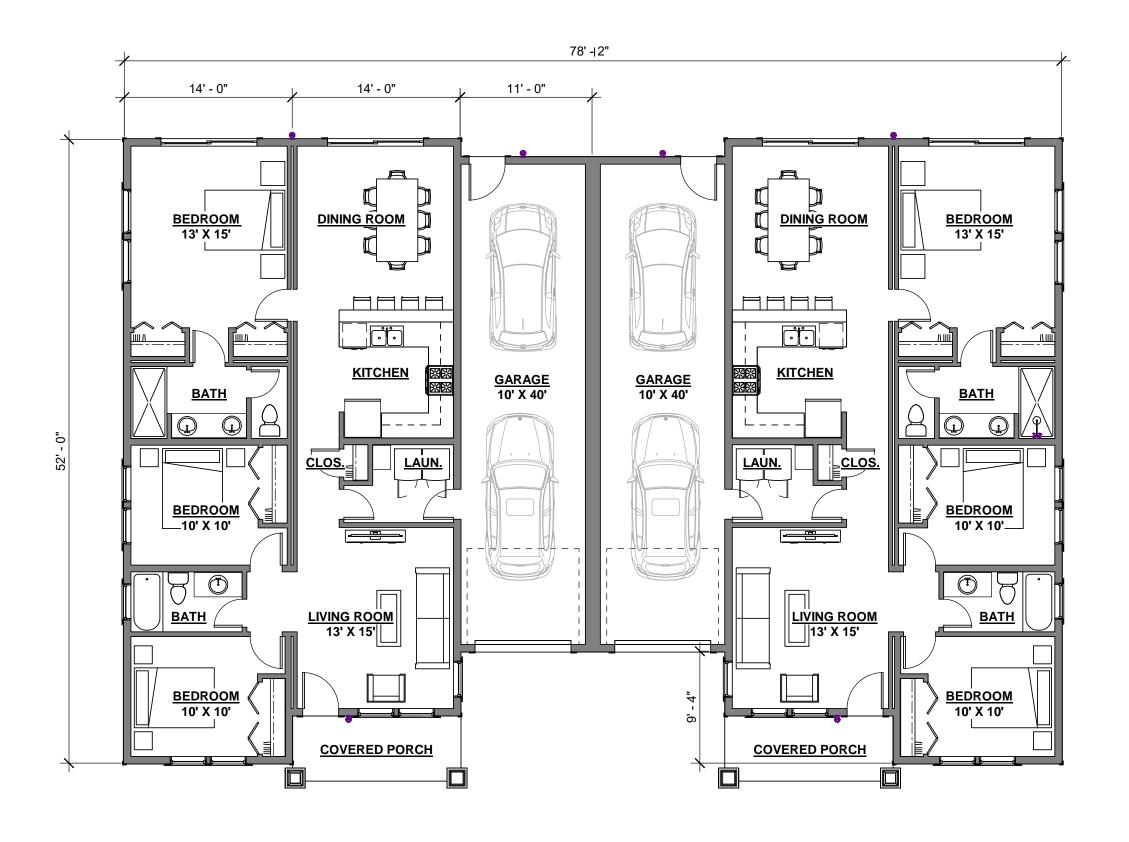

**UNIT A - FLOOR CONCEPT** 





UNIT B1- FRONT ELEVATION

1/8" = 1'-0"



UNIT B1 - SIDE ELEVATION, TYP

1/8" = 1'-0"




UNIT B1 - REAR ELEVATION, TYP

1/8" = 1'-0"




UNIT B2 - FRONT ELEVATION

1/8" = 1'-0"

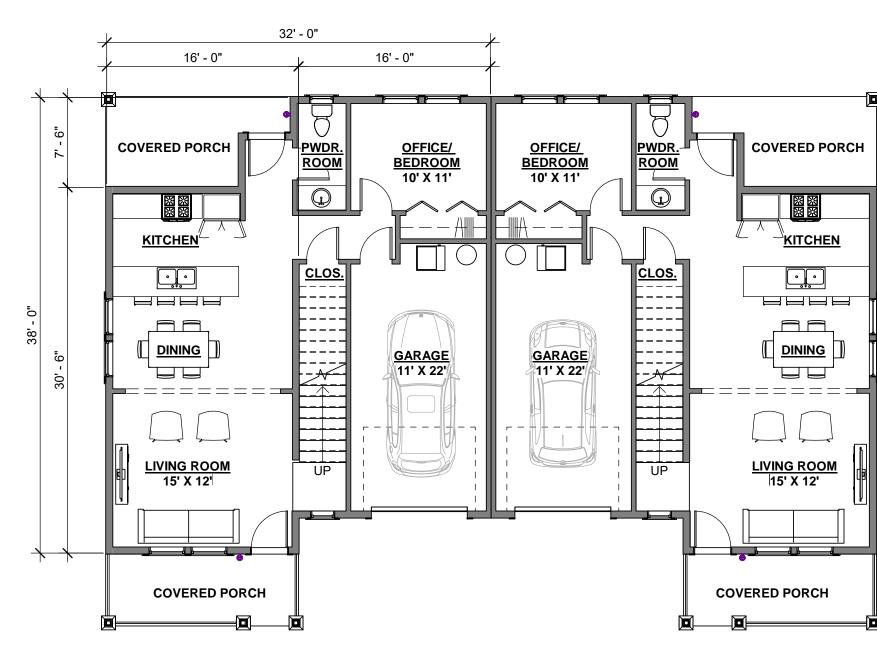

UNIT B - FIRST FLOOR CONCEPT

1/8" = 1'-0"

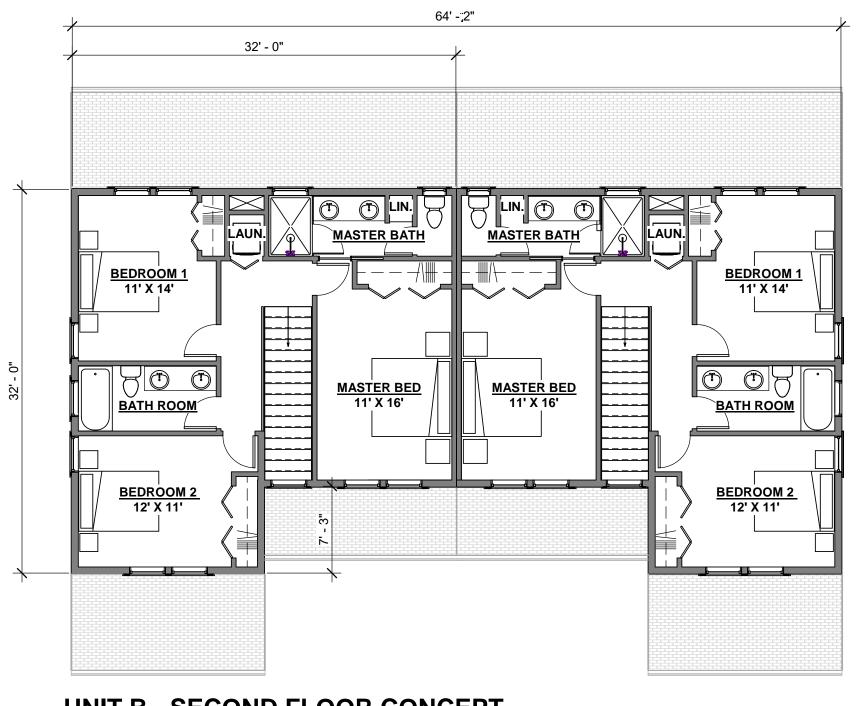

UNIT B - SECOND FLOOR CONCEPT



UNIT B3- FRONT ELEVATION

1/8" = 1'-0"





UNIT C1 - FRONT ELEVATION

1/8" = 1'-0"



UNIT C1 - SIDE ELEVATION, TYP

1/8" = 1'-0"




UNIT C1 - REAR ELEVATION, TYP

1/8" = 1'-0"




UNIT C2 - FRONT ELEVATION

1/8" = 1'-0"

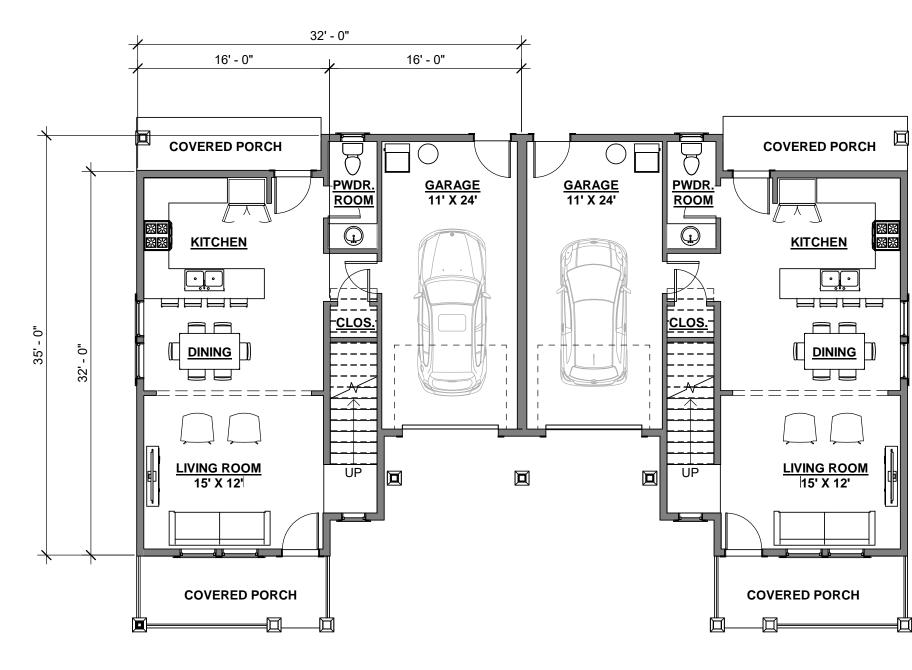

UNIT C - FIRST FLOOR CONCEPT

1/8" = 1'-0"

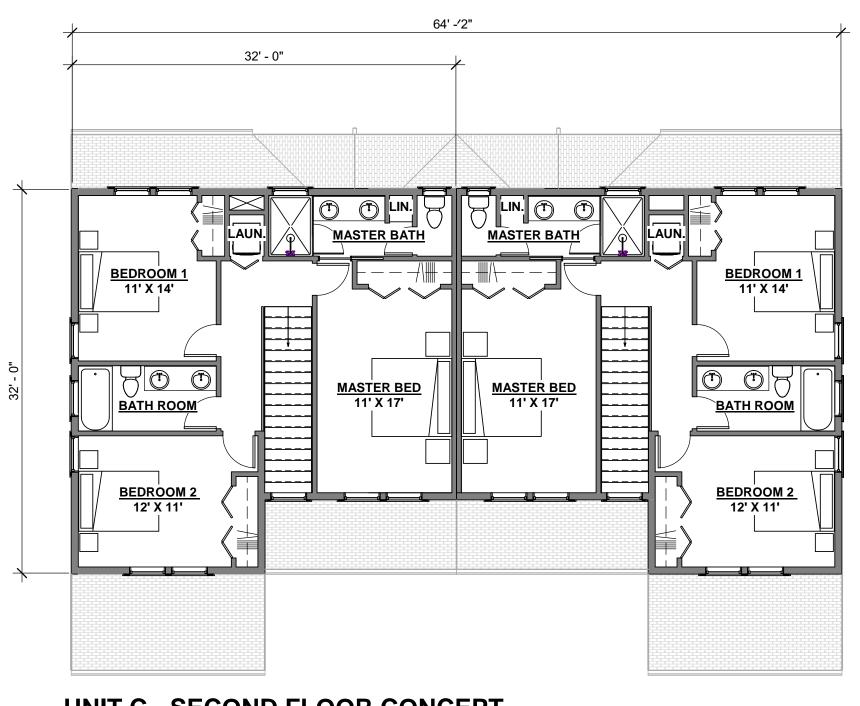

UNIT C - SECOND FLOOR CONCEPT



UNIT C3 - FRONT ELEVATION

1/8" = 1'-0"





UNIT C4- FRONT ELEVATION

1/8" = 1'-0"



UNIT C4 - SIDE ELEVATION, TYP

1/8" = 1'-0"




UNIT C4 - REAR ELEVATION, TYP

1/8" = 1'-0"




UNIT C5 - FRONT ELEVATION

1/8" = 1'-0"

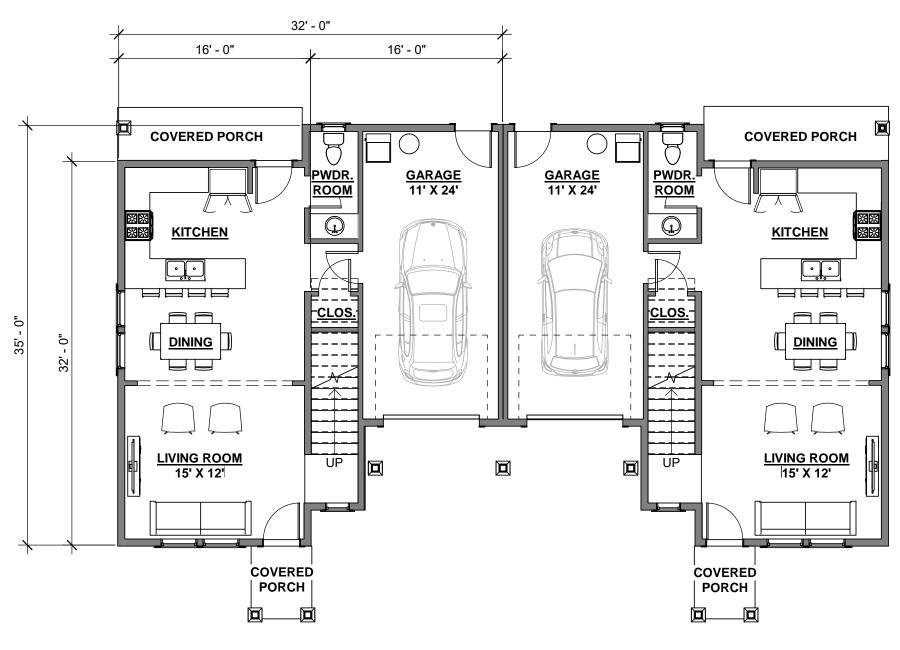


UNIT C - FIRST FLOOR CONCEPT


1/8" = 1'-0"

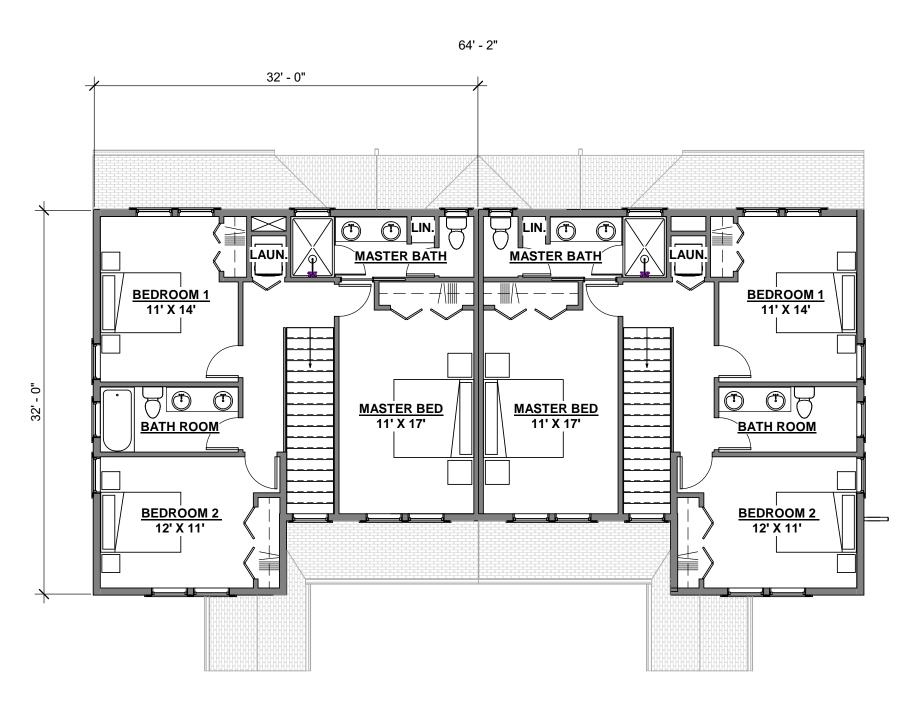


UNIT C - SECOND FLOOR CONCEPT



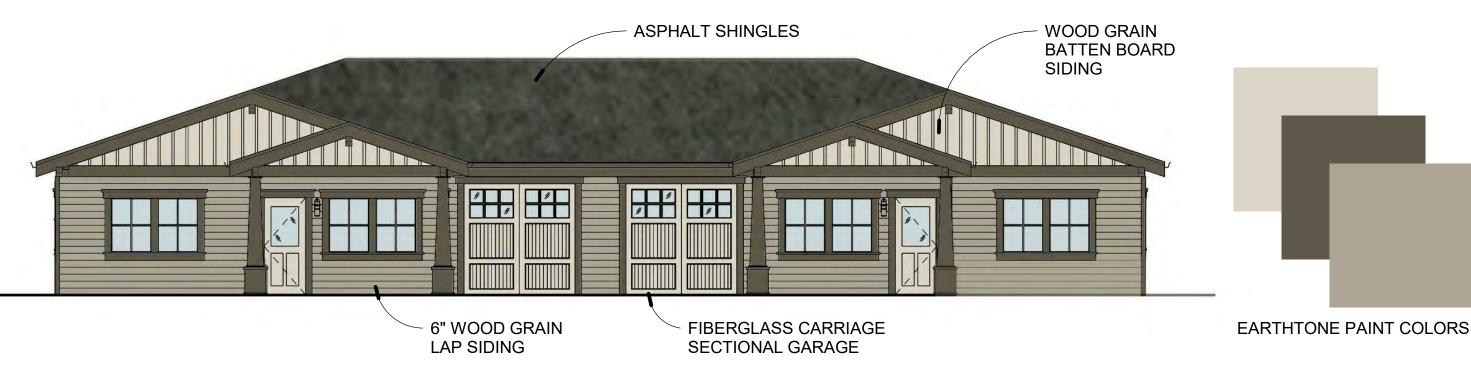

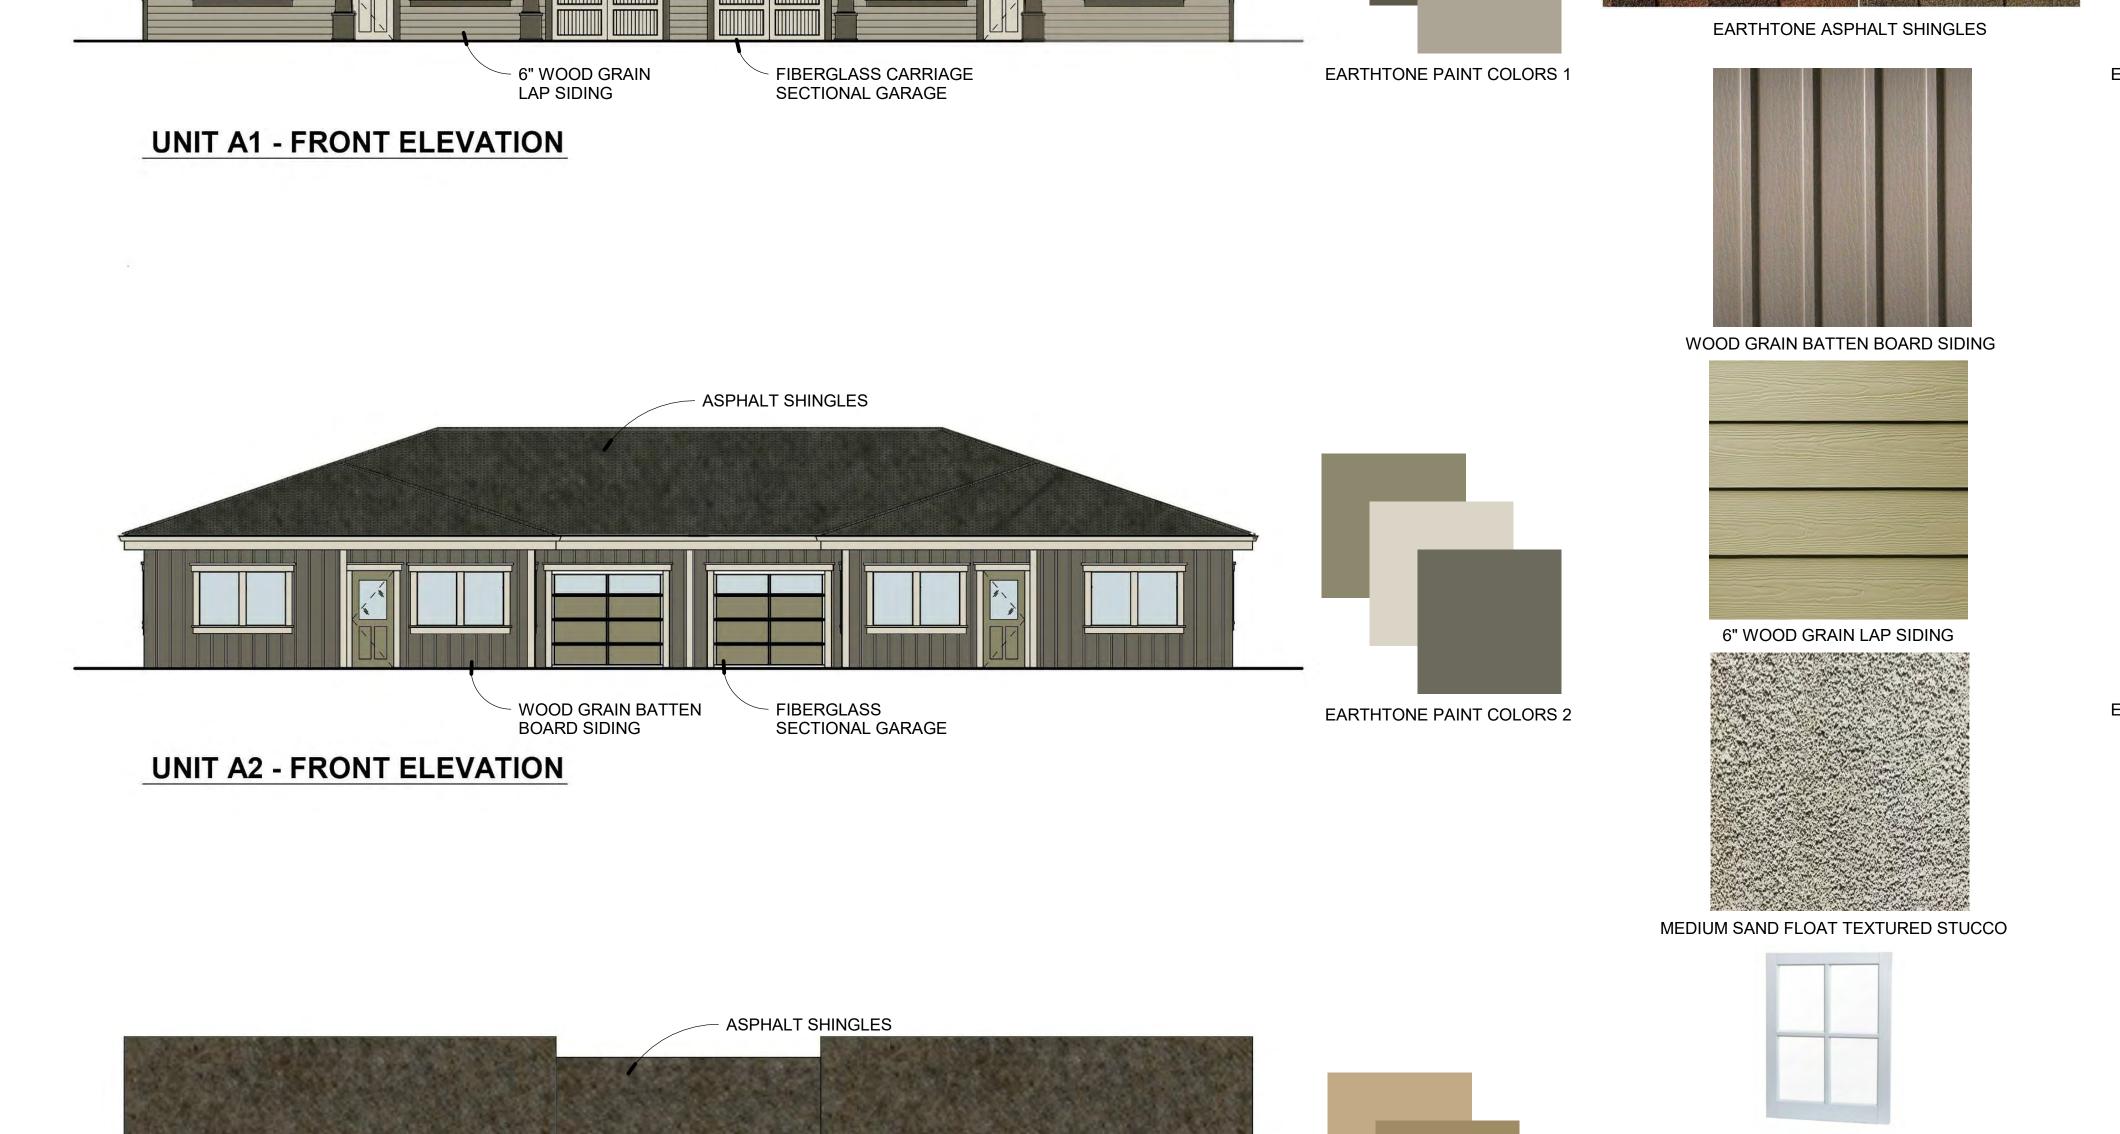

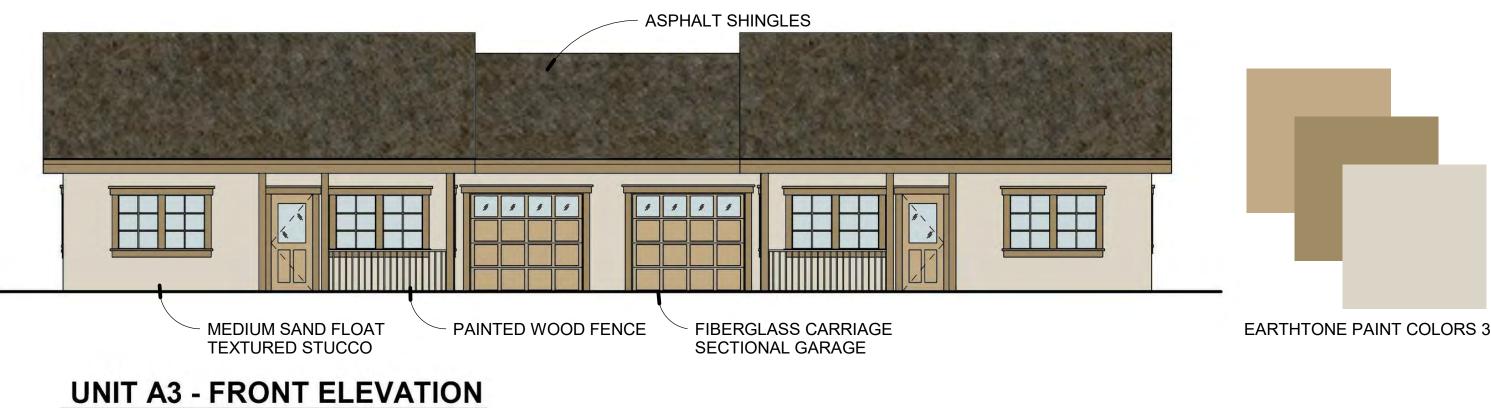





OUTDOOR WALL BRACKET LIGHT

WOOD PICKET FENCE

930 FRESNO AVE





STREET ELEVATION - INTERNAL




STREET ELEVATION - INTERNAL





STREET ELEVATION - FRESNO AVENUE



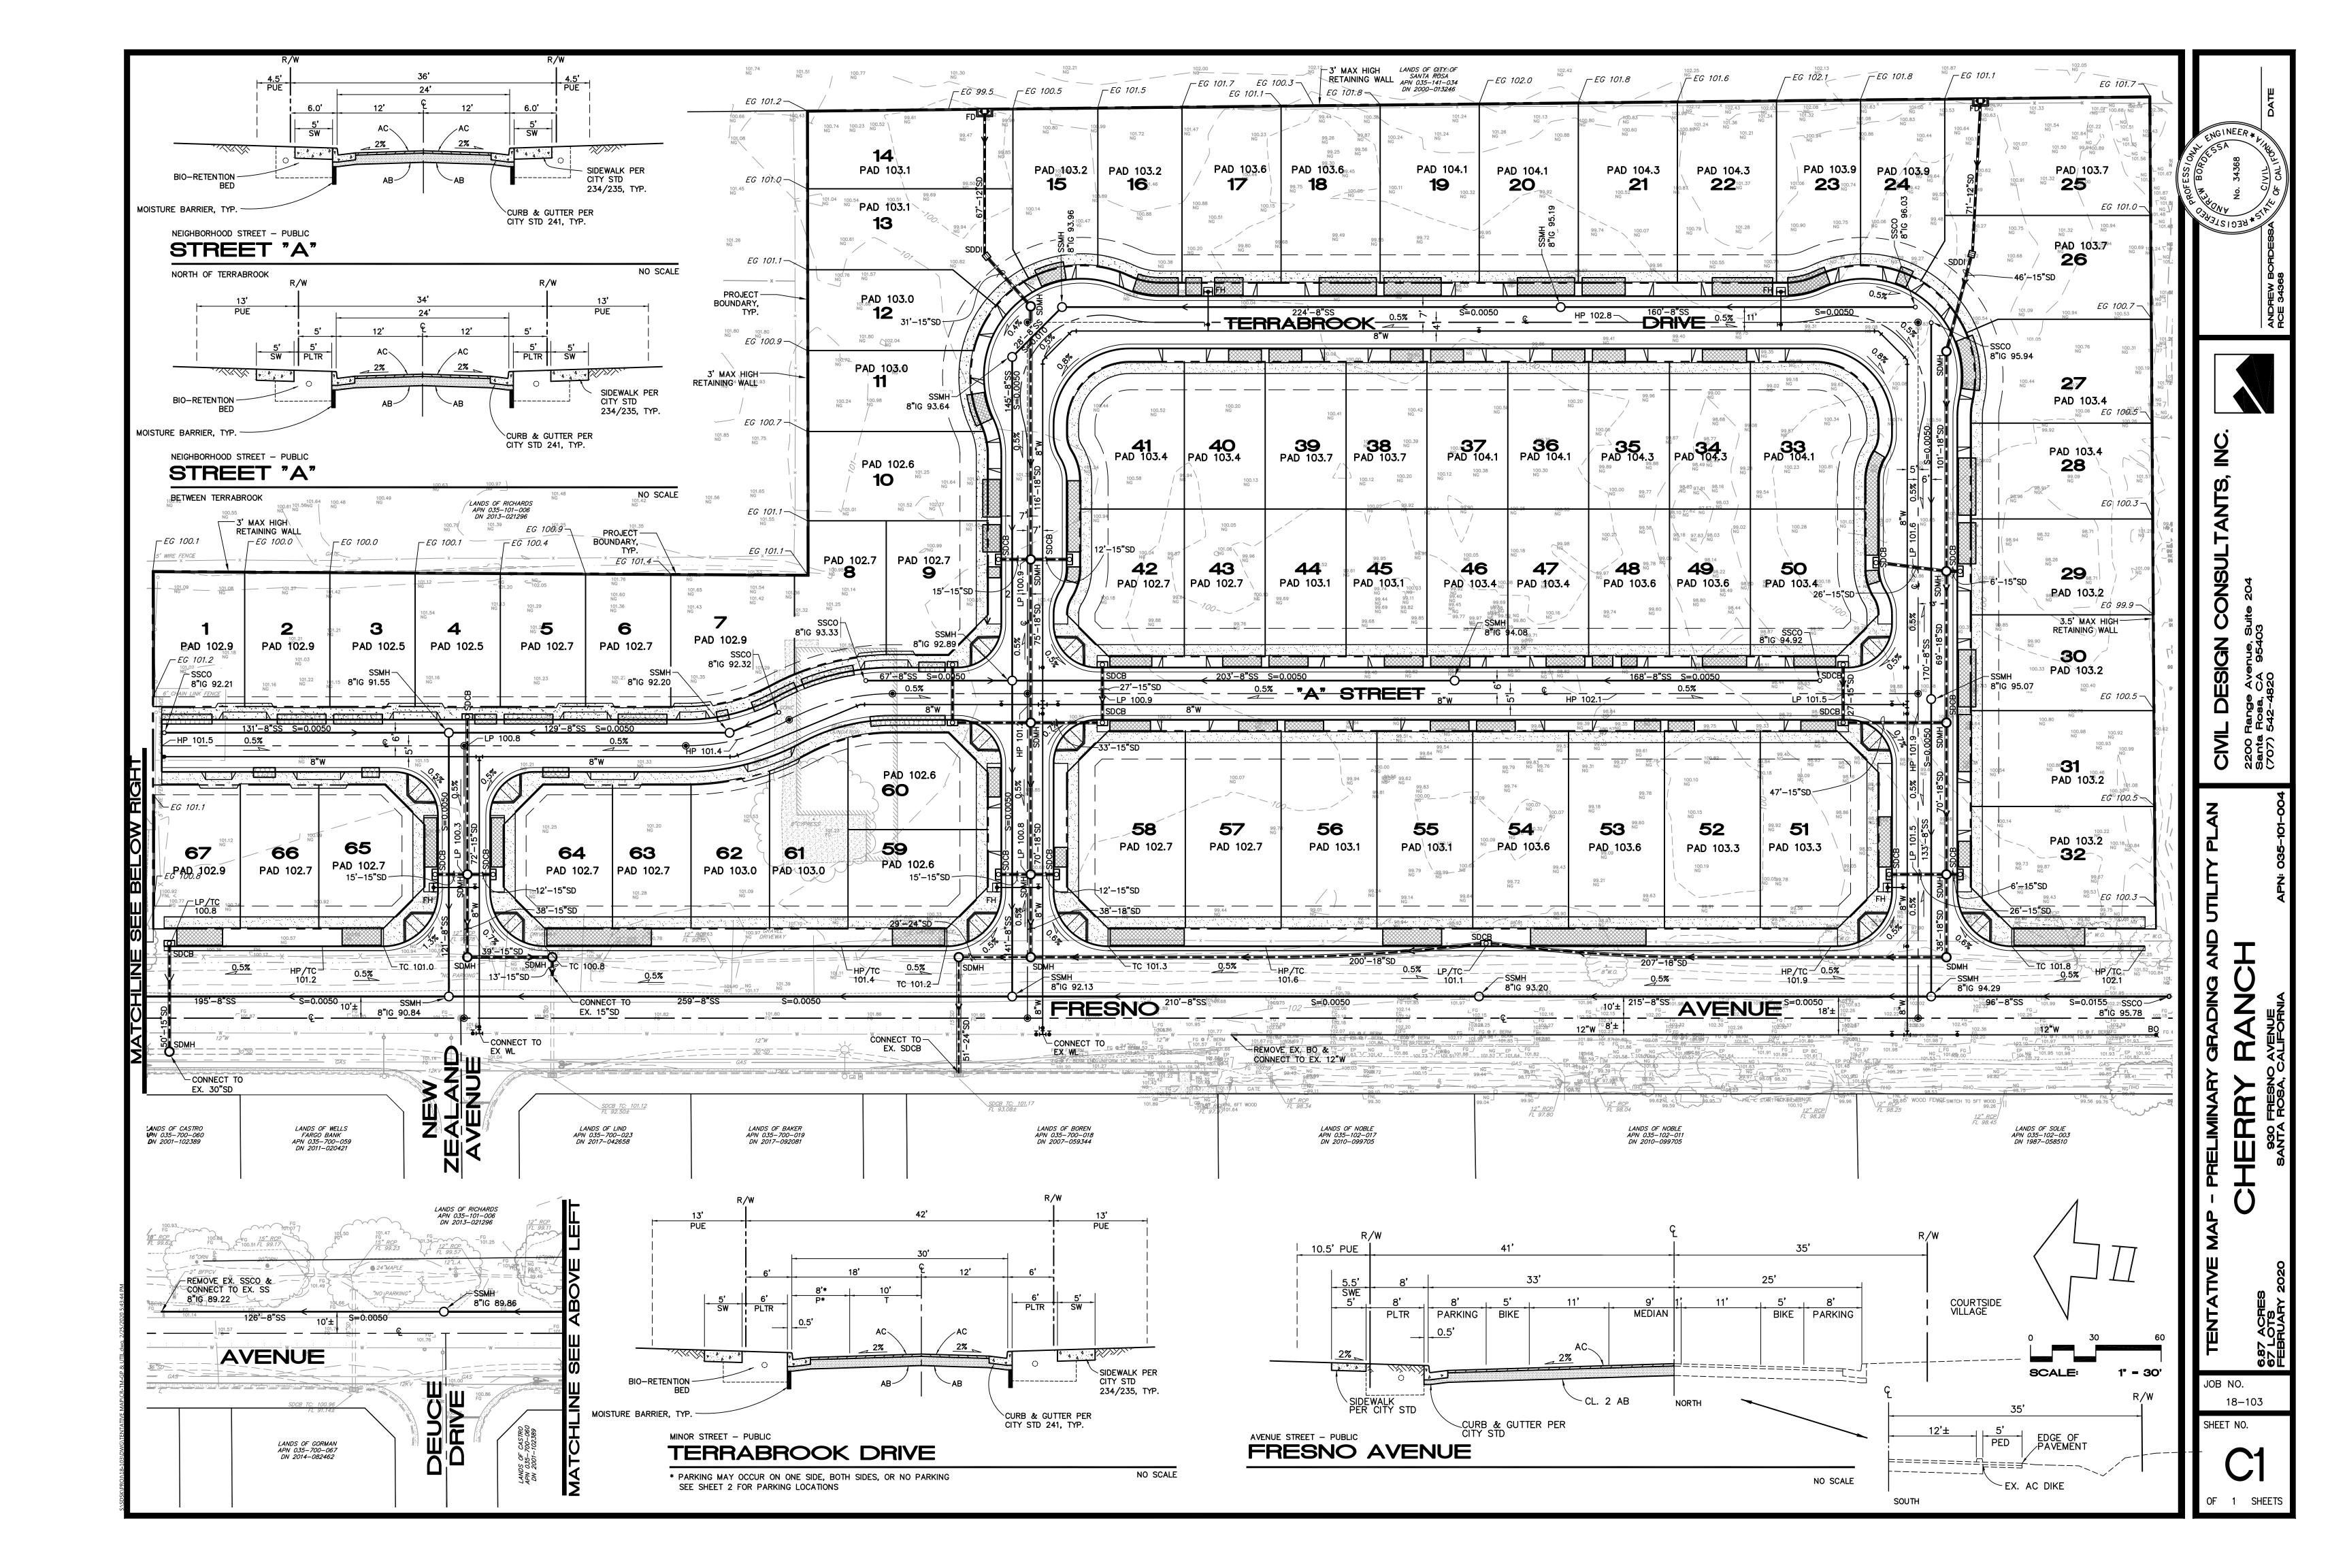

GOOD NEIGHBOR FENCE WITH 2'-0" LATTICE SEE DETAIL 2/L-2

6'-0" GOOD NEIGHBOR FENCE SEE DETAIL 3/L-2

PRIVACY FENCE WITH 2'-0" LATTICE SEE DETAIL I/L-2

PLANNING+ LANDSCAPE ARCHITECTURE

DESIGN REVIEW LANDSCAPE ILLUSTRATIVE PLAN CHERRY RANCH SUBDIVISION 940 FRESNO AVENUE, SANTA ROSA, CALIFORNIA CRC DEVELOPMENT, LLC.

PLANTING LEGEND

FRESNO AVENUE.

BOTANICAL NAME COMMON NAME ACER R.'OCTOBER GLORY' RED MAPLE STRAWBERRY TREE ARBUTUS UNEDO BETULA PENDULA QUERCUS AGRIFOLIA CEANOTHUS 'DARK STAR' CHONDROPETALUM TEC. SMALL CAPE RUSH KARL FORESTER CALAMAGROSTIS ACU. CALLISTEMON.'LITTLE-JOHN'BOTTLEBRUSH CARPINTERIA CALIFORNICA BUSH ANEMONE CISTUS X HYBRID WHITE ROCK ROSE EUPHORBIA

TYPE C3 TYPE C3 R

LOMANDRA

DEER GRASS

DWARF OLIVE

CLEMANTIS

ARTEMESIA

FESCUE

LANTANA

CATMINT

YARROW

BERKELEY SAGE

MONKEY FLOWER

IDAHO FESCUE

GREY SEDGE

MYOPORUM

'EMERALD CARPET'

WHITE CARPET ROSE


HUNTINGTON CARPET I

EUPHORBIA CHARCAIS HETEROMELES ARBUTIFOLIA TOYON LAVANDULA A. 'MUNSTEAD' LOMANDRA LONGIFOLIA MUHLENBERGIA CAPILLARIS DAWN MUHLY MUH RIG MUHLENBERGIA RIGEN OLEA E. 'MONTRIA'

PHRMIUIM 'YELLOW WAVE' NEW ZELAND FLAX ROSMARINUS 'SPICE ISLAND' ROSEMARY RHA EVE RHAMNUS CAL. 'EVECASE CAL. COFFEE BERRY CLEMANTIS ARMANDII HARDENBERGIA VIOLACEA LILAC VINE

GROUNDCOVERS ARC EME ARCTOSTAPHYLOS ARTEMESIA CALIFORNICA FESTUCA CALIFORNICA LAN MON LANTANA MONTEVIDENSIS MYO PRO MYOPORUM PROSTRATE NEP FAS NEPETA X FAASSENII ROS CAR ROSA. 'CARPET ROSE' ROS HUN ROSMARINUS

DRAINAGE SWALES HYDROSEED ACHILLEA MILLEFOLIUM CAREX TUMULICOLA FESTUCA IDAHONESIS JUNCUS PATENS MIMULUS AURANTIACUS WILD FLOWER & GRASS MIX

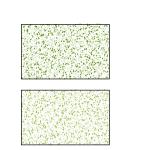

COMMON AREA PLANTING

PRIVATE YARD

BIO RETENTION AREAS.

GRAPHIC SCALE (IN FEET) I INCH = 30 FT

PACIFIC COAST SEED 553 HAWTHORN PLACE LIVERMORE, CA. 94550 925-373-4417 DATE: SHEET NUMBER :

03/27/2020 0 F 2

PROJECT 19-055.01 NUMBER:

TYPE C3

QTY REMARKS/SPACING

SINGLE TRUNK

MULTI TRUNK

MULTI TRUNK SINGLE TRUNK SINGLE TRUNK SINGLE TRUNK SINGLE TRUNK SINGLE TRUNK

SINGLE TRUNK

6' O.C. SPACING

3' O.C. SPACING

4' O.C. SPACING

5' O.C. SPACING

4' O.C. SPACING

3' O.C. SPACING

6' O.C. SPACING

2' O.C. SPACING

3' O.C. SPACING

6' O.C. SPACING

4' O.C. SPACING

5' O.C. SPACING

4' O.C. SPACING

3' O.C. SPACING

6' O.C. SPACING

TRAIN TO FENCE

6' O.C. SPACING

4' O.C. SPACING

18" O.C. SPACING

6' O.C. SPACING

6' O.C. SPACING

3' O.C. SPACING

4' O.C. SPACING

5' O.C SPACING

2' O.C. SPACING

2' O.C. SPACING

2' O.C. SPACING

2' O.C. SPACING

18" O.C. SPACING

TRAIN TO TRELLIS

3' O.C. SPACING

TYPE CI

5 GAL.

5 GAL.

5 GAL.

5 GAL.

5 GAL.

5 GAL

5 GAL.

I GAL.

I GAL.

I GAL.

I GAL.

I GAL

I GAL.

4" POTS

ACHILLEA MILLEFOLIUM

MIMULUS AURANTIACUS

CAREX TUMULICOLA

JUNCUS PATENS

FESTUCA IDAHONESIS

YARROW

BERKELEY SAGE

IDAHO FESCUE

GREY SEDGE MONKEY FLOWER

#### PLANTING LEGEND

	ABBREV.	BOTANICAL NAME	COMMON NAME	WOCULS	SIZE	QTY REMARKS/SPACING	ABBREV.	BOTANICAL NAME	COMMON NAME	WOCULS	SIZE
	TREES										
	ACE RUB	ACER R.'OCTOBER GLORY'	RED MAPLE	Μ	24" BOX	SINGLE TRUNK	OLE LIL	OLEA E. 'MONTRIA'	DWARF OLIVE	L	5 GAL.
	ARB UNE	ARBUTUS UNEDO	STRAWBERRY TREE	L	24" BOX	MULTI TRUNK	PHO YEL	PHRMIUIM 'YELLOW WAVE'	NEW ZELAND FLAX	L	5 GAL.
	BEN PEN	BETULA PENDULA	BIRCH	Μ	24" BOX	MULTI TRUNK	ROS SPI	ROSMARINUS 'SPICE ISLAND'	ROSEMARY	L	5 GAL.
_	GIN BIL	GINKO BIL.'GREEN VASE'	GINKO	L	24" BOX	SINGLE TRUNK	RHA EVE	RHAMNUS CAL.'EVECASE	CAL. COFFEE BERRY	L	5 GAL.
	LAG NAT	LAGERSTROMIA INDICA	CREPE MYRTLE	L	24" BOX	SINGLE TRUNK					
	LAU NOB	LAURUS NOBILIS.'SARATOGA	'BAY LAUREL	L	24" BOX	SINGLE TRUNK	VINES				
	MAL SPP	MALUS SPP.	FLOWERING CHERRY	Μ	I5 GAL.	SINGLE TRUNK	CLE ARM	CLEMANTIS ARMANDII	CLEMANTIS	Μ	5 GAL.
	PYR CAL	PYRUS CAL.'ARISTOCRAT'	FLOWERING PEAR	M	24" BOX	SINGLE TRUNK	HAR VIO	HARDENBERGIA VIOLACEA	LILAC VINE	Μ	5 GAL.
L	— QUE ARG	QUERCUS AGRIFOLIA	COAST LIVE OAK	VL	24" BOX	SINGLE TRUNK					
							GROUNDCO	VERS			
	SHRUBS						ARC EME	ARCTOSTAPHYLOS	'EMERALD CARPET'	L	I GAL.
	CEA DAR	CEANOTHUS 'DARK STAR'	CEANOTHUS	L	5 GAL.	6' O.C. SPACING	ART CAL	ARTEMESIA CALIFORNICA	ARTEMESIA	L	I GAL.
	CHO TEC	CHONDROPETALUM TEC.	SMALL CAPE RUSH	L	5 GAL.	3' O.C. SPACING	FES CAL	FESTUCA CALIFORNICA	FESCUE	L	I GAL.
	CAL ACU	CALAMAGROSTIS ACU.	KARL FORESTER	L	5 GAL.	3' O.C. SPACING	LAN MON	LANTANA MONTEVIDENSIS	LANTANA	L	I GAL.
	CAL LIJ	CALLISTEMON.'LITTLE-JOHN	I'BOTTLEBRUSH	L	5 GAL.	4' O.C. SPACING	MYO PRO	MYOPORUM PROSTRATE	MYOPORUM	L	I GAL.
	CAR CAL	CARPINTERIA CALIFORNICA	BUSH ANEMONE	L	5 GAL.	5' O.C. SPACING	NEP FAS	NEPETA X FAASSENII	CATMINT	L	I GAL.
	CIS HYB	CISTUS X HYBRID	WHITE ROCK ROSE	L	5 GAL.	4' O.C. SPACING	ROS CAR	ROSA.'CARPET ROSE'	WHITE CARPET ROSE	L	I GAL.
	EUP CHA	EUPHORBIA CHARCAIS	EUPHORBIA	L	5 GAL.	3' O.C. SPACING	ROS HUN	ROSMARINUS	HUNTINGTON CARPET	L	I GAL.
	HET ARB	HETEROMELES ARBUTIFOLIA	TOYON	L	5 GAL.	6' O.C. SPACING					
	LAV MUN	LAVANDULA A.'MUNSTEAD'	LAVENDER	L	5 GAL.	2' O.C. SPACING	DRAINAGE	SWALES HYDROSEED			
	LOM BZE	LOMANDRA LONGIFOLIA	LOMANDRA	L	5 GAL.	3' O.C. SPACING		WILD FLOWER & GRASS MIX		L	PACIFIC C
	MUH CAP	MUHLENBERGIA CAPILLARIS	DAWN MUHLY	L	5 GAL.	6' O.C. SPACING					553 HAWT
	MUH RIG	MUHLENBERGIA RIGEN	DEER GRASS	L	5 GAL.	4' O.C. SPACING					LIVERMOR
											005 777 /

QTY REMARKS/SPACING

5' O.C. SPACING 4' O.C. SPACING

3' O.C. SPACING

6' O.C. SPACING

TRAIN TO FENCE

6' O.C. SPACING

4' O.C. SPACING

18" O.C. SPACING

6' O.C. SPACING

6' O.C. SPACING

3' O.C. SPACING

4' O.C. SPACING

5' O.C SPACING

2' O.C. SPACING

2' O.C. SPACING

2' O.C. SPACING

2' O.C. SPACING

18" O.C. SPACING

TRAIN TO TRELLIS

I GAL.

I GAL.

I GAL.

I GAL.

4" POTS

PACIFIC COAST SEED

553 HAWTHORN PLACE

LIVERMORE, CA. 94550

925-373-4417

"I HAVE COMPLIED WITH THE CRITERIA OF THE ORDINANCE AND APPLIED


03/09/2020

MICHAEL A. COOK

FENCE LEGEND

GOOD NEIGHBOR FENCE WITH 2'-0" LATTICE SEE DETAIL 2/L-2 SEE DETAIL 3/L-2

 $\checkmark$ ALIGN

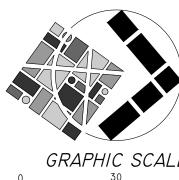

GRAPHIC SCALE

I INCH = 30 FT

SHEET L-1 OF 2 NUMBER : PROJECT 19-055.01 NUMBER:

03/09/2020

l' = 30'

FΜ

MAC

Michael A. Cook PLA 5123 Exp. 11/30/2020

PLANNING+

LANDSCAPE

ARCHITECTURE

5128 DUPONT DRIVE SANTA ROSA CALIFORNIA 95409 707.545.5235 WWW.INTEGRAPLA.COM

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CRC DEVELOPMENT LLC

PROJECT:

<u>CLIENT:</u>

CHERRY RANCH

930 FRESNO AVENUE SANTA ROSA, CA. 94507

SUBDIVISION

APN #035-101-004

364 4IST STREET OAKLAND, CA 94609

REVISIONS:

DATE:

SCALE:

DRAWN BY:

CHECKED BY:

SHEET DESCRIPTION:

DESIGN REVIEW

CONCEPTUAL LANDSCAPE PLAN

MWELO STATEMENT

THEM FOR THE EFFICIENT USE OF WATER IN THE PLANTING PLAN"

DATE

REGISTERED LANDSCAPE ARCHITECT #5123

6'-0" GOOD NEIGHBOR FENCE PRIVACY FENCE WITH 2'-0" LATTICE SEE DETAIL I/L-2

PLANTING AREAS

CENTER LINE PLANTING AREA **RADIUS** TYP. TYPICAL


(IN FEET)

FLOWERING PEAR



STRAWBERRY TREE



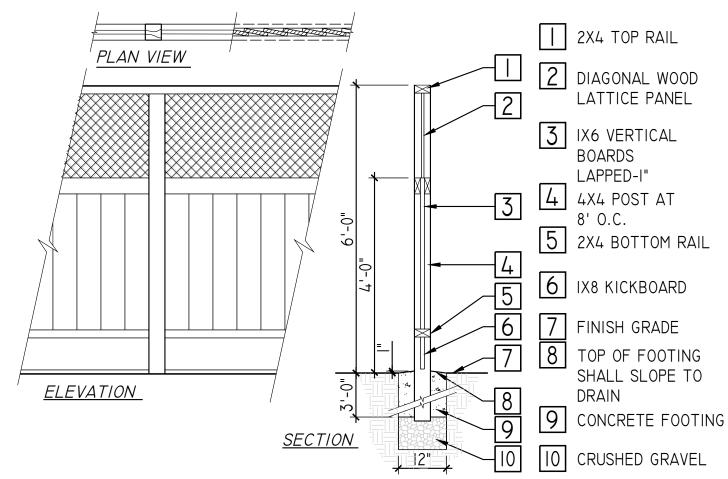

NOTE: WOOD POSTS TO BE PTDF AND ALL OTHER WOOD TO BE HEART REDWOOD.




CRAPE MYRTLE





BAY LAUREL



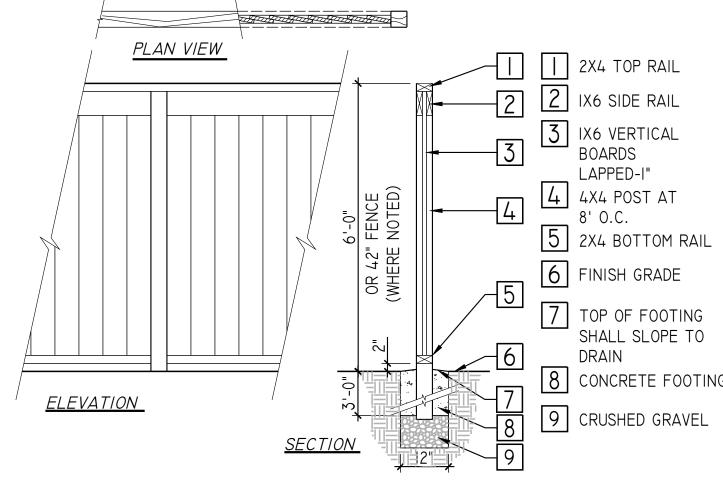

WOOD GOOD NEIGHBOR FENCE

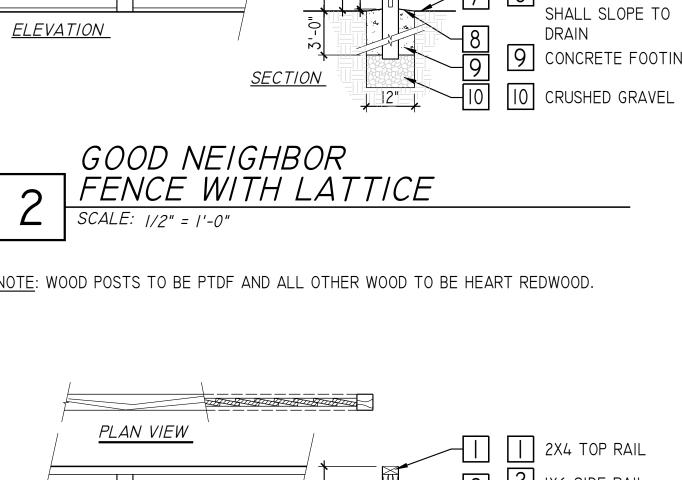

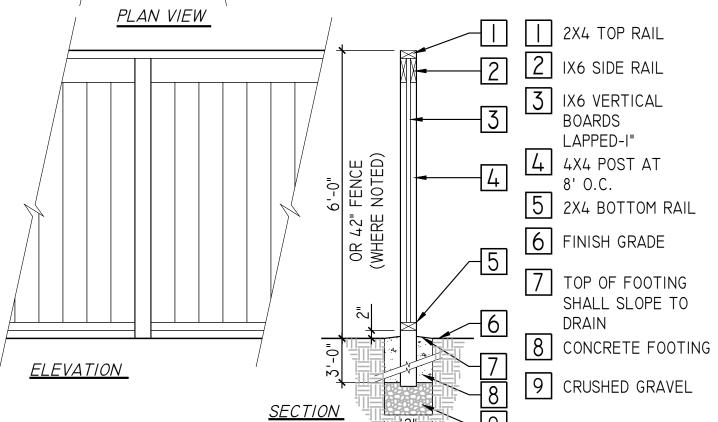




FLOWERING CHERRY



RED MAPLE

#### PLANTING NOTES

- I. CONTRACTOR SHALL BID AND INSTALL PLANTING MATERIALS PER THESE PLANS AND SPECIFICATIONS, UNLESS GIVEN FURTHER WRITTEN INSTRUCTIONS, OR WRITTEN INSTRUCTION BY LANDSCAPE ARCHITECT. WORK INCLUDES, BUT IS NOT LIMITED TO ALL LABOR, GENERAL LIABILITY INSURANCE, WORKMAN'S COMPENSATION, EQUIPMENT, AND MATERIALS NECESSARY TO FURNISH, INSTALL AND GUARANTEE PLANTING, AS SHOWN ON THE DRAWINGS AND SPECIFIED HEREIN.
- 2. COORDINATE FIELD OBSERVATIONS WITH LANDSCAPE ARCHITECT (MINIMUM 2 VISITS), CALL TO PROVIDE 48
  - A. REVIEW FINISHED GRADE W/ LANDSCAPE ARCHITECT PRIOR TO PLANT PLACEMENT. ALL PLANTS SHALL BE INSPECTED BY ARBORIST/ LANDSCAPE ARCHITECT FOR HEALTH, PESTS AND SIZE PRIOR TO LAYOUT. B. LAYOUT PLANTINGS FOR APPROVAL IN FULL QUANTITIES, PRIOR TO DIGGING HOLES. ADJUST LAYOUT AS DIRECTED BY LANDSCAPE ARCHITECT.
- CONTRACTOR SHALL PROVIDE SUBMITTALS/SAMPLES TO LANDSCAPE ARCHITECT OF ALL SPECIMEN TREES (PHOTOGRAPHS WITH HUMAN SCALE), SOIL, MULCH, STAKES, TIES, AGRIFORM TABLETS, GRASS PAVE MATERIALS, STEEL EDGING, AND OTHER MATERIALS.
- ALL WORK SHALL CONFORM TO THE LATEST APPLICABLE SONOMA COUNTY WATER AGENCY ORDINANCES RELATING TO PLANTING AND IRRIGATION. ALL PLANT MATERIALS TO BE INSTALLED PER CITY OF SANTA ROSA STANDARDS AND PLANTING DETAILS. THE PLANT MATERIALS SHALL CONFORM TO THE PLANT LEGEND SPECIFICATION FOR SIZE & LATEST EDITION OF THE AMERICAN NURSERYMAN STANDARDS.
- PRIOR TO REMOVING ANY PLANTS, CONTRACTOR SHALL OBTAIN APPROVAL OF OWNER AND LANDSCAPE ARCHITECT TO DETERMINE SPECIMENS TO REMAIN OR BE TRANSPLANTED. ALL PLANTING AREAS ARE TO BE FREE OF DELETERIOUS MATERIALS AND WEEDS PRIOR TO PLANTING.
- A SOIL FERTILITY TEST SHALL BE REQUIRED FOR REVIEW BY THE LANDSCAPE ARCHITECT AFTER GRADING IS COMPLETE AND BEFORE ANY PLANT WORK. A SOIL TEST SHALL BE PERFORMED TO DETERMINE THE FINAL AMENDMENT AND FERTILIZER FORMULA. THE SOILS REPORT CONDUCTED BY WAYPOINT ANALYTICAL, (408) 727-0330, UNLESS OTHERWISE APPROVED) MUST CONTAIN THE FOLLOWING INFORMATION: A. SOIL PERMEABILITY RATE IN INCHES PER HOUR
- B. SOIL TEXTURE TEST
- C. CATION EXCHANGE CAPACITY D. SOIL FERTILITY INCLUDING TESTS FOR NITROGEN, POTASSIUM, PHOSPHOROUS, PH, ORGANIC MATTER
- TOTAL SOLUBLE SALTS AND SODIUM CONTENT
- F. CONTRACTOR TO REQUEST A "BAY-FRIENDLY" RECOMMENDATION FOR AMENDMENTS TO THE PLANTING
- 7. A MINIMUM OF 8" OF NON-MECHANICALLY COMPACTED SOIL SHALL BE AVAILABLE FOR WATER ABSORPTION AND ROOT GROWTH IN PLANTED AREAS. WITHIN THE LIMITS OF NEW PLANTING AREAS, THE TOP 12" OF EXISTING SOIL OR TO THE EXTENT OF EXISTING TOPSOIL, WHICH EVER IS LESS, SHALL BE STRIPPED AND STOCKPILED ON THE SITE FOR RE-USE. ALL PLANTING AREAS TO BE TILLED SO THAT SOIL IS LOOSE AND NOT COMPACTED. ALL PLANTING BEDS TO RECEIVE A MINIMUM OF 12" OF APPROVED TOPSOIL. TO PREPARE PLANTING BEDS AND LAWN AREAS, CULTIVATE INTO TOP 12" OF SOIL: 6 CUBIC YARDS OF ORGANIC COMPOST PER 1,000 SQUARE FEET. COMPOST IS TO HAVE THE US COMPOSTING COUNCIL'S SEAL OF TESTING ASSURANCE (STA) AND THE ORGANIC MATERIALS REVIEW INSTITUTE (OMRI) LISTING. INCORPORATE COMPOST OR NATURAL FERTILIZER INTO THE SOIL TO A MINIMUM DEPTH OF 8" AT A MINIMUM RATE OF 6 CUBIC YARDS PER 1000 SQUARE FEET OR PER SPECIFIC AMENDMENT RECOMMENDATIONS FROM A SOILS LABORATORY REPORT. ANY ADDITIONAL AMENDMENTS SHALL BE CERTIFIED ORGANIC BY OMRI.
- 8. ALL PLANT LOCATIONS TO BE CONFIRMED IN THE FIELD BY THE LANDSCAPE ARCHITECT. CONTRACTOR IS TO COORDINATE ALL PLANTING WITH UTILITY LOCATIONS NOT SHOWN ON THIS PLAN. ANY CONFLICTS BETWEEN LOCATIONS OF PROPOSED PLANTING AND SITE UTILITIES OR LIGHTING TO BE CALLED TO THE ATTENTION OF THE LANDSCAPE ARCHITECT.
- LAYOUT OF PLANTINGS IS DIAGRAMMATIC AND MAY NEED FIELD ADJUSTMENT FOR EXISTING SITE CONDITIONS NOT SHOWN ON PLANS, OR AS DIRECTED BY THE LANDSCAPE ARCHITECT. ADJUSTMENTS WILL BE MADE FOR VIEWS, ACCESS, ETC. ALL PLANTINGS SHALL BE FIELD ADJUSTED TO MEET THE MINIMUM STATE REGULATIONS FOR PLANTING AND MAINTAINING A FIRE DEFENSIBLE SPACE, DEPT. OF FORESTRY. PLANT QUANTITIES ARE FOR INFORMATIONAL USE ONLY. ANY DISCREPANCIES SHALL BE BROUGHT TO THE ATTENTION OF THE LANDSCAPE ARCHITECT. THE CONTRACTOR SHALL BE RESPONSIBLE FOR ALL PLANTS AS SHOWN ON THE DRAWINGS.
- PLANTS SHALL BE SUFFICIENTLY ROOTED TO THE EDGE OF THE CONTAINER AND TO AN EXTENT SUFFICIENT TO HOLD THE ROOTBALL INTACT WHEN REMOVED FROM THE CONTAINER. NO PLANTS SHALL BE ACCEPTABLE THAT SHOW SIGNS OF CIRCLING OR GIRDLING OF ROOTS, OR ANY OTHER ROOT-BOUND CONDITION. PLANTS SHALL BE FREE FROM ALL PESTS AND DISEASES.
- ALL PLANTS SHALL BE PLACED IN A TRIANGULAR SPACED PATTERN, UNLESS OTHERWISE SPECIFIED.
- EXCAVATE PLANTING PITS I" LESS THAN THE DEPTH OF THE PLANT CONTAINER AND TWO TIMES THE WIDTH OF THE PLANT CONTAINER. PREPARE HOLE BACKFILL MATERIAL BY USING I PART EXISTING SOIL TO I PART ORGANIC COMPOST. THOROUGHLY MIX THIS COMBINATION BEFORE BACKFILLING. SET PLANT PLUMB IN PLANTING PIT AND BRACE RIGIDLY IN POSITION, TAMPING BACKFILL MIX SOLIDLY AROUND THE BALL AND ROOTS. PLACE TOP OF ROOTBALL I" ABOVE SURROUNDING GRADE. (SEE PLANTING DETAILS FOR TREES, SHRUBS AND GROUNDCOVERS ON THIS SHEET). DO NOT OVER COMPACT SOIL.
- ALL TREES ARE TO BE STAKED AND TREES AND SHRUBS ARE TO HAVE WATERING BASINS. ALL TREES CLOSER THAN 8'-0" TO BUILDINGS, WALKS, PAVING, CURBS OR FOOTINGS SHALL BE INSTALLED WITH A DEEF ROOT BARRIER. USE DEEP ROOT BARRIER, TYPE UB 24-2 PER MANUFACTURER'S RECOMMENDATIONS.
- 14. AFTER PLANTING, WATER NEW PLANTINGS DEEPLY AND THOROUGHLY.
- 15. A MINIMUM 3" LAYER OF MULCH SHALL BE APPLIED ON ALL EXPOSED SOIL SURFACES OF PLANTING AREAS EXCEPT IN TURF AREAS, CREEPING OR ROOTING GROUNDCOVERS OR DIRECT SEEDING APPLICATIONS. MULCH SHALL BE "WOOD CHIPS" FROM SEQUOIA LANDSCAPE MATERIALS (707-527-5512), NATURAL COLOR.
- 16. THE CONTRACTOR SHALL MAINTAIN THE PLANTING AND IRRIGATION INSTALLATIONS FOR 60 DAYS FROM THE DATE OF FINAL ACCEPTANCE. ALL PLANT MATERIALS SHALL BE GUARANTEED FOR A MINIMUM PERIOD OF 6  $\blacksquare$ MONTHS FROM DATE OF FINAL ACCEPTANCE.

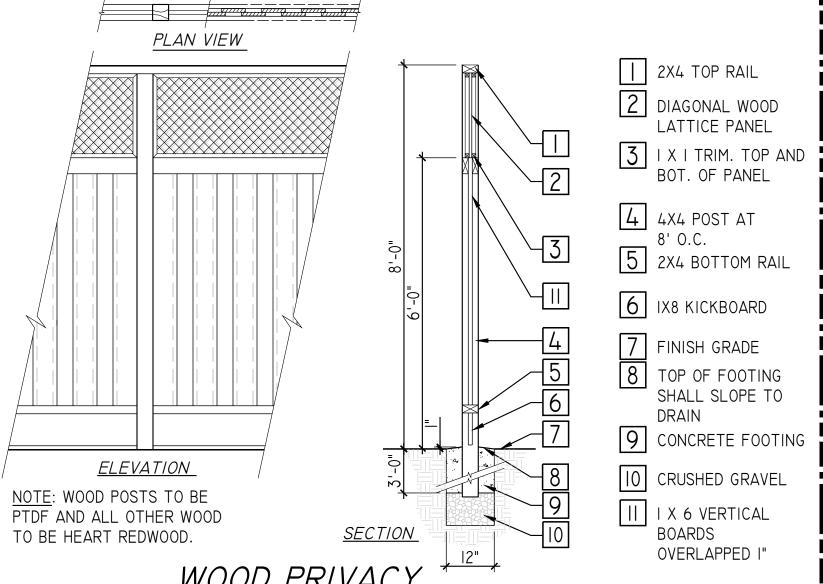

WOOD PRIVACY FENCE WITH LATTICE SCALE: 1/2" = 1'-0"

11 / 30 / 20 Renewal Date Michael A. Cook



PLANNING+ LANDSCAPE ARCHITECTURE

5128 DUPONT DRIVE

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PROJECT:

CHERRY RANCH SUBDIVISION 930 FRESNO AVENUE SANTA ROSA, CA. 94507 APN #035-101-004

CLIENT:

CRC DEVELOPMENT LLC

364 4IST STREET OAKLAND, CA 94609

SHEET DESCRIPTION: DESIGN REVIEW CONCEPTUAL LANDSCAPE PLAN

<u>REVISIONS:</u>

LATTICE PANEL

BOT. OF PANEL

SHALL SLOPE TO

OVERLAPPED I"

DRAIN

	FOR	
NOT	1D	JC7101
CON	1511	JCTION

DATE:	03/09/2020
SCALE:	I" = 30"
DRAWN BY:	FM
CHECKED BY:	MΔC

SHEET L-2 of 2 NUMBER : PROJECT 19-055.01 NUMBER:





COAST LIVE OAK





GINGKO