



RECEIVED

By Andrew Trippel at 2:35 pm, Sep 14, 2020

ONE SANTA ROSA AVE

1 Santa Rosa Ave
Santa Rosa, CA 95404
9/14/20

lowney
arch


ONE SANTA ROSA

1 SANTA ROSA AVE, SANTA ROSA, CALIFORNIA

ABBREVIATIONS

AB	ANCHOR BOLT	MIN	MINIMUM
ACOUS	ACOUSTICAL	MISC	MISCELLANEOUS
ACS	ACCESSIBLE	MTL	METAL
ADJ	ADJUSTABLE/ADJACENT	MTD	MOUNTED
AFF	ABOVE FINISHED FLOOR	MUL	MULLION
AL	ALIGN	(N)	NEW
ALT	ALTERNATE	NEG	NEGATIVE
APROV	APPROVED	NIC	NOT IN CONTRACT
ARCH	ARCHITECTURAL	NO	NUMBER
AUTO	AUTOMATIC	NOM	NOMINAL
		NTS	NOT TO SCALE
BD	BOARD		
BLDG	BUILDING	OC	ON CENTER
BLKG	BLOCKING	OD	OUTSIDE DIAMETER
BM	BEAM	OP	OPENING
BO	BOTTOM OF	OPP	OPPOSITE
BS	BOTH SIDES	ORIG	ORIGINAL
CAB	CABINET	PAF	POWDER ACTUATED FASTENER
CBC	CALIFORNIA BUILDING CODE	PART	PARTITION
CER	CERAMIC	PL	PLATE
CI	CAST IRON	PLAM	PLASTIC LAMINATE
CIP	CAST IN PLACE	PLYWD	PLYWOOD
CJ	CONSTRUCTION JOINT	PN	PLATE NAILING
CL	CLEAR	PP	PARTIAL PENETRATION
CMU	CONCRETE MASONRY UNIT	PRES	PRESSURE
COL	COLUMN	PS	PRESTRESSED
CON	CONNECTION	PT	PRESSURE TREATED
CONT	CONTINUOUS		
CP	COMPLETE PENETRATION	QUAL	QUALITY
CS	COUNTERSUNK	QUAN	QUANTITY
CTC	CENTER TO CENTER		
CTR	CENTER	RAD	RADIUS
CW	COLD WATER	RDWD	REDWOOD
		RECPT	RECEPTACLE
DBL	DOUBLE	REF	REFERENCE
DEPT	DEPARTMENT	REIN	REINFORCEMENT
DET	DETAIL	REQ	REQUIRED
DF	DOUGLAS FIR	REV	REVISION
DIA	DIAMETER	RH	RIGHT HAND
DIV	DIVISION	RHR	RIGHT HAND REVERSE
DN	DOWN	RM	ROOM
DR	DOOR	RND	ROUND
DRWR	DRAWER	RO	ROUGH OPENING
DS	DIAGONAL SHEATHING	RWL	RAIN WATER LEADER
DWG	DRAWING		
		SAD	SEE ARCHITECTURAL DRAWINGS
(E)	EXISTING	SCD	SEE CIVIL DRAWINGS
EA	EACH	SCHED	SCHEDULE
EF	EACH FACE	SECT	SECTION
EL	ELEVATION	SED	SEE ELECTRICAL DRAWINGS
ELEC	ELECTRICAL	SFCD	SEE FINISHED CARPENTRY DRAWINGS
ELEV	ELEVATOR	SHT	SHEET
ENG	EDGE NAILING	SIM	SIMILAR
ENG	ENGINEER	SJ	SEISMIC JOINT
EQ	EQUAL	SKD	SEE KITCHEN CONSULTANT DRAWINGS
EQUIP	EQUIPMENT	SLD	SEE LANDSCAPE DRAWINGS
EW	EACH WAY	SM	SHEET METAL
EX	EXHAUST	SMD	SEE MECHANICAL DRAWINGS
EXP	EXPEDITE	SP	SEE PLUMBING DRAWINGS
EXT	EXTERIOR	SPD	SPECIFICATION
		SPEC	SQUARE
FA	FIRE ALARM	SQ	SQUARE FOOT/FEET
FAB	FABRICATE	SQFT	SANITARY SEWER
FE	FIRE EXTINGUISHER	SS	SEE STRUCTURAL DRAWINGS
FF	FINISHED FLOOR	SSD	STAINLESS STEEL
FIN	FINISH	SSTL	STRAP TIE
FL	FLUSH	ST	STAGGERED
FLR	FLOOR	STAC	STANDARD
FLOUR	FLOURESCENT	STL	STEEL
FOC	FACE OF CONCRETE	STOR	STORAGE
FOF	FACE OF FINISH	STRUCT	STRUCTURAL
FOS	FACE OF STUD	SUS	SUSPENDED
FOUND	FOUNDATION	SYM	SYMMETRICAL
FOW	FACE OF WALL	SYS	SYSTEM
FR	FRAMING		
FTNG	FOOTING	T&B	TOP AND BOTTOM
FUR	FURRING	T&G	TONGUE AND GROOVE
		TD	TIE DOWN
GA	GAUGE	TEMP	TEMPERED
GALV	GALVANIZED, GALVANIZING	TH	THICKNESS
GL	GLASS, GLAZING	THR	THREADED
GLULAM	GLUE LAMINATED BEAM	TN	TRUE NORTH
GYP BD	GYPSON BOARD	TOC	TOP OF CONCRETE
		TOF	TOP OF FINISH
HD	HOLD DOWN	TOP	TOP OF PLATE
HORIZ	HORIZONTAL	TOS	TOP OF STEEL
HSB	HIGH STRENGTH BOLTS	TOW	TOP OF WALL
HSR	HIGH STRENGTH RODS	TYP	TYPICAL
HT	HEIGHT		
HVAC	HEATING VENTILATION & AIR CONDITIONING	UL	UNDER WRITERS LABORATORY
HW	HOT WATER	UON	UNLESS OTHERWISE NOTED
		UTIL	UTILITY, UTILITIES
INC	INCLUDING, INCLUDED		
INFO	INFORMATION	VER	VERIFY
INT	INTERIOR	VERT	VERTICAL
		VEST	VESTIBULE
JH	JOIST HANGER	VIF	VERIFY IN FIELD
JT	JOINT		
		W/	WITH
L	LONG, LENGTH	W/O	WITHOUT
LB	POUND	WC	WATER CLOSET
LAM	LAMINATE	WD	WOOD
LH	LEFT HAND	WH	WATER HEATER
LHR	LEFT HAND REVERSE		
LT	LIGHT	YD	YARD
LTW	LIGHT WEIGHT		
MANF	MANUFACTURER		
MAINT	MAINTENANCE		
MAX	MAXIMUM		
MB	MACHINE BOLTS		
MECH	MECHANICAL		
MEZZ	MEZZANINE		

PARCEL MAP

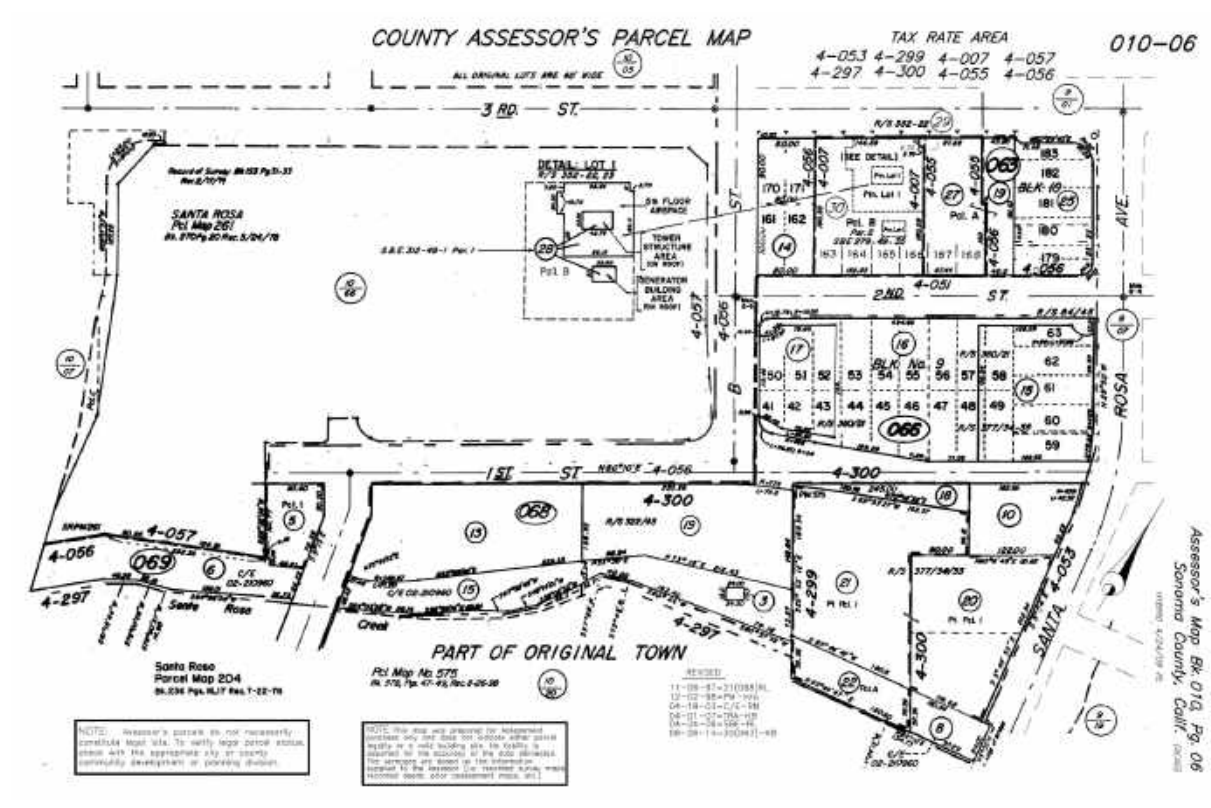

APN: 010-063-025

DEFERRED SUBMITTALS

1. FIRE SPRINKLERS

GRAPHIC SYMBOLS

DETAIL REFERENCE	DRAWING NUMBER	#
	SHEET NUMBER	#
DETAIL SECTION REFERENCE	DRAWING NUMBER	#
	SHEET NUMBER	#
BUILDING SECTION REFERENCE	DRAWING NUMBER	#
	SHEET NUMBER	#
WALL SECTION REFERENCE	DRAWING NUMBER	#
	SHEET NUMBER	#
EXTERIOR ELEVATION REFERENCE	DRAWING NUMBER	1
	SHEET NUMBER	#
INTERIOR ELEVATION REVERENCE	DRAWING NUMBER	1
	SHEET NUMBER	4
REVISION REFERENCE		#
DOOR REFERENCE		##
WINDOW REFERENCE		#
ELEVATION DATUM		●
ROOM NUMBER		###
PARTITION TYPE		#
FINISH CEILING HEIGHT		'X'-X"
CENTER LINE		⊥

PROJECT DESCRIPTION

NEW CONSTRUCTION OF A SEVEN STORY MULTI-FAMILY RESIDENTIAL BUILDING INCLUDING 120 APARTMENT UNITS AND AMENITIES AT FIRST LEVEL AND ROOFTOP AMENITY DECK.

PROJECT WILL BE A COMBINATION OF SITE-BUILT AND MODULAR CONSTRUCTION:

THE FIRST TWO LEVELS, INCLUDING APROXIMATELY 31,000 SF OF APARTMENTS AND AMENITIES, WILL BE SITE-BUILT.

FLOORS 3-7, APPROXIMATELY 75,700 SF, WILL BE CONSTRUCTED OF FACTORY-BUILT MODULAR UNITS.

3,670 SF OF AMENITY ROOF DECK WILL BE PROVIDED.


CONCESSIONS

1. GROUND FLOOR CEILING HEIGHTS TO 9'-6"

DRAWING LIST

SHEET NUMBER	SHEET NAME
GENERAL	
G0	COVER SHEET
G0.0	PROJECT DATA SHEET
G0.1	DATA SHEET
G0.2	ACCESSIBILITY DIAGRAMS
G0.3	CAL GREEN MANDATORY MEASURES
G0.4	CAL GREEN MANDATORY MEASURES
G1.0	EXISTING EXTERIOR PERSPECTIVES
G1.1	EXTERIOR PERSPECTIVES
G1.2	ARCHITECTURAL DIFFERENTIATION
CIVIL	
1 of 2	PROJECT INFORMATION
2 of 2	GRADING AND UTILITY PLAN
LANDSCAPE	
L00	PLANT LIST
L01	GROUND LEVEL PLAN
L02	ROOF PLAN
L03	SECTION
ARCHITECTURAL	
A0.2	NEIGHBORHOOD CONTEXT MAP
A1.0	SITE PLAN
A2.1	GROUND FLOOR PLAN
A2.2	LEVEL 2 FLOOR PLAN
A2.3	LEVEL 3 FLOOR PLAN
A2.4	LEVEL 4 FLOOR PLAN
A2.5	LEVEL 5 FLOOR PLAN
A2.6	LEVEL 6 FLOOR PLAN
A2.7	LEVEL 7 FLOOR PLAN
A2.8	ROOF PLAN
A2.9	MODULES PLAN
A3.1	EXTERIOR ELEVATION
A3.2	EXTERIOR ELEVATION
A3.3	EXTERIOR ELEVATION
A3.4	EXTERIOR ELEVATION
A3.5	MATERIAL BOARD
A3.10	BUILDING SECTION
A3.11	BUILDING SECTION
A3.12	BUILDING SECTION
SHEET TOTAL: 34	

PROJECT LOCATION

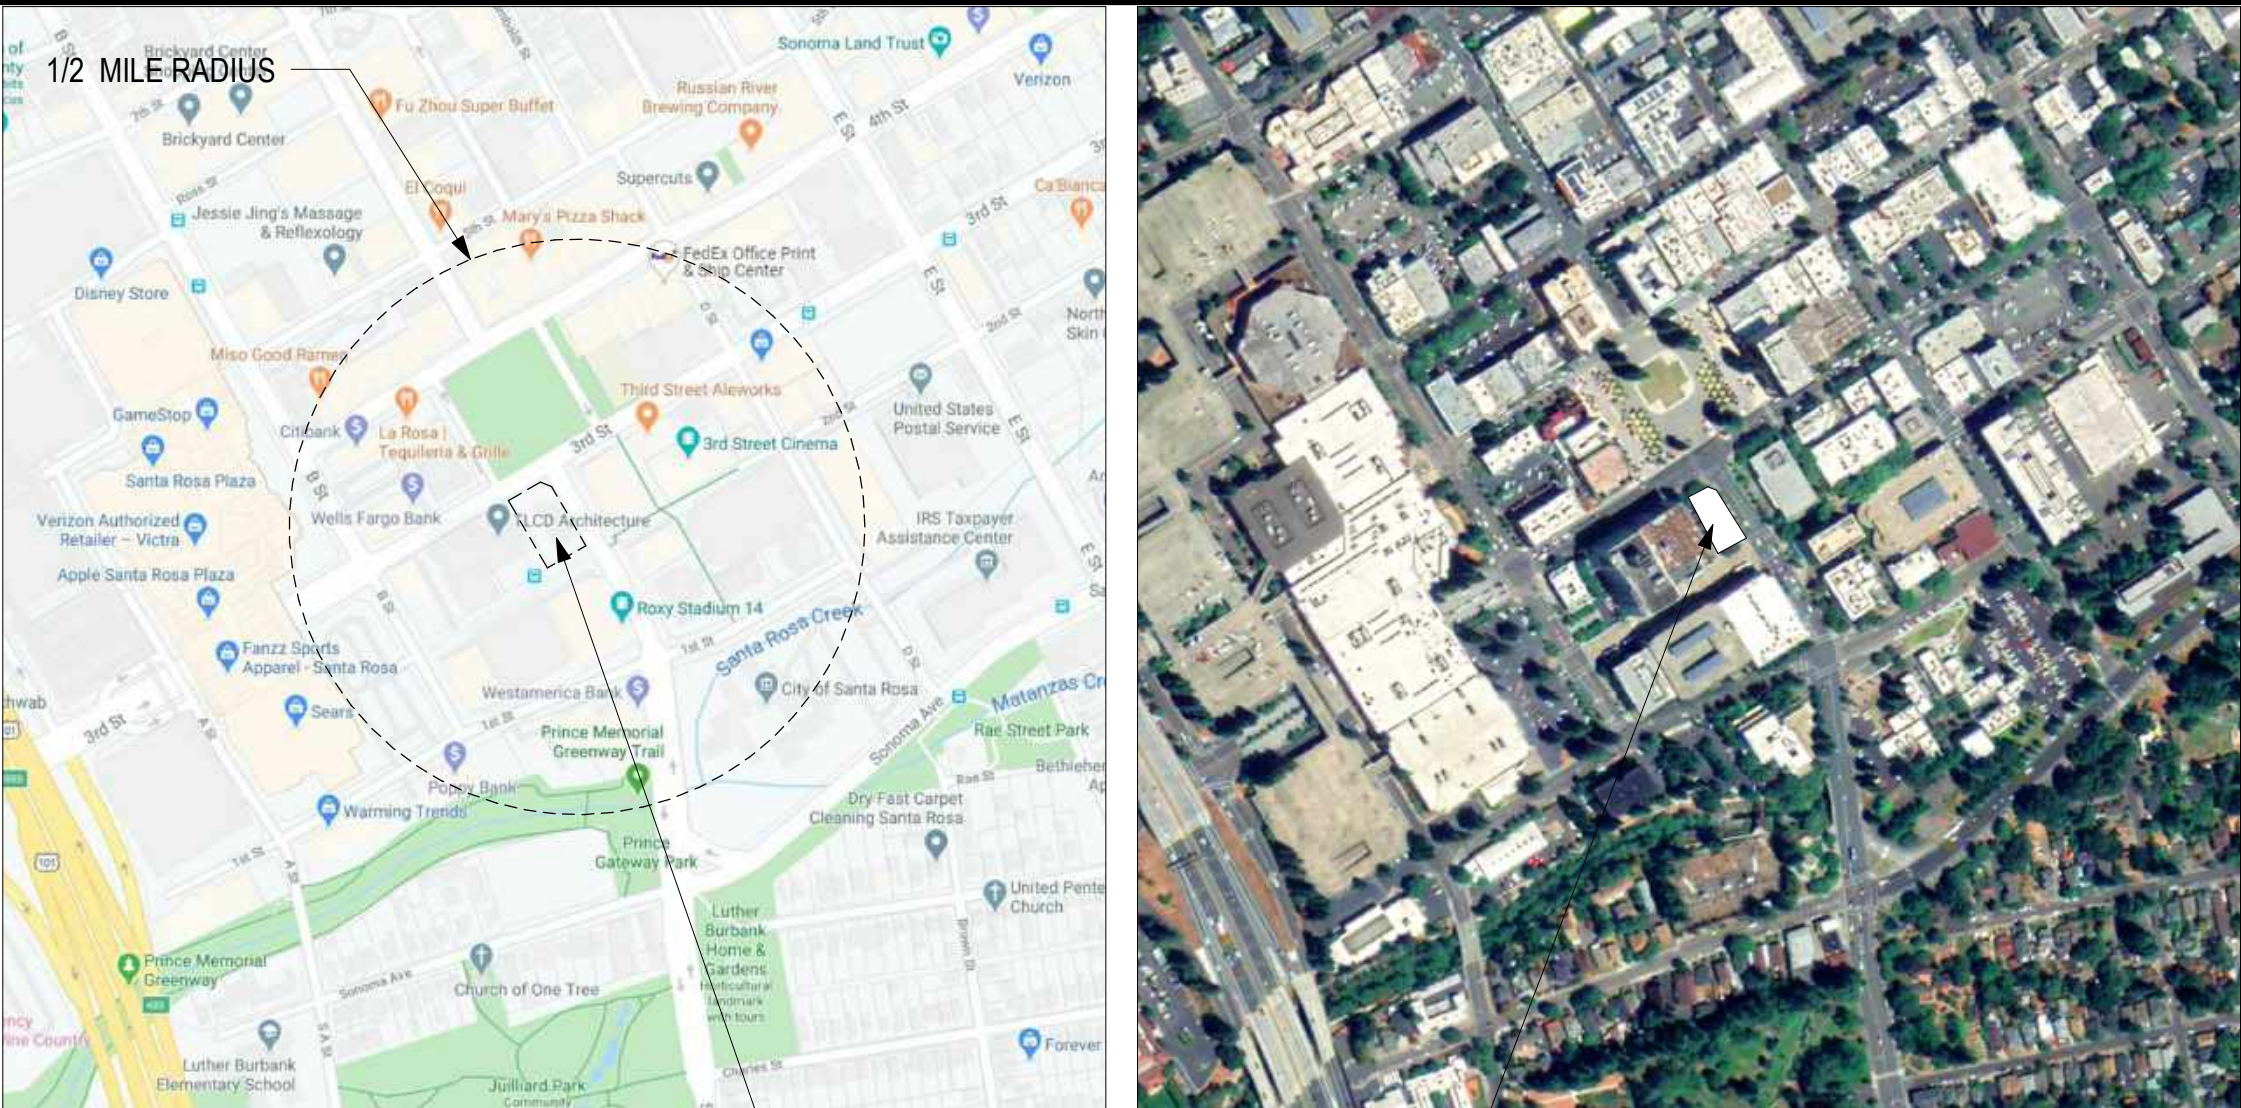

PROJECT LOCATION

PROJECT DATA

ZONING INFORMATION	
ASSESSOR'S PARCEL #:	010-063-025
ZONING DISTRICT:	CD-10-SA
DOWNTOWN COMMERCIAL, STATION AREA COMBINING DISTRICT COURTHOUSE SQUARE SUBAREA	10 STORIES
PROPOSED PROJECT DATA	
LOT AREA:	21,600 SF
TOTAL COVERED AREA:	15,249 SF
TOTAL UNITS:	120 UNITS
TOTAL STORIES:	5 OVER 2 STORIES
CONSTRUCTION TYPE:	IIIA MODULAR OVER IA
SPRINKLERED:	YES
OCCUPANCY CLASSIFICATION:	R-2: 85,602 SF B: 1,039 SF A-3: 1,1534 SF

ZONING ORDINANCES	
ALLOWABLE STORIES:	10 STORIES
PROPOSED STORIES:	7 STORIES
ALLOWABLE HEIGHT:	150' - 0" MAX
PROPOSED HEIGHT:	74' - 11"
ALLOWABLE LOT COVERAGE:	100%
PROPOSED LOT COVERAGE:	15,249 / 21,600 = 71%
DENSITY	
ALLOWABLE DENSITY:	NO MAXIMUM
ACTUAL NUMBER OF UNITS:	120 UNITS
DWELLING UNITS/ACRE:	120/50 = 240 UNITS/ ACRE

OPEN SPACE

PROVIDED OPEN SPACE:	
GROUND LEVEL:	2,199 SF COMMON
GROUND LEVEL:	921 SF PRIVATE
LEVEL 7:	1,147 SF PRIVATE
ROOF DECK:	3,801 SF COMMON
TOTAL OPEN SPACE PROVIDED:	8,068 SF

PARKING

AUTO PARKING:	
20-36.040 TABLE 3-4:	
MINIMUM PARKING REQUIRED:	
1 RESERVED SPACE/ UNIT= 120	
TOTAL AUTO SPACES PROVIDED:	
90 SPACES TO BE RESERVED AT GARAGE 12-555 1ST STREET.	
BICYCLE PARKING	
MINIMUM REQUIRED: 1 SPACE/ 4 UNITS = 30 SPACES	
PROVIDED: 84 LONG TERM BIKE SPACES	
3 SHORT TERM BIKE RACKS	

lowney
arch

Tel: 510.836.5400 URL: lowneyarch.com
350 seveneenth street | suite 200 | oakland, california 94612

ONE SANTA ROSA AVE

1 SRA LLC

1 Santa Rosa Ave
Santa Rosa, CA 95404

OWNER

1 SRA LLC
PO Box 8001
Napa, CA 94559
Phone: 415.519.7574

ARCHITECT

LOWNEY ARCHITECTURE
360 17th Street, Suite 200
Oakland, CA 94612
Phone: 510.269.1124

STRUCTURAL

INNOVATIVE STRUCTURAL
ENGINEERING, INC.
40810 County Center Dr Suite
110 Temecula, CA 92591
Phone: 951.226.4355

CIVIL ENGINEERING

BKF ENGINEERS
200 4th Street, Suite 300,
Santa Rosa, CA 95401
Phone: 707.583.8528

MEP

FARD ENGINEERS, INC.
309 Lennon Lane, Suite 200
Walnut Creek, CA 94598
Phone: 925.932.5505

LANDSCAPE ARCHITECT

LOWNEY ARCHITECTURE
360 17th Street, Suite 200
Oakland, CA 94612
Phone: 510.836.5400

STAMP

NOT FOR CONSTRUCTION

#	DATE	ISSUES & REVISIONS	BY
	04/14/202	100% SD	PS
2	04/17/2020	100% SD UPDATES	PS
	05/20/2020	DESIGN REVIEW BOARD	PS
	07/02/2020	REDUCED REVIEW AUTHORITY DESIGN REVIEW	PS

DRAWN BY: SDLP
PROJECT NUMBER: 19-186
SHEET ISSUE DATE: 07/02/20
SHEET TITLE:

PROJECT DATA SHEET

SHEET NUMBER

G0.0

ALL DRAWINGS AND WRITTEN MATERIAL APPEARING HEREIN CONSTITUTE ORIGINAL AND UNPUBLISHED WORK OF THE ARCHITECT AND MAY NOT BE DUPLICATED, USED OR DISCLOSED WITHOUT WRITTEN CONSENT OF THE ARCHITECT

9/4/2020 6:05:49 PM

GROSS BUILDING AREA

LEVEL	GROSS FLOOR AREA
GROUND LEVEL	15,707 SF
LEVEL 2	15,732 SF
LEVEL 3 PODIUM	15,732 SF
LEVEL 4	15,732 SF
LEVEL 5	15,732 SF
LEVEL 6	14,593 SF
LEVEL 7	13,275 SF
ROOF LEVEL	537 SF
Grand Total:	107,039 SF

UNIT COUNT

UNIT TYPE	NAME	AREA	COUNT
GROUND LEVEL			
A1	STUDIO	483 SF	6
A3	STUDIO	524 SF	1
A4	STUDIO	483 SF	1
B1	1 BR	726 SF	4
C1	2 BR	866 SF	1
C2	2 BR	946 SF	1
			14
LEVEL 2			
A1	STUDIO	483 SF	5
A2	STUDIO	696 SF	1
A3	STUDIO	528 SF	1
A5	STUDIO	431 SF	1
B2	1 BR	611 SF	1
B3	1 BR	640 SF	1
B4	1 BR	731 SF	4
C1	2 BR	846 SF	1
C4	2 BR	956 SF	1
C5	2 BR	898 SF	1
C6	2 BR	1,031 SF	1
			18
LEVEL 3 PODIUM			
A1	STUDIO	484 SF	5
A2	STUDIO	700 SF	1
A3	STUDIO	531 SF	1
B2	1 BR	622 SF	1
B3	1 BR	641 SF	1
B4	1 BR	739 SF	4
C1	2 BR	851 SF	1
C3	2 BR	930 SF	1
C4	2 BR	964 SF	1
C5	2 BR	877 SF	1
C6	2 BR	1,026 SF	1
			18
LEVEL 4			
A1	STUDIO	484 SF	5
A2	STUDIO	705 SF	1
A3	STUDIO	531 SF	1
B2	1 BR	622 SF	1
B3	1 BR	641 SF	1
B4	1 BR	739 SF	4
C1	2 BR	854 SF	1
C4	2 BR	964 SF	1
C5	2 BR	877 SF	1
C6	2 BR	1,026 SF	1
C7	2 BR	930 SF	1
			18
LEVEL 5			
A1	STUDIO	484 SF	5
A2	STUDIO	705 SF	1
A3	STUDIO	531 SF	1
B2	1 BR	622 SF	1
B3	1 BR	641 SF	1
B4	1 BR	734 SF	4
C1	2 BR	853 SF	1
C4	2 BR	964 SF	1
C5	2 BR	877 SF	1
C6	2 BR	1,026 SF	1
C7	2 BR	930 SF	1
			18
LEVEL 6			
A1	STUDIO	484 SF	5
A2	STUDIO	705 SF	1
A3	STUDIO	531 SF	1
B2	1 BR	622 SF	1
B3	1 BR	641 SF	1
B4	1 BR	734 SF	4
C1	2 BR	853 SF	1
C4	2 BR	964 SF	1
C5	2 BR	877 SF	1
C7	2 BR	929 SF	1
			17
LEVEL 7			
A1	STUDIO	488 SF	5
A2	STUDIO	712 SF	1
A3	STUDIO	531 SF	1
B2	1 BR	628 SF	1
B5	1 BR	583 SF	4
B6	1 BR	499 SF	1
B7	1 BR	711 SF	1
C5	2 BR	883 SF	1
C8	2 BR	713 SF	1
C9	2 BR	816 SF	1
			17
Total Units			120

SCOPE OF WORK MATRIX

LOCATION	BUILDING COMPONENT	SITE BUILT (SB)	FACTORY BUILT (FB)
Grade Level	Site Elements	Sidewalks and driveways; landscaping including at grade planting, mulching, trees, bike racks, pedestrian unit paving; irrigation; gates and gate operations equipment; trash enclosures; relocation of solar panels	N/A
	Utilities	Electrical transformer, utility connections	N/A
Podium Levels	Ceiling, Doors, Windows, Walls	Wood stud walls, furring walls, ceiling where occurs, doors, windows, folding glass wall	N/A
		Exit signage and exterior signage	N/A
	Exterior Finishes	Waterproofing, exterior wall finish assemblies	N/A
	Podium	Concrete superstructure. Light-gauge garage steel floor & wall framing.	N/A
	Interiors	Interior finishes; community kitchen, including appliances and cabinetry; restroom, including fixtures; laundry appliances	N/A
Above Podium	Stairs	Egress balconies, waterproofing, factory-built stair installation, guardrails and handrails	Stair run and treads, ship flat
	Units	Sleepers; MEP and Structural access close-ups and insulation; waterproofing membrane; sheathing close-up between Module connections; exterior finishes	Floor, ceiling, wall assemblies, MEP equipment and fixtures, exhaust fans, ducts, grilles, casework, appliances, finishes, doors and windows, flashing around openings
	Unit Balconies	Install Factory-Built balconies; composite decking over sleepers over waterproofing; guardrail; sidewalls; finishes on exposed wood	Floor assembly, waterproofing
	Signage	All signage, including Unit entry door signage	N/A
	Roof	Roof finish including insulation, roof curbs, installation of parapet walls; parapet support and caps; roof walkpads; stormwater management system: scuppers, leader boxes and rain-water leaders	Roof assembly at top units; partial height parapet to be shipped flat; blocking for parapet installation; blocking for solar systems; coordination with solar layout; "dog-house" roof structures, to be shipped loose

GENERAL NOTES

CITY'S CLIMATE ACTION PLAN (CAP) CHECK LIST REQUIREMENTS:

SECTION:

- 1.1.1: THIS PROJECT TO COMPLY WITH CALGREEN TIER 1 CHECKLIST
- 1.3.1: INSTALL REAL-TIME ENERGY MONITORS AT ALL PROJECT UTILITIES
- 6.1.3: GC TO INCREASE DIVERSION OF CONSTRUCTION WASTE BY DIVERTING 65% OF CONSTRUCTION WASTE
- 9.2.1: CONSTRUCTION EQUIPMENT IDLEING TIME TO BE NO MORE THAN 5 MUNITES
- 9.2.2: GC TO ENSURE CONSTRUCTION EQUIPMENT ARE MAINTAINED PER MANUFACTURER'S REQUIREMENTS
- 9.2.3: GC TO USE ELECTRICAL OR ALTERNATIVE FUELS FOR CONSTRUCTION EQUIPMENT TO REDUCE GHG EMISSIONS, PER CAP MEASURE 9.2



TEL 510.836.5400 URL lowneyarch.com
350 SEVENTEENTH STREET | SUITE 200 | OAKLAND, CALIFORNIA 94612

ONE SANTA ROSA AVE

1 SRA LLC

1 Santa Rosa Ave
Santa Rosa, CA 95404

OWNER

1 SRA LLC
PO Box 8001
Napa, CA 94559
Phone: 415.519.7574

ARCHITECT

LOWNEY ARCHITECTURE
360 17th Street, Suite 200
Oakland, CA 94612
Phone: 510.269.1124

STRUCTURAL

INNOVATIVE STRUCTURAL
ENGINEERING, INC.
40810 County Center Dr Suite
110 Temecula, CA 92591
Phone: 951.226.4355

CIVIL ENGINEERING

BFK ENGINEERS
200 4th Street, Suite 300,
Santa Rosa, CA 95401
Phone: 707.583.8528

MEP

FARD ENGINEERS, INC.
309 Lennon Lane, Suite 200
Walnut Creek, CA 94598
Phone: 925.932.5505

LANDSCAPE ARCHITECT

LOWNEY ARCHITECTURE
360 17th Street, Suite 200
Oakland, CA 94612
Phone: 510.836.5400

STAMP

NOT FOR
CONSTRUCTION

#	DATE	ISSUES & REVISIONS	BY
	04/14/202	100% SD	PS
2	04/17/2020	100% SD UPDATES	PS
	05/20/2020	DESIGN REVIEW BOARD	PS
	07/02/2020	REDUCED REVIEW AUTHORITY DESIGN REVIEW	PS

DRAWN BY: SDLP
PROJECT NUMBER: 19-186
SHEET ISSUE DATE: 07/02/20
SHEET TITLE:


DATA SHEET

SHEET NUMBER

G0.1



ALL DRAWINGS AND WRITTEN MATERIAL APPEARING HEREIN
CONSTITUTE ORIGINAL AND UNPUBLISHED WORK OF THE
ARCHITECT AND MAY NOT BE DUPLICATED, USED OR DISCLOSED
WITHOUT WRITTEN CONSENT OF THE ARCHITECT

- * CLEAR WIDTH PER 1133A.2.1.1-3:
1. U-SHAPED KITCHENS, DESIGNED WITH PARALLEL APPROACH AT A RANGE OR COOKTOP LOCATED AT THE BASE OF THE U, SHALL HAVE A MINIMUM CLEAR WIDTH OF AT LEAST 60 INCHES.
 2. U-SHAPED KITCHENS, DESIGNED WITH A COOKTOP OR SINK LOCATED AT THE BASE OF THE U, WHICH PROVIDES A KNEE AND TOE SPACE IN ACCORDANCE WITH SECTION 1133A.7 TO ALLOW FOR A FORWARD APPROACH, SHALL HAVE A CLEAR WIDTH OF AT LEAST INCHES.
 3. ALL OTHER KITCHEN DESIGNS SHALL PROVIDE A MINIMUM CLEAR WIDTH OF AT LEAST 48 INCHES.

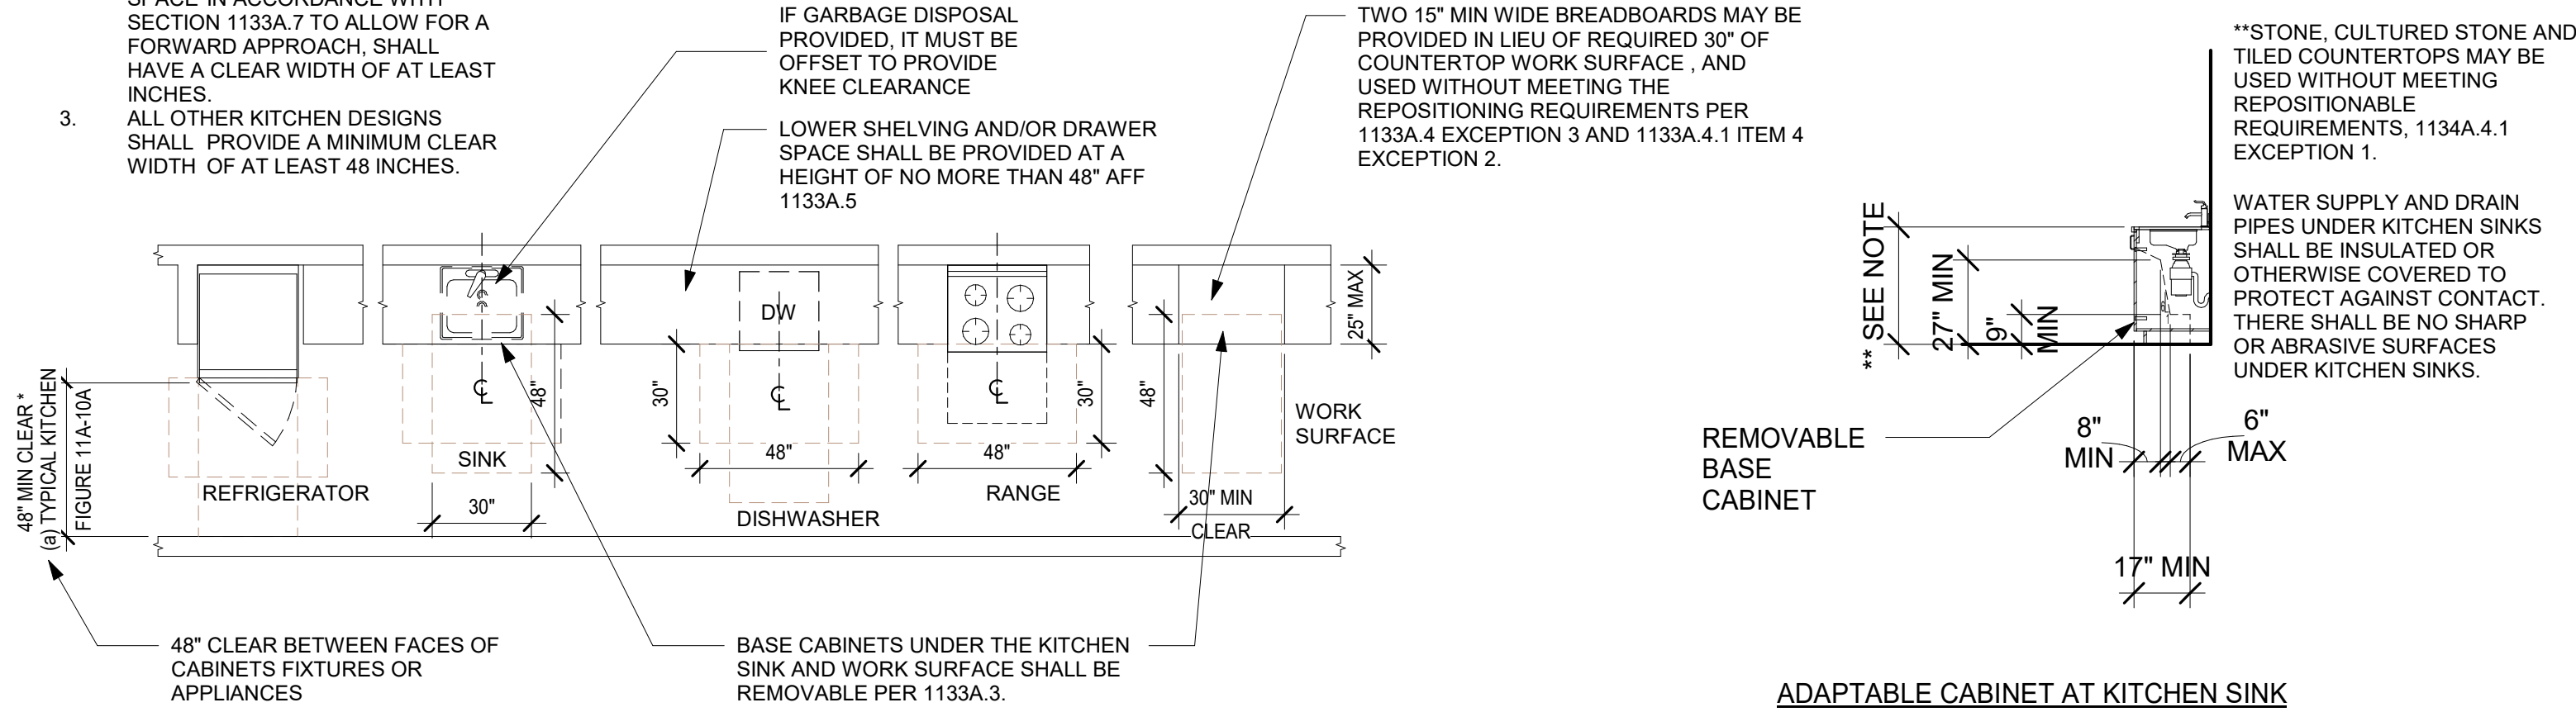

1 ACCESSIBLE PARKING
1/4" = 1'-0"

WATER SUPPLY AND DRAIN PIPES SHALL BE INSULATED OR PROTECTED AGAINST CONTACT. THERE SHALL BE NO SHARP OR ABRASIVE SURFACES UNDER LAVATORIES AND SINKS.

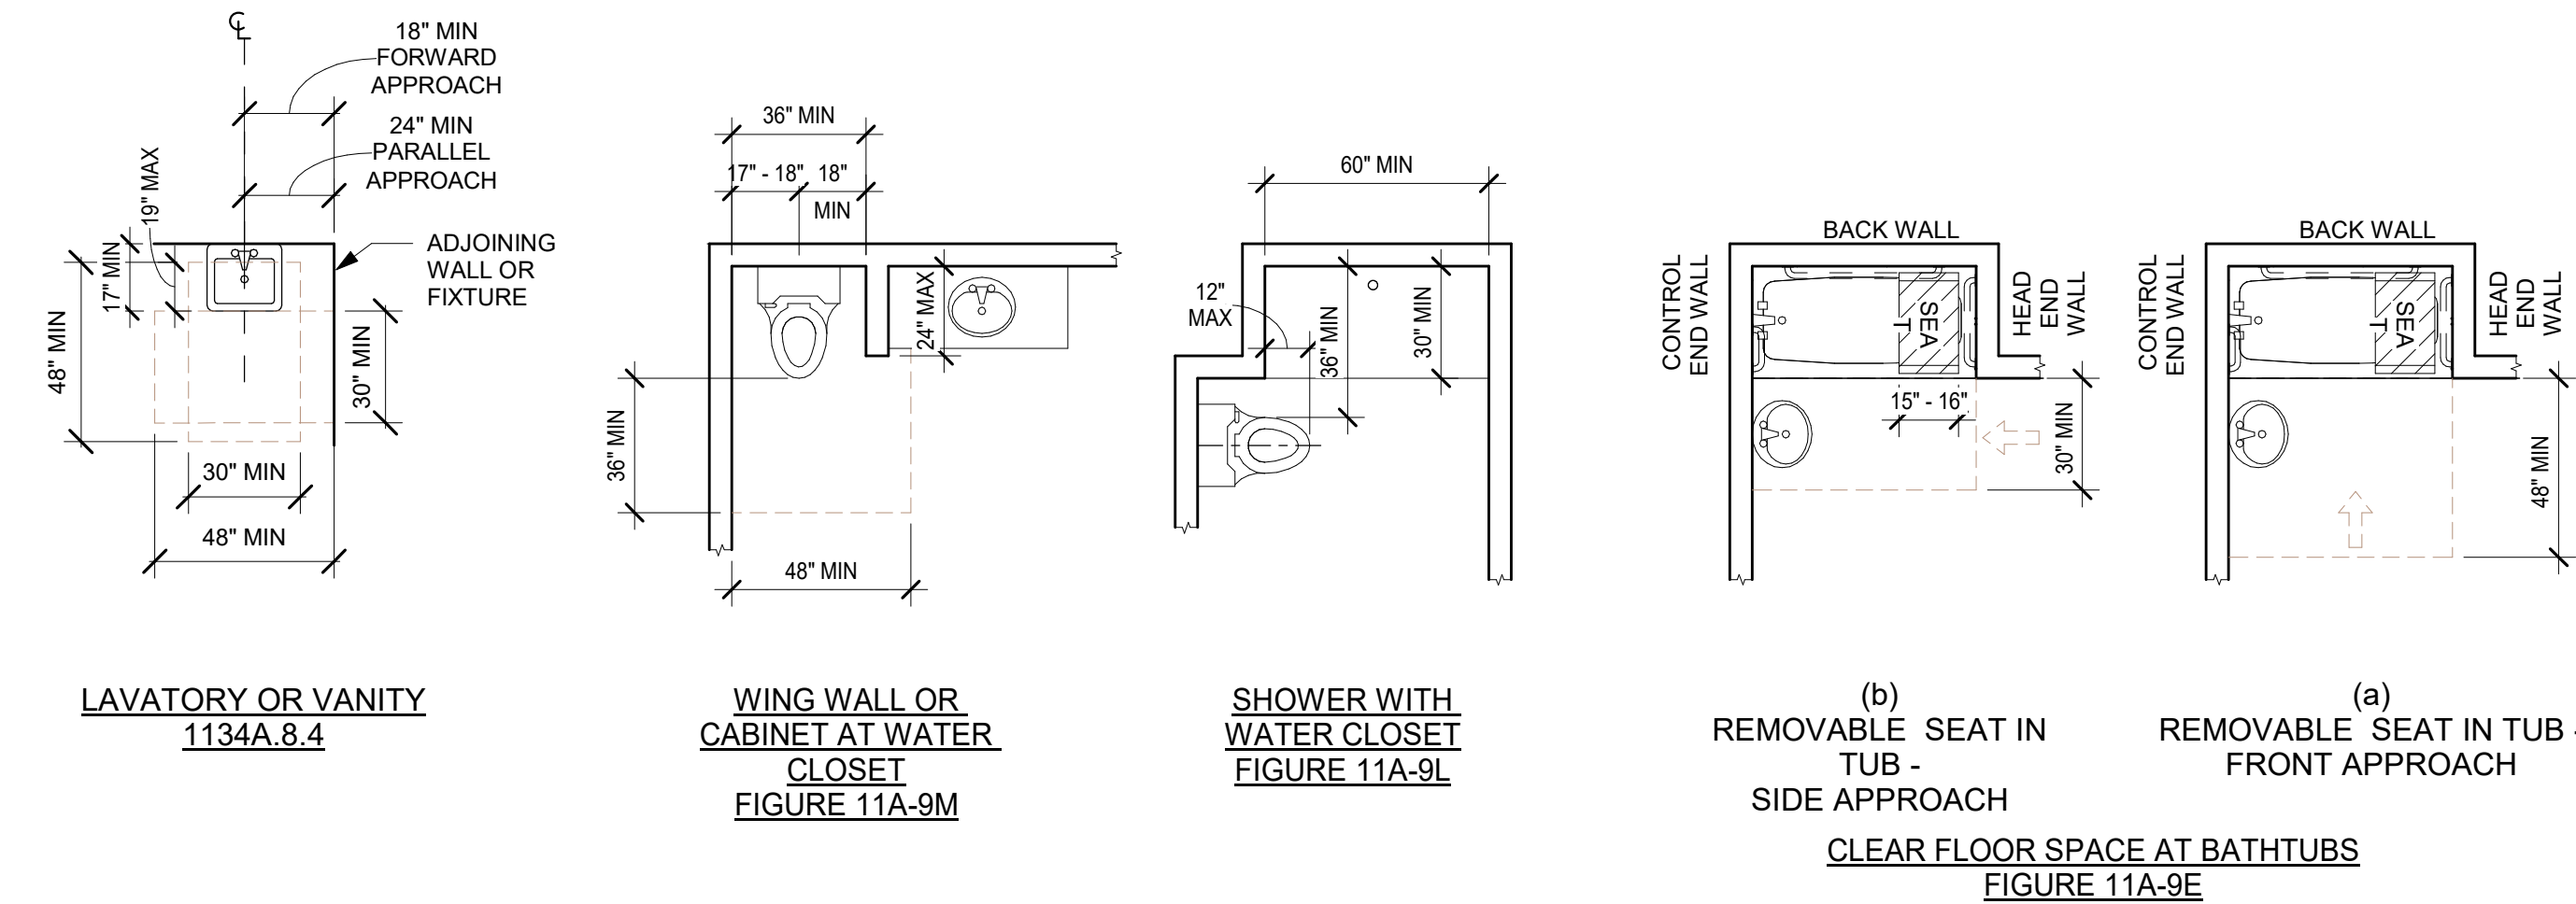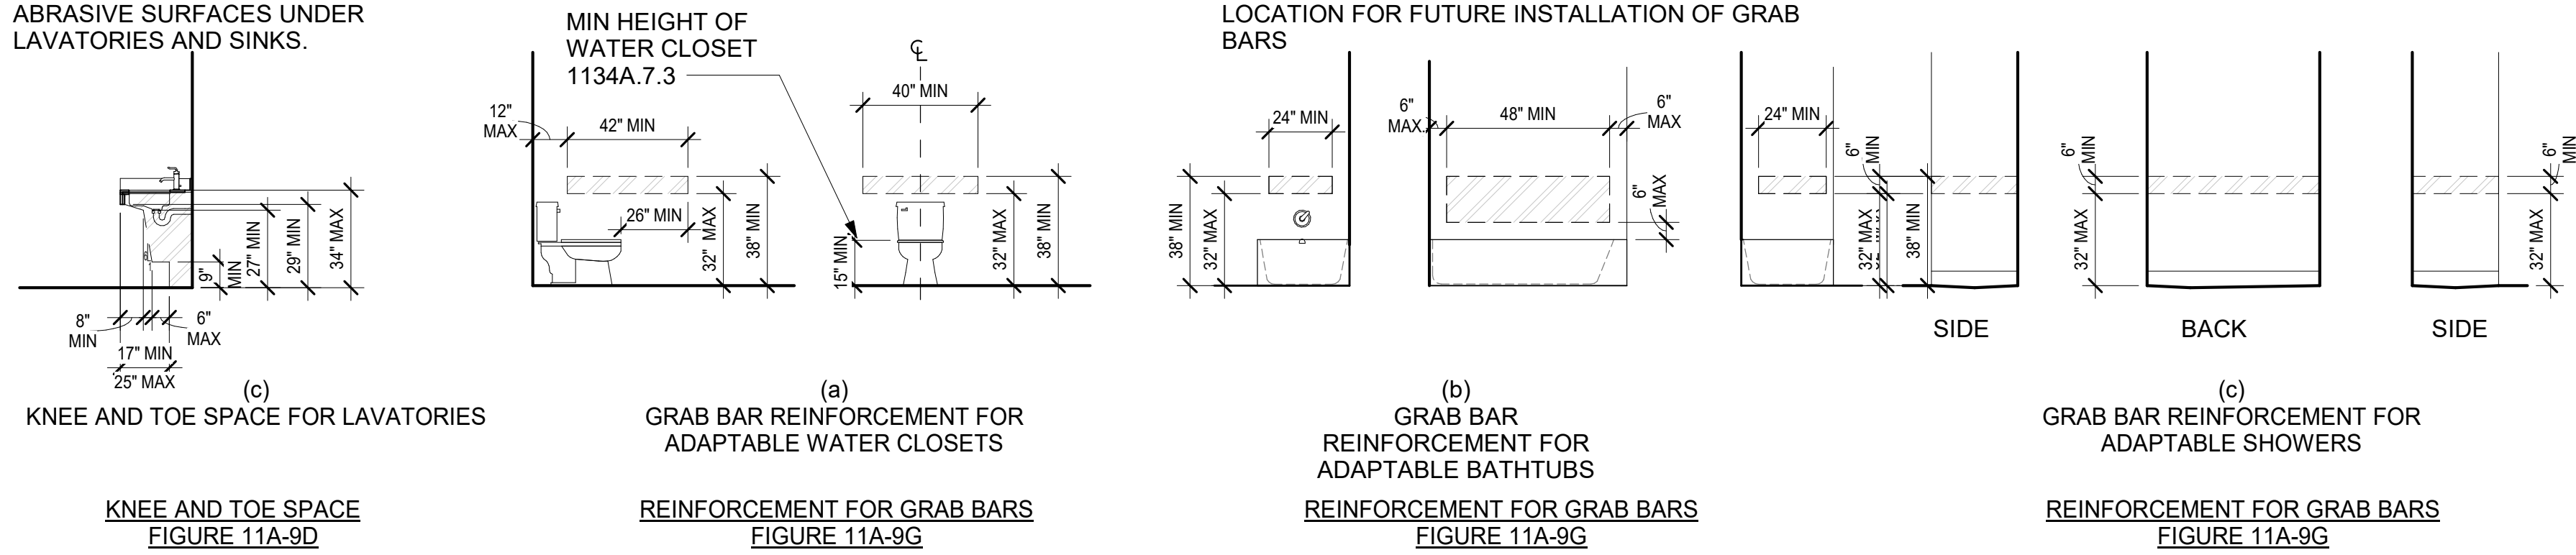

3 ACCESSIBLE PARKING
1/4" = 1'-0"

STRUCTURAL STRENGTH REQUIREMENTS PER CBC 1127A.4.4

1. BENDING STRESS IN A GRAB BAR OR SEAT INDUCED BY THE MAXIMUM BENDING MOMENT FROM THE APPLICATION OF A 250-POUND (1112 N) POINT LOAD SHALL BE LESS THAN THE ALLOWABLE STRESS FOR THE MATERIAL OF THE GRAB BAR OR SEAT.
2. SHEAR STRESS INDUCED IN A GRAB BAR OR SEAT BY THE APPLICATION OF A 250-POUND (1112 N) POINT LOAD SHALL BE LESS THAN THE ALLOWABLE SHEAR STRESS FOR THE MATERIAL OF THE GRAB BAR OR SEAT AND IF ITS MOUNTING BRACKET OR OTHER SUPPORT IS CONSIDERED TO BE FULLY RESTRAINED, THEN DIRECT AND TORSIONAL SHEAR STRESSES SHALL NOT EXCEED THE ALLOWABLE SHEAR STRESS.
3. SHEAR FORCE INDUCED IN A FASTENER OR MOUNTING DEVICE FROM THE APPLICATION OF A 250-POUND (1112 N) POINT LOAD SHALL BE LESS THAN THE ALLOWABLE LATERAL LOAD OF EITHER THE FASTENER OR MOUNTING DEVICE OR THE SUPPORTING STRUCTURE, WHICHEVER IS THE SMALLER ALLOWABLE LOAD.
4. TENSILE FORCE INDUCED IN A FASTENER BY A DIRECT TENSION FORCE OF A 200-POUND (1112 N) POINT LOAD, PLUS THE MAXIMUM MOMENT FROM THE APPLICATION OF A 250-POUND (1112 N) POINT LOAD, SHALL BE LESS THAN THE ALLOWABLE WITHDRAWAL LOAD BETWEEN THE FASTENER AND THE SUPPORTING STRUCTURE.
5. GRAB BARS SHALL NOT ROTATE WITHIN THEIR FITTINGS.

ONE SANTA ROSA AVE

1 SRA LLC

1 Santa Rosa Ave
Santa Rosa, CA 95404

OWNER

1 SRA LLC
PO Box 8001
Napa, CA 94559
Phone: 415.519.7574

ARCHITECT

LOWNEY ARCHITECTURE
360 17th Street, Suite 200
Oakland, CA 94612
Phone: 510.269.1124

STRUCTURAL

INNOVATIVE STRUCTURAL
ENGINEERING, INC.
40810 County Center Dr Suite
110 Temecula, CA 92591
Phone: 951.226.4355

CIVIL ENGINEERING

BFK ENGINEERS
200 4th Street, Suite 300,
Santa Rosa, CA 95401
Phone: 707.583.8528

MEP

FARD ENGINEERS, INC.
309 Lennon Lane, Suite 200
Walnut Creek, CA 94598
Phone: 925.932.5505

LANDSCAPE ARCHITECT

LOWNEY ARCHITECTURE
360 17th Street, Suite 200
Oakland, CA 94612
Phone: 510.836.5400

STAMP

NOT FOR
CONSTRUCTION

#	DATE	ISSUES & REVISIONS	BY
04/14/2020	100% SD	PS	
04/17/2020	100% SD UPDATES	PS	
05/20/2020	DESIGN REVIEW BOARD	PS	
07/02/2020	REDUCED REVIEW AUTHORITY DESIGN REVIEW	PS	

DRAWN BY: SDLP
PROJECT NUMBER: 19-186
SHEET ISSUE DATE: 07/02/20
SHEET TITLE:

ACCESSIBILITY DIAGRAMS

SHEET NUMBER

G0.2

ALL DRAWINGS AND WRITTEN MATERIAL APPEARING HEREIN CONSTITUTE ORIGINAL AND UNPUBLISHED WORK OF THE ARCHITECT AND MAY NOT BE DUPLICATED, USED OR DISCLOSED WITHOUT WRITTEN CONSENT OF THE ARCHITECT

2019 CALIFORNIA GREEN BUILDING STANDARDS CODE

RESIDENTIAL MANDATORY MEASURES, SHEET 1 (January 2020, Includes August 2019 Supplement)

Y	NA	RESPON PARTY	CHAPTER 3 GREEN BUILDING SECTION 301 GENERAL	Y	NA	RESPON PARTY
			301.1 SCOPE. Buildings shall be designed to include the green building measures specified as mandatory in the application checklists contained in this code. Voluntary green building measures are also included in the application checklists and may be included in the design and construction of structures covered by this code, but are not required unless adopted by a city, county, or city and county as specified in Section 101.7.			
			301.1.1 Additions and alterations. [HCD] The mandatory provisions of Chapter 4 shall be applied to additions or alterations of existing residential buildings where the addition or alteration increases the building's conditioned area, volume, or size. The requirements shall apply only to and/or within the specific area of the addition or alteration.			
			Note: On and after January 1, 2014, residential buildings undergoing permitted alterations, additions, or improvements shall replace noncompliant plumbing fixtures with water-conserving plumbing fixtures. Plumbing fixture replacement is required prior to issuance of a certificate of final completion, certificate of occupancy or final permit approval by the local building department. See Civil Code Section 1101.1, et seq., for the definition of a noncompliant plumbing fixture, types of residential buildings affected and other important enactment dates.			
			301.2 LOW-RISE AND HIGH-RISE RESIDENTIAL BUILDINGS. [HCD] The provisions of individual sections of CALGreen may apply to either low-rise residential buildings high-rise residential buildings, or both. Individual sections will be designated by banners to indicate where the section applies specifically to low-rise only (LR) or high-rise only (HR). When the section applies to both low-rise and high-rise buildings, no banner will be used.			
			SECTION 302 MIXED OCCUPANCY BUILDINGS			
			302.1 MIXED OCCUPANCY BUILDINGS. In mixed occupancy buildings, each portion of a building shall comply with the specific green building measures applicable to each specific occupancy.			
			ABBREVIATION DEFINITIONS: HCD Department of Housing and Community Development BSC California Building Standards Commission DSA-SS Division of the State Architect, Structural Safety OSHPD Office of Statewide Health Planning and Development LR Low Rise HR High Rise AA Additions and Alterations N New			
			CHAPTER 4 RESIDENTIAL MANDATORY MEASURES			
			DIVISION 4.1 PLANNING AND DESIGN			
			SECTION 4.102 DEFINITIONS 4.102.1 DEFINITIONS The following terms are defined in Chapter 2 (and are included here for reference)			
			FRENCH DRAIN. A trench, hole or other depressed area loosely filled with rock, gravel, fragments of brick or similar pervious material used to collect or channel drainage or runoff water.			
			WATTLES. Wattles are used to reduce sediment in runoff. Wattles are often constructed of natural plant materials such as hay, straw or similar material shaped in the form of tubes and placed on a downflow slope. Wattles are also used for perimeter and inlet controls.			
			4.106 SITE DEVELOPMENT 4.106.1 GENERAL. Preservation and use of available natural resources shall be accomplished through evaluation and careful planning to minimize negative effects on the site and adjacent areas. Preservation of slopes, management of storm water drainage and erosion controls shall comply with this section.			
			4.106.2 STORM WATER DRAINAGE AND RETENTION DURING CONSTRUCTION. Projects which disturb less than one acre of soil and are not part of a larger common plan of development which in total disturbs one acre or more, shall manage storm water drainage during construction. In order to manage storm water drainage during construction, one or more of the following measures shall be implemented to prevent flooding of adjacent property, prevent erosion and retain soil runoff on the site.			
			1. Retention basins of sufficient size shall be utilized to retain storm water on the site. 2. Where storm water is conveyed to a public drainage system, collection point, gutter or similar disposal method, water shall be filtered by use of a barrier system, wattle or other method approved by the enforcing agency. 3. Compliance with a lawfully enacted storm water management ordinance.			
			Note: Refer to the State Water Resources Control Board for projects which disturb one acre or more of soil, or are part of a larger common plan of development which in total disturbs one acre or more of soil. (Website: https://www.waterboards.ca.gov/water_issues/programs/stormwater/construction.html)			
			4.106.3 GRADING AND PAVING. Construction plans shall indicate how the site grading or drainage system will manage all surface water flows to keep water from entering buildings. Examples of methods to manage surface water include, but are not limited to, the following:			
			1. Swales 2. Water collection and disposal systems 3. French drains 4. Water retention gardens 5. Other water measures which keep surface water away from buildings and aid in groundwater recharge.			
			Exception : Additions and alterations not altering the drainage path.			
			4.106.4 Electric vehicle (EV) charging for new construction. New construction shall comply with Sections 4.106.4.1, 4.106.4.2, or 4.106.4.3 to facilitate future installation and use of EV chargers. Electric vehicle supply equipment (EVSE) shall be installed in accordance with the California Electrical Code, Article 625.			
			Exceptions: 1. On a case-by-case basis, where the local enforcing agency has determined EV charging and infrastructure are not feasible based upon one or more of the following conditions: 1.1 Where there is no commercial power supply. 1.2 Where there is evidence substantiating that meeting the requirements will alter the local utility infrastructure design requirements on the utility side of the meter so as to increase the utility side cost to the homeowner or the developer by more than \$400.00 per dwelling unit. 2. Accessory Dwelling Units (ADU) and Junior Accessory Dwelling Units (JADU) without additional parking facilities.			
			4.106.4.1 New one- and two-family dwellings and townhouses with attached private garages. For each dwelling unit, install a listed raceway to accommodate a dedicated 208/240-volt branch circuit. The raceway shall not be less than trade size 1 (nominal 1-inch inside diameter). The raceway shall originate at the main service or subpanel and shall terminate into a listed cabinet, box or other enclosure in close proximity to the proposed location of an EV charger. Raceways are required to be continuous at enclosed, inaccessible or concealed areas and spaces. The service panel and/or subpanel shall provide capacity to install a 40-ampere minimum dedicated branch circuit and space(s) reserved to permit installation of a branch circuit overcurrent protective device.			
			4.106.4.1.1 Identification. The service panel or subpanel circuit directory shall identify the overcurrent protective device space(s) reserved for future EV charging as "EV CAPABLE". The raceway termination location shall be permanently and visibly marked as "EV CAPABLE".			
			4.106.4.2 New multifamily dwellings. If residential parking is available, ten (10) percent of the total number of parking spaces on a building site, provided for all types of parking facilities, shall be electric vehicle charging spaces (EV spaces) capable of supporting future EVSE. Calculations for the required number of EV spaces shall be rounded up to the nearest whole number.			
			Notes: 1. Construction documents are intended to demonstrate the project's capability and capacity for facilitating future EV charging. 2. There is no requirement for EV spaces to be constructed or available until EV chargers are installed for use.			
			4.106.4.2.1 Electric vehicle charging space (EV space) locations. Construction documents shall indicate the location of proposed EV spaces. Where common use parking is provided at least one EV space shall be located in the common use parking area and shall be available for use by all residents.			

Y	NA	RESPON PARTY	4.106.4.2.1.1 Electric Vehicle Charging Stations (EVCS) When EV chargers are installed, EV spaces required by Section 4.106.2.2, Item 3, shall comply with at least one of the following options: 1. The EV space shall be located adjacent to an accessible parking space meeting the requirements of the California Building Code, Chapter 11A, to allow use of the EV charger from the accessible parking space. 2. The EV space shall be located on an accessible route, as defined in the California Building Code, Chapter 2, to the building. Exception: Electric vehicle charging stations designed and constructed in compliance with the California Building Code, Chapter 11B, are not required to comply with Section 4.106.4.2.1.1 and Section 4.106.4.2.2, Item 3. Note: Electric Vehicle charging stations serving public housing are required to comply with the California Building Code, Chapter 11B.	Y	NA	RESPON PARTY																		
			4.106.4.2.2 Electric vehicle charging space (EV space) dimensions. The EV space shall be designed to comply with the following: 1. The minimum length of each EV space shall be 18 feet (5486 mm). 2. The minimum width of each EV space shall be 9 feet (2743 mm). 3. One in every 25 EV spaces, but not less than one EV space, shall have an 8-foot (2438 mm) wide minimum aisle. A 5-foot (1524 mm) wide minimum aisle shall be permitted provided the minimum width of the EV space is 12 feet (3659 mm). a. Surface slope for this EV space and the aisle shall not exceed 1 unit vertical in 48 units horizontal (2.083 percent slope) in any direction.																					
			4.106.4.2.3 Single EV space required. Install a listed raceway capable of accommodating a 208/240-volt dedicated branch circuit. The raceway shall not be less than trade size 1 (nominal 1-inch inside diameter). The raceway shall originate at the main service or subpanel and shall terminate into a listed cabinet, box or enclosure in close proximity to the proposed location of the EV space. Construction documents shall identify the raceway termination point. The service panel and/or subpanel shall provide capacity to install a 40-ampere minimum dedicated branch circuit and space(s) reserved to permit installation of a branch circuit overcurrent protective device.																					
			4.106.4.2.4 Multiple EV spaces required. Construction documents shall indicate the raceway termination point and proposed location of future EV spaces and EV chargers. Construction documents shall also provide information on amperage of future EVSE, raceway method(s), wiring schematics and electrical load calculations to verify that the electrical panel service capacity and electrical system, including any on-site distribution transformer(s), have sufficient capacity to simultaneously charge all EVs at all required EV spaces at the full rated amperage of the EVSE. Plan design shall be based upon a 40-ampere minimum branch circuit. Required raceways and related components that are planned to be installed underground, enclosed, inaccessible or in concealed areas and spaces shall be installed at the time of original construction.																					
			4.106.4.2.5 Identification. The service panel or subpanel circuit directory shall identify the overcurrent protective device space(s) reserved for future EV charging purposes as "EV CAPABLE" in accordance with the California Electrical Code.																					
			4.106.4.3 New hotels and motels. All newly constructed hotels and motels shall provide EV spaces capable of supporting future installation of EVSE. The construction documents shall identify the location of the EV spaces.																					
			Notes: 1. Construction documents are intended to demonstrate the project's capability and capacity or facilitating future EV charging. 2. There is no requirement for EV spaces to be constructed or available until EV chargers are installed for use.																					
			4.106.4.3.1 Number of required EV spaces. The number of required EV spaces shall be based on the total number of parking spaces provided for all types of parking facilities in accordance with Table 4.106.4.3.1. Calculations for the required number of EV spaces shall be rounded up to the nearest whole number.																					
			TABLE 4.106.4.3.1 <table><thead><tr><th>TOTAL NUMBER OF PARKING SPACES</th><th>NUMBER OF REQUIRED EV SPACES</th></tr></thead><tbody><tr><td>0-9</td><td>0</td></tr><tr><td>10-25</td><td>1</td></tr><tr><td>26-50</td><td>2</td></tr><tr><td>51-75</td><td>4</td></tr><tr><td>76-100</td><td>5</td></tr><tr><td>101-150</td><td>7</td></tr><tr><td>151-200</td><td>10</td></tr><tr><td>201 and over</td><td>6 percent of total</td></tr></tbody></table>	TOTAL NUMBER OF PARKING SPACES	NUMBER OF REQUIRED EV SPACES	0-9	0	10-25	1	26-50	2	51-75	4	76-100	5	101-150	7	151-200	10	201 and over	6 percent of total			
TOTAL NUMBER OF PARKING SPACES	NUMBER OF REQUIRED EV SPACES																							
0-9	0																							
10-25	1																							
26-50	2																							
51-75	4																							
76-100	5																							
101-150	7																							
151-200	10																							
201 and over	6 percent of total																							
			4.106.4.3.2 Electric vehicle charging space (EV space) dimensions. The EV spaces shall be designed to comply with the following: 1. The minimum length of each EV space shall be 18 feet (5486mm). 2. The minimum width of each EV space shall be 9 feet (2743mm)																					
			4.106.4.3.3 Single EV space required. When a single EV space is required, the EV space shall be designed in accordance with Section 4.106.4.2.3.																					
			4.106.4.3.4 Multiple EV spaces required. When multiple EV spaces are required, the EV spaces shall be designed in accordance with Section 4.106.4.2.4.																					
			4.106.4.3.5 Identification. The service panels or sub-panels shall be identified in accordance with Section 4.106.4.2.5.																					
			4.106.4.3.6 Accessible EV spaces. In addition to the requirements in Section 4.106.4.3, EV spaces for hotels/motels and all EVSE, when installed, shall comply with the accessibility provisions for the EV charging stations in the California Building Code, Chapter 11B.																					
			DIVISION 4.2 ENERGY EFFICIENCY																					
			4.201 GENERAL																					
			4.201.1 SCOPE. For the purposes of mandatory energy efficiency standards in this code, the California Energy Commission will continue to adopt mandatory standards.																					

Y	NA	RESPON PARTY	DIVISION 4.3 WATER EFFICIENCY AND CONSERVATION	Y	NA	RESPON PARTY																
			4.303 INDOOR WATER USE																			
			4.303.1 WATER CONSERVING PLUMBING FIXTURES AND FITTINGS. Plumbing fixtures (water closets and urinals) and fittings (faucets and showerheads) shall comply with the sections 4.303.1.1, 4.303.1.2, 4.303.1.3, and 4.303.4.4.																			
			Note: All noncompliant plumbing fixtures in any residential real property shall be replaced with water-conserving plumbing fixtures. Plumbing fixture replacement is required prior to issuance of a certificate of final completion, certificate of occupancy, or final permit approval by the local building department. See Civil Code Section 1101.1, et seq., for the definition of a noncompliant plumbing fixture, types of residential buildings affected and other important enactment dates.																			
			4.303.1.1 Water Closets. The effective flush volume of all water closets shall not exceed 1.28 gallons per flush. Tank-type water closets shall be certified to the performance criteria of the U.S. EPA WaterSense Specification for Tank-type Toilets.																			
			Note: The effective flush volume of dual flush toilets is defined as the composite, average flush volume of two reduced flushes and one full flush.																			
			4.303.1.2 Urinals. The effective flush volume of wall mounted urinals shall not exceed 0.125 gallons per flush. The effective flush volume of all other urinals shall not exceed 0.5 gallons per flush.																			
			4.303.1.3 Showerheads.																			
			4.303.1.3.1 Single Showerhead. Showerheads shall have a maximum flow rate of not more than 1.8 gallons per minute at 80 psi. Showerheads shall be certified to the performance criteria of the U.S. EPA WaterSense Specification for Showerheads.																			
			4.303.1.3.2 Multiple showerheads serving one shower. When a shower is served by more than one showerhead, the combined flow rate of all the showerheads and/or other shower outlets controlled by a single valve shall not exceed 1.8 gallons per minute at 80 psi, or the shower shall be designed to only allow one shower outlet to be in operation at a time.																			
			Note: A hand-held shower shall be considered a showerhead.																			
			4.303.1.4 Faucets.																			
			4.303.1.4.1 Residential Lavatory Faucets. The maximum flow rate of residential lavatory faucets shall not exceed 1.2 gallons per minute at 60 psi. The minimum flow rate of residential lavatory faucets shall not be less than 0.8 gallons per minute at 20 psi.																			
			4.303.1.4.2 Lavatory Faucets in Common and Public Use Areas. The maximum flow rate of lavatory faucets installed in common and public use areas (outside of dwellings or sleeping units) in residential buildings shall not exceed 0.5 gallons per minute at 60 psi.																			
			4.303.1.4.3 Metering Faucets. Metering faucets when installed in residential buildings shall not deliver more than 0.2 gallons per cycle.																			
			4.303.1.4.4 Kitchen Faucets. The maximum flow rate of kitchen faucets shall not exceed 1.8 gallons per minute at 60 psi. Kitchen faucets may temporarily increase the flow above the maximum rate, but not to exceed 2.2 gallons per minute at 60 psi, and must default to a maximum flow rate of 1.8 gallons per minute at 60 psi.																			
			Note: Where complying faucets are unavailable, aerators or other means may be used to achieve reduction.																			
			4.303.2 STANDARDS FOR PLUMBING FIXTURES AND FITTINGS. Plumbing fixtures and fittings shall be installed in accordance with the California Plumbing Code, and shall meet the applicable standards referenced in Table 1701.1 of the California Plumbing Code.																			
			NOTE: THIS TABLE COMPILES THE DATA IN SECTION 4.303.1, AND IS INCLUDED AS A CONVENIENCE FOR THE USER.																			
			TABLE - MAXIMUM FIXTURE WATER USE <table><thead><tr><th>FIXTURE TYPE</th><th>FLOW RATE</th></tr></thead><tbody><tr><td>SHOWER HEADS (RESIDENTIAL)</td><td>1.8 GMP @ 80 PSI</td></tr><tr><td>LAVATORY FAUCETS (RESIDENTIAL)</td><td>MAX. 1.2 GPM @ 60 PSI MIN. 0.8 GPM @ 20 PSI</td></tr><tr><td>LAVATORY FAUCETS IN COMMON & PUBLIC USE AREAS</td><td>0.5 GPM @ 60 PSI</td></tr><tr><td>KITCHEN FAUCETS</td><td>1.8 GPM @ 60 PSI</td></tr><tr><td>METERING FAUCETS</td><td>0.2 GAL/CYCLE</td></tr><tr><td>WATER CLOSET</td><td>1.28 GAL/FLUSH</td></tr><tr><td>URINALS</td><td>0.125 GAL/FLUSH</td></tr></tbody></table>	FIXTURE TYPE	FLOW RATE	SHOWER HEADS (RESIDENTIAL)	1.8 GMP @ 80 PSI	LAVATORY FAUCETS (RESIDENTIAL)	MAX. 1.2 GPM @ 60 PSI MIN. 0.8 GPM @ 20 PSI	LAVATORY FAUCETS IN COMMON & PUBLIC USE AREAS	0.5 GPM @ 60 PSI	KITCHEN FAUCETS	1.8 GPM @ 60 PSI	METERING FAUCETS	0.2 GAL/CYCLE	WATER CLOSET	1.28 GAL/FLUSH	URINALS	0.125 GAL/FLUSH			
FIXTURE TYPE	FLOW RATE																					
SHOWER HEADS (RESIDENTIAL)	1.8 GMP @ 80 PSI																					
LAVATORY FAUCETS (RESIDENTIAL)	MAX. 1.2 GPM @ 60 PSI MIN. 0.8 GPM @ 20 PSI																					
LAVATORY FAUCETS IN COMMON & PUBLIC USE AREAS	0.5 GPM @ 60 PSI																					
KITCHEN FAUCETS	1.8 GPM @ 60 PSI																					
METERING FAUCETS	0.2 GAL/CYCLE																					
WATER CLOSET	1.28 GAL/FLUSH																					
URINALS	0.125 GAL/FLUSH																					
			4.304 OUTDOOR WATER USE																			
			4.304.1 OUTDOOR POTABLE WATER USE IN LANDSCAPE AREAS. Residential developments shall comply with a local water efficient landscape ordinance or the current California Department of Water Resources' Model Water Efficient Landscape Ordinance (MWELO), whichever is more stringent.																			
			NOTES: 1. The Model Water Efficient Landscape Ordinance (MWELO) is located in the California Code Regulations, Title 23, Chapter 2.7, Division 2. MWELO and supporting documents, including water budget calculator, are available at: https://www.water.ca.gov/																			

Y	NA	RESPON PARTY	DIVISION 4.4 MATERIAL CONSERVATION AND RESOURCE EFFICIENCY	Y	NA	RESPON PARTY
			4.406 ENHANCED DURABILITY AND REDUCED MAINTENANCE			
			4.406.1 RODENT PROOFING. Annular spaces around pipes, electric cables, conduits or other openings in sole/bottom plates at exterior walls shall be protected against the passage of rodents by closing such openings with cement mortar, concrete masonry or a similar method acceptable to the enforcing agency.			
			4.408 CONSTRUCTION WASTE REDUCTION, DISPOSAL AND RECYCLING			
			4.408.1 CONSTRUCTION WASTE MANAGEMENT. Recycle and/or salvage for reuse a minimum of 65 percent of the non-hazardous construction and demolition waste in accordance with either Section 4.408.2, 4.408.3 or 4.408.4, or meet a more stringent local construction and demolition waste management ordinance.			
			Exceptions: 1. Excavated soil and land-clearing debris. 2. Alternate waste reduction methods developed by working with local agencies if diversion or recycle facilities capable of compliance with this item do not exist or are not located reasonably close to the jobsite. 3. The enforcing agency may make exceptions to the requirements of this section when isolated jobsites are located in areas beyond the haul boundaries of the diversion facility.			
			4.408.2 CONSTRUCTION WASTE MANAGEMENT PLAN. Submit a construction waste management plan in conformance with Items 1 through 5. The construction waste management plan shall be updated as necessary and shall be available during construction for examination by the enforcing agency.			
			1. Identify the construction and demolition waste materials to be diverted from disposal by recycling, reuse on the project or salvage for future use or sale. 2. Specify if construction and demolition waste materials will be sorted on-site (source separated) or bulk mixed (single stream). 3. Identify diversion facilities where the construction and demolition waste material collected will be taken. 4. Identify construction methods employed to reduce the amount of construction and demolition waste generated. 5. Specify that the amount of construction and demolition waste materials diverted shall be calculated by weight or volume, but not by both.			
			4.408.3 WASTE MANAGEMENT COMPANY. Utilize a waste management company, approved by the enforcing agency, which can provide verifiable documentation that the percentage of construction and demolition waste material diverted from the landfill complies with Section 4.408.1.			
			Note: The owner or contractor may make the determination if the construction and demolition waste materials will be diverted by a waste management company.			
			4.408.4 WASTE STREAM REDUCTION ALTERNATIVE [LR]. Projects that generate a total combined weight of construction and demolition waste disposed of in landfills, which do not exceed 3.4 lbs./sq. ft. of the building area shall meet the minimum 65% construction waste reduction requirement in Section 4.408.1.			
			4.408.4.1 WASTE STREAM REDUCTION ALTERNATIVE. Projects that generate a total combined weight of construction and demolition waste disposed of in landfills, which do not exceed 2 pounds per square foot of the building area, shall meet the minimum 65% construction waste reduction requirement in Section 4.408.1.			
			4.408.5 DOCUMENTATION. Documentation shall be provided to the enforcing agency which demonstrates compliance with Section 4.408.2, Items 1 through 5, Section 4.408.3 or Section 4.408.4.			
			Notes: 1. Sample forms found in "A Guide to the California Green Building Standards Code (Residential)" located at www.hcd.ca.gov/CALGreen.html may be used to assist in documenting compliance with this section. 2. Mixed construction and demolition debris (C & D) processors can be located at the California Department of Resources Recycling and Recovery (CalRecycle).			
			4.410 BUILDING MAINTENANCE AND OPERATION			
			4.410.1 OPERATION AND MAINTENANCE MANUAL. At the time of final inspection, a manual, compact disc, web-based reference or other media acceptable to the enforcing agency which includes all of the following shall be placed in the building: 1. Directions to the owner or occupant that the manual shall remain with the building throughout the life cycle of the structure. 2. Operation and maintenance instructions for the following: a. Equipment and appliances, including water-saving devices and systems, HVAC systems, photovoltaic systems, electric vehicle chargers, water-heating systems and other major appliances and equipment. b. Roof and yard drainage, including gutters and downspouts. c. Space conditioning systems, including condensers and air filters. d. Landscape irrigation systems. e. Water reuse systems. 3. Information from local utility, water and waste recovery providers on methods to further reduce resource consumption, including recycle programs and locations. 4. Public transportation and/or carpool options available in the area. 5. Educational material on the positive impacts of an interior relative humidity between 30-60 percent and what methods an occupant may use to maintain the relative humidity level in that range. 6. Information about water-conserving landscape and irrigation design and controllers which conserve water. 7. Instructions for maintaining gutters and downspouts and the importance of diverting water at least 5 feet away from the foundation. 8. Information on required routine maintenance measures, including, but not limited to, caulking, painting, grading around the building, etc. 9. Information about state solar energy and incentive programs available. 10. A copy of all special inspections verifications required by the enforcing agency or this code.			
			4.410.2 RECYCLING BY OCCUPANTS. Where 5 or more multifamily dwelling units are constructed on a building site, provide readily accessible area(s) that serves all buildings on the site and are identified for the depositing, storage and collection of non-hazardous materials for recycling, including (at a minimum) paper, corrugated cardboard, glass, plastics, organic waste, and metals, or meet a lawfully enacted local recycling ordinance, if more restrictive.			
			Exception: Rural jurisdictions that meet and apply for the exemption in Public Resources Code Section 42649.82 (a)(2)(A) et seq. are note required to comply with the organic waste portion of this section.			
			DIVISION 4.5 ENVIRONMENTAL QUALITY			
			SECTION 4.501 GENERAL			
			4.501.1 Scope The provisions of this chapter shall outline means of reducing the quality of air contaminants that are odorous, irritating and/or harmful to the comfort and well being of a building's installers, occupants and neighbors.			
			SECTION 4.502 DEFINITIONS			
			5.102.1 DEFINITIONS The following terms are defined in Chapter 2 (and are included here for reference)			
			AGRIFIBER PRODUCTS. Agrifiber products include wheatboard, strawboard, panel substrates and door cores, not including furniture, fixtures and equipment (FF&E) not considered base building elements.			
			COMPOSITE WOOD PRODUCTS. Composite wood products include hardwood plywood, particleboard and medium density fiberboard. "Composite wood products" does not include hardwood, structural plywood, structural panels, structural composite lumber, oriented strand board, glued laminated timber, prefabricated wood I-joists or finger-jointed lumber, all as specified in California Code of regulations (CCR), title 17, Section 93120.1.			
			DIRECT-VENT APPLIANCE. A fuel-burning appliance with a sealed combustion system that draws all air for combustion from the outside atmosphere and discharges all flue gases to the outside atmosphere.			



TEL 510.836.5400 URL lowneyarch.com
360 seveneenth street | suite 200 | oakland, california 94612

ONE SANTA ROSA AVE

1 SRA LLC

1 Santa Rosa Ave
Santa Rosa, CA 95404

OWNER

1 SRA LLC
PO Box 8001
Napa, CA 94559
Phone: 415.519.7574

ARCHITECT

LOWNEY ARCHITECTURE
360 17th Street, Suite 200
Oakland, CA 94612
Phone: 510.269.1124

STRUCTURAL

INNOVATIVE STRUCTURAL
ENGINEERING, INC.
40810 County Center Dr Suite
110 Temecula, CA 92591
Phone: 951.226.4355

CIVIL ENGINEERING

BKF ENGINEERS
200 4th Street, Suite 300,
Santa Rosa, CA 95401
Phone: 707.583.8528

MEP

FARD ENGINEERS, INC.
309 Lennon Lane, Suite 200
Walnut Creek, CA 94598
Phone: 925.932.5505


LANDSCAPE ARCHITECT

LOWNEY ARCHITECTURE
360 17th Street, Suite 200
Oakland, CA 94612
Phone: 510.836.5400

STAMP

NOT FOR
CONSTRUCTION

#	DATE	ISSUES & REVISIONS	BY
	07/02/2020	REDUCED REVIEW AUTHORITY DESIGN REVIEW	PS

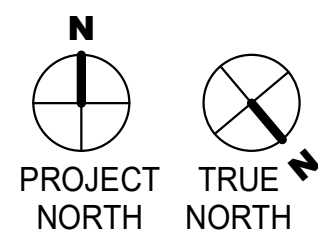

DRAWN BY: Author
PROJECT NUMBER: 19-186
SHEET ISSUE DATE: 07/02/20
SHEET TITLE:

CAL GREEN
MANDATORY
MEASURES

SHEET NUMBER

G0.3

ALL DRAWINGS AND WRITTEN MATERIAL APPEARING HEREIN
CONSTITUTE ORIGINAL AND UNPUBLISHED WORK OF THE
ARCHITECT AND MAY NOT BE DUPLICATED, USED OR DISCLOSED
WITHOUT WRITTEN CONSENT OF THE ARCHITECT

Y	=	YES
N/A	=	NOT APPLICABLE
RESPON. PARTY	=	RESPONSIBLE PARTY (i.e. ARCHITECT, ENGINEER, OWNER, CONTRACTOR, INSPECTOR ETC.)



1 Santa Rosa Ave
Santa Rosa, CA 95404

1 SRA LLC
PO Box 8001
Napa, CA 94559
Phone: 415.519.7574

LOWNEY ARCHITECTURE
360 17th Street, Suite 200
Oakland, CA 94612
Phone: 510.269.1124

INNOVATIVE STRUCTURAL
ENGINEERING, INC.
40810 County Center Dr Suite
110 Temecula, CA 92591
Phone: 951.226.4355

BFK ENGINEERS
200 4th Street, Suite 300,
Santa Rosa, CA 95401
Phone: 707.583.8528

FARD ENGINEERS, INC.
309 Lennon Lane, Suite 200
Walnut Creek, CA 94598
Phone: 925.932.5505

LOWNEY ARCHITECTURE
360 17th Street, Suite 200
Oakland, CA 94612
Phone: 510.836.5400

DRAWN BY: Author
PROJECT NUMBER: 19-186
SHEET ISSUE DATE: 07/02/20
SHEET TITLE:

G0.4

ALL DRAWINGS AND WRITTEN MATERIAL APPEARING HEREIN
CONSTITUTE ORIGINAL AND UNPUBLISHED WORK OF THE
ARCHITECT AND MAY NOT BE DUPLICATED, USED OR DISCLOSED
WITHOUT WRITTEN CONSENT OF THE ARCHITECT

[illegible]

9/4/2020 6:05:51 PM

DISCLAIMER: THIS DOCUMENT IS PROVIDED AND INTENDED TO BE USED AS A MEANS TO INDICATE AREAS OF COMPLIANCE WITH THE 2016 CALIFORNIA GREEN BUILDING STANDARDS (CALGREEN) CODE. DUE TO THE VARIABLES BETWEEN BUILDING DEPARTMENT JURISDICTIONS, THIS CHECKLIST IS TO BE USED ON AN INDIVIDUAL PROJECT BASIS AND MAY BE MODIFIED BY THE END USER TO MEET THOSE INDIVIDUAL NEEDS. THE END USER ASSUMES ALL RESPONSIBILITY ASSOCIATED WITH THE USE OF THIS DOCUMENT, INCLUDING VERIFICATION WITH THE FULL CODE.




VIEW FROM SANTA ROSA AVENUE AND 3RD STREET



VIEW FROM SANTA ROSA AVENUE AND 4TH STREET



VIEW FROM SANTA ROSA AVENUE AND 2ND STREET

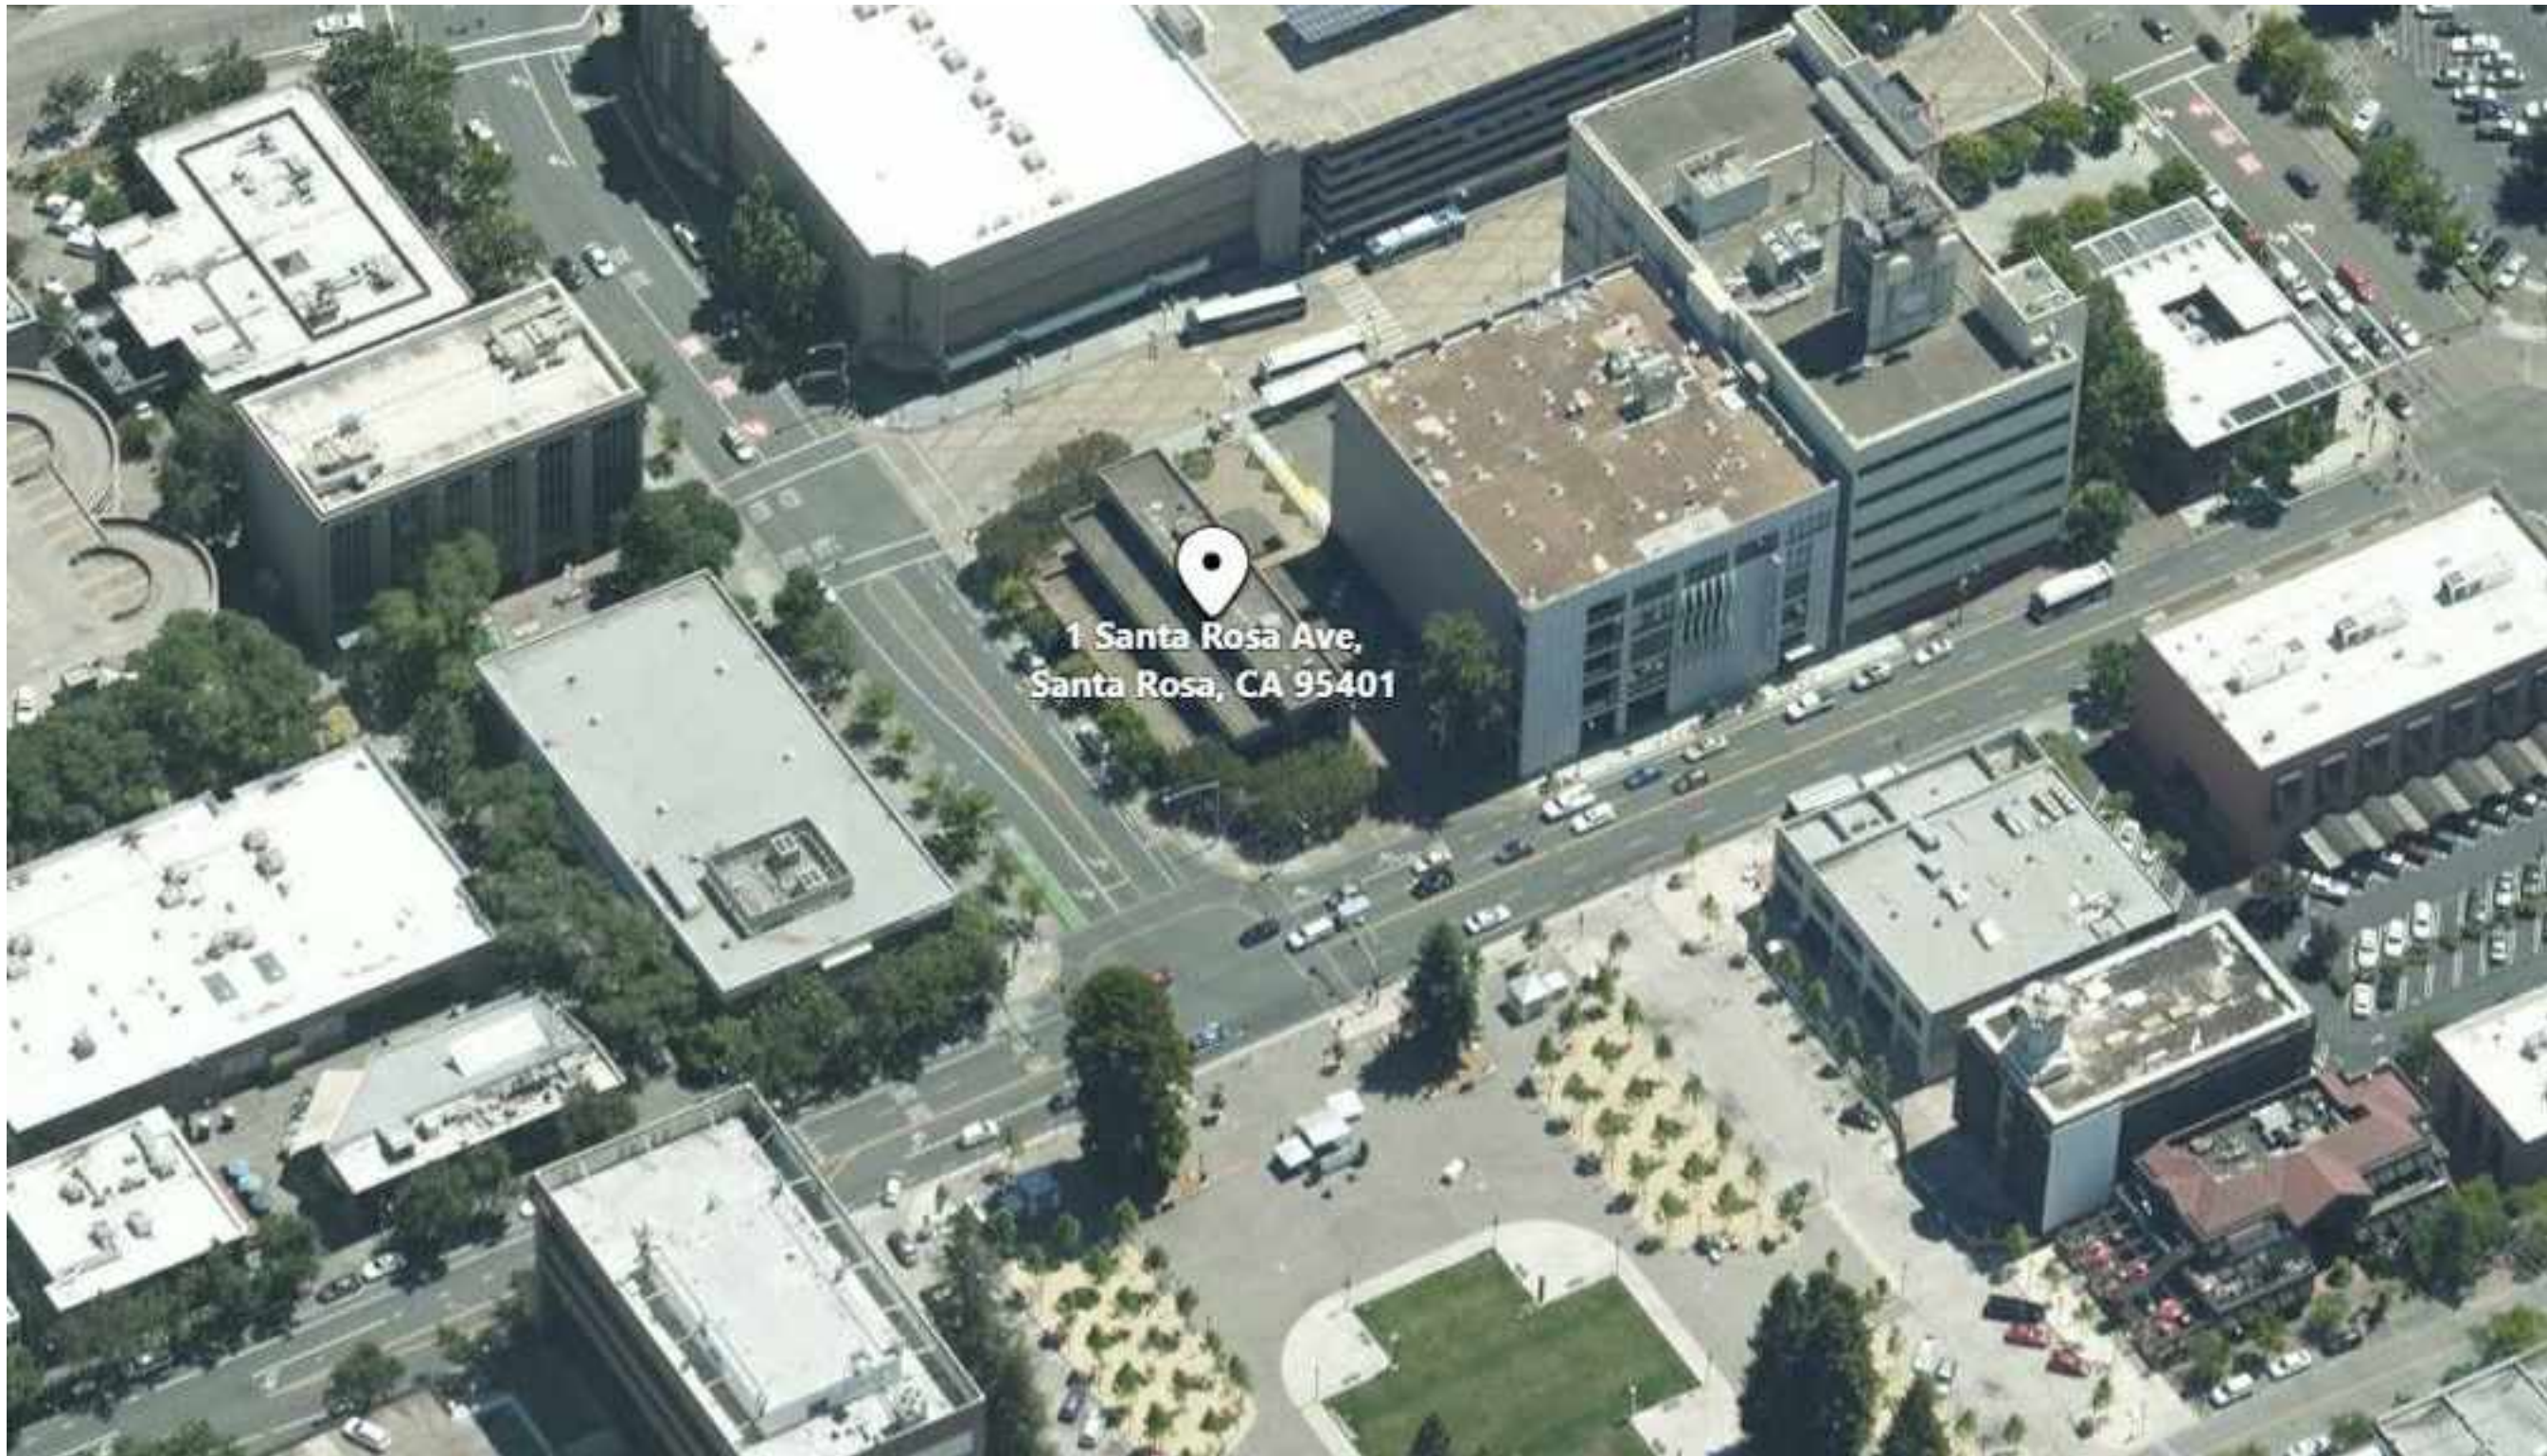

AERIAL VIEW FROM SANTA ROSA AVENUE AND 3RD STREET

ONE SANTA
ROSA AVE

1 SRA LLC

1 Santa Rosa Ave
Santa Rosa, CA 95404

OWNER

1 SRA LLC
PO Box 8001
Napa, CA 94559
Phone: 415.519.7574

ARCHITECT

LOWNEY ARCHITECTURE
360 17th Street, Suite 200
Oakland, CA 94612
Phone: 510.269.1124

STRUCTURAL

INNOVATIVE STRUCTURAL
ENGINEERING, INC.
40810 County Center Dr Suite
110 Temecula, CA 92591
Phone: 951.226.4355

CIVIL ENGINEERING

BFK ENGINEERS
200 4th Street, Suite 300,
Santa Rosa, CA 95401
Phone: 707.583.8528

MEP

FARD ENGINEERS, INC.
309 Lennon Lane, Suite 200
Walnut Creek, CA 94598
Phone: 925.932.5505


LANDSCAPE ARCHITECT

LOWNEY ARCHITECTURE
360 17th Street, Suite 200
Oakland, CA 94612
Phone: 510.836.5400

STAMP

NOT FOR
CONSTRUCTION

#	DATE	ISSUES & REVISIONS	BY
	07/02/2020	REDUCED REVIEW AUTHORITY DESIGN REVIEW	PS

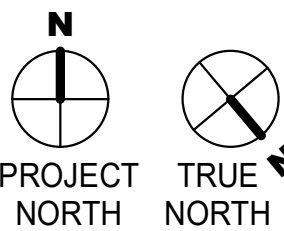

DRAWN BY: SDLP
PROJECT NUMBER: 19-186
SHEET ISSUE DATE: 07/02/20
SHEET TITLE:

EXISTING
EXTERIOR
PERSPECTIVES

SHEET NUMBER

G1.0

ALL DRAWINGS AND WRITTEN MATERIAL APPEARING HEREIN
CONSTITUTE ORIGINAL AND UNPUBLISHED WORK OF THE
ARCHITECT AND MAY NOT BE DUPLICATED, USED OR DISCLOSED
WITHOUT WRITTEN CONSENT OF THE ARCHITECT



VIEW FROM SANTA ROSA AVENUE AND 3RD STREET



VIEW FROM SANTA ROSA AVENUE AND 4TH STREET



VIEW FROM SANTA ROSA AVENUE AND 1ST STREET



AERIAL VIEW FROM SANTA ROSA AVENUE AND 3RD STREET

ONE SANTA
ROSA AVE

1 SRA LLC

1 Santa Rosa Ave
Santa Rosa, CA 95404

OWNER

1 SRA LLC
PO Box 8001
Napa, CA 94559
Phone: 415.519.7574

ARCHITECT

LOWNEY ARCHITECTURE
360 17th Street, Suite 200
Oakland, CA 94612
Phone: 510.269.1124

STRUCTURAL

INNOVATIVE STRUCTURAL
ENGINEERING, INC.
40810 County Center Dr Suite
110 Temecula, CA 92591
Phone: 951.226.4355

CIVIL ENGINEERING

BFK ENGINEERS
200 4th Street, Suite 300,
Santa Rosa, CA 95401
Phone: 707.583.8528

MEP

FARD ENGINEERS, INC.
309 Lennon Lane, Suite 200
Walnut Creek, CA 94598
Phone: 925.932.5505

LANDSCAPE ARCHITECT

LOWNEY ARCHITECTURE
360 17th Street, Suite 200
Oakland, CA 94612
Phone: 510.836.5400

STAMP

NOT FOR
CONSTRUCTION

#	DATE	ISSUES & REVISIONS	BY
	04/14/2020	100% SD	PS
2	04/17/2020	100% SD UPDATES	PS
	05/20/2020	DESIGN REVIEW BOARD	PS
	07/02/2020	REDUCED REVIEW AUTHORITY DESIGN REVIEW	PS

DRAWN BY: SDLP
PROJECT NUMBER: 19-186
SHEET ISSUE DATE: 07/02/20
SHEET TITLE:

EXTERIOR
PERSPECTIVES

SHEET NUMBER

G1.1

ALL DRAWINGS AND WRITTEN MATERIAL APPEARING HEREIN
CONSTITUTE ORIGINAL AND UNPUBLISHED WORK OF THE
ARCHITECT AND MAY NOT BE DUPLICATED, USED OR DISCLOSED
WITHOUT WRITTEN CONSENT OF THE ARCHITECT

ONE SANTA
ROSA AVE

1 SRA LLC

1 Santa Rosa Ave
Santa Rosa, CA 95404

OWNER

1 SRA LLC
PO Box 8001
Napa, CA 94559
Phone: 415.519.7574

ARCHITECT

LOWNEY ARCHITECTURE
360 17th Street, Suite 200
Oakland, CA 94612
Phone: 510.269.1124

STRUCTURAL

INNOVATIVE STRUCTURAL
ENGINEERING, INC.
40810 County Center Dr Suite
110 Temecula, CA 92591
Phone: 951.226.4355

CIVIL ENGINEERING

BFK ENGINEERS
200 4th Street, Suite 300,
Santa Rosa, CA 95401
Phone: 707.583.8528

MEP

FARD ENGINEERS, INC.
309 Lennon Lane, Suite 200
Walnut Creek, CA 94598
Phone: 925.932.5505

LANDSCAPE ARCHITECT

LOWNEY ARCHITECTURE
360 17th Street, Suite 200
Oakland, CA 94612
Phone: 510.836.5400

STAMP

NOT FOR
CONSTRUCTION

#	DATE	ISSUES & REVISIONS	BY


DRAWN BY: Author
PROJECT NUMBER: 19-186
SHEET ISSUE DATE: 04/11/17
SHEET TITLE:

ARCHITECTURAL
DIFFERENTIATION

SHEET NUMBER


G1.2

ALL DRAWINGS AND WRITTEN MATERIAL APPEARING HEREIN
CONSTITUTE ORIGINAL AND UNPUBLISHED WORK OF THE
ARCHITECT AND MAY NOT BE DUPLICATED, USED OR DISCLOSED
WITHOUT WRITTEN CONSENT OF THE ARCHITECT

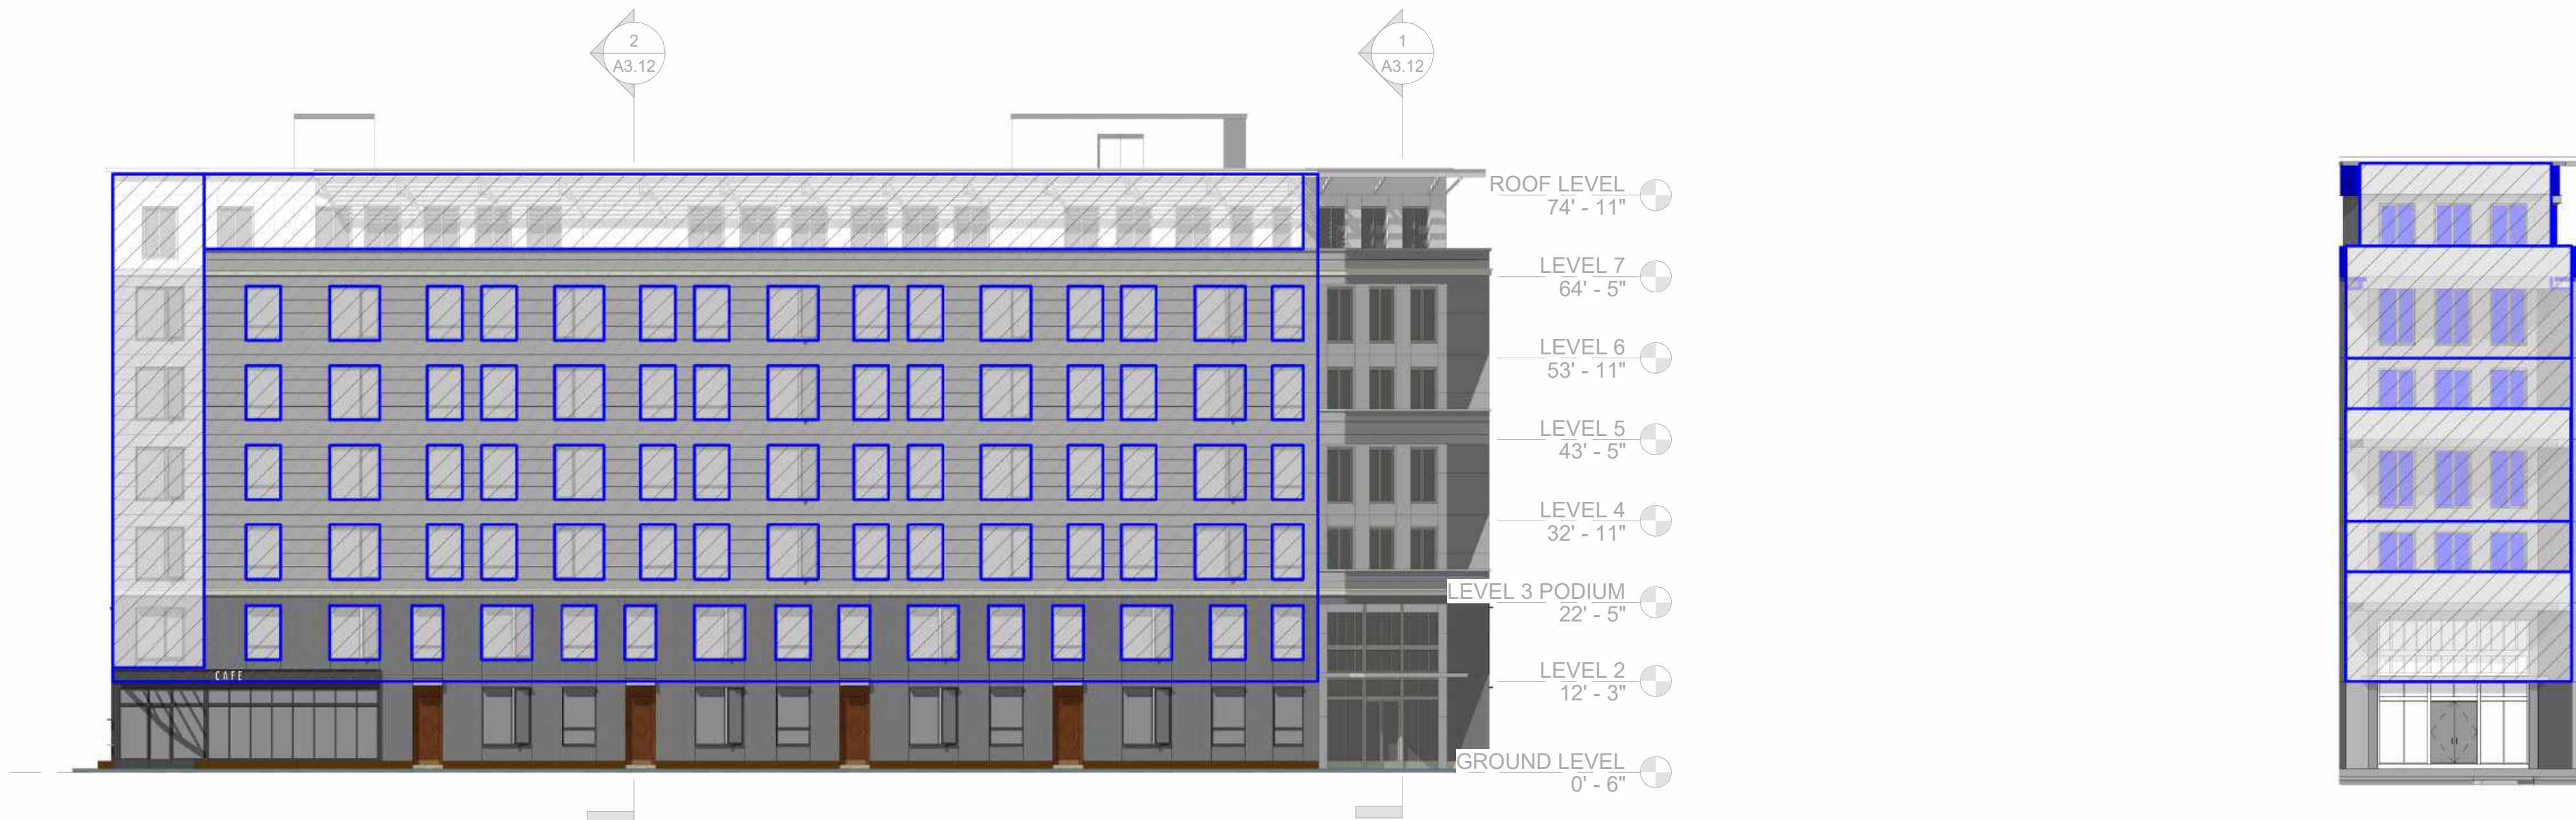

① EXTERIOR ELEVATION - EAST - OPENING %
1/16" = 1'-0"

② EXTERIOR ELEVATION - CHAMFER - OPENING %
1/16" = 1'-0"

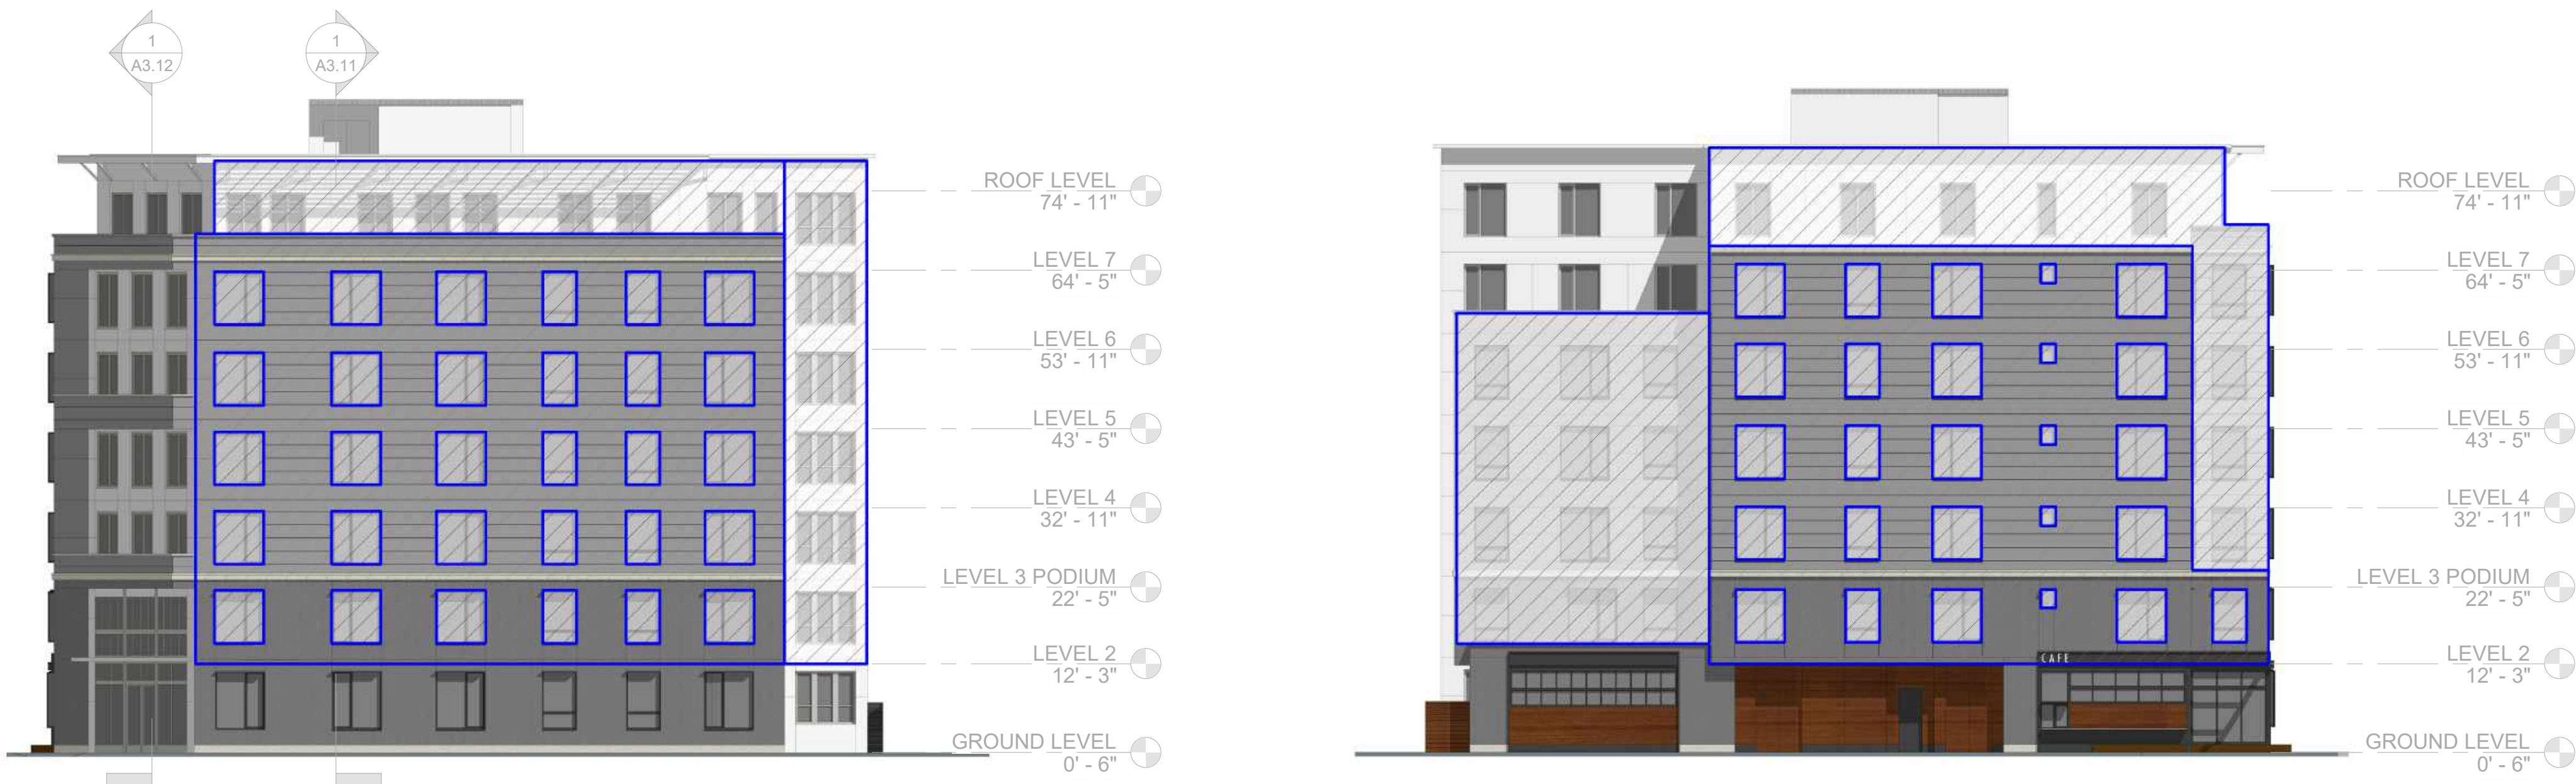

③ EXTERIOR ELEVATION - NORTH - OPENING %
1/16" = 1'-0"

④ EXTERIOR ELEVATION - SOUTH - OPENING %
1/16" = 1'-0"

	Wall Area (sq ft)	50% Req'd (sq ft)	A.D. Area (sq ft)
South Wall (Transit Mall)	6453		3698.33
East Wall (Santa Rosa Ave)	10169.9		4806.34
North Wall (3rd Street)	5909		2687.8
Chamfer	1867.1		1890.17
Total	24399	12199.5	13082.64

Chamfer	sq ft
Total Wall Area	1867.1
Window Area	0
Balcony Area	639
Offset Planes	1251.17
Total Arch Differ	1890.17

North Wall (3rd Street)	sq ft
Total Wall Area	5909
Window Area	1225
Balcony Area	729.8
Offset Planes	733
Total Arch Differ	2687.8

East Wall (Santa Rosa Ave)	sq ft
Total Wall Area	10169.9
Window Area	2681
Balcony Area	1369.04
Offset Planes	756.3
Total Arch Differ	4806.34

South Wall (Transit Mall)	sq ft
Total Wall Area	6453
Window Area	896.5
Offset Planes	2801.83
Total Arch Differ	3698.33

DESIGN REVIEW IMPROVEMENT DRAWINGS FOR
1 SANTA ROSA AVENUE
SANTA ROSA, CALIFORNIA

APN 010-063-025
JULY 2020

OWNER: 1 SRA LLC
PO BOX 8001
NAPA, CA 94559
PH: (415) 519-7574

ARCHITECT: LOWNEY ARCH
360 SEVENTEENTH STREET, SUITE 200
OAKLAND, CA 94612
PH: (510) 836-5400

CIVIL ENGINEER: BKF ENGINEERS
200 4TH ST, STE. 300
SANTA ROSA, CA 95401
PH: (707) 583-8500
FAX: (707) 583-8539

GENERAL NOTES

THE DESIGN PROFESSIONAL WHO PREPARED THESE DRAWINGS IS NOT RESPONSIBLE FOR THE MISUSE OF, OR UNAUTHORIZED CHANGES MADE TO THESE DRAWINGS. THE CONTRACTOR SHALL OBTAIN WRITTEN PERMISSION FROM THE DESIGN PROFESSIONAL WHO PREPARED THESE DRAWINGS PRIOR TO MAKING CHANGES.

FURNISH AND INSTALL MATERIALS IN ACCORDANCE WITH THE CITY OF SANTA ROSA "DESIGN AND CONSTRUCTION STANDARDS".

OBTAIN RELEVANT PERMITS AND APPROVALS REQUIRED BY GOVERNING AGENCIES PRIOR TO COMMENCING WORK.

ASSUME SOLE AND COMPLETE RESPONSIBILITY FOR JOB SITE CONDITIONS DURING THE COURSE OF CONSTRUCTION FOR THE PROJECT, INCLUDING SAFETY OF ALL PERSONS AND PROPERTY. THIS REQUIREMENT APPLIES CONTINUOUSLY, AND IS NOT LIMITED TO NORMAL WORKING HOURS.

HOLD HARMLESS, INDEMNIFY AND DEFEND THE OWNER, THE DESIGN PROFESSIONAL FROM LIABILITY, REAL OR ALLEGED IN CONNECTION WITH THE PERFORMANCE OF WORK ON THIS PROJECT, EXCEPTING LIABILITY ARISING FROM THE WILLFUL MISCONDUCT OR SOLE NEGLIGENCE OF THE DESIGN PROFESSIONAL.

IF REQUIRED, SUBMIT A TRAFFIC CONTROL PLAN TO THE DEPARTMENT OF PUBLIC WORKS AND OBTAIN APPROVAL PRIOR TO COMMENCING WORK IN THE PUBLIC RIGHT OF WAY.

PROVIDE A PROPERLY SIGNED ALTERNATE ACCESSIBLE ROUTE OF TRAVEL IF CONSTRUCTION ACTIVITIES IMPACT PEDESTRIAN ACCESS. THIS REQUIREMENT APPLIES CONTINUOUSLY, AND IS NOT LIMITED TO NORMAL WORKING HOURS.

PROPERLY MUFFLE EQUIPMENT AND LIMIT CONSTRUCTION HOURS TO 7:00 AM TO 7:00 PM MONDAY THRU FRIDAY, AND 8:00AM TO 6:00PM ON SATURDAYS. NO CONSTRUCTION IS PERMITTED ON SUNDAYS AND HOLIDAYS. THIS RESTRICTION INCLUDES THE STARTUP OF MOTOR VEHICLES AND OTHER HEAVY EQUIPMENT.

REPAIR DAMAGE TO FACILITIES OCCURRING AS A RESULT OF CONSTRUCTION ACTIVITIES TO RETURN THEM TO THEIR CONDITION PRIOR TO CONSTRUCTION.

MAINTAIN A CLEAN CONSTRUCTION SITE TO PREVENT THE INTRODUCTION OF FOREIGN MATERIALS INTO THE STORM WATER CONVEYANCE SYSTEM. REMOVE MATERIAL WHICH WILL NOT BE USED ON SITE AS IT IS EXCAVATED AND DISPOSE IN ACCORDANCE WITH THE GOVERNING AGENCY'S REQUIREMENTS.

PROVIDE DUST CONTROL THROUGHOUT THE DURATION OF THE CONSTRUCTION PROJECT TO MINIMIZE AIRBORNE POLLUTANTS.

RETAIN THE SERVICES OF AN AUTHORIZED DESIGN PROFESSIONAL TO PREPARE A SEDIMENT CONTROL PLAN IF WORK WILL BE CONDUCTED BETWEEN OCTOBER 1 AND MAY 1 OF THE SUBSEQUENT YEAR.

GRADING NOTES

REMOVE MATERIAL WHICH WILL NOT BE USED ON SITE AS IT IS EXCAVATED AND DISPOSE IN ACCORDANCE WITH THE GOVERNING AGENCY'S REQUIREMENTS.

MAINTAIN A CLEAN CONSTRUCTION SITE TO PREVENT THE INTRODUCTION OF FOREIGN MATERIALS INTO THE STORM WATER CONVEYANCE SYSTEM. ACTIVITY DURING CONSTRUCTION WHICH RESULTS IN THE DISCHARGE OF POLLUTANTS TO THE STORM WATER CONVEYANCE SYSTEM IS IN VIOLATION OF THE CITY OF SANTA ROSA STORM WATER ORDINANCE AND STATE WATER RESOURCES CONTROL BOARD'S REGULATIONS.

STOP WORK IF CONTAMINATED MATERIAL IS ENCOUNTERED. PREPARE A WORK PLAN AND ACQUIRE APPROVAL IN WRITING FROM THE CITY OF SANTA ROSA FIRE DEPARTMENT AND THE STATE REGIONAL WATER QUALITY CONTROL BOARD PRIOR TO RESUMING WORK.

THE CONTRACTOR SHALL NOT IMPEDE DRAINAGE FROM EXISTING UPSTREAM PROPERTIES. THE CONTRACTOR SHALL PLACE STOCKPILES AWAY FROM CREEK SETBACKS, AWAY FROM VEGETATION DESIGNATED TO REMAIN, A MINIMUM OF 10-FEET FROM ADJACENT EXISTING RESIDENTIAL PARCELS, AND A MINIMUM OF 50-FEET FROM ADJACENT EXISTING RESIDENTIAL PARCELS WHERE THE STOCKPILE DEPTH EXCEEDS 2.5-FEET.

UTILITY NOTES

THE LOCATIONS OF EXISTING UNDERGROUND FACILITIES SHOWN ON THIS DRAWING ARE APPROXIMATE AND ARE BASED ON OBSERVED TOPOGRAPHIC SURFACE FEATURES AND AVAILABLE INFORMATION. UTILITY SIZES WERE TAKEN FROM PUBLIC SOURCES SUCH AS EXISTING IMPROVEMENT DRAWINGS. THE PROFESSIONAL PREPARING THIS MAP ASSUMES NO RESPONSIBILITY FOR THE ACCURACY OF THESE FACILITIES OR FOR THE INADVERTENT OMISSION OF RELATED INFORMATION.

THE CONTRACTOR SHALL BE RESPONSIBLE FOR NOTIFYING UNDERGROUND SERVICE ALERT (U.S.A.). CALL TOLL-FREE (800) 642-2444 AT LEAST TWO WORKING DAYS PRIOR TO EXCAVATION.

EXPOSE EXISTING UTILITIES PRIOR TO TRENCHING TO VERIFY THE ALIGNMENTS AND ELEVATIONS OF THE UTILITIES, AND TO VERIFY DESIGN ASSUMPTIONS. EXISTING UTILITIES MAY REQUIRE RELOCATION AND/OR PROPOSED IMPROVEMENTS MAY REQUIRE GRADE OR ALIGNMENT REVISION DUE TO FIELD CONDITIONS. IF THE EXPOSED UTILITY IS DETERMINED TO BE IN A LOCATION WHICH IS NOT REFLECTED BY THIS DRAWING, NOTIFY THE ENGINEER IN WRITING SO THAT APPROPRIATE ADJUSTMENTS CAN BE MADE.

CROSSING UTILITIES WHICH HAVE BEEN IDENTIFIED IN THE CONSTRUCTION DOCUMENTS MAY NOT BE CONSTRUED AS UTILITY CONFLICTS. THE CONTRACTOR SHALL INSTALL GRAVITY UTILITIES TO THE LINES AND ELEVATIONS IDENTIFIED IN THE CONSTRUCTION DOCUMENTS AND INSTALL OTHER UTILITIES ABOVE OR BELOW GRAVITY UTILITIES WHILE COMPLYING WITH THE MINIMUM COVER REQUIREMENTS FOR EACH UTILITY INSTALLED.

UNLESS OTHERWISE NOTED, PROVIDE SCH40 PVC 1120 COMPLYING WITH NSF 14 FOR PLASTIC POTABLE WATER SERVICE PIPING WHERE DOWNSTREAM OF THE BACKFLOW PREVENTION DEVICE AND ANNOTATED AS WATER (W) ON THIS DRAWING. THE PIPING SHALL INCLUDE THE MARKING "NSF-PW".

UNLESS OTHERWISE NOTED, PROVIDE SCH40 POLYVINYL CHLORIDE PIPE WHERE ANNOTATED AS SEWER (SS) ON THIS DRAWING.

PROVIDE TRENCHING IN ACCORDANCE WITH CITY OF SANTA ROSA STANDARD 215 AND SECTION 19 OF THE CITY OF SANTA ROSA CONSTRUCTION SPECIFICATIONS.

THE CONTRACTOR IS CAUTIONED NOT TO ORDER MATERIAL OR INSTALL IMPROVEMENTS UNTIL CONFLICTS ARE RESOLVED. IMPROVEMENTS INSTALLED OR ORDERED PRIOR TO CONFLICT RESOLUTION SHALL BE DONE SOLELY AT THE CONTRACTOR'S RISK AND AT NO EXPENSE TO THE OWNER, THE DESIGN PROFESSIONAL, OR THE CITY OF SANTA ROSA.

UPON COMPLETION OF THE CURB AND GUTTER, THE CONTRACTOR SHALL LEGIBLY INSCRIBE 4-INCH TALL LETTERS, "S" TO DESIGNATE SEWER AND "W" TO DESIGNATE WATER, INTO THE CURB FACE AT EACH LOCATION WHERE THE UTILITY CROSSES BENEATH THE CURB.

THE USE OF CONTROLLED DENSITY BACKFILL (CDF) WITHIN ANY PUBLIC SEWER OR WATER TRENCH IS NOT ALLOWED UNLESS SPECIFICALLY APPROVED BY THE DIRECTOR OF WATER.

CONTRACTOR SHALL NOTIFY INSPECTOR A MINIMUM OF 48-HOURS IN ADVANCE TO ALLOW FOR VISUAL ONSITE INSPECTION OF WATER PIPE JOINTS, VALVES, CONNECTIONS, SERVICE SADDLES, HARNESSSES, ANCHORS AND THRUST BLOCKS, PRIOR TO BACKFILLING.

CONTRACTOR SHALL NOTIFY INSPECTOR A MINIMUM OF 48-HOURS IN ADVANCE TO ALLOW FOR VISUAL INSPECTION OF CUT/TIE INS TO THE SEWER SYSTEM AND ALL ABANDONMENTS.

ONLY AUTHORIZED CITY PERSONNEL SHALL OPERATE VALVES ON THE EXISTING WATER SYSTEM.


RESTRAINED MECHANICAL JOINTS SHALL BE USED ON ALL TEES, FITTINGS, AND ASSOCIATED GATE VALVES UNLESS OTHER APPROVED OR DIRECTED BY THE INSPECTOR.

SUBMITTALS FOR ALL ITEMS USED FOR WATER AND SEWER CONSTRUCTION IN THE CITY RIGHT OF WAY ARE REQUIRED FOR REVIEW AND APPROVAL PRIOR TO THE START OF WORK.

ALL VERTICAL AND HORIZONTAL SEPARATION REQUIREMENTS BETWEEN UTILITIES SHALL CONFORM TO THE MOST RECENT STATE WATER RESOURCES CONTROL BOARD REQUIREMENTS. THESE STATE REQUIREMENTS SUPERSEDE THE CITY STANDARDS.

THE CONTRACTOR SHALL CONTACT THE CITY OF SANTA ROSA WATER DEPARTMENT FOR FINAL INSPECTION OF ALL SEWER MAINS AND LATERALS, ALL SEWER MAINS AND LATERALS MUST BE CLEANED AND MANHOLED PRIOR TO CITY ACCEPTANCE.

IF DAMAGE OCCURS TO ANY WATER SERVICE DURING CONSTRUCTION, THE CONTRACTOR SHALL REPLACE THE SERVICE FROM THE CORPORATION STOP AT THE MAIN TO THE WATER METER WITHOUT SPLICING.

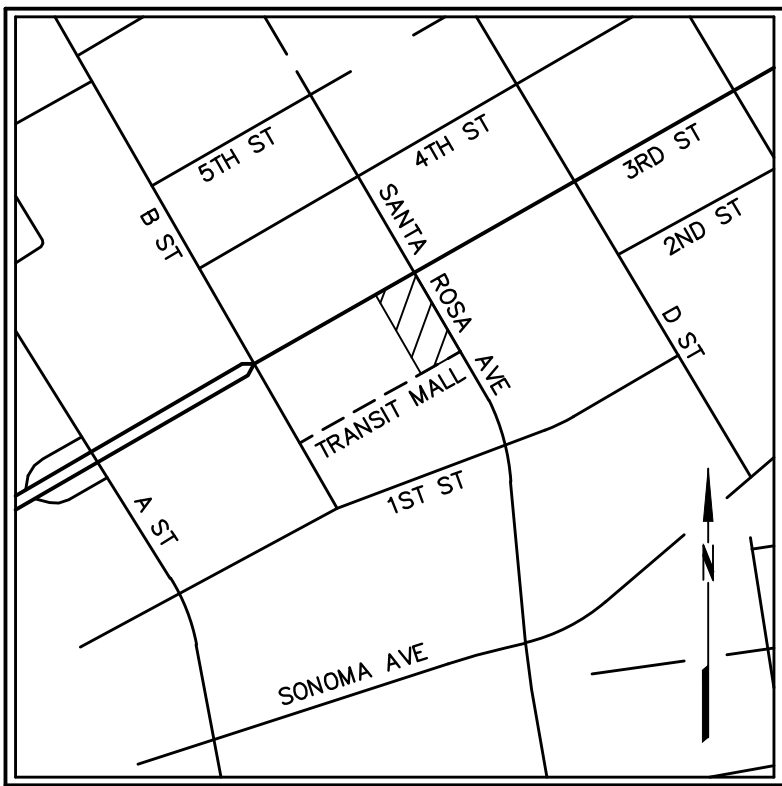

INDEX OF DRAWINGS

1. PROJECT INFORMATION
2. GRADING & UTILITY PLAN

TOPOGRAPHIC NOTES

UNAUTHORIZED CHANGES & USES: THE PROFESSIONAL PREPARING THIS MAP WILL NOT BE RESPONSIBLE FOR, OR LIABLE FOR, UNAUTHORIZED CHANGES TO OR USES OF THIS MAP. CHANGES TO THIS MAP MUST BE REQUESTED IN WRITING AND MUST BE APPROVED BY THE PROFESSIONAL.

THE LOCATIONS OF EXISTING UNDERGROUND FACILITIES SHOWN ON THESE DRAWINGS ARE APPROXIMATE AND ARE BASED ON OBSERVED TOPOGRAPHIC SURFACE FEATURES AND AVAILABLE INFORMATION. THE PROFESSIONAL PREPARING THIS MAP ASSUMES NO RESPONSIBILITY FOR THE ACCURACY OF THESE FACILITIES OR FOR THE INADVERTENT OMISSION OF RELATED INFORMATION.

TREE DIAMETERS ARE MEASURED AT CHEST HEIGHT (48"). DRIPLINE DIAMETERS AND TREE SPECIES ARE APPROXIMATE ONLY AND SHOULD BE VERIFIED BY A CERTIFIED TREE ARBORIST.

MISCELLANEOUS BOUNDARY INFORMATION SHOWN HEREON WAS OBTAINED FROM THE RECORD OF SURVEY FILED IN BOOK 352, PAGE 22 OF SONOMA COUNTY RECORDS.

BASIS OF BEARINGS: RECORD OF SURVEY FILED IN BOOK 352, PAGE 22 OF SONOMA COUNTY RECORDS.

THE BEARINGS AND DISTANCES DO NOT REFLECT A FIELD SURVEY AND DO NOT CONSTITUTE A FORMAL BOUNDARY DETERMINATION.

BENCHMARK: POINT NO. 6. CITY OF SANTA ROSA BENCHMARK G332 BETTER DESCRIBED AS A 2-INCH BRASS DISK MARKED "CITY OF SANTA ROSA" IN A WELL MONUMENT AT THE WEST END OF A PLANTER AT THE BACK OF WALL, NORTHWEST CORNER OF THE INTERSECTION OF 3RD ST AND SANTA ROSA AVE. ELEV: 163.93 (NAVD88)


FIELD SURVEY DATE: 10/28/15

SYMBOLS & LEGEND

EXISTING	PROPOSED	
		CENTERLINE MONUMENT
		FIRE HYDRANT
		DOUBLE CHECK DETECTOR FIRE LINE BACKFLOW ASSEMBLY
		STREET SIGN
		STREET LIGHT
		TREE
		PROPERTY LINE
		EASEMENT
		CENTERLINE
		GRADE BREAK
		RETAINING WALL
		FENCE
		SANITARY SEWER
		STORM DRAIN
		WATER
		UNDERGROUND ELECTRIC LINE
		UNDERGROUND TELECOM LINE
		CONCRETE
		GRAVEL
		KEYNOTE
		DETAIL IDENTIFICATION
		SHEET WHERE DETAIL IS SHOWN


ABBREVIATIONS

±	MORE OR LESS	SD	STORM DRAIN
APN	ASSESSOR'S PARCEL NUMBER	SDMH	STORM DRAIN MANHOLE
BLRD	BOLLARD	SS	SANITARY SEWER
BLDG	BUILDING	SSCO	SANITARY SEWER CLEAN OUT
COMM	COMMUNICATIONS	SSMH	SANITARY SEWER MANHOLE
CONC	CONCRETE	STLT	STREET LIGHT
DW	DRIVEWAY	TC	TOP FACE OF CURB
E	ELECTRIC	TG	TOP OF GRATE
FF	FINISHED FLOOR	TS	TRAFFIC SIGNAL
FG	FINISHED GRADE	TW	TOP OF WALL
GI	GRATE INLET	TYP	TYPICAL
MH	MANHOLE	UB	UTILITY BOX
MAX	MAXIMUM	UTIL	UTILITY
MIN	MINIMUM	W	WATER
PG&E	PACIFIC GAS & ELECTRIC	WM	WATER METER

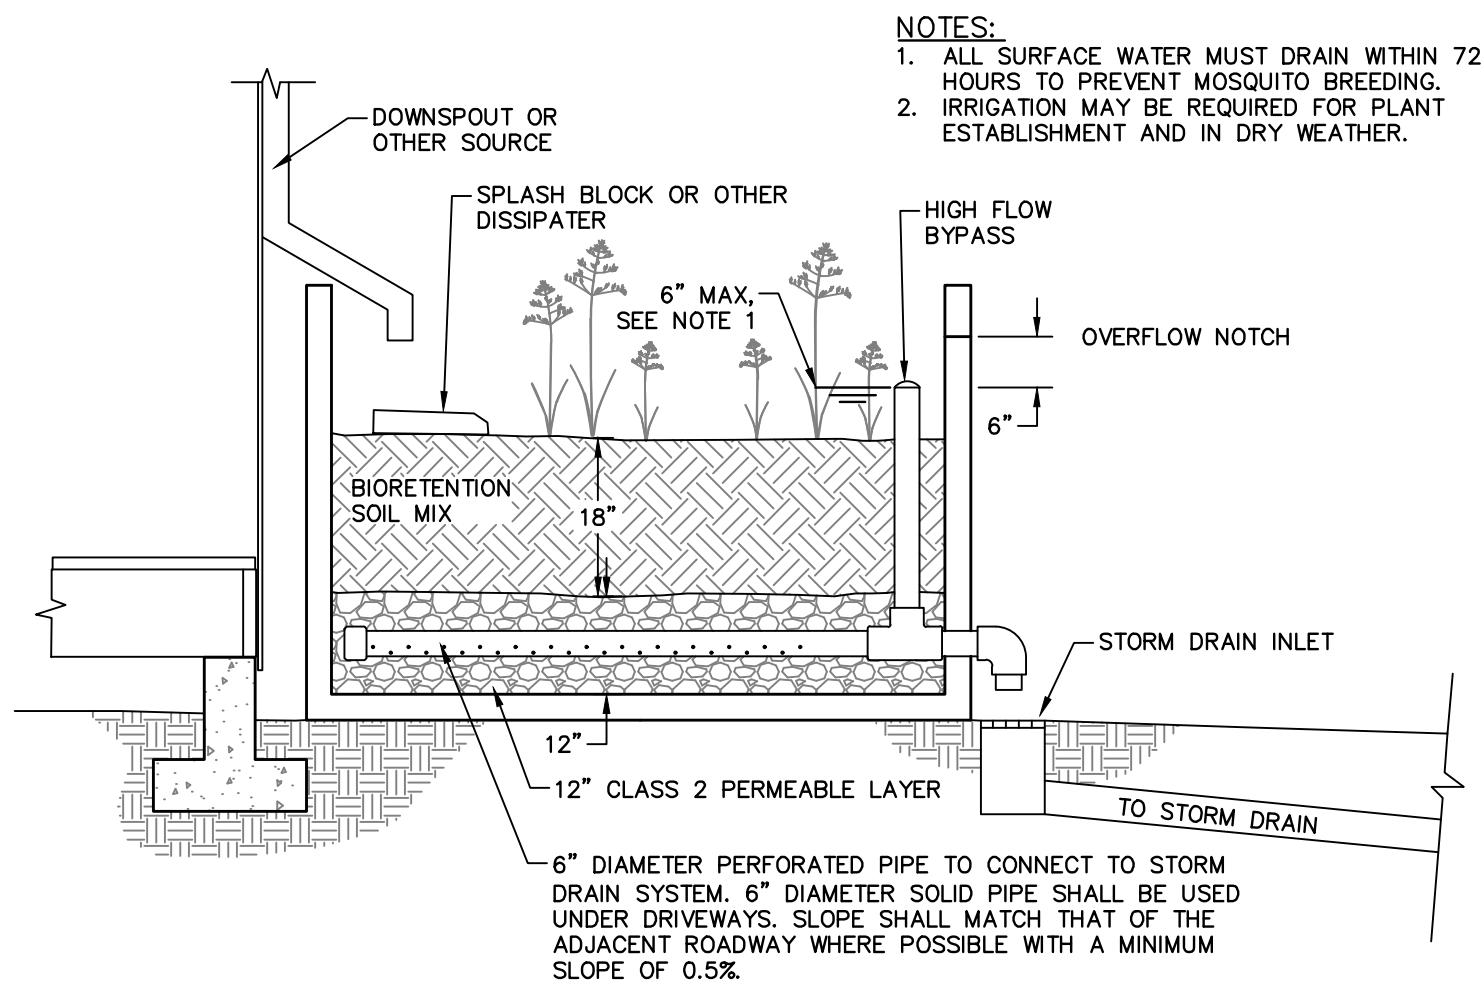

1 FLOW THROUGH PLANTER BIORETENTION

NO SCALE

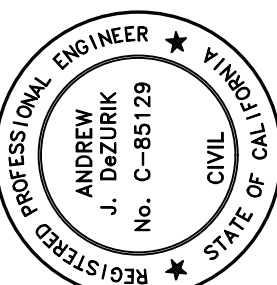

PRELIMINARY

NOT FOR CONSTRUCTION

DATE: 07/28/2020
ANDREW J. DEZURIK C-85129




1 SANTA ROSA AVENUE
APN 010-063-025
CITY OF SANTA ROSA, COUNTY OF SONOMA, STATE OF CALIFORNIA


PROJECT INFORMATION

Revisions	No.	Date	Scale	As Shown	Design	Drawn	Approved	Job No.
		July 28, 2020	AS SHOWN	AS SHOWN	AS SHOWN	AS SHOWN	AS SHOWN	20159140

Drawing Number:

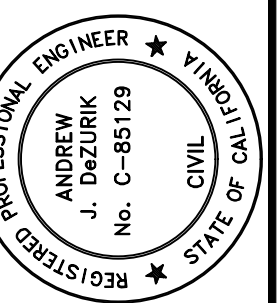

PRELIMINARY
NOT FOR CONSTRUCTION
DATE: 07/28/2020
ANDREW J. DEZURIK C-85129

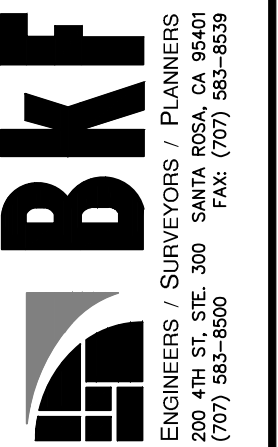










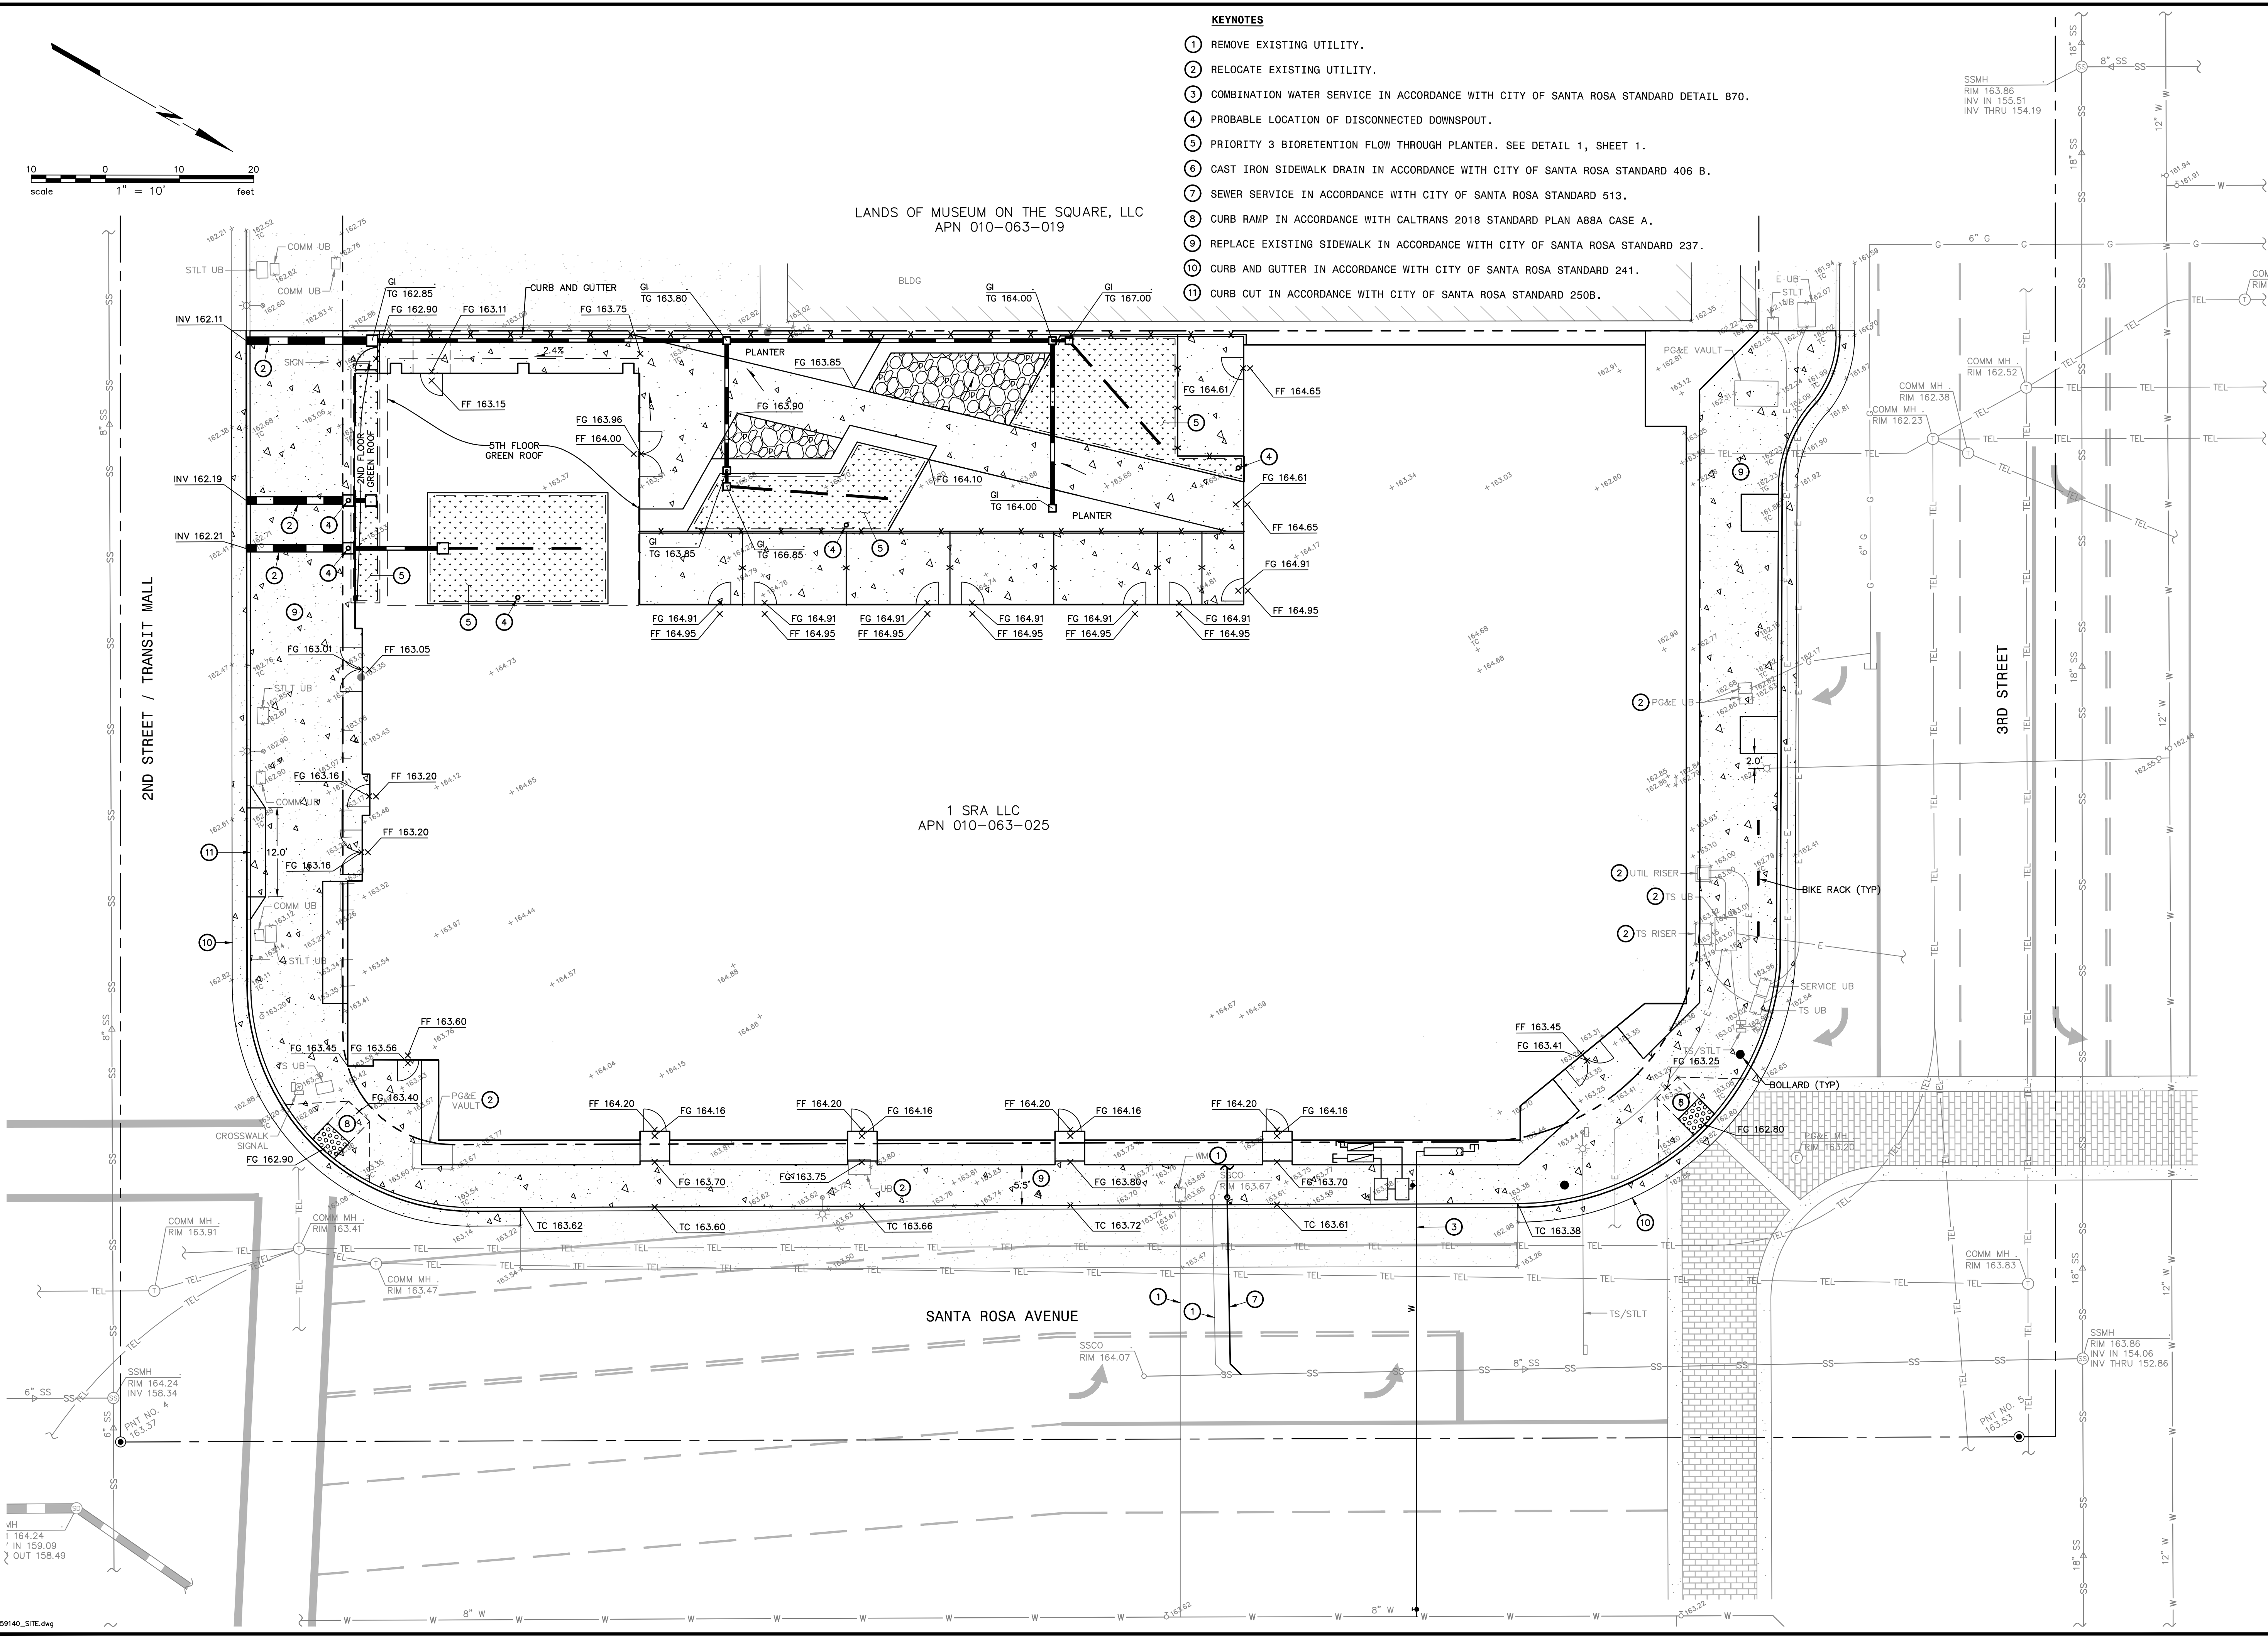


1 SANTA ROSA AVENUE
APN 010-063-025
CITY OF SANTA ROSA, COUNTY OF SONOMA, STATE OF CALIFORNIA
GRADING & UTILITY PLAN

Revisions	
No.	
Date: JULY 2020	Scale: AS SHOWN
Drawn: EP	Approved: AD
Job No: 20159140	

KEYNOTES

- 1 REMOVE EXISTING UTILITY.
- 2 RELOCATE EXISTING UTILITY.
- 3 COMBINATION WATER SERVICE IN ACCORDANCE WITH CITY OF SANTA ROSA STANDARD DETAIL 870.
- 4 PROBABLE LOCATION OF DISCONNECTED DOWNSPOUT.
- 5 PRIORITY 3 BIORETENTION FLOW THROUGH PLANTER. SEE DETAIL 1, SHEET 1.
- 6 CAST IRON SIDEWALK DRAIN IN ACCORDANCE WITH CITY OF SANTA ROSA STANDARD 406 B.
- 7 SEWER SERVICE IN ACCORDANCE WITH CITY OF SANTA ROSA STANDARD 513.
- 8 CURB RAMP IN ACCORDANCE WITH CALTRANS 2018 STANDARD PLAN A88A CASE A.
- 9 REPLACE EXISTING SIDEWALK IN ACCORDANCE WITH CITY OF SANTA ROSA STANDARD 237.
- 10 CURB AND GUTTER IN ACCORDANCE WITH CITY OF SANTA ROSA STANDARD 241.
- 11 CURB CUT IN ACCORDANCE WITH CITY OF SANTA ROSA STANDARD 250B.



Planting Schedule - Ground Level								
Symbol	Image	Scientific Name	Common Name	Count	WUCOLS	Gallons	Size	Notes
ANI HAR		Anigazanthos 'Harmony'	Harmony Kangaroo Paw	21	Low	1 Gal	4' H X 2' W	
ARC GLA		Arctostaphylos glauca	Bigberry manzanita	2	Very Low	24" Box	15' H x 15' W	
ART IUD		Artemisa ludoviciana	White Sagebrush	64	Low	1 Gal	2'H X 2'W	aromatic
COT COG		Cotinus coggygria 'Golden Spirit'	Golden Spirit Smoke Tree	5	Low	15 Gal	15'H X 10'W	
EUP CHA		Euphorbia characias 'Wulfenii'	Spurge	55	Low	5 Gal	4'H X 4'W	
LOM LON		Lomandra longifolia 'Breeze'	Dwarf Mat Rush	72	Low	1 Gal	2'H X 2'W	
MAL SNO		Malus 'snowdrift'	Snowdrift Crab Apple	8	Moderate	15 Gal	15'H X 3'W	pruned to shape
MOR CAL		Morella californica	Pacific Wax Myrtle	1	Moderate	24" Box	25'H x 25' W	
POL CAL		Polypodium californicum	California polypody fern	50	Low	1 Gal	2'H X 2'W	
PYR CAL		Pyrus calleryana	Ornamental Pear	2	Moderate	24" Box	50' H X 50'W	
RIB SPE		Ribes speciosum	Fuschia-flowered Gooseberry	16	Low	5 Gal	5'H X 5'W	
TEU FRU		Teucrium fruticans	Bush Germander	12	Low	5 Gal	4'H X 4'W	clipped to shape









Tree to Be Removed

Irrigation Design Intent
Irrigation System is designed to provide the minimum amount of water necessary to sustain good plant health. All selected components are commercial grade, selected for durability, vandal resistance and minimum maintenance requirement. The system is a combination of subsurface irrigation and tree bubblers as appropriate to plant type, exposure, and slope conditions.

Control of the system is via a weather-enabled controller capable of daily self-adjustment based on real-time weather conditions as measured by an on-site weather sensor.

The system includes a master control valve and flow sensing capability which will shut down all or part of the system if leaks are detected.

Planting Schedule - Roof Level								
Symbol	Image	Scientific Name	Common Name	Count	WUCOLS	Gallons	Size	Notes
CIT LIM		Citrus Lime 'Bearss'	Persian Lime	2	Low	15 Gal	10'H X 6'W	
EUP CHA		Euphorbia characias 'Wulfenii'	Spurge	14	Low	5 Gal	4'H X 4'W	
LAV ANG		Lavandula angustifolia 'Hidcote Blue'	Hidcote Blue Lavender	110	Low	1 Gal	2'H X 2'W	
OLE EUR		Olea europaea 'Swan Hill'	Olive	3	Low	24" Box	25'H X 30'W	
ROS OFF		Rosmarinus officinalis 'Barbecue'	Rosmarinus officinalis	11	Low	1 Gal	4'H x 3'W	
TEU FRU		Teucrium fruticans	Bush Germander	5	Low	5 Gal	4'H X 4'W	clipped to shape

Mixed Annuals and Herbs: Mint
 Pansy
 Violet
 Melon

ONE SANTA
ROSA AVE

Owner

Enter Project Address in Manage -> Project Information

OWNER

1 SRA LLC
PO Box 8001
Napa, CA 94559
Phone: 415.519.7574

ARCHITECT

LOWNEY ARCHITECTURE
360 17th Street, Suite 200
Oakland, CA 94612
Phone: 510.269.1124

STRUCTURAL

INNOVATIVE STRUCTURAL
ENGINEERING, INC.
40810 County Center Dr Suite
110 Temecula, CA 92591
Phone: 951.226.4355

CIVIL ENGINEERING

BFK ENGINEERS
200 4th Street, Suite 300,
Santa Rosa, CA 95401
Phone: 707.583.8528

MEP

FARD ENGINEERS, INC.
309 Lennon Lane, Suite 200
Walnut Creek, CA 94598
Phone: 925.932.5505


LANDSCAPE ARCHITECT

LOWNEY ARCHITECTURE
360 17th Street, Suite 200
Oakland, CA 94612
Phone: 510.836.5400

STAMP



#	DATE	ISSUES & REVISIONS	BY
	09/11/2020	SCHEMATIC DESIGN	JB

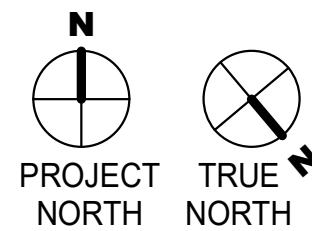

DRAWN BY: Author
PROJECT NUMBER: 00-000
SHEET ISSUE DATE: 07/15/20
SHEET TITLE:

PLANT LIST

SHEET NUMBER

L00

ALL DRAWINGS AND WRITTEN MATERIAL APPEARING HEREIN
CONSTITUTE ORIGINAL AND UNPUBLISHED WORK OF THE
ARCHITECT AND MAY NOT BE DUPLICATED, USED OR DISCLOSED
WITHOUT WRITTEN CONSENT OF THE ARCHITECT

**ONE SANTA
ROSA AVE**

Owner

Enter Project Address in Manage -> Project Information

OWNER

1 SRA LLC
PO Box 8001
Napa, CA 94559
Phone: 415.519.7574

ARCHITECT

LOWNEY ARCHITECTURE
360 17th Street, Suite 200
Oakland, CA 94612
Phone: 510.269.1124

STRUCTURAL

INNOVATIVE STRUCTURAL
ENGINEERING, INC.
40810 County Center Dr Suite
110 Temecula, CA 92591
Phone: 951.226.4355

CIVIL ENGINEERING

BFK ENGINEERS
200 4th Street, Suite 300,
Santa Rosa, CA 95401
Phone: 707.583.8528


MEP

FARD ENGINEERS, INC.
309 Lennon Lane, Suite 200
Walnut Creek, CA 94598
Phone: 925.932.5505

LANDSCAPE ARCHITECT

LOWNEY ARCHITECTURE
360 17th Street, Suite 200
Oakland, CA 94612
Phone: 510.836.5400

STAMP

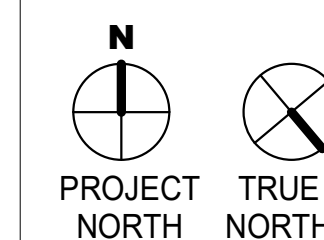[illegible]


DRAWN BY:	Author
PROJECT NUMBER:	00-000
SHEET ISSUE DATE:	07/15/20
SHEET TITLE:	

GROUND LEVEL PLAN

SHEET NUMBER

L01

ALL DRAWINGS AND WRITTEN MATERIAL APPEARING HEREIN
CONSTITUTE ORIGINAL AND UNPUBLISHED WORK OF THE
ARCHITECT AND MAY NOT BE DUPLICATED, USED OR DISCLOSED
WITHOUT WRITTEN CONSENT OF THE ARCHITECT

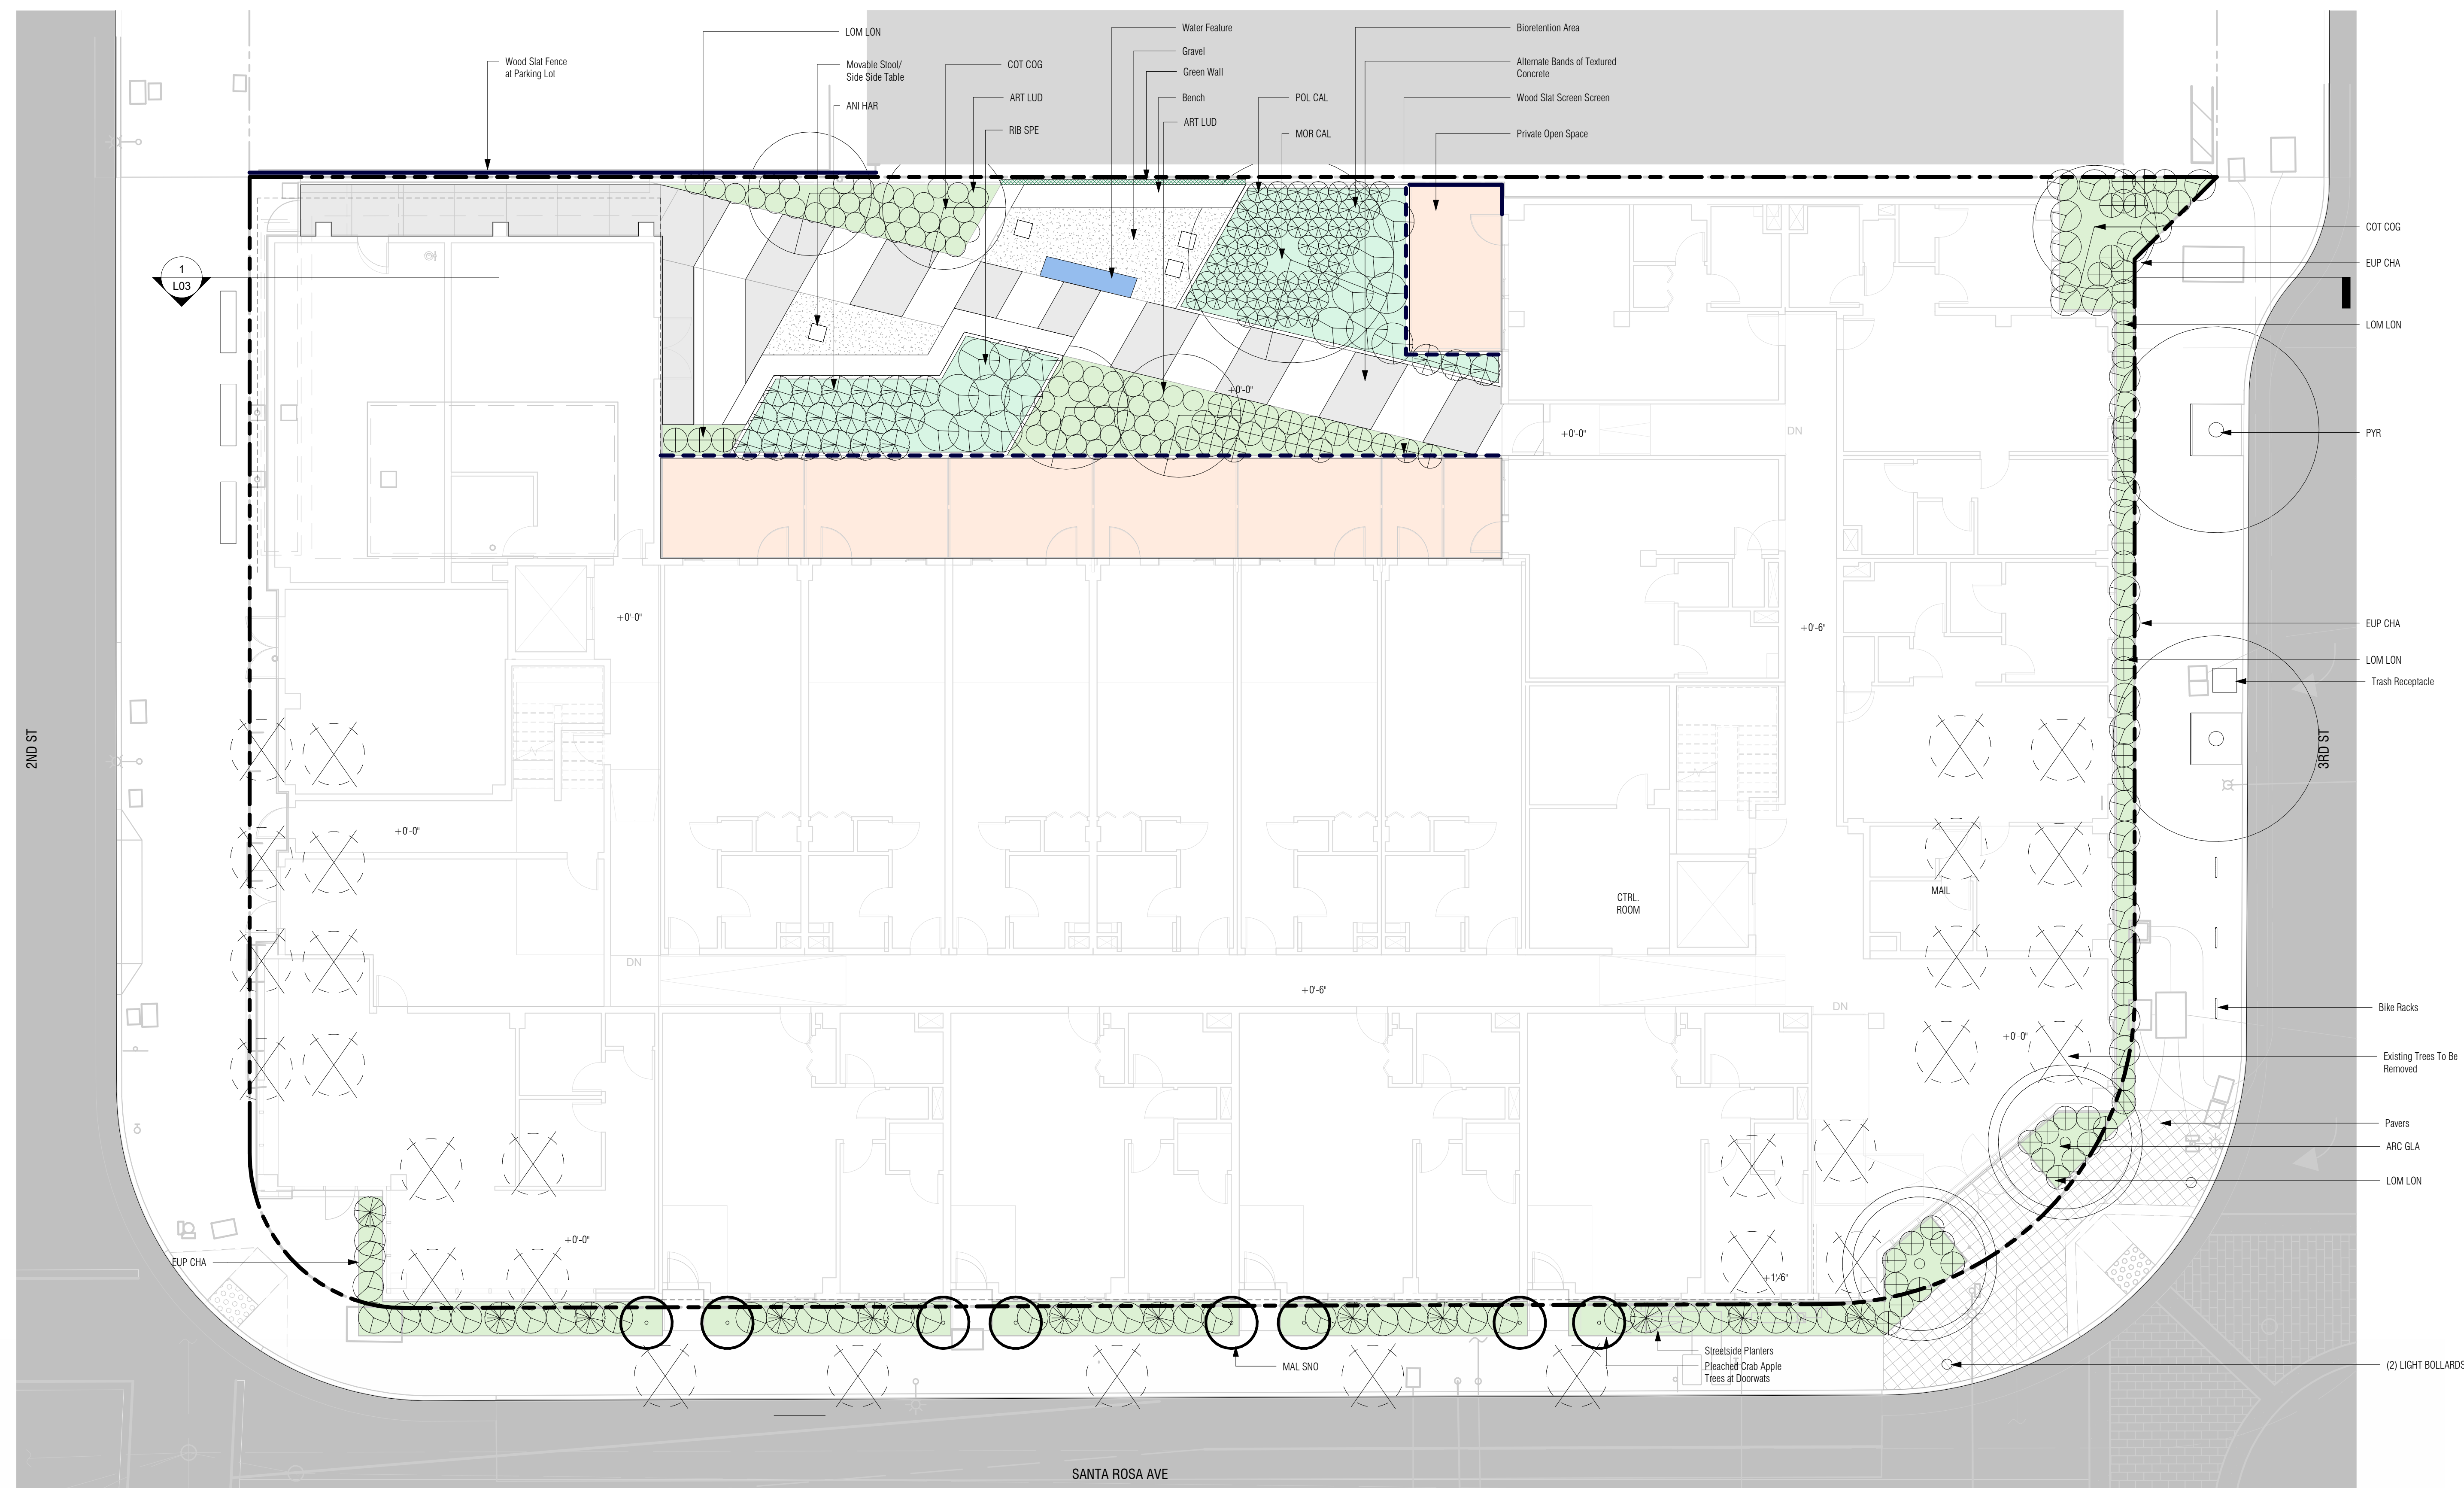

Linear Benches



Alternate Bands of Permeable Concrete and Impervious Concrete



Pavers



Water Fountain



Green Wall




Moveable Stool




Wood Slat Fence



Streetside Planters:
Euphorbia and Clipped Trees and Shrubs

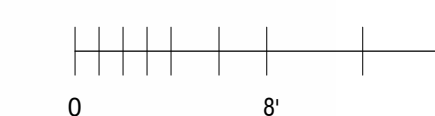

9/11/2020 4:09:12 PM

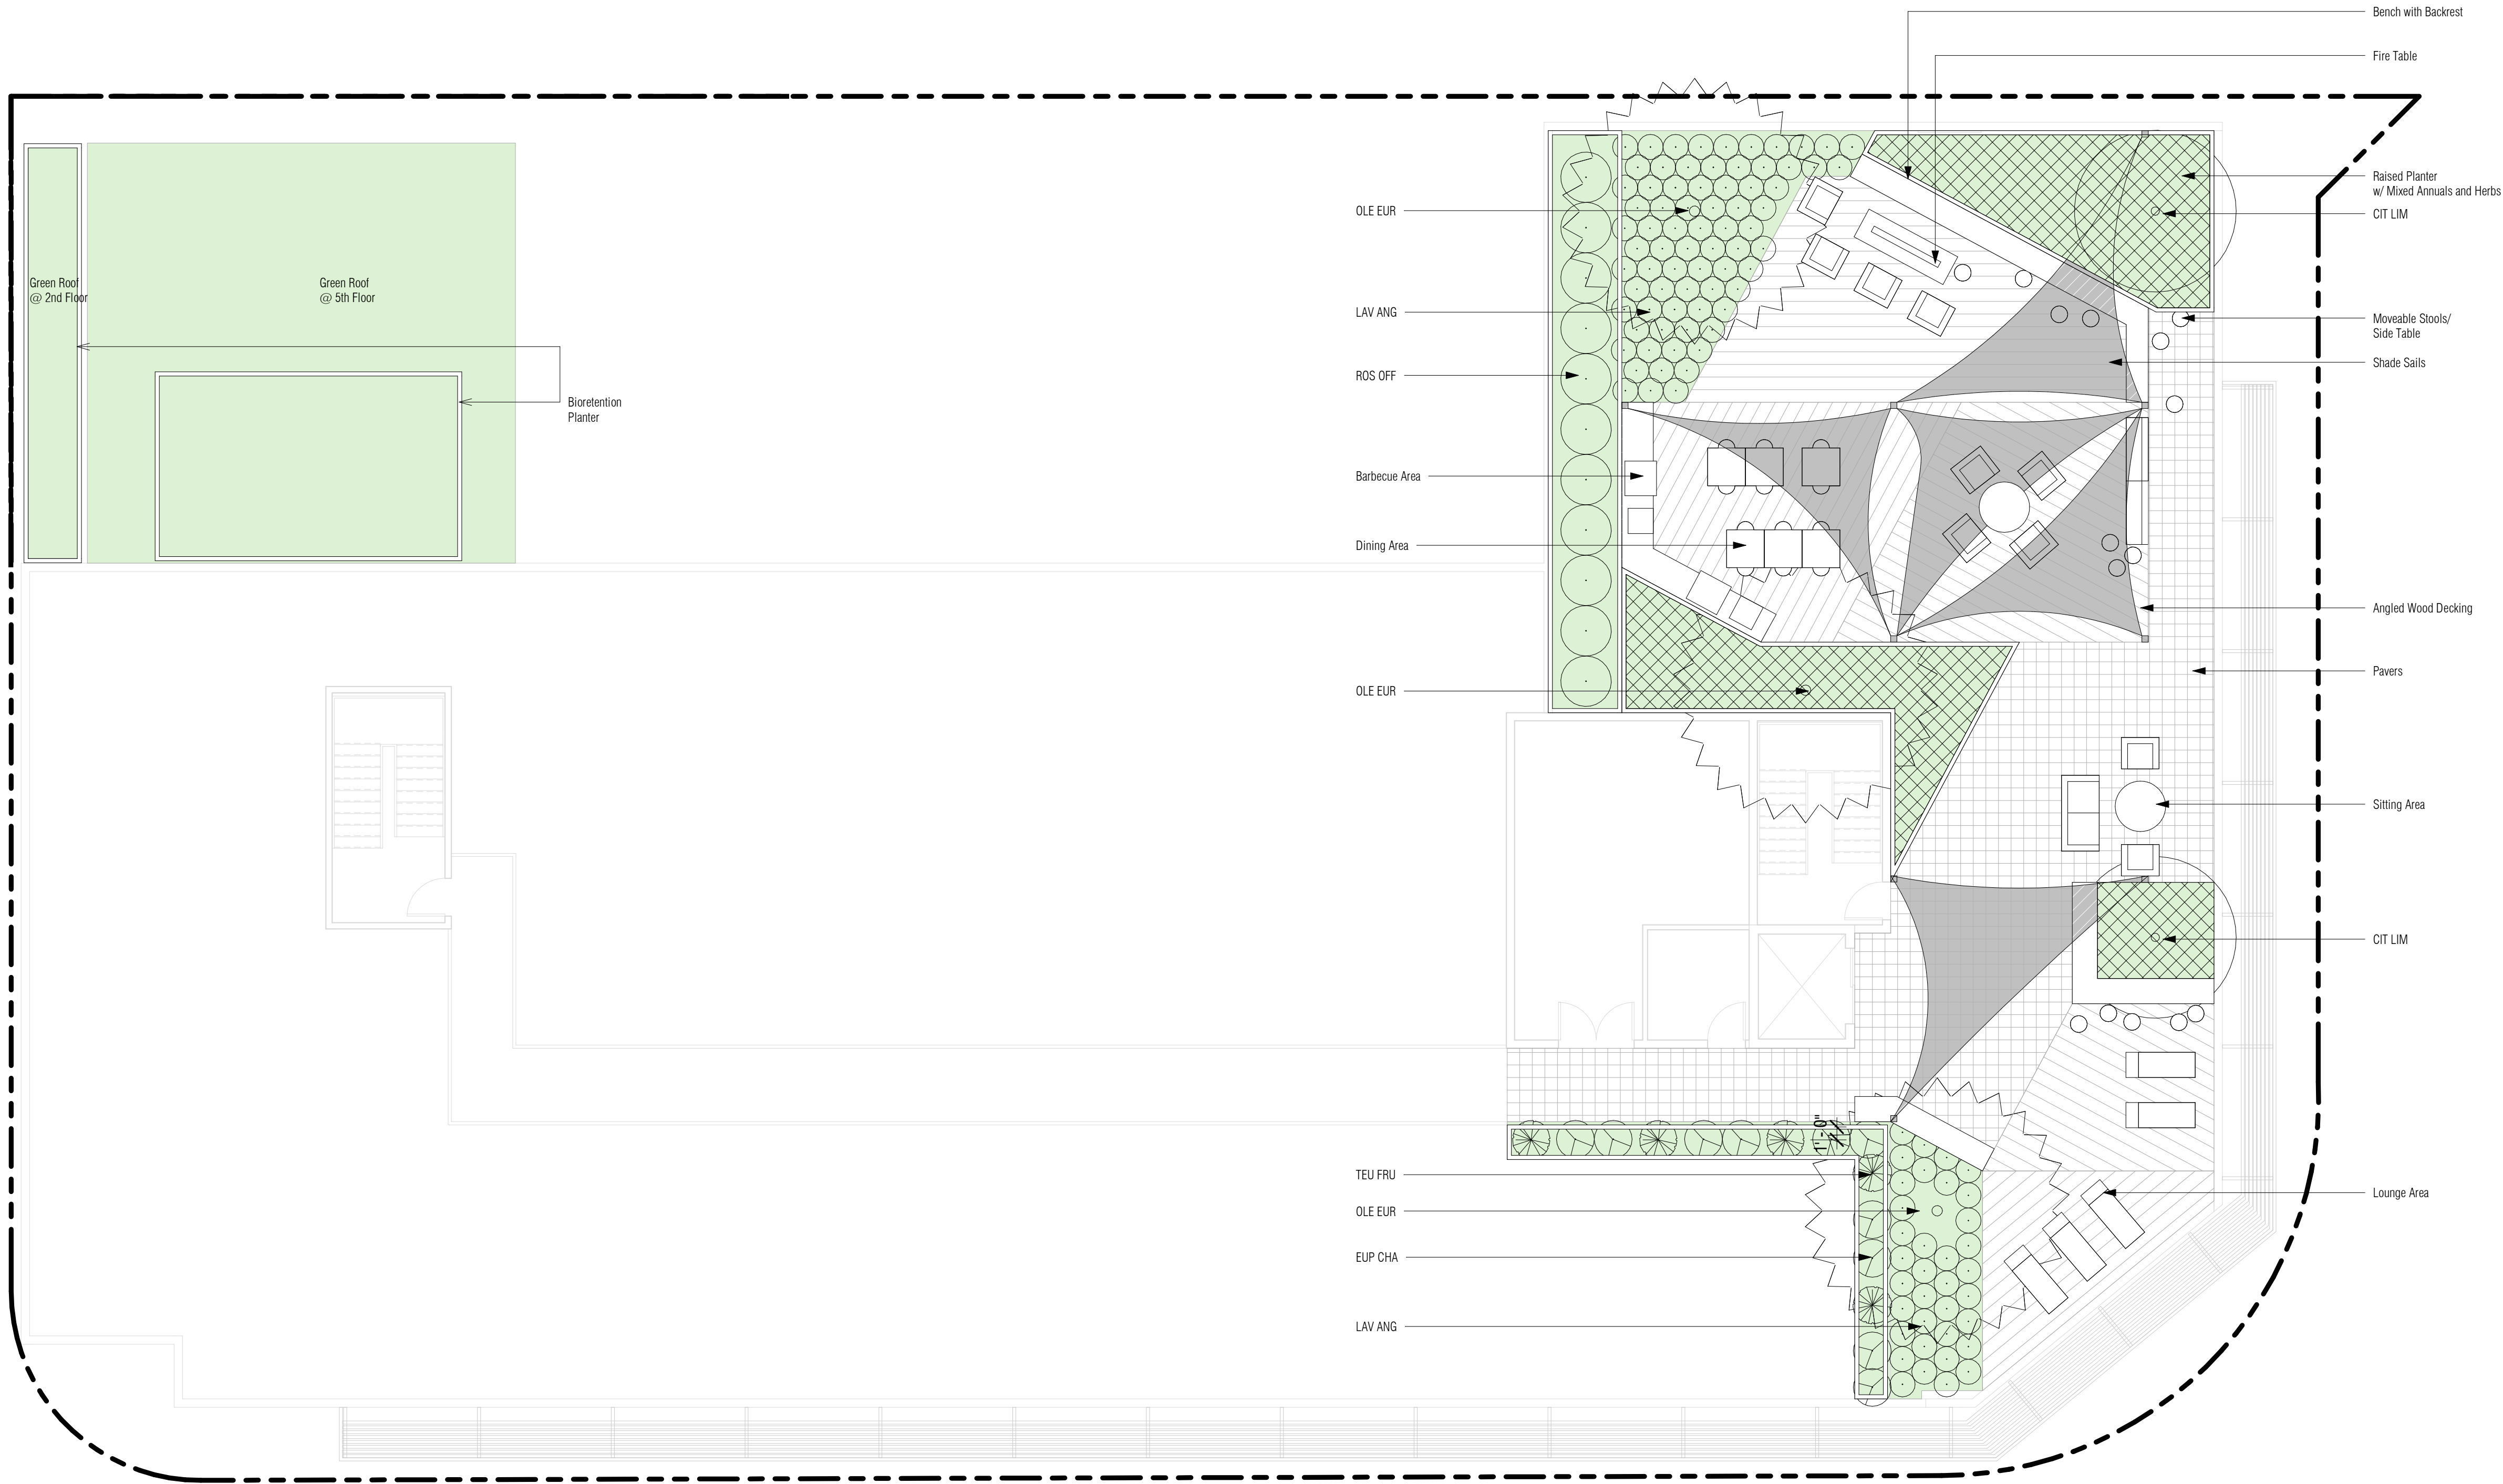

ONE SANTA
ROSA AVE

Owner

Enter Project Address in Manage -> Project Information

OWNER

1 SRA LLC
PO Box 8001
Napa, CA 94559
Phone: 415.519.7574

ARCHITECT

LOWNEY ARCHITECTURE
360 17th Street, Suite 200
Oakland, CA 94612
Phone: 510.269.1124

STRUCTURAL

INNOVATIVE STRUCTURAL
ENGINEERING, INC.
40810 County Center Dr Suite
110 Temecula, CA 92591
Phone: 951.226.4355

CIVIL ENGINEERING

BFK ENGINEERS
200 4th Street, Suite 300,
Santa Rosa, CA 95401
Phone: 707.583.8528

MEP

FARD ENGINEERS, INC.
309 Lennon Lane, Suite 200
Walnut Creek, CA 94598
Phone: 925.932.5505


LANDSCAPE ARCHITECT

LOWNEY ARCHITECTURE
360 17th Street, Suite 200
Oakland, CA 94612
Phone: 510.836.5400

STAMP



#	DATE	ISSUES & REVISIONS	BY
	09/11/2020	SCHEMATIC DESIGN	JB

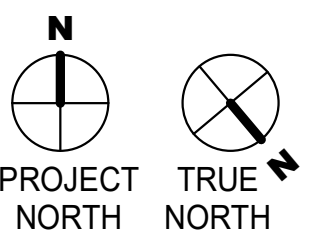

DRAWN BY: Author
PROJECT NUMBER: 00-000
SHEET ISSUE DATE: 07/15/20
SHEET TITLE:

ROOF PLAN

SHEET NUMBER

L02

ALL DRAWINGS AND WRITTEN MATERIAL APPEARING HEREIN
CONSTITUTE ORIGINAL AND UNPUBLISHED WORK OF THE
ARCHITECT AND MAY NOT BE DUPLICATED, USED OR DISCLOSED
WITHOUT WRITTEN CONSENT OF THE ARCHITECT



Angled Wood Decking



Shade Sail



Barbecue Area



Firepit Seating




Chaise Lounges



Green Roof



Citrus Trees:
Buddha's Hand

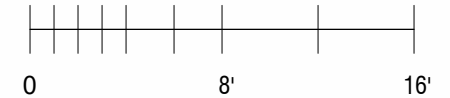



Courtyard Section

ONE SANTA ROSA AVE

Owner

Enter Project Address in Manage -> Project Information

OWNER

1 SRA LLC
PO Box 8001
Napa, CA 94559
Phone: 415.519.7574

ARCHITECT

LOWNEY ARCHITECTURE
360 17th Street, Suite 200
Oakland, CA 94612
Phone: 510.269.1124

STRUCTURAL

INNOVATIVE STRUCTURAL
ENGINEERING, INC.
40810 County Center Dr Suite
110 Temecula, CA 92591
Phone: 951.226.4355

CIVIL ENGINEERING

BFK ENGINEERS
200 4th Street, Suite 300,
Santa Rosa, CA 95401
Phone: 707.583.8528

MEP

FARD ENGINEERS, INC.
309 Lennon Lane, Suite 200
Walnut Creek, CA 94598
Phone: 925.932.5505


LANDSCAPE ARCHITECT

LOWNEY ARCHITECTURE
360 17th Street, Suite 200
Oakland, CA 94612
Phone: 510.836.5400

STAMP



#	DATE	ISSUES & REVISIONS	BY
	09/11/2020	SCHEMATIC DESIGN	JB

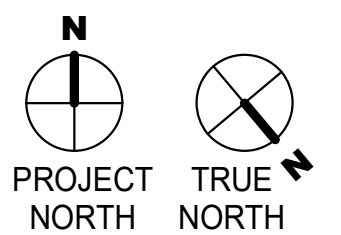


DRAWN BY: Author
PROJECT NUMBER: 00-000
SHEET ISSUE DATE: 07/15/20
SHEET TITLE:

SECTION

SHEET NUMBER

L03

ALL DRAWINGS AND WRITTEN MATERIAL APPEARING HEREIN
CONSTITUTE ORIGINAL AND UNPUBLISHED WORK OF THE
ARCHITECT AND MAY NOT BE DUPLICATED, USED OR DISCLOSED
WITHOUT WRITTEN CONSENT OF THE ARCHITECT

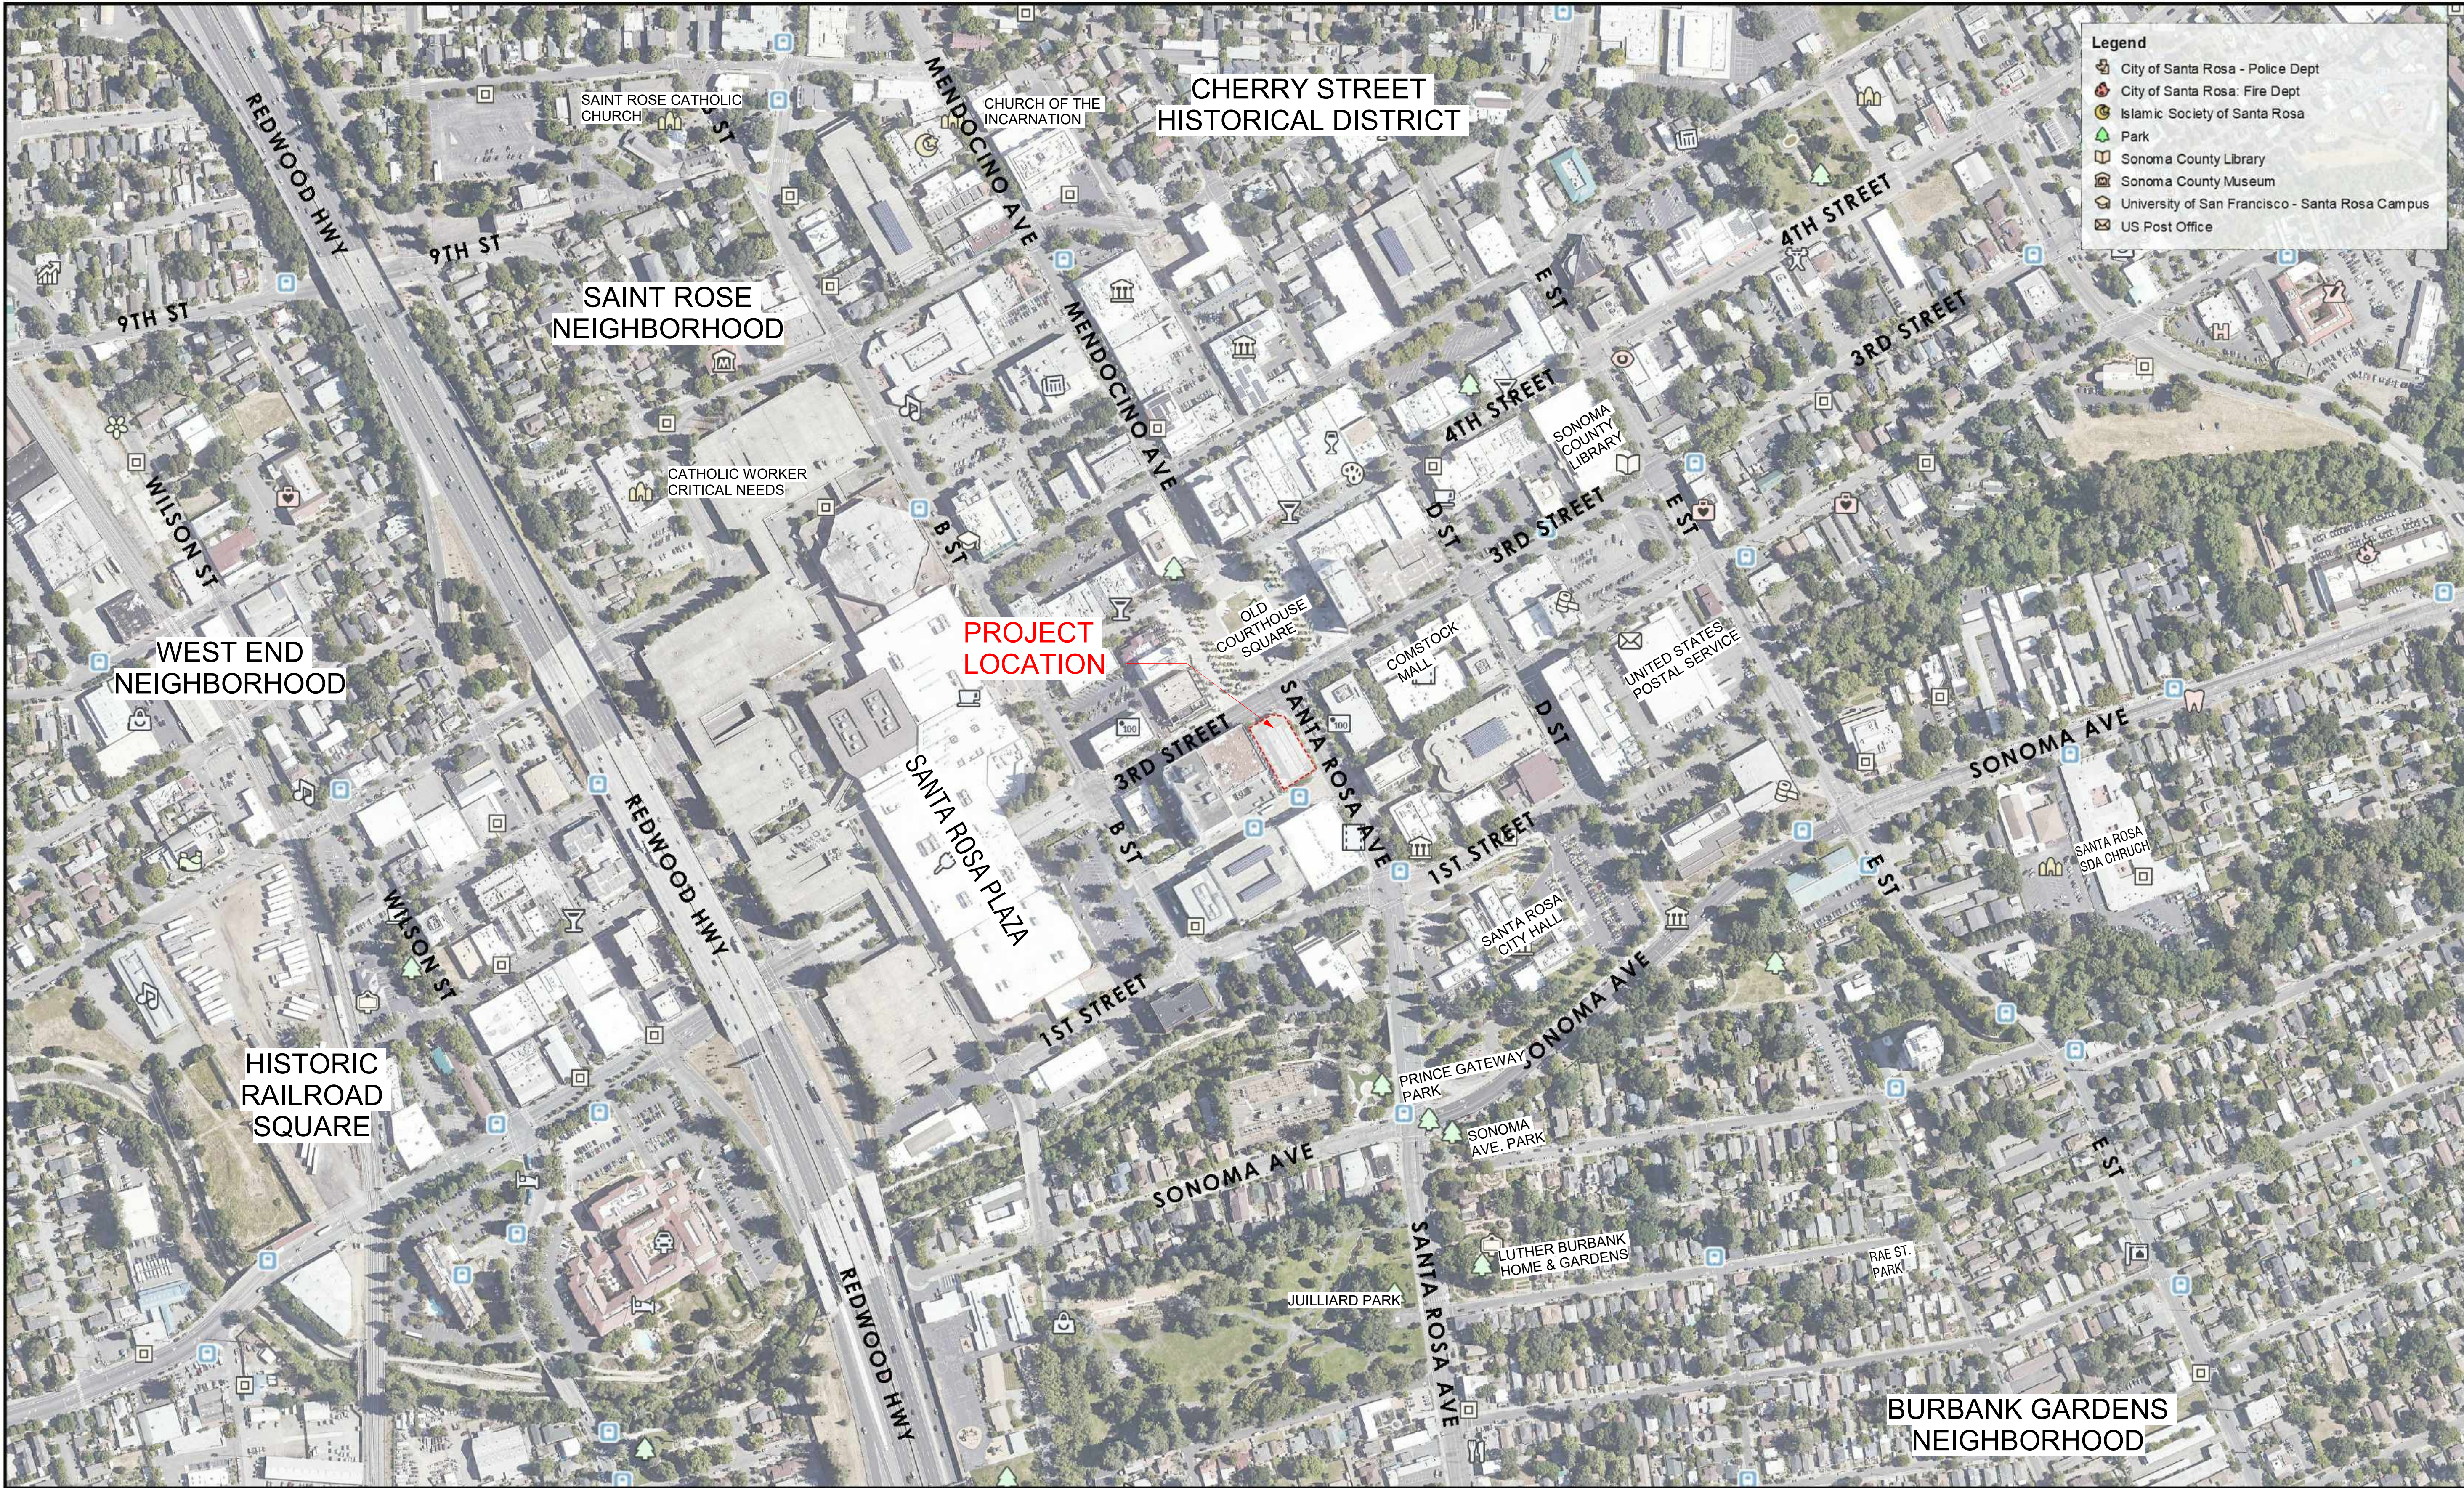

ONE SANTA
ROSA AVE

1 SRA LLC
1 Santa Rosa Ave
Santa Rosa, CA 95404

OWNER
1 SRA LLC
PO Box 8001
Napa, CA 94559
Phone: 415.519.7574

ARCHITECT
LOWNEY ARCHITECTURE
360 17th Street, Suite 200
Oakland, CA 94612
Phone: 510.269.1124

STRUCTURAL
INNOVATIVE STRUCTURAL
ENGINEERING, INC.
40810 County Center Dr Suite
110 Temecula, CA 92591
Phone: 951.226.4355

CIVIL ENGINEERING
BFK ENGINEERS
200 4th Street, Suite 300,
Santa Rosa, CA 95401
Phone: 707.583.8528

MEP
FARD ENGINEERS, INC.
309 Lennon Lane, Suite 200
Walnut Creek, CA 94598
Phone: 925.932.5505

LANDSCAPE ARCHITECT
LOWNEY ARCHITECTURE
360 17th Street, Suite 200
Oakland, CA 94612
Phone: 510.836.5400

STAMP

NOT FOR
CONSTRUCTION


#	DATE	ISSUES & REVISIONS	BY
1	04/14/2020	100% SD	PS
2	04/17/2020	100% SD UPDATES	PS
	05/20/2020	DESIGN REVIEW BOARD	PS
	07/02/2020	REDUCED REVIEW AUTHORITY DESIGN REVIEW	PS

DRAWN BY: SDLP
PROJECT NUMBER: 19-186
SHEET ISSUE DATE: 07/02/20
SHEET TITLE:

NEIGHBORHOOD
CONTEXT MAP

SHEET NUMBER
A0.2

ALL DRAWINGS AND WRITTEN MATERIAL APPEARING HEREIN
CONSTITUTE ORIGINAL AND UNPUBLISHED WORK OF THE
ARCHITECT AND MAY NOT BE DUPLICATED, USED OR DISCLOSED
WITHOUT WRITTEN CONSENT OF THE ARCHITECT

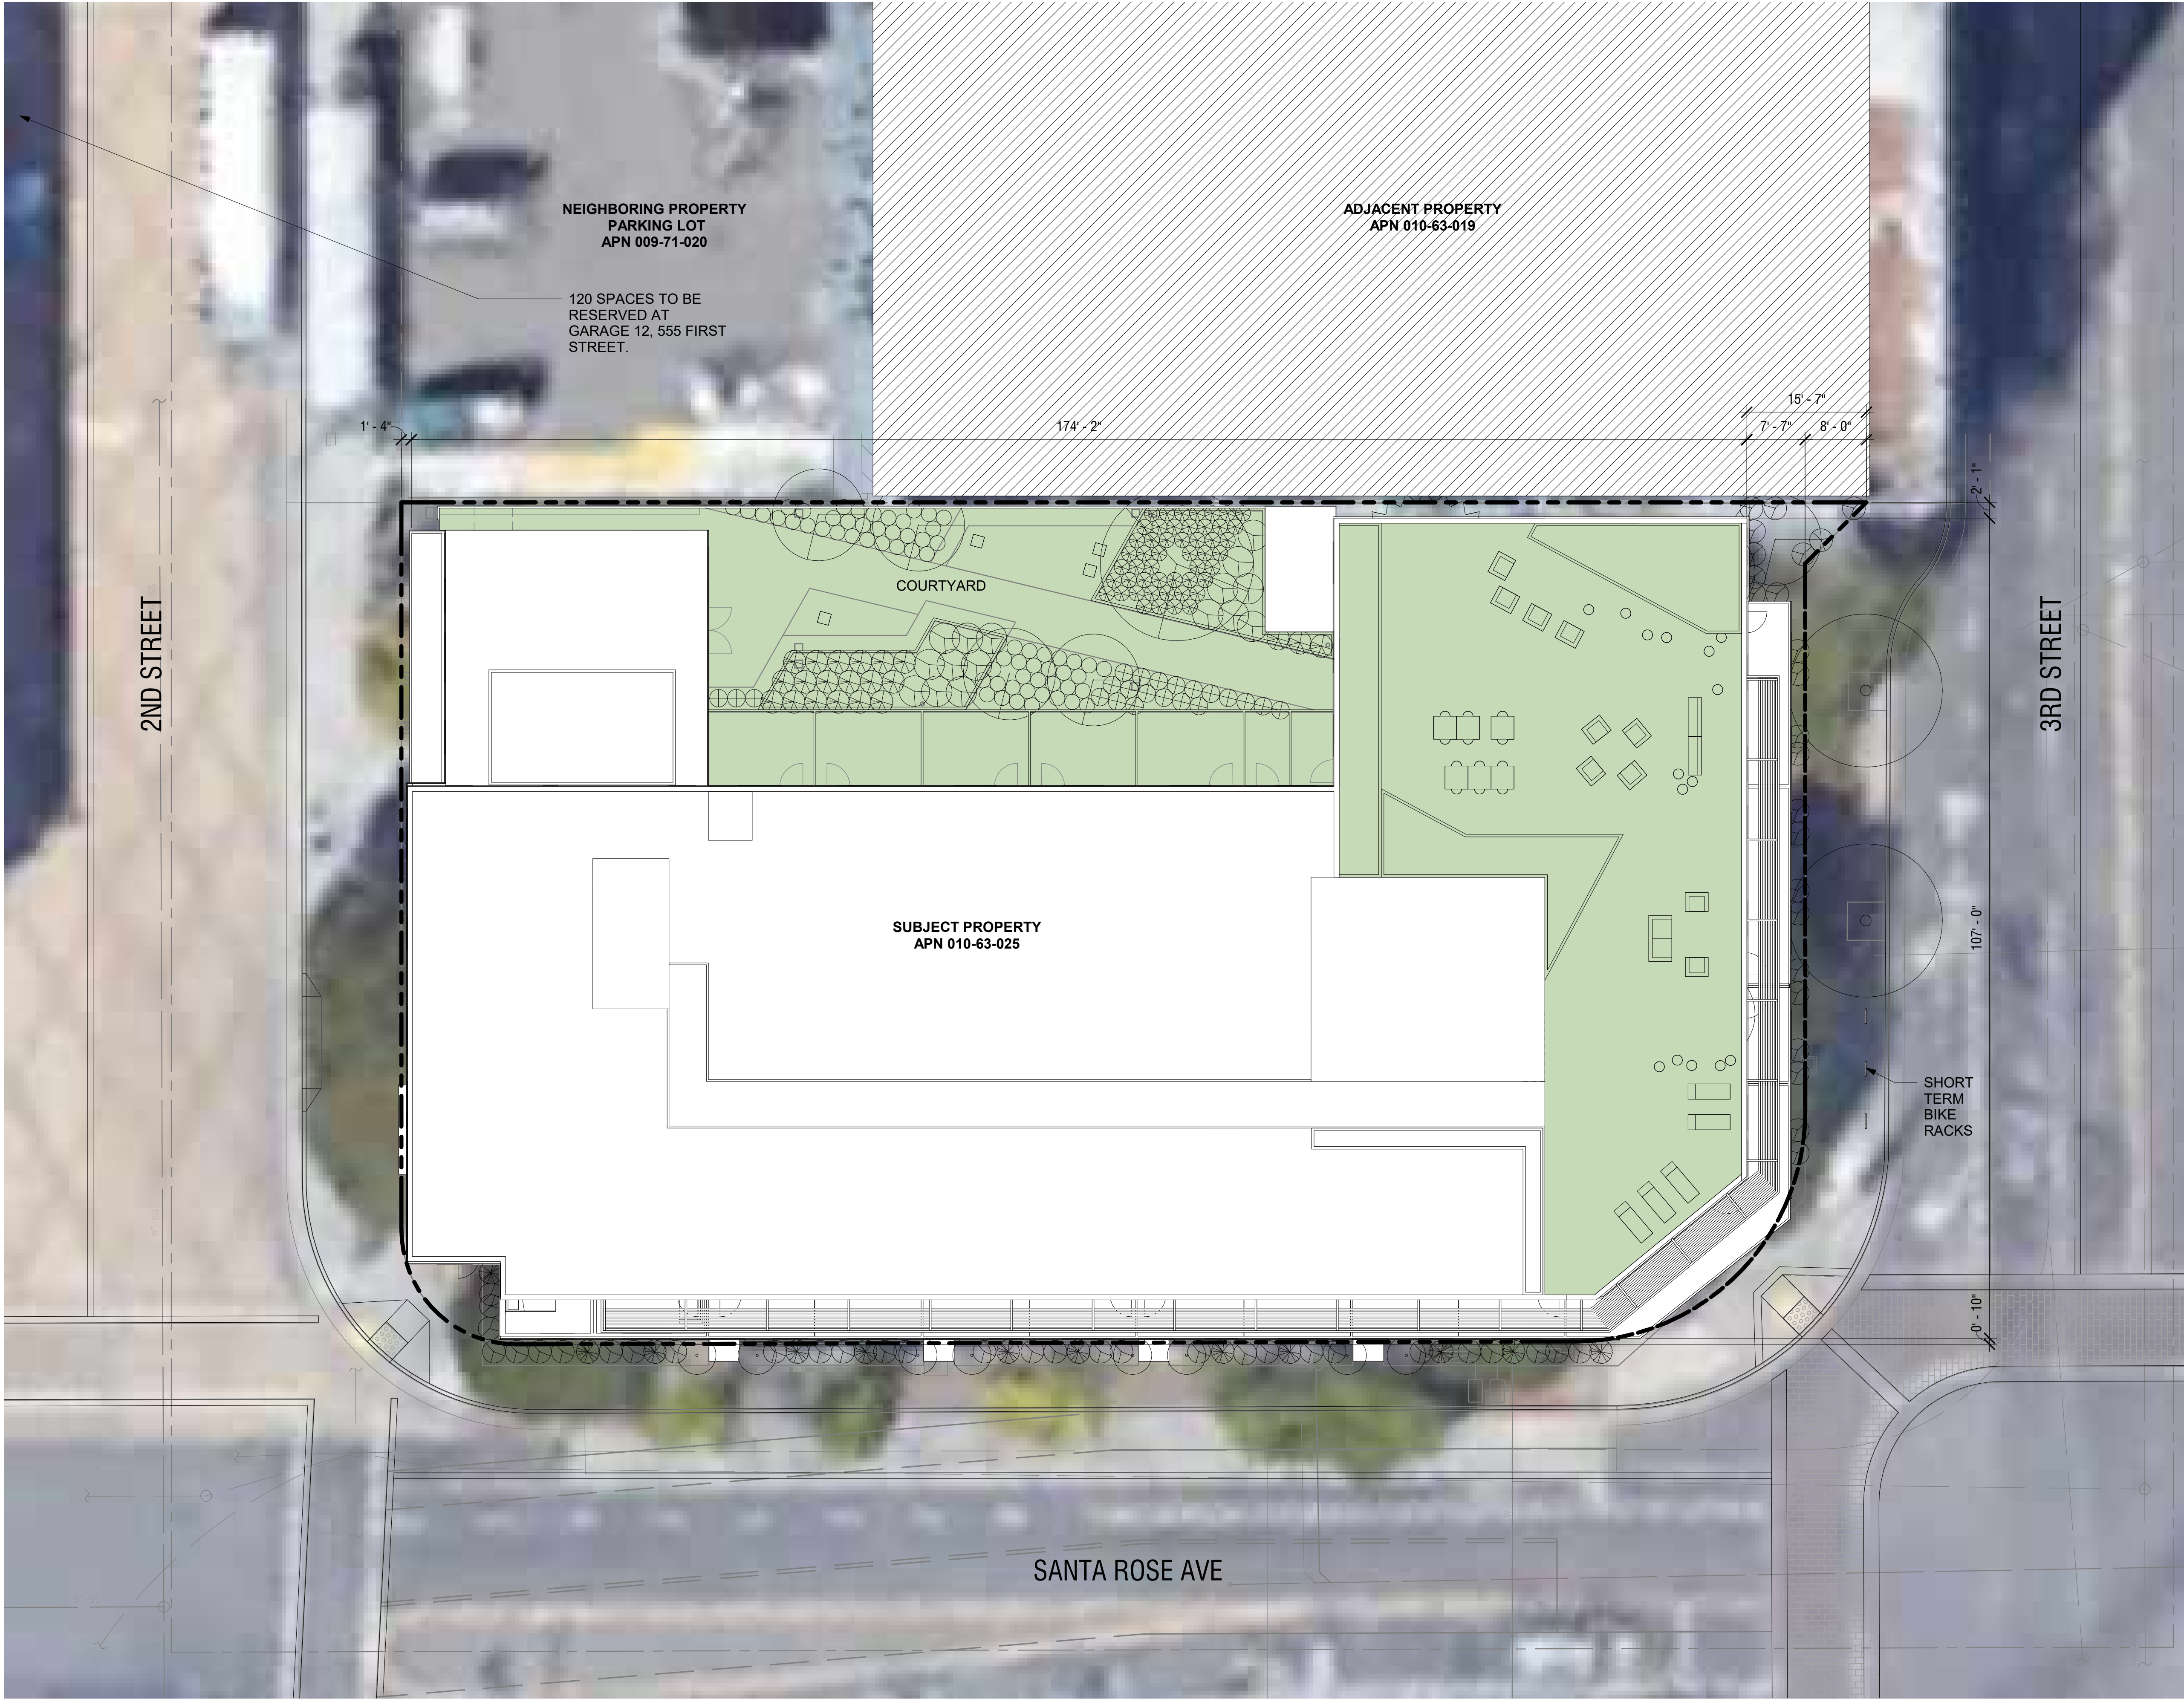

SHEET NOTES

1. ACCESSIBLE PATHS OF TRAVEL SHALL MEET REQUIREMENTS OF CBC 11B-302, SHALL HAVE A CONTINUOUS COMMON SURFACE, NOT INTERRUPTED BY STEPS OR BY ABRUPT CHANGES IN LEVEL EXCEEDING 1/2 INCH AND SHALL BE A MINIMUM OF 48 INCHES IN WIDTH. SURFACE CROSS SLOPES SHALL NOT EXCEED 1/4 INCH PER FOOT. WHEN THE SLOPE IN DIRECTION OF TRAVEL OF ANY WALK EXCEEDS ONE UNIT VERTICAL TO 20 UNITS HORIZONTAL, IT SHALL COMPLY WITH PROVISIONS OF CBC 11B-405 FOR RAMPS.

LEGEND

- PROPOSED BUILDING
- PROPOSED OPEN SPACE
- PROPERTY LINE

lowney
arch

TEL 510.836.5400 URL lowneyarch.com
360 SEVENTEENTH STREET | SUITE 200 | OAKLAND, CALIFORNIA 94612

ONE SANTA
ROSA AVE

1 SRA LLC

1 Santa Rosa Ave
Santa Rosa, CA 95404

OWNER

1 SRA LLC
PO Box 8001
Napa, CA 94559
Phone: 415.519.7574

ARCHITECT

LOWNEY ARCHITECTURE
360 17th Street, Suite 200
Oakland, CA 94612
Phone: 510.269.1124

STRUCTURAL

INNOVATIVE STRUCTURAL
ENGINEERING, INC.
40810 County Center Dr Suite
110 Temecula, CA 92591
Phone: 951.226.4355

CIVIL ENGINEERING

BFK ENGINEERS
200 4th Street, Suite 300,
Santa Rosa, CA 95401
Phone: 707.583.8528

MEP

FARD ENGINEERS, INC.
309 Lennon Lane, Suite 200
Walnut Creek, CA 94598
Phone: 925.932.5505


LANDSCAPE ARCHITECT

LOWNEY ARCHITECTURE
360 17th Street, Suite 200
Oakland, CA 94612
Phone: 510.836.5400

STAMP

NOT FOR
CONSTRUCTION

#	DATE	ISSUES & REVISIONS	BY
	04/14/202	100% SD	PS
2	04/17/2020	100% SD UPDATES	PS
	05/20/2020	DESIGN REVIEW BOARD	PS
	07/02/2020	REDUCED REVIEW AUTHORITY DESIGN REVIEW	PS

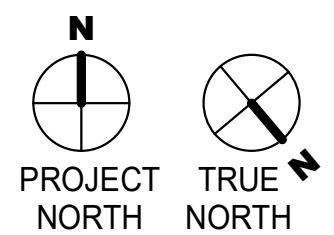

DRAWN BY: SDLP
PROJECT NUMBER: 19-186
SHEET ISSUE DATE: 07/02/20
SHEET TITLE:

SITE PLAN

SHEET NUMBER

A1.0

ALL DRAWINGS AND WRITTEN MATERIAL APPEARING HEREIN CONSTITUTE ORIGINAL AND UNPUBLISHED WORK OF THE ARCHITECT AND MAY NOT BE DUPLICATED, USED OR DISCLOSED WITHOUT WRITTEN CONSENT OF THE ARCHITECT

1 ROOF LEVEL SITE PLAN
3/32" = 1'-0"

9/4/2020 6:06:53 PM

9/4/2020 5:07:02 PM

1 GROUND LEVEL
1/8" = 1'-0"



KEY NOTES

- 1 LOW-HEIGHT LANDSCAPE WALL SCONCE
SPEC: BEGA 22 261 SCONCE
W/ BLACK TRIM FINISH.
6 7/8" W X 3 3/4" H 2 3/8" D
LOCATION: WALL MOUNT, CENTERED
BETWEEN UNIT WINDOWS, BOTTOM OF
FIXTURE TO ALIGN WITH BOTTOM OF
ADJACENT WINDOW SILL

lowney
arch

TEL 510.836.5400 URL lowneyarch.com
350 SEVENTEENTH STREET | SUITE 200 | OAKLAND, CALIFORNIA 94612

**ONE SANTA
ROSA AVE**

1 SRA LLC

1 Santa Rosa Ave
Santa Rosa, CA 95404

OWNER

1 SRA LLC
PO Box 8001
Napa, CA 94559
Phone: 415.519.7574

ARCHITECT

LOWNEY ARCHITECTURE
360 17th Street, Suite 200
Oakland, CA 94612
Phone: 510.269.1124

STRUCTURAL

INNOVATIVE STRUCTURAL
ENGINEERING, INC.
40810 County Center Dr Suite
110 Temecula, CA 92591
Phone: 951.226.4355

CIVIL ENGINEERING

BKF ENGINEERS
200 4th Street, Suite 300,
Santa Rosa, CA 95401
Phone: 707.583.8528

MEP

FARD ENGINEERS, INC.
309 Lennon Lane, Suite 200
Walnut Creek, CA 94598
Phone: 925.932.5505

LANDSCAPE ARCHITECT

LOWNEY ARCHITECTURE
360 17th Street, Suite 200
Oakland, CA 94612
Phone: 510.836.5400


STAMP

**NOT FOR
CONSTRUCTION**

#	DATE	ISSUES & REVISIONS	BY
1	04/14/202	100% SD	PS
2	04/17/2020	100% SD UPDATES	PS
	05/20/2020	DESIGN REVIEW BOARD	PS
	07/02/2020	REDUCED REVIEW AUTHORITY DESIGN REVIEW	PS

Legend

- 1 BEDROOM
- 2 BEDROOM
- AMENITY
- CIRCULATION
- OPEN SPACE
- RESIDENTIAL LOBBY
- RESTAURANT
- STUDIO
- UTILITY

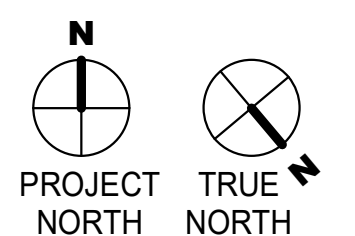

DRAWN BY: SDLP
PROJECT NUMBER: 19-186
SHEET ISSUE DATE: 07/02/20
SHEET TITLE:

**GROUND FLOOR
PLAN**

SHEET NUMBER

A2.1

ALL DRAWINGS AND WRITTEN MATERIAL APPEARING HEREIN
CONSTITUTE ORIGINAL AND UNPUBLISHED WORK OF THE
ARCHITECT AND MAY NOT BE DUPLICATED, USED OR DISCLOSED
WITHOUT WRITTEN CONSENT OF THE ARCHITECT

9/4/2020 6:07:05 PM



ONE SANTA ROSA AVE

1 SRA LLC
1 Santa Rosa Ave
Santa Rosa, CA 95404

OWNER
1 SRA LLC
PO Box 8001
Napa, CA 94559
Phone: 415.519.7574

ARCHITECT
LOWNEY ARCHITECTURE
360 17th Street, Suite 200
Oakland, CA 94612
Phone: 510.269.1124

STRUCTURAL
INNOVATIVE STRUCTURAL
ENGINEERING, INC.
40810 County Center Dr Suite
110 Temecula, CA 92591
Phone: 951.226.4355

CIVIL ENGINEERING
BFK ENGINEERS
200 4th Street, Suite 300,
Santa Rosa, CA 95401
Phone: 707.583.8528

MEP
FARD ENGINEERS, INC.
309 Lennon Lane, Suite 200
Walnut Creek, CA 94598
Phone: 925.932.5505

LANDSCAPE ARCHITECT
LOWNEY ARCHITECTURE
360 17th Street, Suite 200
Oakland, CA 94612
Phone: 510.836.5400

STAMP

**NOT FOR
CONSTRUCTION**

#	DATE	ISSUES & REVISIONS	BY
04/14/202	100% SD	PS	
2	04/17/2020	100% SD UPDATES	PS
05/20/2020	DESIGN REVIEW BOARD	PS	
07/02/2020	REDUCED REVIEW AUTHORITY DESIGN REVIEW	PS	



DRAWN BY: SDLP
PROJECT NUMBER: 19-186
SHEET ISSUE DATE: 07/02/20
SHEET TITLE:

LEVEL 2 FLOOR PLAN

SHEET NUMBER

A2.2

ALL DRAWINGS AND WRITTEN MATERIAL APPEARING HEREIN CONSTITUTE ORIGINAL AND UNPUBLISHED WORK OF THE ARCHITECT AND MAY NOT BE DUPLICATED, USED OR DISCLOSED WITHOUT WRITTEN CONSENT OF THE ARCHITECT

1 Santa Rosa Ave
Santa Rosa, CA 9540

OWNER
1 SRA LLC
PO Box 8001
Napa, CA 94559
Phone: 415.519.7574

ARCHITECT
LOWNEY ARCHITECTURE
360 17th Street, Suite 200
Oakland, CA 94612
Phone: 510.269.1124

STRUCTURAL
INNOVATIVE STRUCTURAL
ENGINEERING, INC.
40810 County Center Dr Suite
110 Temecula, CA 92591
Phone: 951.226.4355

CIVIL ENGINEERING
BKF ENGINEERS
200 4th Street, Suite 300,
Santa Rosa, CA 95401
Phone: 707.583.8528


MEP
FARD ENGINEERS, INC.
309 Lennon Lane, Suite 200
Walnut Creek, CA 94598
Phone: 925.932.5505

LANDSCAPE ARCHITECT
LOWNEY ARCHITECTURE
360 17th Street, Suite 200
Oakland, CA 94612
Phone: 510.836.5400

STAMP

**NOT FOR
CONSTRUCTION**

#	DATE	ISSUES & REVISIONS	B
	04/14/2022	100% SD	P
2	04/17/2020	100% SD UPDATES	P
	05/20/2020	DESIGN REVIEW BOARD	P
	07/02/2020	REDUCED REVIEW AUTHORITY DESIGN REVIEW	P

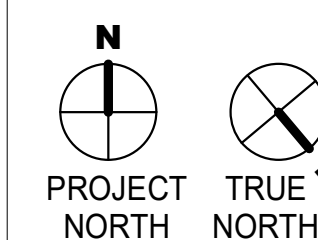

DRAWN BY: SDLP
PROJECT NUMBER: 19-186
SHEET ISSUE DATE: 07/02/20
SHEET TITLE:


LEVEL 3 FLOOR
PLAN

SHEET NUMBER

A2.3

ALL DRAWINGS AND WRITTEN MATERIAL APPEARING HEREIN
CONSTITUTE ORIGINAL AND UNPUBLISHED WORK OF THE
ARCHITECT AND MAY NOT BE DUPLICATED, USED OR DISCLOSED
WITHOUT WRITTEN CONSENT OF THE ARCHITECT

1 AFFORDABLE UNIT

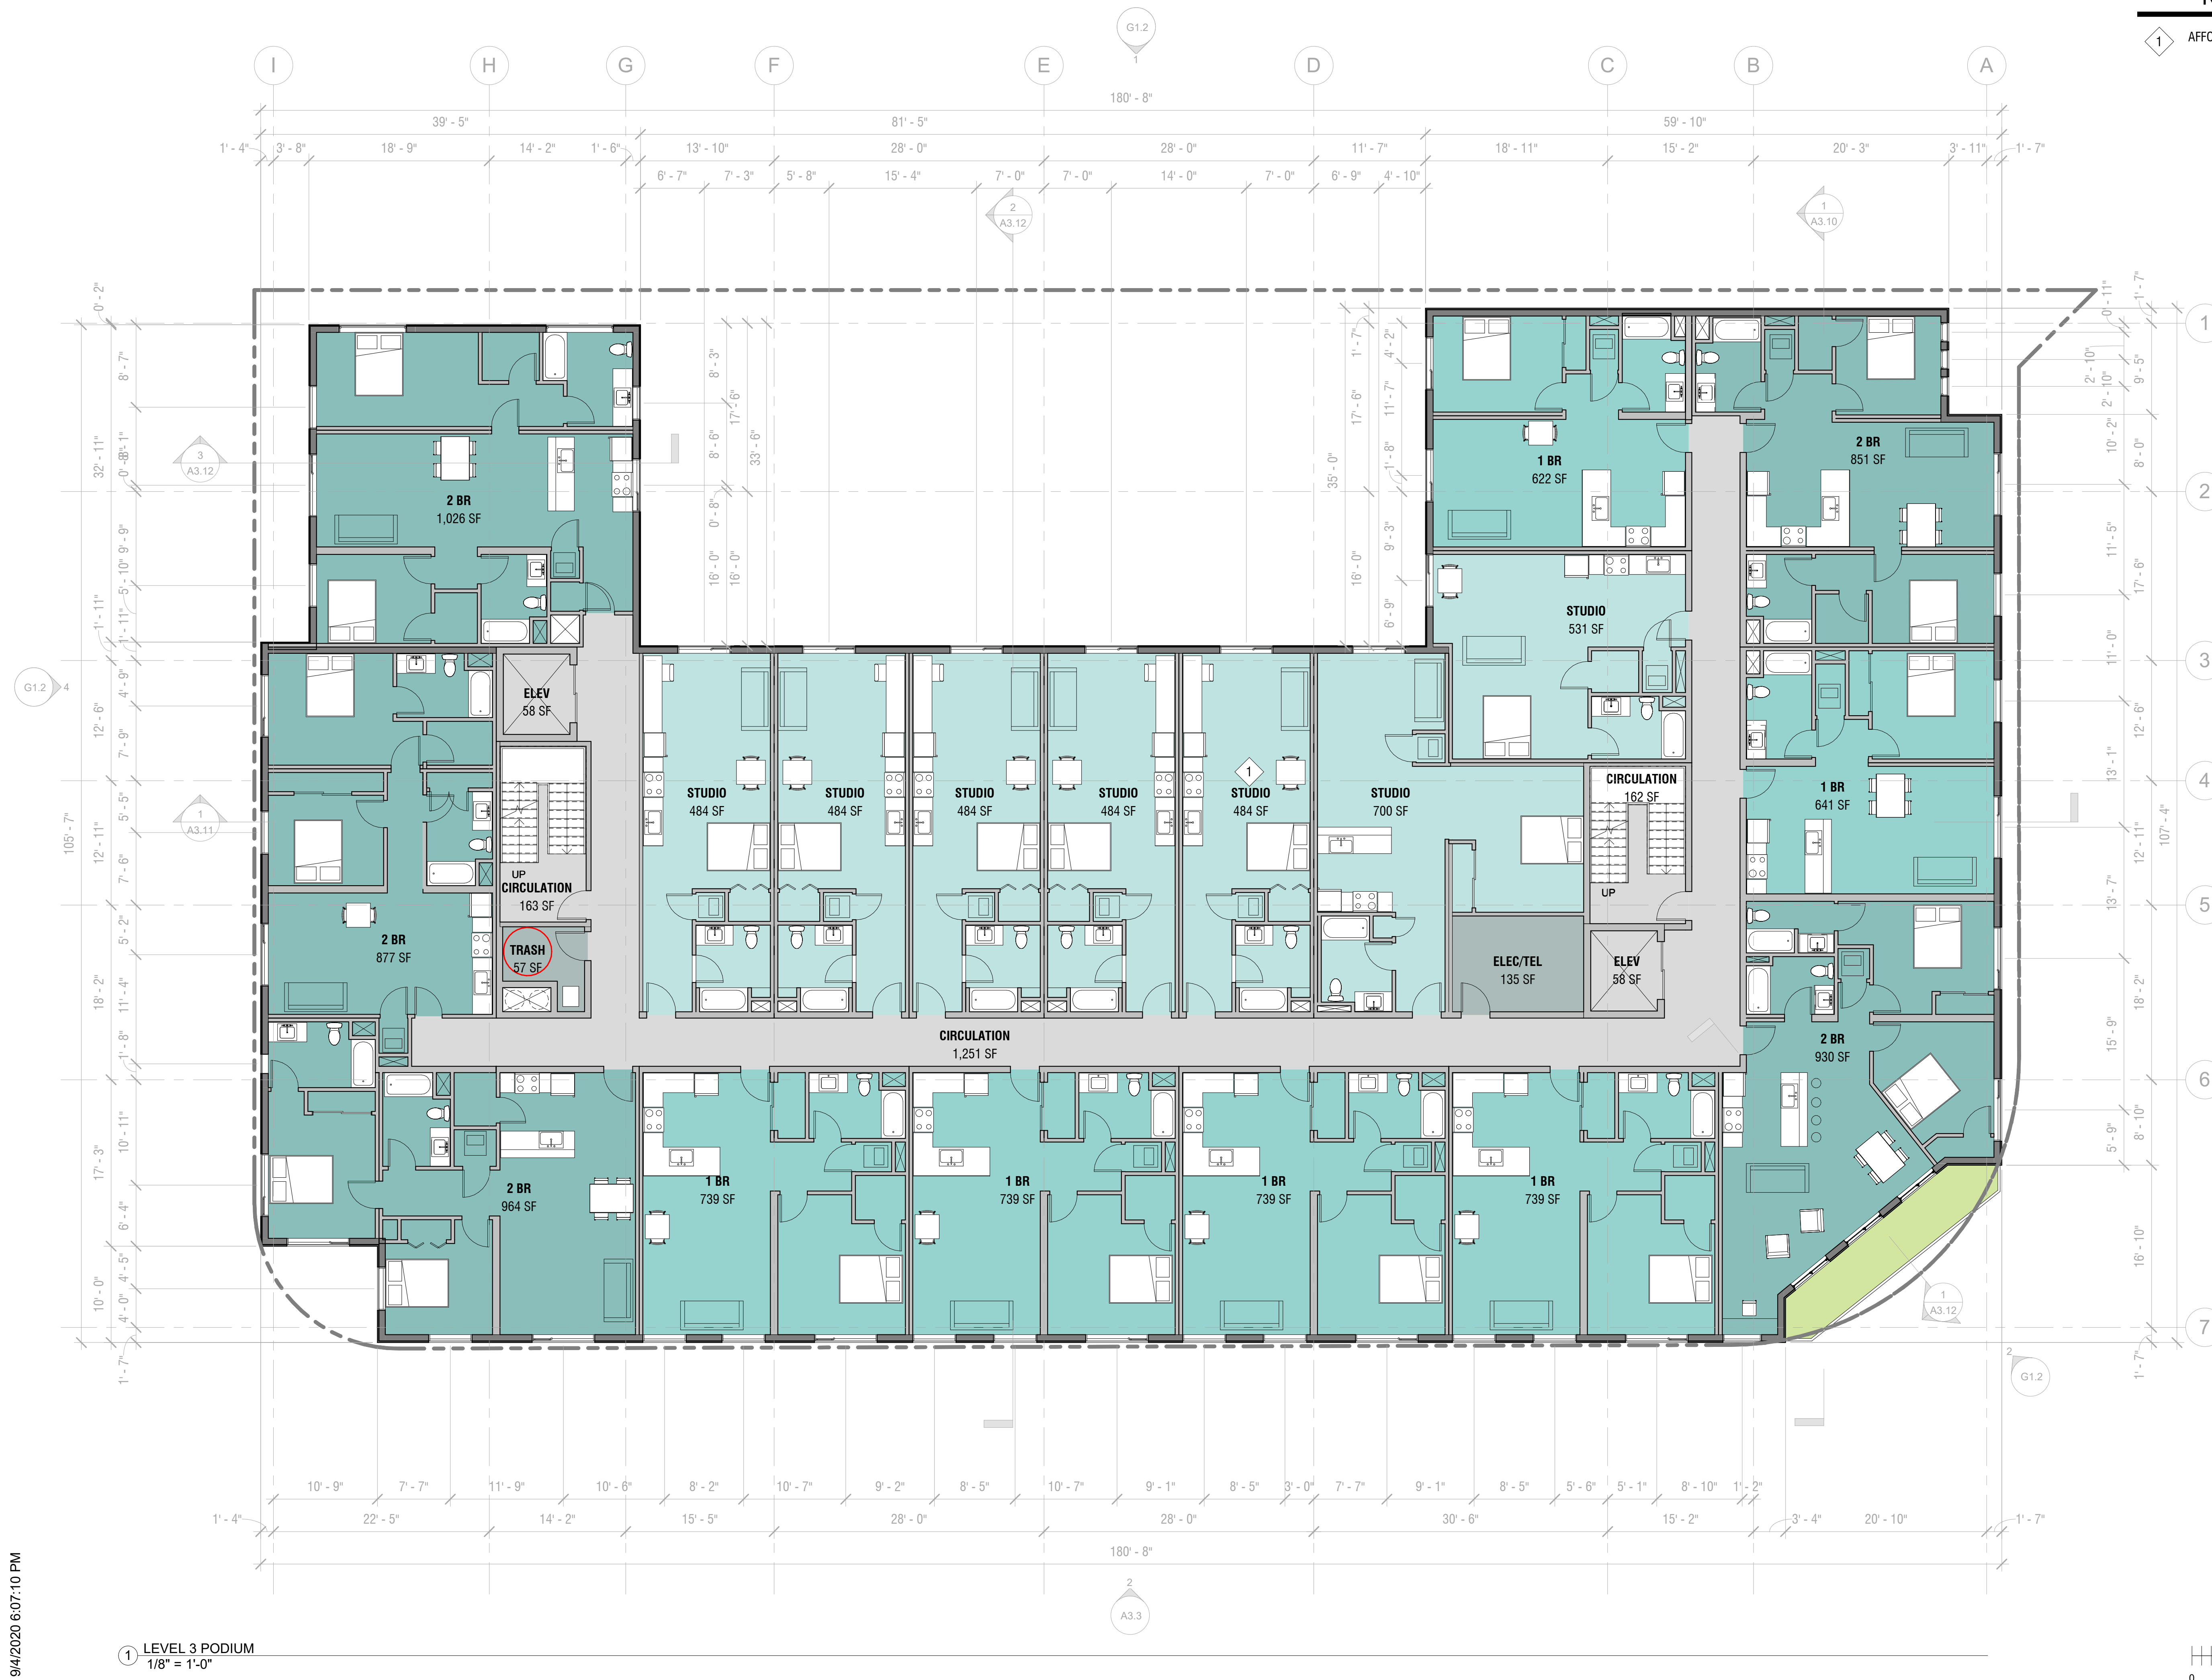

9/4/2020 6:07:10 PM

9/4/2020 6:07:14 PM



① LEVEL 4
1/8" = 1'-0"

KEY NOTES

① AFFORDABLE UNIT

Legend

- 1 BEDROOM
- 2 BEDROOM
- CIRCULATION
- STUDIO
- UTILITY



Tel: 510.836.5400 URL: lowneyarch.com
350 seveneenth street | suite 200 | oakland, california 94612

ONE SANTA ROSA AVE

1 SRA LLC

1 Santa Rosa Ave
Santa Rosa, CA 95404

OWNER

1 SRA LLC
PO Box 8001
Napa, CA 94559
Phone: 415.519.7574

ARCHITECT

LOWNEY ARCHITECTURE
360 17th Street, Suite 200
Oakland, CA 94612
Phone: 510.269.1124

STRUCTURAL

INNOVATIVE STRUCTURAL
ENGINEERING, INC.
40810 County Center Dr Suite
110 Temecula, CA 92591
Phone: 951.226.4355

CIVIL ENGINEERING

BFK ENGINEERS
200 4th Street, Suite 300,
Santa Rosa, CA 95401
Phone: 707.583.8528

MEP

FARD ENGINEERS, INC.
309 Lennon Lane, Suite 200
Walnut Creek, CA 94598
Phone: 925.932.5505


LANDSCAPE ARCHITECT

LOWNEY ARCHITECTURE
360 17th Street, Suite 200
Oakland, CA 94612
Phone: 510.836.5400

STAMP

**NOT FOR
CONSTRUCTION**

#	DATE	ISSUES & REVISIONS	BY
04/14/202	100% SD	PS	
2	04/17/2020	100% SD UPDATES	PS
	05/20/2020	DESIGN REVIEW BOARD	PS
	07/02/2020	REDUCED REVIEW AUTHORITY DESIGN REVIEW	PS

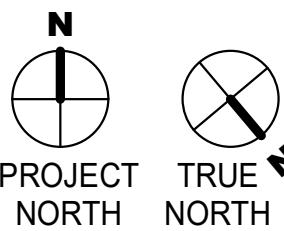

DRAWN BY: SDLP
PROJECT NUMBER: 19-186
SHEET ISSUE DATE: 07/02/20
SHEET TITLE:

LEVEL 4 FLOOR PLAN

SHEET NUMBER

A2.4

ALL DRAWINGS AND WRITTEN MATERIAL APPEARING HEREIN CONSTITUTE ORIGINAL AND UNPUBLISHED WORK OF THE ARCHITECT AND MAY NOT BE DUPLICATED, USED OR DISCLOSED WITHOUT WRITTEN CONSENT OF THE ARCHITECT

9/4/2020 5:07:19 PM



KEY NOTES

1 AFFORDABLE UNIT

lowney
arch

Tel: 510.836.5400 | www.lowneyarch.com
350 Seventh Street | Suite 200 | Oakland, California 94612

ONE SANTA ROSA AVE

1 SRA LLC

1 Santa Rosa Ave
Santa Rosa, CA 95404

OWNER

1 SRA LLC
PO Box 8001
Napa, CA 94559
Phone: 415.519.7574

ARCHITECT

LOWNEY ARCHITECTURE
360 17th Street, Suite 200
Oakland, CA 94612
Phone: 510.269.1124

STRUCTURAL

INNOVATIVE STRUCTURAL
ENGINEERING, INC.
40810 County Center Dr Suite
110 Temecula, CA 92591
Phone: 951.226.4355

CIVIL ENGINEERING

BFK ENGINEERS
200 4th Street, Suite 300,
Santa Rosa, CA 95401
Phone: 707.583.8528

MEP

FARD ENGINEERS, INC.
309 Lennon Lane, Suite 200
Walnut Creek, CA 94598
Phone: 925.932.5505


LANDSCAPE ARCHITECT

LOWNEY ARCHITECTURE
360 17th Street, Suite 200
Oakland, CA 94612
Phone: 510.836.5400

STAMP

**NOT FOR
CONSTRUCTION**

#	DATE	ISSUES & REVISIONS	BY
2	04/14/2020	100% SD	PS
	04/17/2020	100% SD UPDATES	PS
	05/20/2020	DESIGN REVIEW BOARD	PS
	07/02/2020	REDUCED REVIEW AUTHORITY DESIGN REVIEW	PS

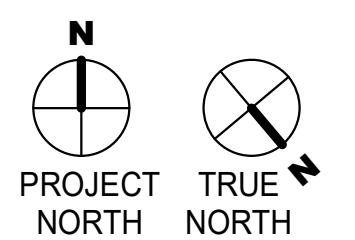

DRAWN BY: SDLP
PROJECT NUMBER: 19-186
SHEET ISSUE DATE: 07/02/20
SHEET TITLE:

LEVEL 5 FLOOR PLAN

SHEET NUMBER

A2.5


ALL DRAWINGS AND WRITTEN MATERIAL APPEARING HEREIN
CONSTITUTE ORIGINAL AND UNPUBLISHED WORK OF THE
ARCHITECT AND MAY NOT BE DUPLICATED, USED OR DISCLOSED
WITHOUT WRITTEN CONSENT OF THE ARCHITECT

Legend

- 1 BEDROOM
- 2 BEDROOM
- CIRCULATION
- OPEN SPACE
- STUDIO
- UTILITY



9/4/2020 6:07:23 PM

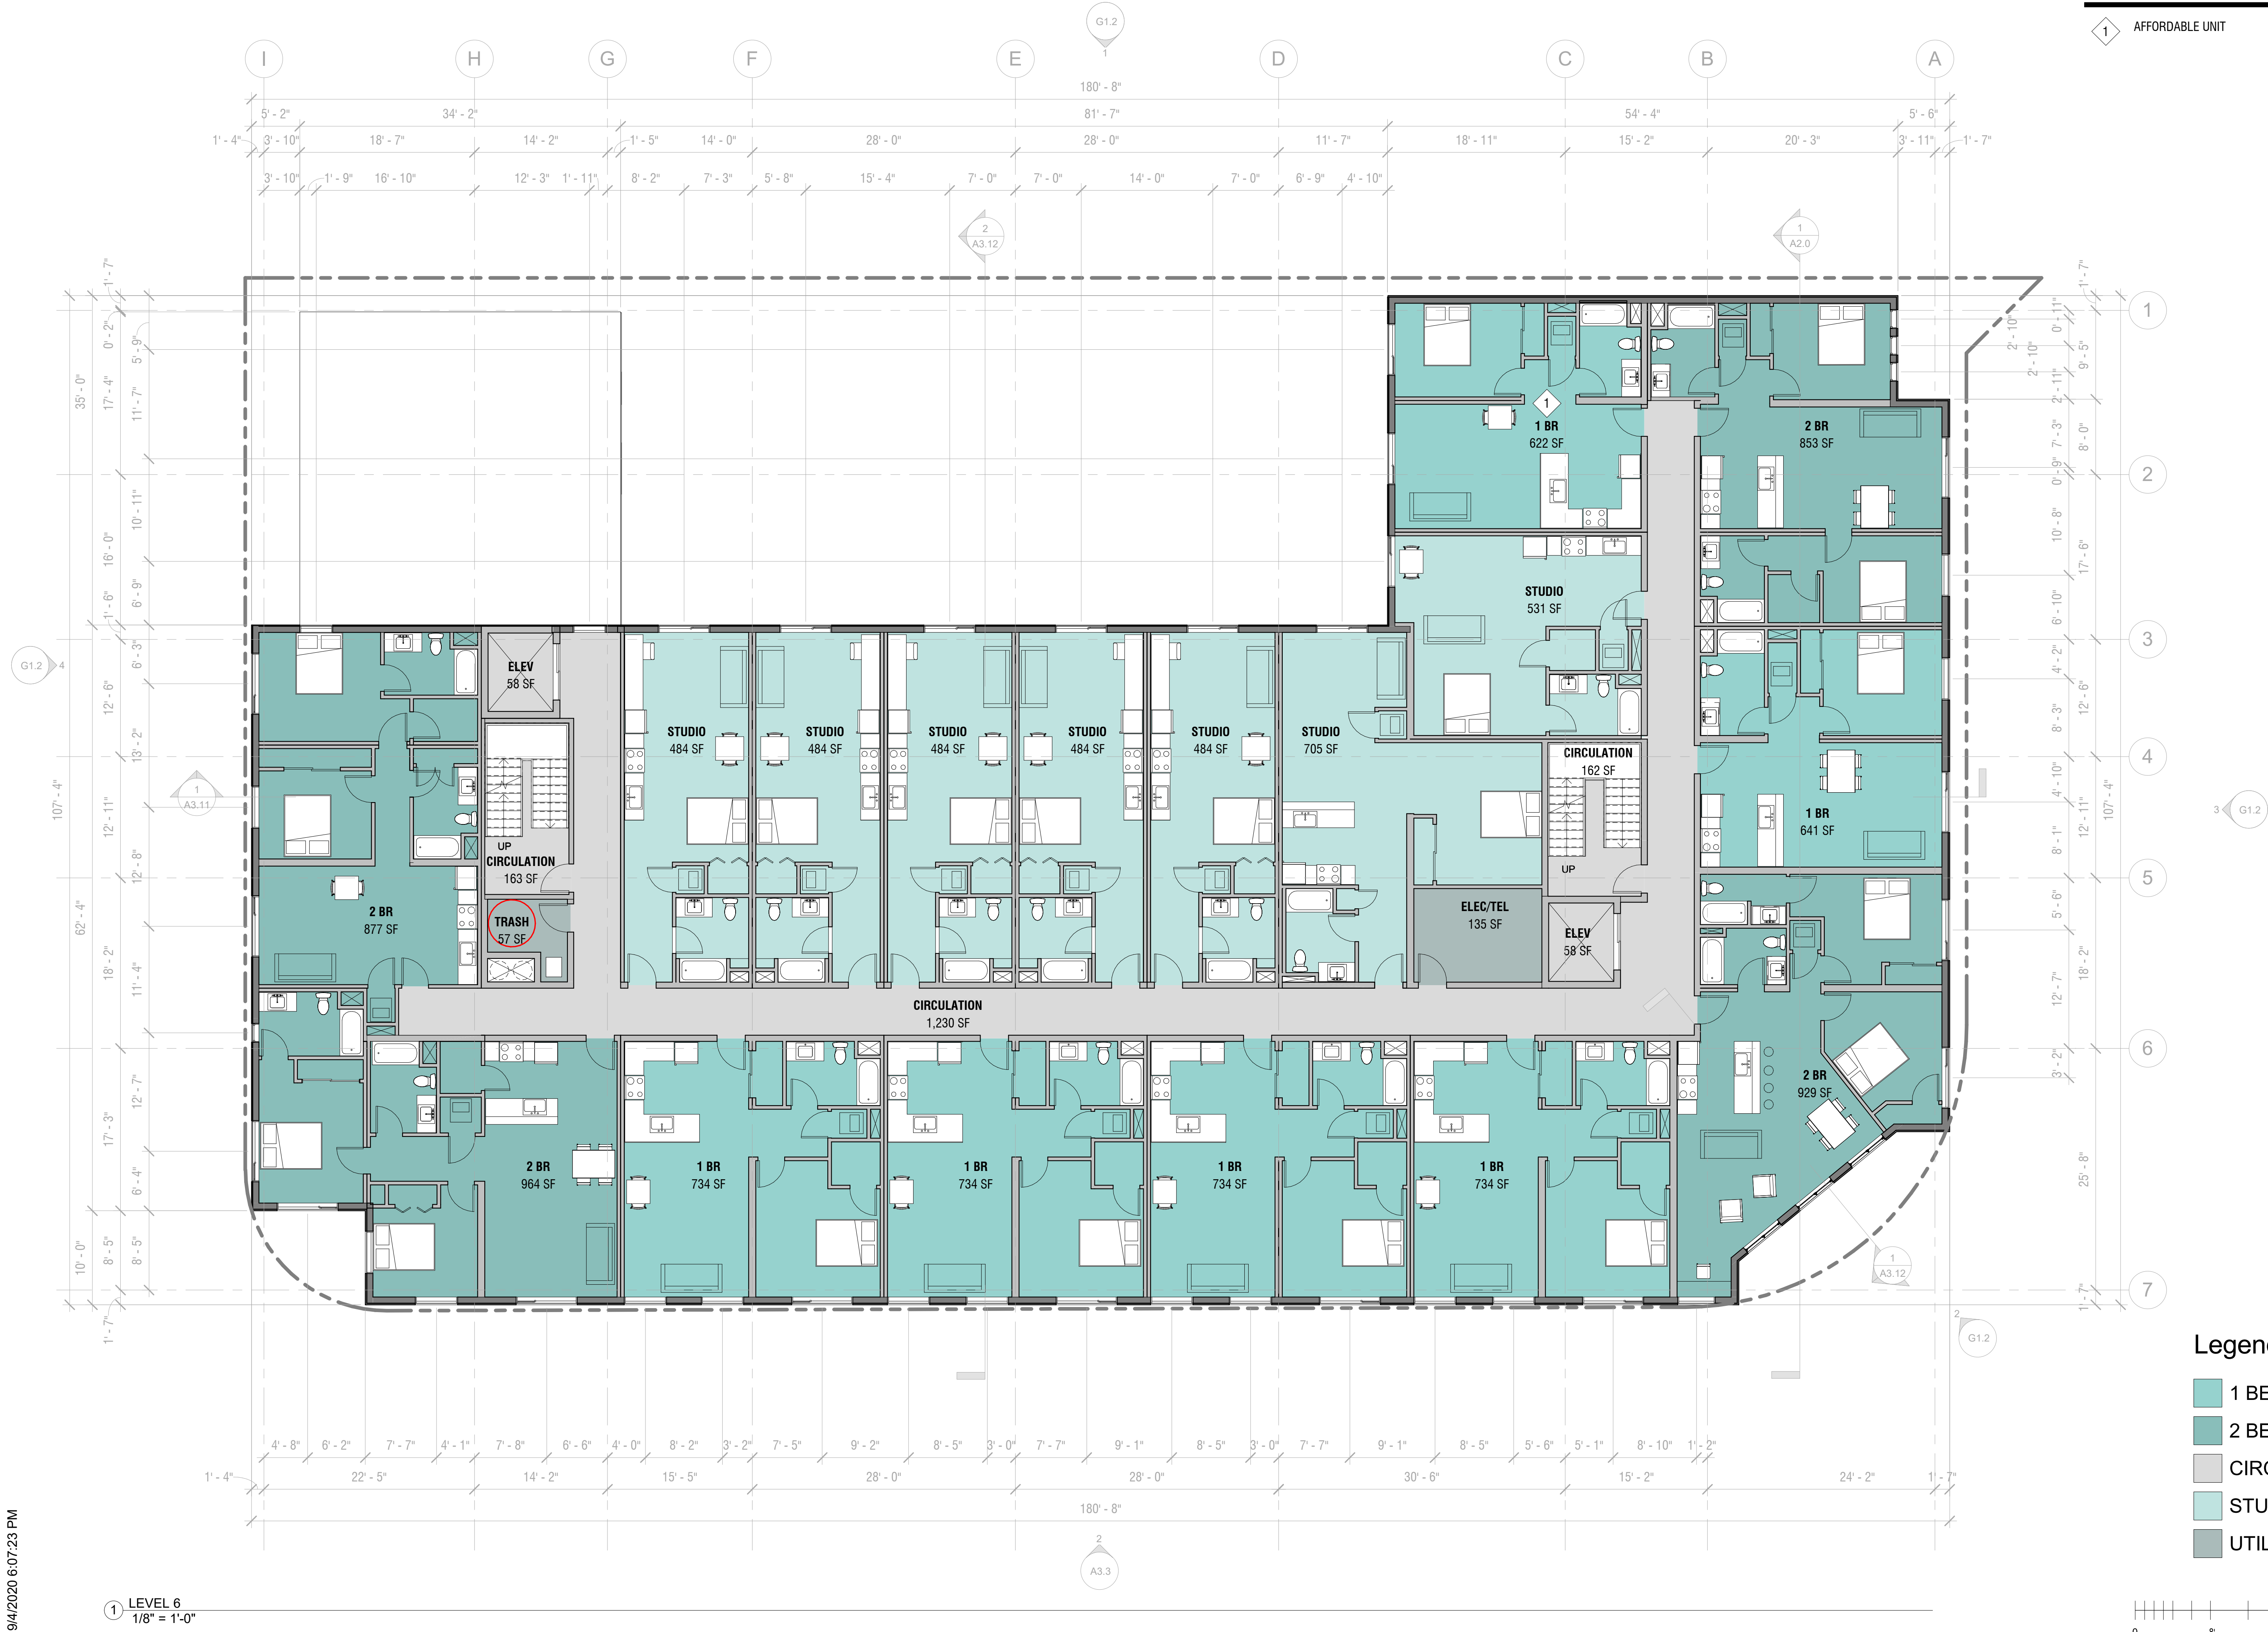

KEY NOTES

1 AFFORDABLE UNIT

lowney
arch

TEL 510.836.5400 URL lowneyarch.com
350 SEVENTEENTH STREET | SUITE 200 | OAKLAND, CALIFORNIA 94612

ONE SANTA ROSA AVE

1 SRA LLC

1 Santa Rosa Ave
Santa Rosa, CA 95404

OWNER

1 SRA LLC
PO Box 8001
Napa, CA 94559
Phone: 415.519.7574

ARCHITECT

LOWNEY ARCHITECTURE
360 17th Street, Suite 200
Oakland, CA 94612
Phone: 510.269.1124

STRUCTURAL

INNOVATIVE STRUCTURAL
ENGINEERING, INC.
40810 County Center Dr Suite
110 Temecula, CA 92591
Phone: 951.226.4355

CIVIL ENGINEERING

BKF ENGINEERS
200 4th Street, Suite 300,
Santa Rosa, CA 95401
Phone: 707.583.8528

MEP

FARD ENGINEERS, INC.
309 Lennon Lane, Suite 200
Walnut Creek, CA 94598
Phone: 925.932.5505


LANDSCAPE ARCHITECT

LOWNEY ARCHITECTURE
360 17th Street, Suite 200
Oakland, CA 94612
Phone: 510.836.5400

STAMP

**NOT FOR
CONSTRUCTION**

#	DATE	ISSUES & REVISIONS	BY
04/14/2020	100% SD	PS	
2	04/17/2020	100% SD UPDATES	PS
05/20/2020	DESIGN REVIEW BOARD	PS	
07/02/2020	REDUCED REVIEW AUTHORITY DESIGN REVIEW	PS	

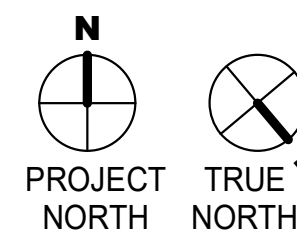

DRAWN BY: SDLP
PROJECT NUMBER: 19-186
SHEET ISSUE DATE: 07/02/20
SHEET TITLE:


LEVEL 6 FLOOR PLAN

SHEET NUMBER

A2.6

ALL DRAWINGS AND WRITTEN MATERIAL APPEARING HEREIN CONSTITUTE ORIGINAL AND UNPUBLISHED WORK OF THE ARCHITECT AND MAY NOT BE DUPLICATED, USED OR DISCLOSED WITHOUT WRITTEN CONSENT OF THE ARCHITECT

9/4/2020 6:07:28 PM

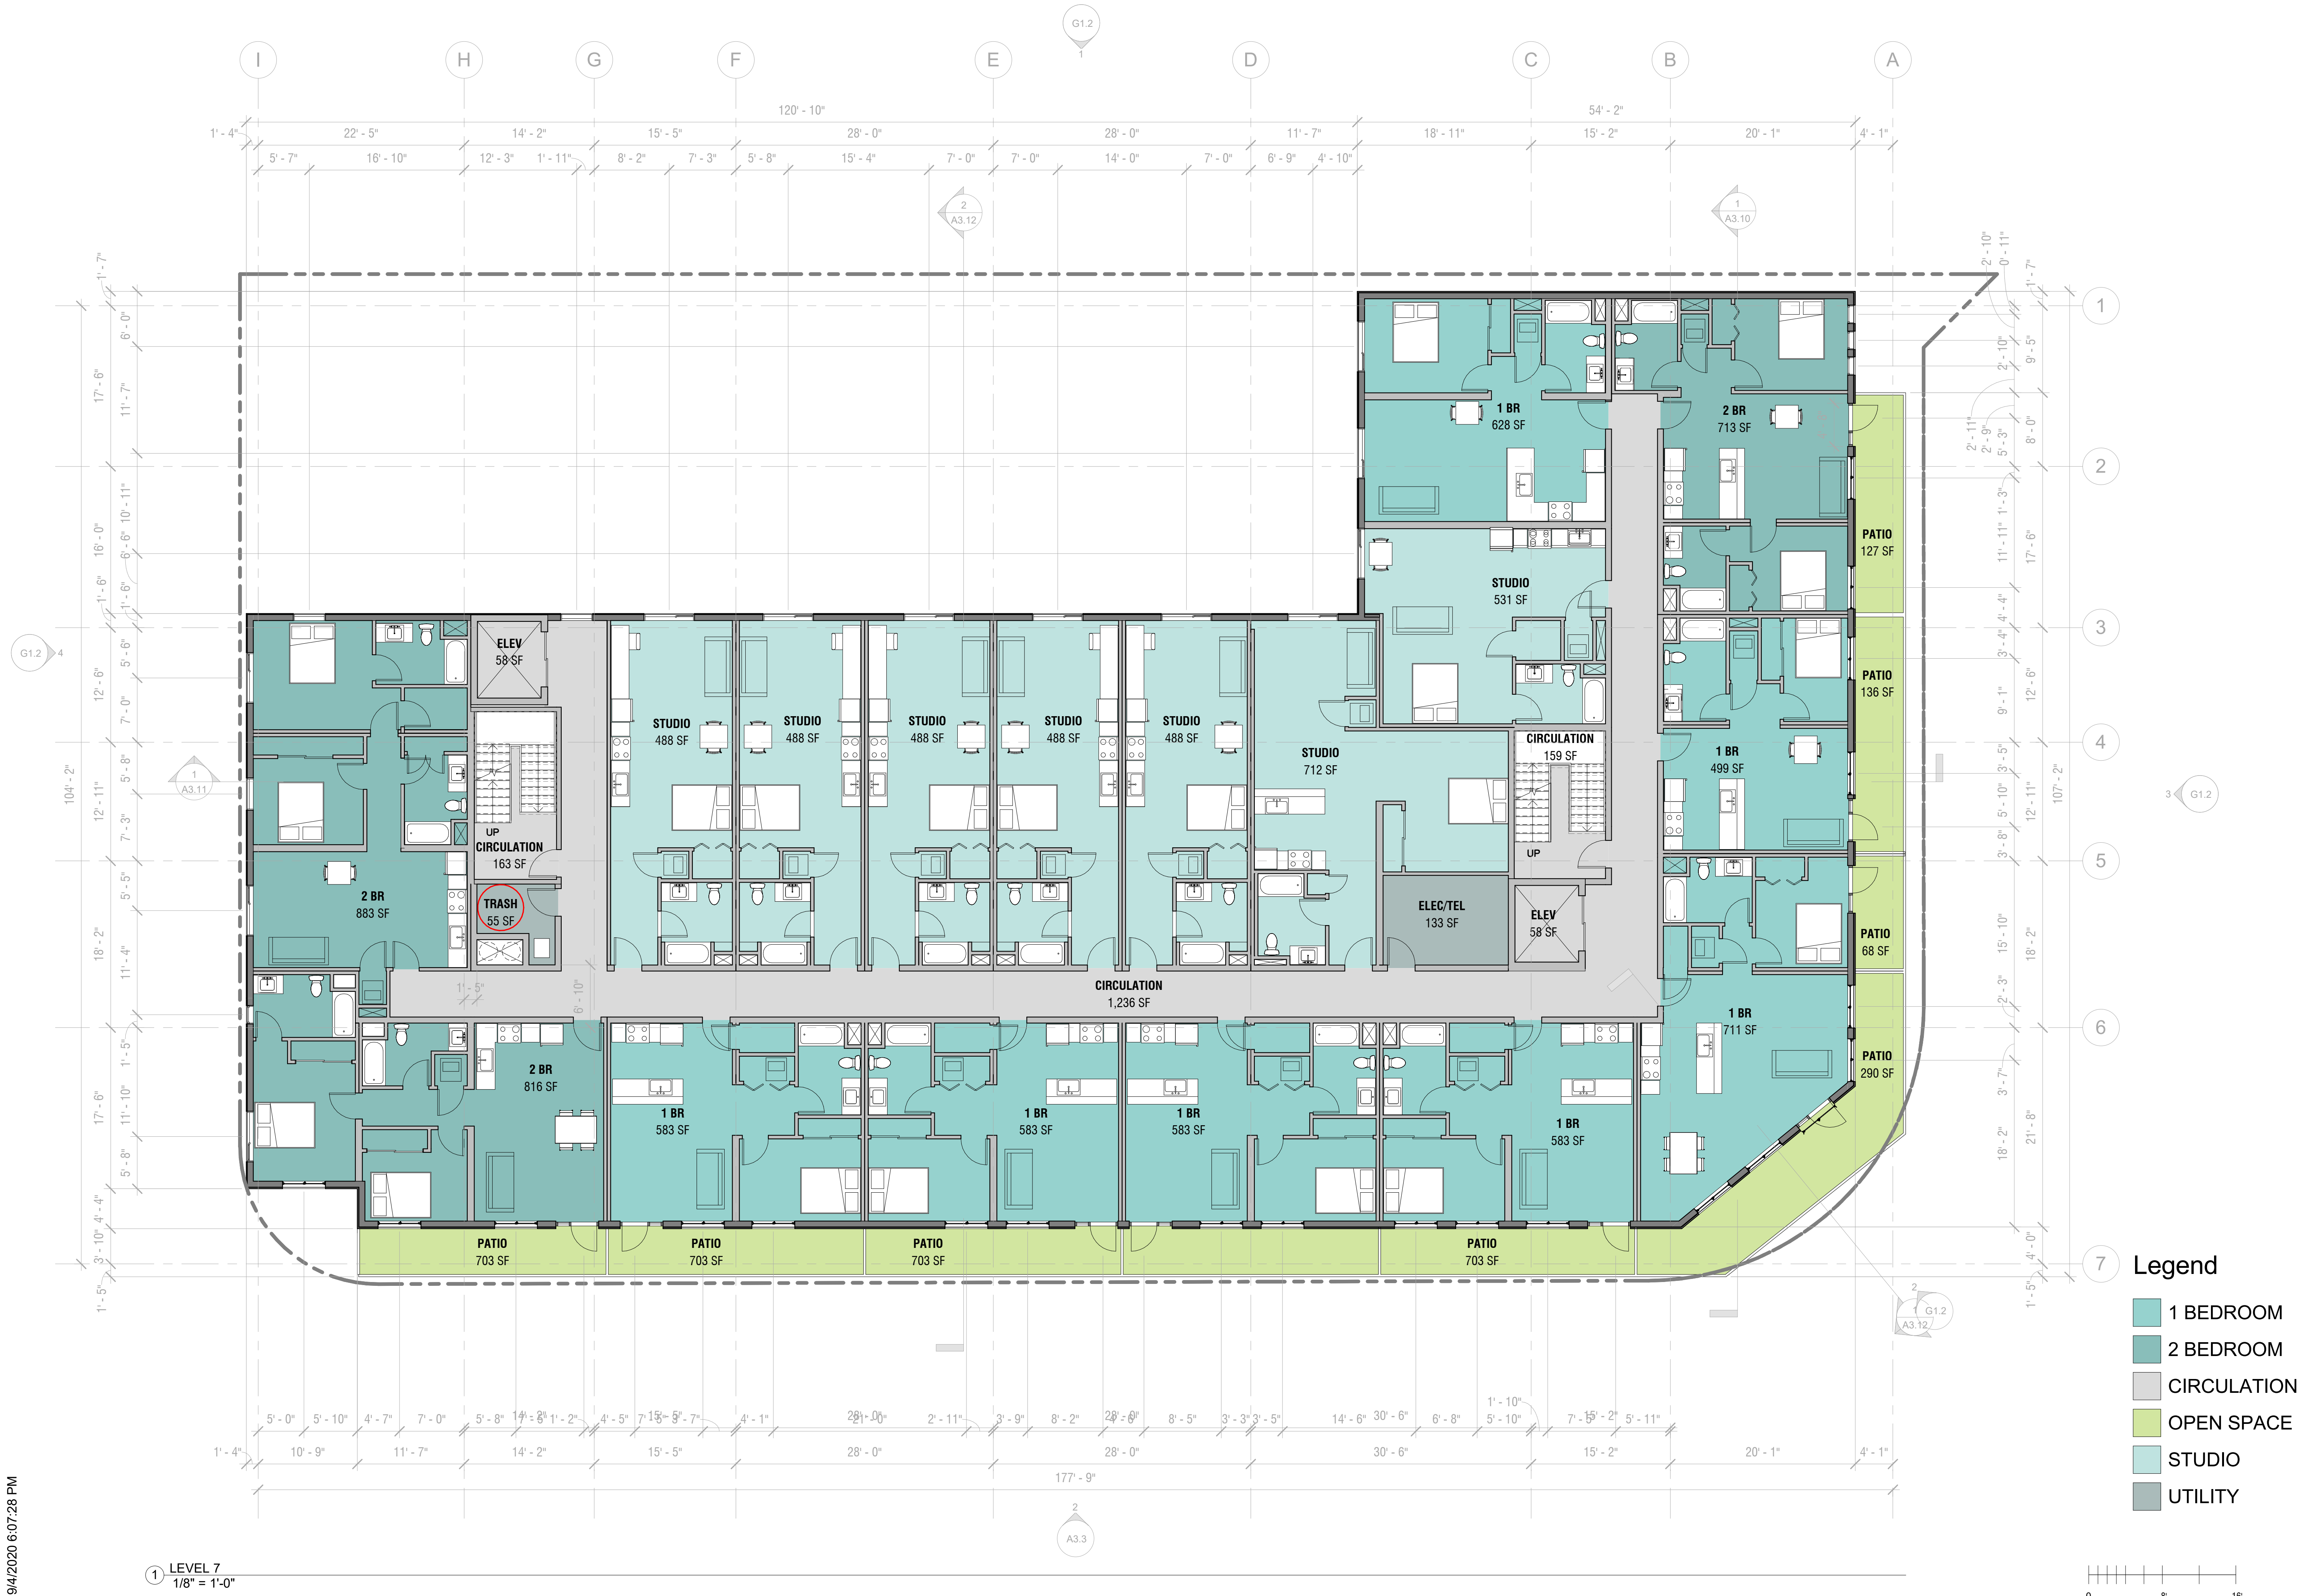

1 LEVEL 7
1/8" = 1'-0"

Legend

- 1 BEDROOM
- 2 BEDROOM
- CIRCULATION
- OPEN SPACE
- STUDIO
- UTILITY

NOT FOR CONSTRUCTION

#	DATE	ISSUES & REVISIONS	BY
1	04/14/202	100% SD	PS
2	04/17/2020	100% SD UPDATES	PS
	05/20/2020	DESIGN REVIEW BOARD	PS
	07/02/2020	REDUCED REVIEW AUTHORITY DESIGN REVIEW	PS

Legend

PROJECT NORTH
TRUE NORTH

DRAWN BY: SDLP
PROJECT NUMBER: 19-186
SHEET ISSUE DATE: 07/02/20
SHEET TITLE:

LEVEL 7 FLOOR PLAN

SHEET NUMBER **A2.7**

ALL DRAWINGS AND WRITTEN MATERIAL APPEARING HEREIN CONSTITUTE ORIGINAL AND UNPUBLISHED WORK OF THE ARCHITECT AND MAY NOT BE DUPLICATED, USED OR DISCLOSED WITHOUT WRITTEN CONSENT OF THE ARCHITECT

lowney arch

TEL 510.836.5400 URL lowneyarch.com
350 SEVENTH STREET | SUITE 200 | OAKLAND, CALIFORNIA 94612

ONE SANTA ROSA AVE
1 SRA LLC
1 Santa Rosa Ave
Santa Rosa, CA 95404

OWNER
1 SRA LLC
PO Box 8001
Napa, CA 94559
Phone: 415.519.7574

ARCHITECT
LOWNEY ARCHITECTURE
360 17th Street, Suite 200
Oakland, CA 94612
Phone: 510.269.1124

STRUCTURAL
INNOVATIVE STRUCTURAL
ENGINEERING, INC.
40810 County Center Dr Suite
110 Temecula, CA 92591
Phone: 951.226.4355


CIVIL ENGINEERING
BFK ENGINEERS
200 4th Street, Suite 300,
Santa Rosa, CA 95401
Phone: 707.583.8528

MEP
FARD ENGINEERS, INC.
309 Lennon Lane, Suite 200
Walnut Creek, CA 94598
Phone: 925.932.5505

LANDSCAPE ARCHITECT
LOWNEY ARCHITECTURE
360 17th Street, Suite 200
Oakland, CA 94612
Phone: 510.836.5400

STAMP

9/4/2020 6:07:29 PM

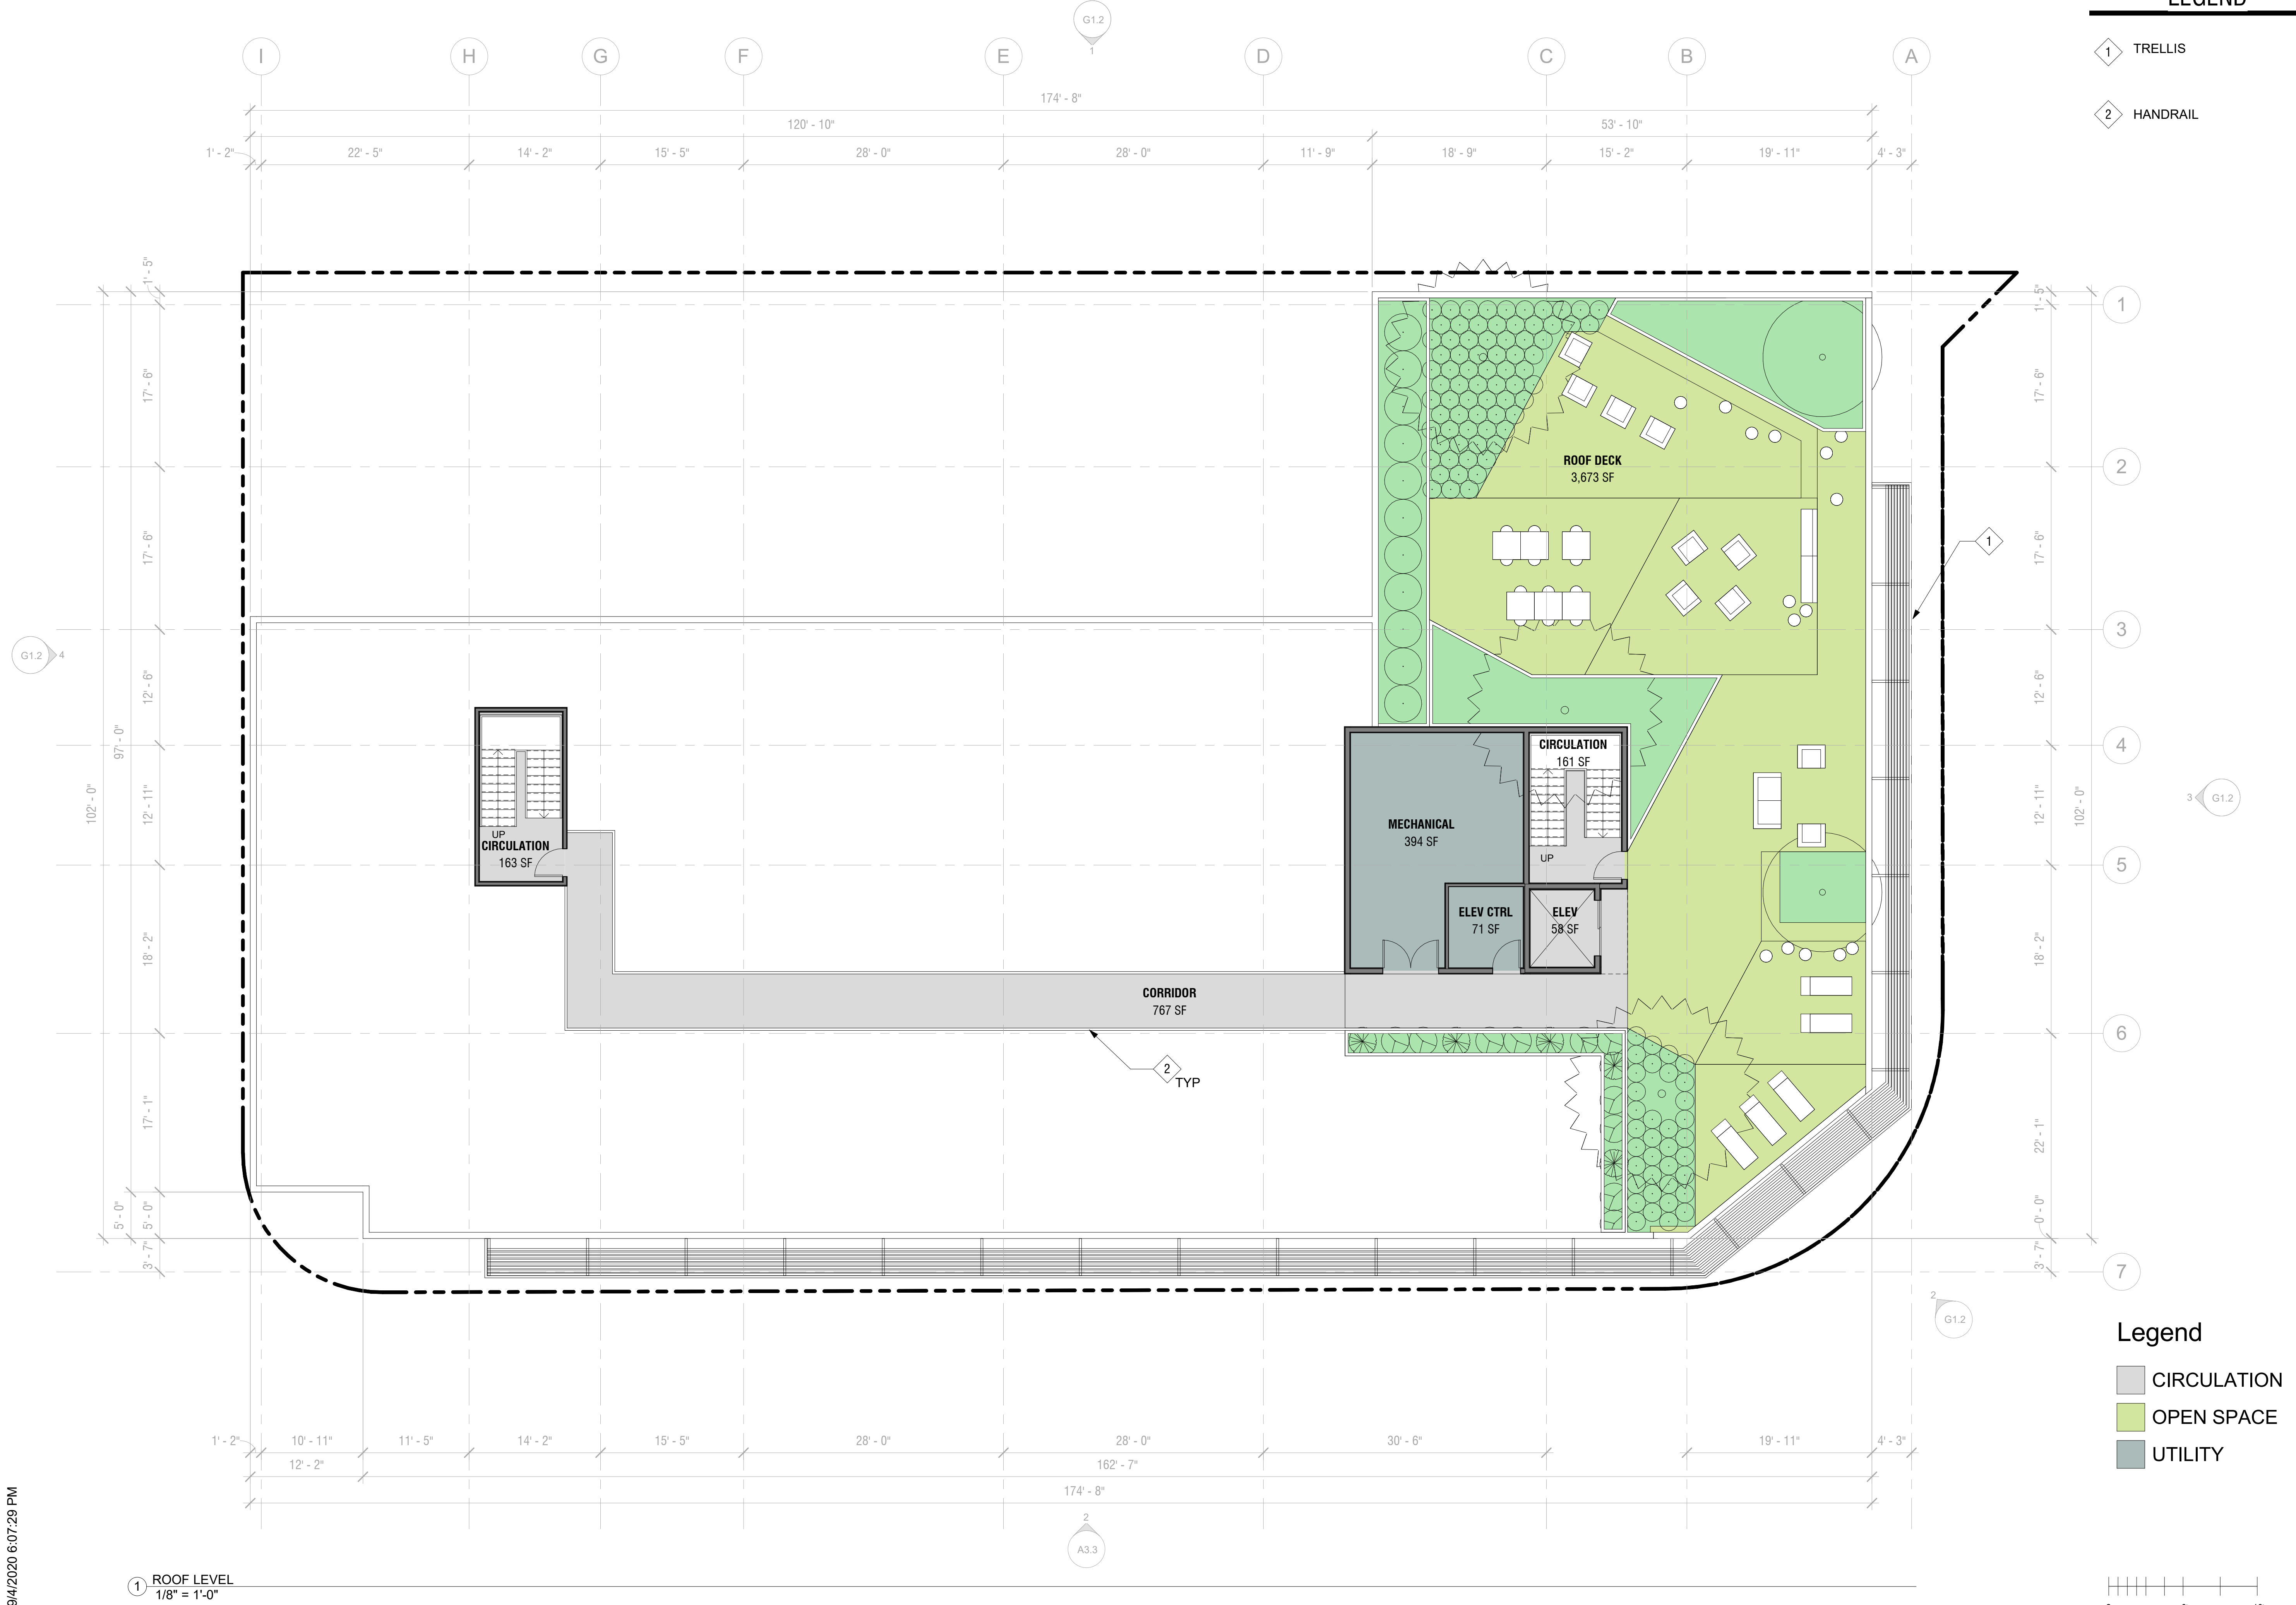

1 ROOF LEVEL
1/8" = 1'-0"

LEGEND

- 1 TRELLIS
2 HANDRAIL

Legend

- CIRCULATION
OPEN SPACE
UTILITY

lowney
arch

TEL 510.836.5400 URL lowneyarch.com
360 SEVENTEENTH STREET | SUITE 200 | OAKLAND, CALIFORNIA 94612

ONE SANTA ROSA AVE

1 SRA LLC

1 Santa Rosa Ave
Santa Rosa, CA 95404

OWNER

1 SRA LLC
PO Box 8001
Napa, CA 94559
Phone: 415.519.7574

ARCHITECT

LOWNEY ARCHITECTURE
360 17th Street, Suite 200
Oakland, CA 94612
Phone: 510.269.1124

STRUCTURAL

INNOVATIVE STRUCTURAL
ENGINEERING, INC.
40810 County Center Dr Suite
110 Temecula, CA 92591
Phone: 951.226.4355

CIVIL ENGINEERING

BFK ENGINEERS
200 4th Street, Suite 300,
Santa Rosa, CA 95401
Phone: 707.583.8528

MEP

FARD ENGINEERS, INC.
309 Lennon Lane, Suite 200
Walnut Creek, CA 94598
Phone: 925.932.5505


LANDSCAPE ARCHITECT

LOWNEY ARCHITECTURE
360 17th Street, Suite 200
Oakland, CA 94612
Phone: 510.836.5400

STAMP

NOT FOR
CONSTRUCTION

#	DATE	ISSUES & REVISIONS	BY
	04/14/202	100% SD	PS
2	04/17/2020	100% SD UPDATES	PS
	05/20/2020	DESIGN REVIEW BOARD	PS
	07/02/2020	REDUCED REVIEW AUTHORITY DESIGN REVIEW	PS

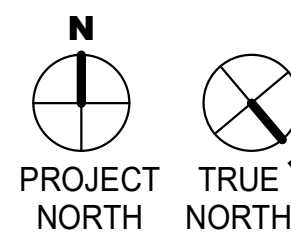

DRAWN BY: SDLP
PROJECT NUMBER: 19-186
SHEET ISSUE DATE: 07/02/20
SHEET TITLE:


ROOF PLAN

SHEET NUMBER


A2.8

ALL DRAWINGS AND WRITTEN MATERIAL APPEARING HEREIN
CONSTITUTE ORIGINAL AND UNPUBLISHED WORK OF THE
ARCHITECT AND MAY NOT BE DUPLICATED, USED OR DISCLOSED
WITHOUT WRITTEN CONSENT OF THE ARCHITECT

9/4/2020 6:07:30 PM

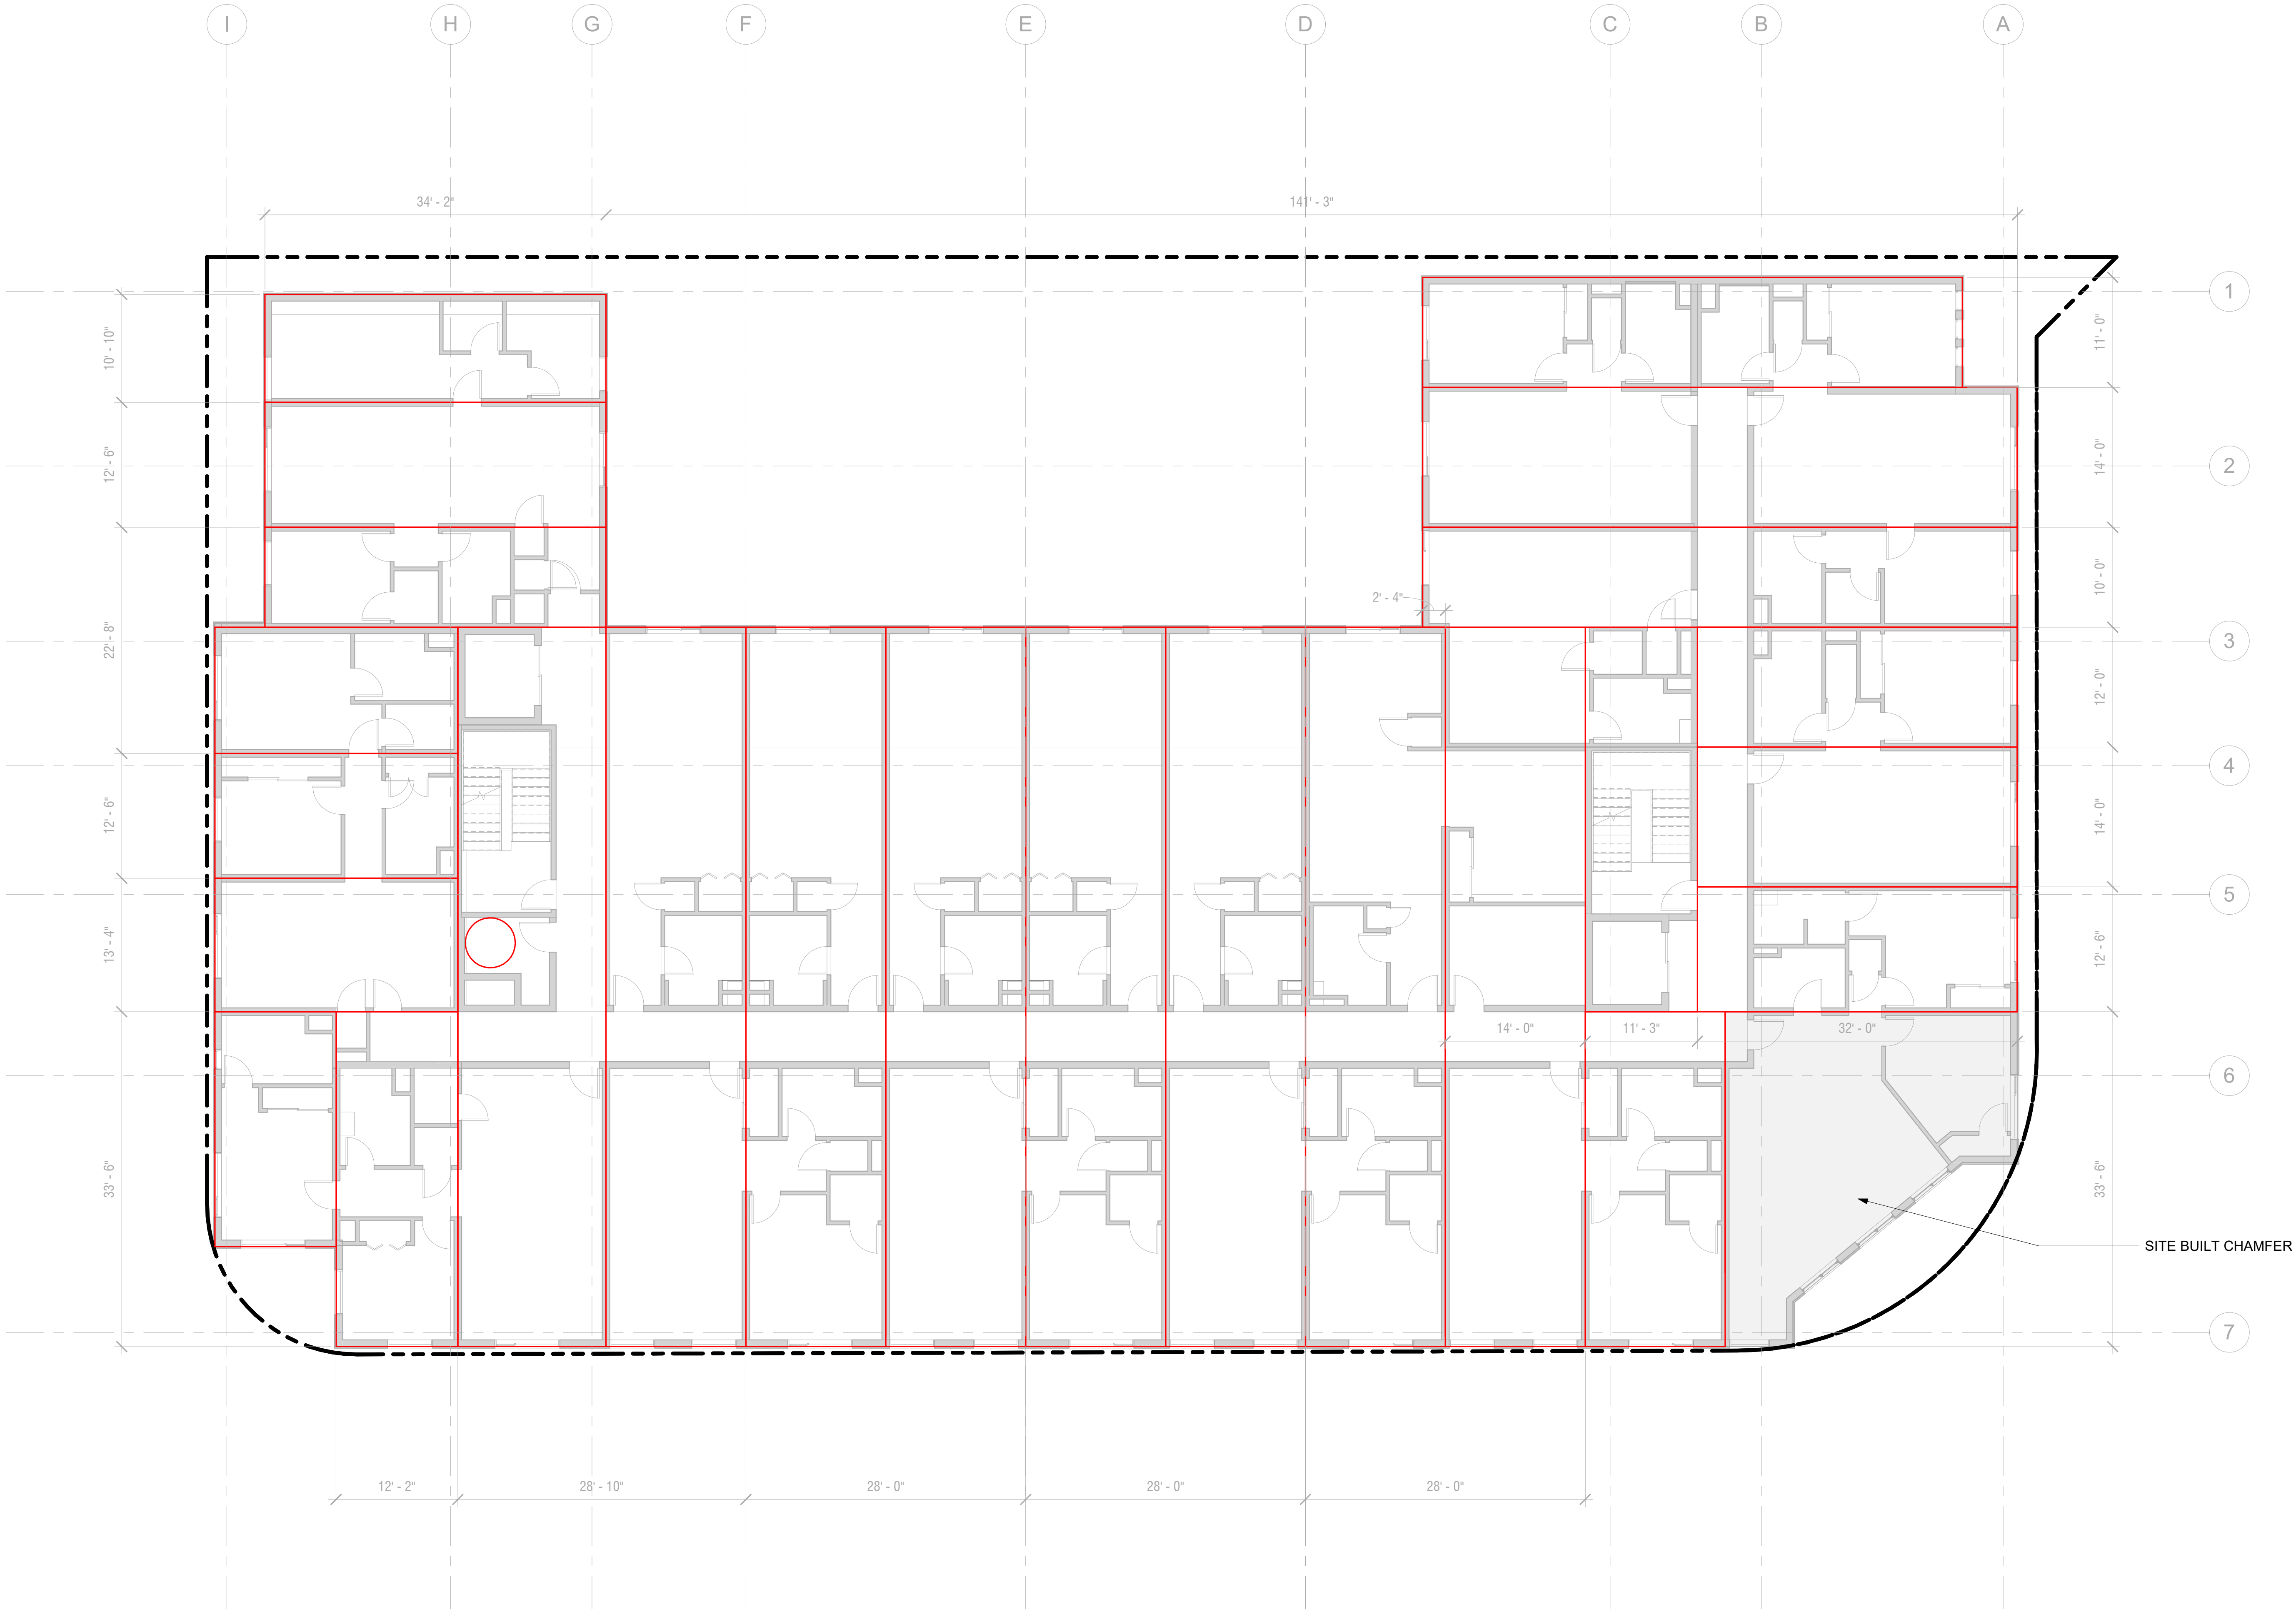

1 MODULES DIAGRAM
1/8" = 1'-0"

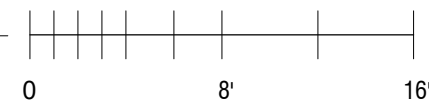

lowney
arch

Tel: 510.836.5400 URL: lowneyarch.com
360 seventeenth street | suite 200 | oakland, california 94612

ONE SANTA
ROSA AVE

1 SRA LLC

1 Santa Rosa Ave
Santa Rosa, CA 95404

OWNER

1 SRA LLC
PO Box 8001
Napa, CA 94559
Phone: 415.519.7574

ARCHITECT

LOWNEY ARCHITECTURE
360 17th Street, Suite 200
Oakland, CA 94612
Phone: 510.269.1124

STRUCTURAL

INNOVATIVE STRUCTURAL
ENGINEERING, INC.
40810 County Center Dr Suite
110 Temecula, CA 92591
Phone: 951.226.4355

CIVIL ENGINEERING

BFK ENGINEERS
200 4th Street, Suite 300,
Santa Rosa, CA 95401
Phone: 707.583.8528

MEP

FARD ENGINEERS, INC.
309 Lennon Lane, Suite 200
Walnut Creek, CA 94598
Phone: 925.932.5505


LANDSCAPE ARCHITECT

LOWNEY ARCHITECTURE
360 17th Street, Suite 200
Oakland, CA 94612
Phone: 510.836.5400

STAMP

NOT FOR
CONSTRUCTION

#	DATE	ISSUES & REVISIONS	BY
	04/14/202	100% SD	PS
2	04/17/2020	100% SD UPDATES	PS
	05/20/2020	DESIGN REVIEW BOARD	PS
	07/02/2020	REDUCED REVIEW AUTHORITY DESIGN REVIEW	PS

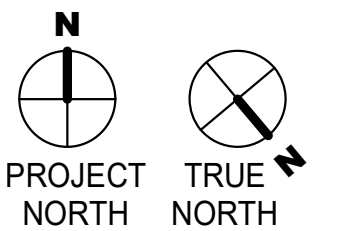

DRAWN BY: SDLP
PROJECT NUMBER: 19-186
SHEET ISSUE DATE: 07/02/20
SHEET TITLE:

MODULES PLAN

SHEET NUMBER

A2.9

ALL DRAWINGS AND WRITTEN MATERIAL APPEARING HEREIN
CONSTITUTE ORIGINAL AND UNPUBLISHED WORK OF THE
ARCHITECT AND MAY NOT BE DUPLICATED, USED OR DISCLOSED
WITHOUT WRITTEN CONSENT OF THE ARCHITECT

1 EXTERIOR ELEVATION - NORTH
1/8" = 1'-0"



MATERIAL LEGEND

- 1 CEMENTITIOUS FACADE SYSTEM - EQUISTONE (NATURA N 074)
- 2 STUCCO, 20/30 SAND FINISH, PAINTED "LIGHT BEIGE", SW 7757-256-C1
- 3 STOREFRONT GLAZING
- 4 1 PANEL PREMIUM WOOD PELLA® ENTRY DOOR
- 5 CEMENTITIOUS FACADE SYSTEM - ASPYRE ARTISAN V-GROOVE
- 6 PRODEMA PRODEX PANEL - NUX
- 7 TRELLIS PT. "HIGH REFLECTIVE WHITE", SW 7757-256-C1
- 8 PER UNIT ENTRANCE
- 9 BEGA 33 514 SCONCE WHITE FINISH, 2 1/8" W X 7 7/8" H X 2 3/8" D
- 10 BEGA 22 343 SCONCE 11" H X 11" W X 5 3/8" D
- 11 BEGA 24 374 SCONCE W/ BRONZE TRIM FINISH. 11 7/8" W X 4 3/8"H 3 3/8" D
- 12 FENCE PER LANDSCAPE DRAWINGS
- 13 BEGA WALL SCONCE 33 816 5 1/8"W X 9 1/8"H X 5 3/8"D
- 14 UV TOLERANT WATERPROOFING INSIDE BLIND-WALL CONDITION AT NEIGHBORING BUILDING
- 15 CEMENTITIOUS FACADE SYSTEM - ASPYRE REVEAL PANEL
- 16 PUBLIC ART INSTALLATION AREA

lowney
arch

Tel 510.836.5400 URL lowneyarch.com
360 seventeenth street | suite 200 | oakland, california 94612

ONE SANTA ROSA AVE

1 SRA LLC

1 Santa Rosa Ave
Santa Rosa, CA 95404

OWNER

1 SRA LLC
PO Box 8001
Napa, CA 94559
Phone: 415.519.7574

ARCHITECT

LOWNEY ARCHITECTURE
360 17th Street, Suite 200
Oakland, CA 94612
Phone: 510.269.1124

STRUCTURAL

INNOVATIVE STRUCTURAL
ENGINEERING, INC.
40810 County Center Dr Suite
110 Temecula, CA 92591
Phone: 951.226.4355

CIVIL ENGINEERING

BFK ENGINEERS
200 4th Street, Suite 300,
Santa Rosa, CA 95401
Phone: 707.583.8528

MEP

FARD ENGINEERS, INC.
309 Lennon Lane, Suite 200
Walnut Creek, CA 94598
Phone: 925.932.5505

LANDSCAPE ARCHITECT

LOWNEY ARCHITECTURE
360 17th Street, Suite 200
Oakland, CA 94612
Phone: 510.836.5400

STAMP

NOT FOR
CONSTRUCTION

#	DATE	ISSUES & REVISIONS	BY
	04/14/202	100% SD	PS
2	04/17/2020	100% SD UPDATES	PS
	05/20/2020	DESIGN REVIEW BOARD	PS
	07/02/2020	REDUCED REVIEW AUTHORITY DESIGN REVIEW	PS


DRAWN BY: SDLP
PROJECT NUMBER: 19-186
SHEET ISSUE DATE: 07/02/20
SHEET TITLE:

EXTERIOR
ELEVATION

SHEET NUMBER

A3.1

ALL DRAWINGS AND WRITTEN MATERIAL APPEARING HEREIN
CONSTITUTE ORIGINAL AND UNPUBLISHED WORK OF THE
ARCHITECT AND MAY NOT BE DUPLICATED, USED OR DISCLOSED
WITHOUT WRITTEN CONSENT OF THE ARCHITECT

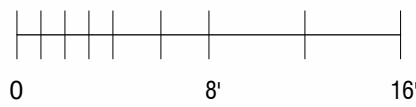

9/4/2020 6:07:34 PM



1 EXTERIOR ELEVATION - EAST
1/8" = 1'-0"

MATERIAL LEGEND

- 1 CEMENTITIOUS FACADE SYSTEM - EQUITONE (NATURA N 074)
- 2 STUCCO, 20/30 SAND FINISH, PAINTED "LIGHT BEIGE", SW 7757-256-C1
- 3 STOREFRONT GLAZING
- 4 1 PANEL PREMIUM WOOD PELLA® ENTRY DOOR
- 5 CEMENTITIOUS FACADE SYSTEM - ASPYRE ARTISAN V-GROOVE
- 6 PRODEMA PRODEX PANEL - NUX
- 7 TRELLIS PT. "HIGH REFLECTIVE WHITE", SW 7757-256-C1
- 8 PER UNIT ENTRANCE BEGA 33 514 SCONCE WHITE FINISH, 2 1/8" W X 7 7/8" H X 2 3/8" D
- 9 BEGA 22 343 SCONCE 11" H X 11" W X 5 3/8" D
- 10 BEGA 24 374 SCONCE W/ BRONZE TRIM FINISH, 11 7/8" W X 4 3/8" H X 3 3/8" D
- 11 FENCE PER LANDSCAPE DRAWINGS
- 12 BEGA WALL SCONCE 33 816 5 1/8"W X 9 1/8"H X 5 3/8"D
- 13 UV TOLERANT WATERPROOFING INSIDE BLIND-WALL CONDITION AT NEIGHBORING BUILDING
- 14 CEMENTITIOUS FACADE SYSTEM - ASPYRE REVEAL PANEL
- 15 PUBLIC ART INSTALLATION AREA

lowney
arch

Tel: 510.836.5400 | URL: lowneyarch.com
350 seveneenth street | suite 200 | oakland, california 94612

ONE SANTA ROSA AVE

1 SRA LLC

1 Santa Rosa Ave
Santa Rosa, CA 95404

OWNER

1 SRA LLC
PO Box 8001
Napa, CA 94559
Phone: 415.519.7574

ARCHITECT

LOWNEY ARCHITECTURE
360 17th Street, Suite 200
Oakland, CA 94612
Phone: 510.269.1124

STRUCTURAL

INNOVATIVE STRUCTURAL
ENGINEERING, INC.
40810 County Center Dr Suite
110 Temecula, CA 92591
Phone: 951.226.4355

CIVIL ENGINEERING

BFK ENGINEERS
200 4th Street, Suite 300,
Santa Rosa, CA 95401
Phone: 707.583.8528

MEP

FARD ENGINEERS, INC.
309 Lennon Lane, Suite 200
Walnut Creek, CA 94598
Phone: 925.932.5505

LANDSCAPE ARCHITECT

LOWNEY ARCHITECTURE
360 17th Street, Suite 200
Oakland, CA 94612
Phone: 510.836.5400

STAMP

**NOT FOR
CONSTRUCTION**

#	DATE	ISSUES & REVISIONS	BY
	04/14/2020	100% SD	PS
2	04/17/2020	100% SD UPDATES	PS
	05/20/2020	DESIGN REVIEW BOARD	PS
	07/02/2020	REDUCED REVIEW AUTHORITY DESIGN REVIEW	PS

DRAWN BY: SDLP
PROJECT NUMBER: 19-186
SHEET ISSUE DATE: 07/02/20
SHEET TITLE:

**EXTERIOR
ELEVATION**

SHEET NUMBER

A3.2

ALL DRAWINGS AND WRITTEN MATERIAL APPEARING HEREIN
CONSTITUTE ORIGINAL AND UNPUBLISHED WORK OF THE
ARCHITECT AND MAY NOT BE DUPLICATED, USED OR DISCLOSED
WITHOUT WRITTEN CONSENT OF THE ARCHITECT

ONE SANTA ROSA AVE

1 SRA LLC

1 Santa Rosa Ave
Santa Rosa, CA 95404

OWNER

1 SRA LLC
PO Box 8001
Napa, CA 94559
Phone: 415.519.7574

ARCHITECT

LOWNEY ARCHITECTURE
360 17th Street, Suite 200
Oakland, CA 94612
Phone: 510.269.1124

STRUCTURAL

INNOVATIVE STRUCTURAL
ENGINEERING, INC.
40810 County Center Dr Suite
110 Temecula, CA 92591
Phone: 951.226.4355

CIVIL ENGINEERING

BFK ENGINEERS
200 4th Street, Suite 300,
Santa Rosa, CA 95401
Phone: 707.583.8528

MEP

FARD ENGINEERS, INC.
309 Lennon Lane, Suite 200
Walnut Creek, CA 94598
Phone: 925.932.5505

LANDSCAPE ARCHITECT

LOWNEY ARCHITECTURE
360 17th Street, Suite 200
Oakland, CA 94612
Phone: 510.836.5400

STAMP

NOT FOR
CONSTRUCTION

#	DATE	ISSUES & REVISIONS	BY
	04/14/202	100% SD	PS
2	04/17/2020	100% SD UPDATES	PS
	05/20/2020	DESIGN REVIEW BOARD	PS
	07/02/2020	REDUCED REVIEW AUTHORITY DESIGN REVIEW	PS

DRAWN BY: SDLP
PROJECT NUMBER: 19-186
SHEET ISSUE DATE: 07/02/20
SHEET TITLE:

EXTERIOR
ELEVATION

SHEET NUMBER

A3.3

ALL DRAWINGS AND WRITTEN MATERIAL APPEARING HEREIN
CONSTITUTE ORIGINAL AND UNPUBLISHED WORK OF THE
ARCHITECT AND MAY NOT BE DUPLICATED, USED OR DISCLOSED
WITHOUT WRITTEN CONSENT OF THE ARCHITECT

MATERIAL LEGEND

- 1

CEMENTITIOUS FACADE SYSTEM -
EQUITONE (NATURA N 074)
- 2

STUCCO, 20/30 SAND FINISH, PAINTED
"LIGHT BEIGE", SW 7757-256-C1
- 3

STOREFRONT GLAZING
- 4

1 PANEL PREMIUM WOOD PELLA®
ENTRY DOOR
- 5

CEMENTITIOUS FACADE SYSTEM - ASPYRE
ARTISAN V-GROOVE
- 6

PRODEMA PRODEX PANEL -
NUX
- 7

TRELLIS PT. "HIGH REFLECTIVE
WHITE", SW 7757-256-C1
- 8

PER UNIT ENTRANCE
BEGA 33 514 SCONCE
WHITE FINISH, 2 1/8" W X 7 7/8" H X 2 3/8" D
- 9

BEGA 22 343
SCONCE 11" H X 11" W X 5 3/8" D
- 10

BEGA 24 374 SCONCE
W/ BRONZE TRIM
FINISH. 11 7/8" W X 4 3/8"H 3 3/8" D
- 11

FENCE PER LANDSCAPE DRAWINGS
- 12

BEGA WALL SCONCE 33 816
5 1/8"W X 9 1/8"H X 5 3/8"D
- 13

UV TOLERANT WATERPROOFING
INSIDE BLIND-WALL
CONDITION AT NEIGHBORING BUILDING
- 14

CEMENTITIOUS FACADE SYSTEM - ASPYRE
REVEAL PANEL
- 15

ROOF LEVEL
PUBLIC ART INSTALLATION AREA

LEVEL 7
64' - 5"

LEVEL 6
53' - 11"


LEVEL 5
43' - 5"

LEVEL 4
32' - 11"

LEVEL 3 PODIUM
22' - 5"

LEVEL 2
12' - 3"

GROUND LEVEL
0' - 6"

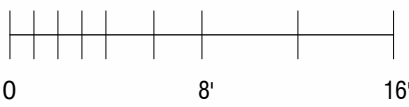

2 EXTERIOR ELEVATION - WEST
1/8" = 1'-0"

9/4/2020 6:07:38 PM

1 EXTERIOR ELEVATION - SOUTH
1/8" = 1'-0"



MATERIAL LEGEND

- 1 CEMENTITIOUS FACADE SYSTEM - EQUISTONE (NATURA N 074)
- 2 STUCCO, 20/30 SAND FINISH, PAINTED "LIGHT BEIGE", SW 7757-256-C1
- 3 STOREFRONT GLAZING
- 4 1 PANEL PREMIUM WOOD PELLA® ENTRY DOOR
- 5 CEMENTITIOUS FACADE SYSTEM - ASPYRE ARTISAN V-GROOVE
- 6 PRODEMA PRODEX PANEL - NUX
- 7 TRELLIS PT. "HIGH REFLECTIVE WHITE", SW 7757-256-C1
- 8 PER UNIT ENTRANCE BEGA 33 514 SCONCE WHITE FINISH, 2 1/8" W X 7 7/8" H X 2 3/8" D
- 9 BEGA 22 343 SCONCE 11" H X 11" W X 5 3/8" D
- 10 BEGA 24 374 SCONCE W/ BRONZE TRIM FINISH. 11 7/8" W X 4 3/8"H 3 3/8" D
- 11 FENCE PER LANDSCAPE DRAWINGS
- 12 BEGA WALL SCONCE 33 816 5 1/8"W X 9 1/8"H X 5 3/8"D
- 13 UV TOLERANT WATERPROOFING INSIDE BLIND-WALL CONDITION AT NEIGHBORING BUILDING
- 14 CEMENTITIOUS FACADE SYSTEM - ASPYRE REVEAL PANEL
- 15 PUBLIC ART INSTALLATION AREA

lowney
arch

TEL 510.836.5400 URL lowneyarch.com
360 seventeenth street | suite 200 | oakland, california 94612

ONE SANTA ROSA AVE

1 SRA LLC

1 Santa Rosa Ave
Santa Rosa, CA 95404

OWNER

1 SRA LLC
PO Box 8001
Napa, CA 94559
Phone: 415.519.7574

ARCHITECT

LOWNEY ARCHITECTURE
360 17th Street, Suite 200
Oakland, CA 94612
Phone: 510.269.1124

STRUCTURAL

INNOVATIVE STRUCTURAL
ENGINEERING, INC.
40810 County Center Dr Suite
110 Temecula, CA 92591
Phone: 951.226.4355

CIVIL ENGINEERING

BFK ENGINEERS
200 4th Street, Suite 300,
Santa Rosa, CA 95401
Phone: 707.583.8528

MEP

FARD ENGINEERS, INC.
309 Lennon Lane, Suite 200
Walnut Creek, CA 94598
Phone: 925.932.5505

LANDSCAPE ARCHITECT

LOWNEY ARCHITECTURE
360 17th Street, Suite 200
Oakland, CA 94612
Phone: 510.836.5400

STAMP

NOT FOR
CONSTRUCTION

#	DATE	ISSUES & REVISIONS	BY
	04/14/202	100% SD	PS
2	04/17/2020	100% SD UPDATES	PS
	05/20/2020	DESIGN REVIEW BOARD	PS
	07/02/2020	REDUCED REVIEW AUTHORITY DESIGN REVIEW	PS


DRAWN BY: SDLP
PROJECT NUMBER: 19-186
SHEET ISSUE DATE: 07/02/20
SHEET TITLE:

EXTERIOR
ELEVATION


SHEET NUMBER

A3.4

ALL DRAWINGS AND WRITTEN MATERIAL APPEARING HEREIN
CONSTITUTE ORIGINAL AND UNPUBLISHED WORK OF THE
ARCHITECT AND MAY NOT BE DUPLICATED, USED OR DISCLOSED
WITHOUT WRITTEN CONSENT OF THE ARCHITECT

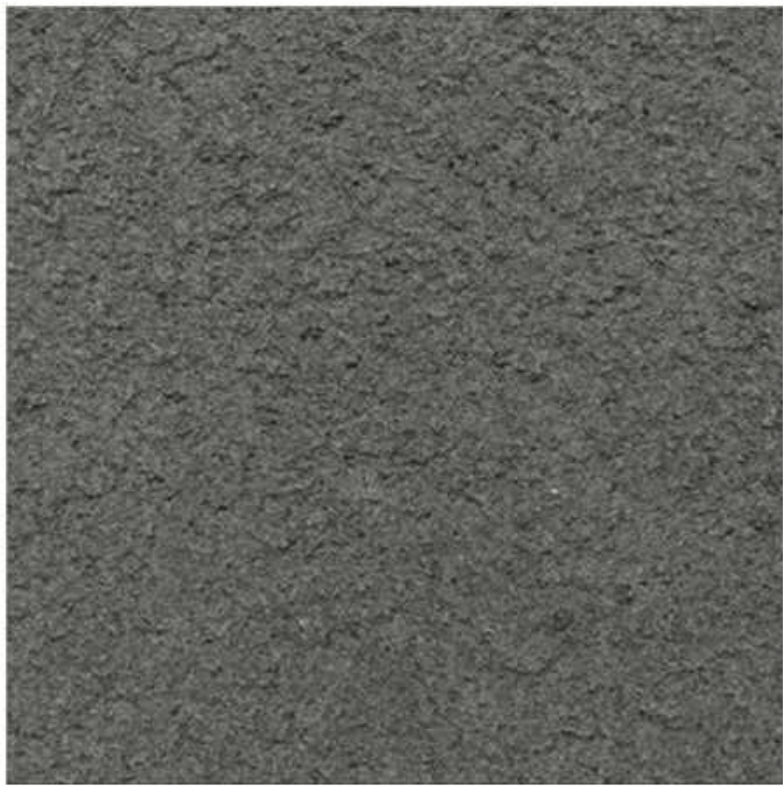

1 CEMENTITIOUS FACADE SYSTEM - EQUITONE (NATURA N 074)

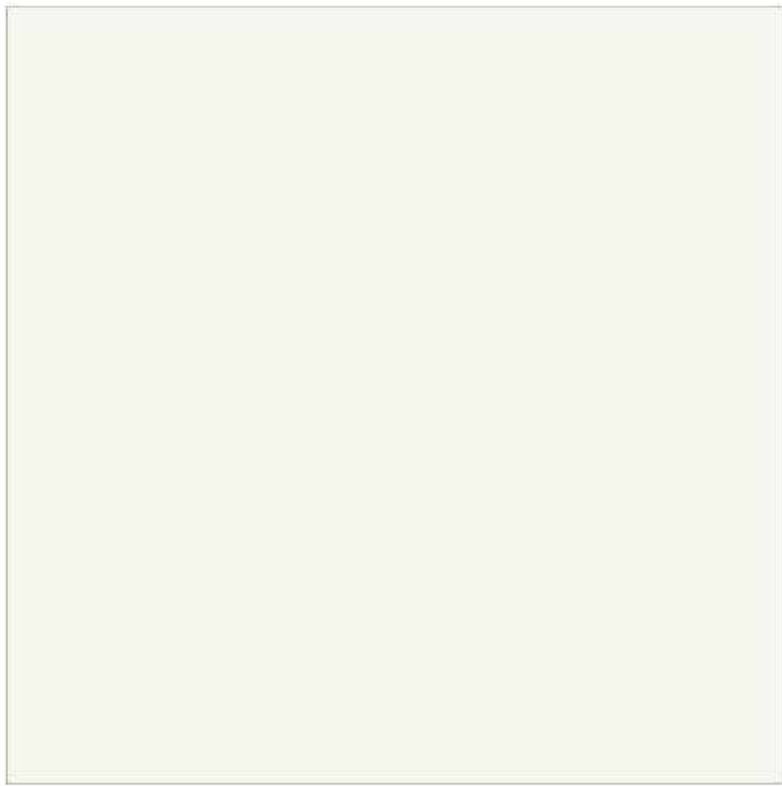


2 STUCCO, 20/30 SAND FINISH, PAINTED "HIGH REFLECTIVE WHITE", SW 7757-256-C1



4 1 PANEL PREMIUM WOOD PELLA® ENTRY DOOR



7 TRELLIS PT. "HIGH REFLECTIVE WHITE", SW 7757-256-C1

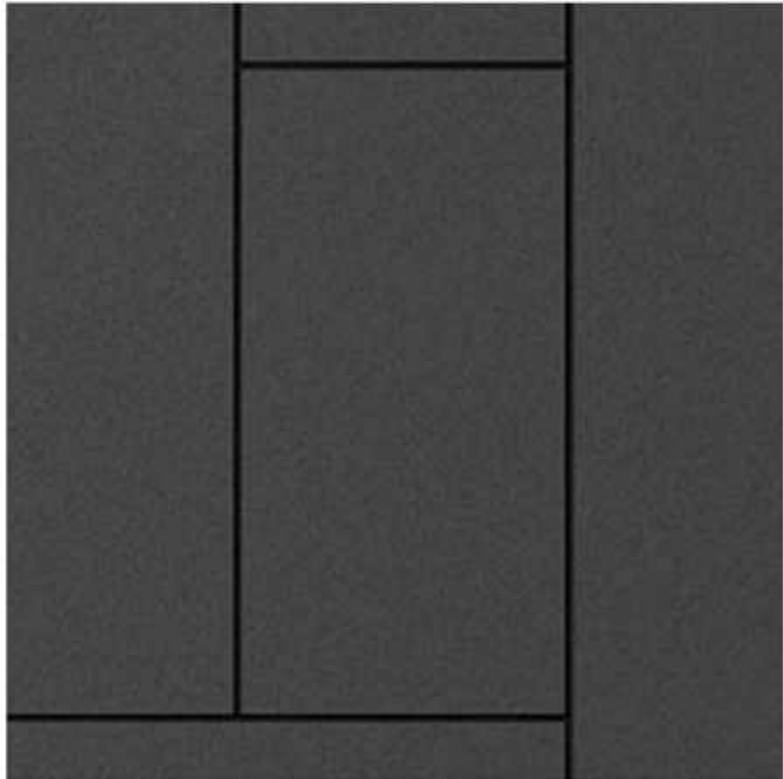

5 CEMENTITIOUS FACADE SYSTEM - ASPYRE ARTISAN V-GROOVE



6 PRODEMA PRODEX PANEL - NUX

MATERIAL LEGEND

- 1

CEMENTITIOUS FACADE SYSTEM - EQUITONE (NATURA N 074)
- 2

STUCCO, 20/30 SAND FINISH, PAINTED "LIGHT BEIGE", SW 7757-256-C1
- 3

STOREFRONT GLAZING
- 4

1 PANEL PREMIUM WOOD PELLA® ENTRY DOOR
- 5

CEMENTITIOUS FACADE SYSTEM - ASPYRE ARTISAN V-GROOVE
- 6

PRODEMA PRODEX PANEL - NUX
- 7

TRELLIS PT. "HIGH REFLECTIVE WHITE", SW 7757-256-C1
- 8

PER UNIT ENTRANCE
BEGA 33 514 SCONCE
WHITE FINISH, 2 1/8" W X 7 7/8" H X 2 3/8" D
- 9

BEGA 22 343
SCONCE 11" H X 11" W X 5 3/8" D
- 10

BEGA 24 374 SCONCE
W/ BRONZE TRIM
FINISH. 11 7/8" W X 4 3/8"H X 3 3/8" D
- 11

FENCE PER LANDSCAPE DRAWINGS
- 12

BEGA WALL SCONCE 33 816
5 1/8"W X 9 1/8"H X 5 3/8"D
- 13

UV TOLERANT WATERPROOFING
INSIDE BLIND-WALL
CONDITION AT NEIGHBORING BUILDING
- 14

CEMENTITIOUS FACADE SYSTEM - ASPYRE REVEAL PANEL
- 15

PUBLIC ART INSTALLATION AREA



Tel 510.836.5400 URL lowneyarch.com
360 seventeenth street | suite 200 | oakland, california 94612

ONE SANTA ROSA AVE

1 SRA LLC

1 Santa Rosa Ave
Santa Rosa, CA 95404

OWNER

1 SRA LLC
PO Box 8001
Napa, CA 94559
Phone: 415.519.7574

ARCHITECT

LOWNEY ARCHITECTURE
360 17th Street, Suite 200
Oakland, CA 94612
Phone: 510.269.1124

STRUCTURAL

INNOVATIVE STRUCTURAL
ENGINEERING, INC.
40810 County Center Dr Suite
110 Temecula, CA 92591
Phone: 951.226.4355

CIVIL ENGINEERING

BFK ENGINEERS
200 4th Street, Suite 300,
Santa Rosa, CA 95401
Phone: 707.583.8528

MEP

FARD ENGINEERS, INC.
309 Lennon Lane, Suite 200
Walnut Creek, CA 94598
Phone: 925.932.5505

LANDSCAPE ARCHITECT

LOWNEY ARCHITECTURE
360 17th Street, Suite 200
Oakland, CA 94612
Phone: 510.836.5400

STAMP

NOT FOR
CONSTRUCTION

#	DATE	ISSUES & REVISIONS	BY
	04/14/202	100% SD	PS
2	04/17/2020	100% SD UPDATES	PS
	05/20/2020	DESIGN REVIEW BOARD	PS
	07/02/2020	REDUCED REVIEW AUTHORITY DESIGN REVIEW	PS

DRAWN BY: SDLP
PROJECT NUMBER: 19-186
SHEET ISSUE DATE: 07/02/20
SHEET TITLE:

MATERIAL BOARD

SHEET NUMBER

A3.5

ALL DRAWINGS AND WRITTEN MATERIAL APPEARING HEREIN
CONSTITUTE ORIGINAL AND UNPUBLISHED WORK OF THE
ARCHITECT AND MAY NOT BE DUPLICATED, USED OR DISCLOSED
WITHOUT WRITTEN CONSENT OF THE ARCHITECT

ONE SANTA
ROSA AVE

1 SRA LLC
1 Santa Rosa Ave
Santa Rosa, CA 95404

OWNER
1 SRA LLC
PO Box 8001
Napa, CA 94559
Phone: 415.519.7574

ARCHITECT
LOWNEY ARCHITECTURE
360 17th Street, Suite 200
Oakland, CA 94612
Phone: 510.269.1124

STRUCTURAL
INNOVATIVE STRUCTURAL
ENGINEERING, INC.
40810 County Center Dr Suite
110 Temecula, CA 92591
Phone: 951.226.4355

CIVIL ENGINEERING
BFK ENGINEERS
200 4th Street, Suite 300,
Santa Rosa, CA 95401
Phone: 707.583.8528

MEP
FARD ENGINEERS, INC.
309 Lennon Lane, Suite 200
Walnut Creek, CA 94598
Phone: 925.932.5505

LANDSCAPE ARCHITECT
LOWNEY ARCHITECTURE
360 17th Street, Suite 200
Oakland, CA 94612
Phone: 510.836.5400

STAMP

NOT FOR
CONSTRUCTION

#	DATE	ISSUES & REVISIONS	BY
	04/14/202	100% SD	PS
2	04/17/2020	100% SD UPDATES	PS
	05/20/2020	DESIGN REVIEW BOARD	PS
	07/02/2020	REDUCED REVIEW AUTHORITY DESIGN REVIEW	PS


DRAWN BY: SDLP
PROJECT NUMBER: 19-186
SHEET ISSUE DATE: 07/02/20
SHEET TITLE:

BUILDING
SECTION

SHEET NUMBER

A3.10

ALL DRAWINGS AND WRITTEN MATERIAL APPEARING HEREIN
CONSTITUTE ORIGINAL AND UNPUBLISHED WORK OF THE
ARCHITECT AND MAY NOT BE DUPLICATED, USED OR DISCLOSED
WITHOUT WRITTEN CONSENT OF THE ARCHITECT

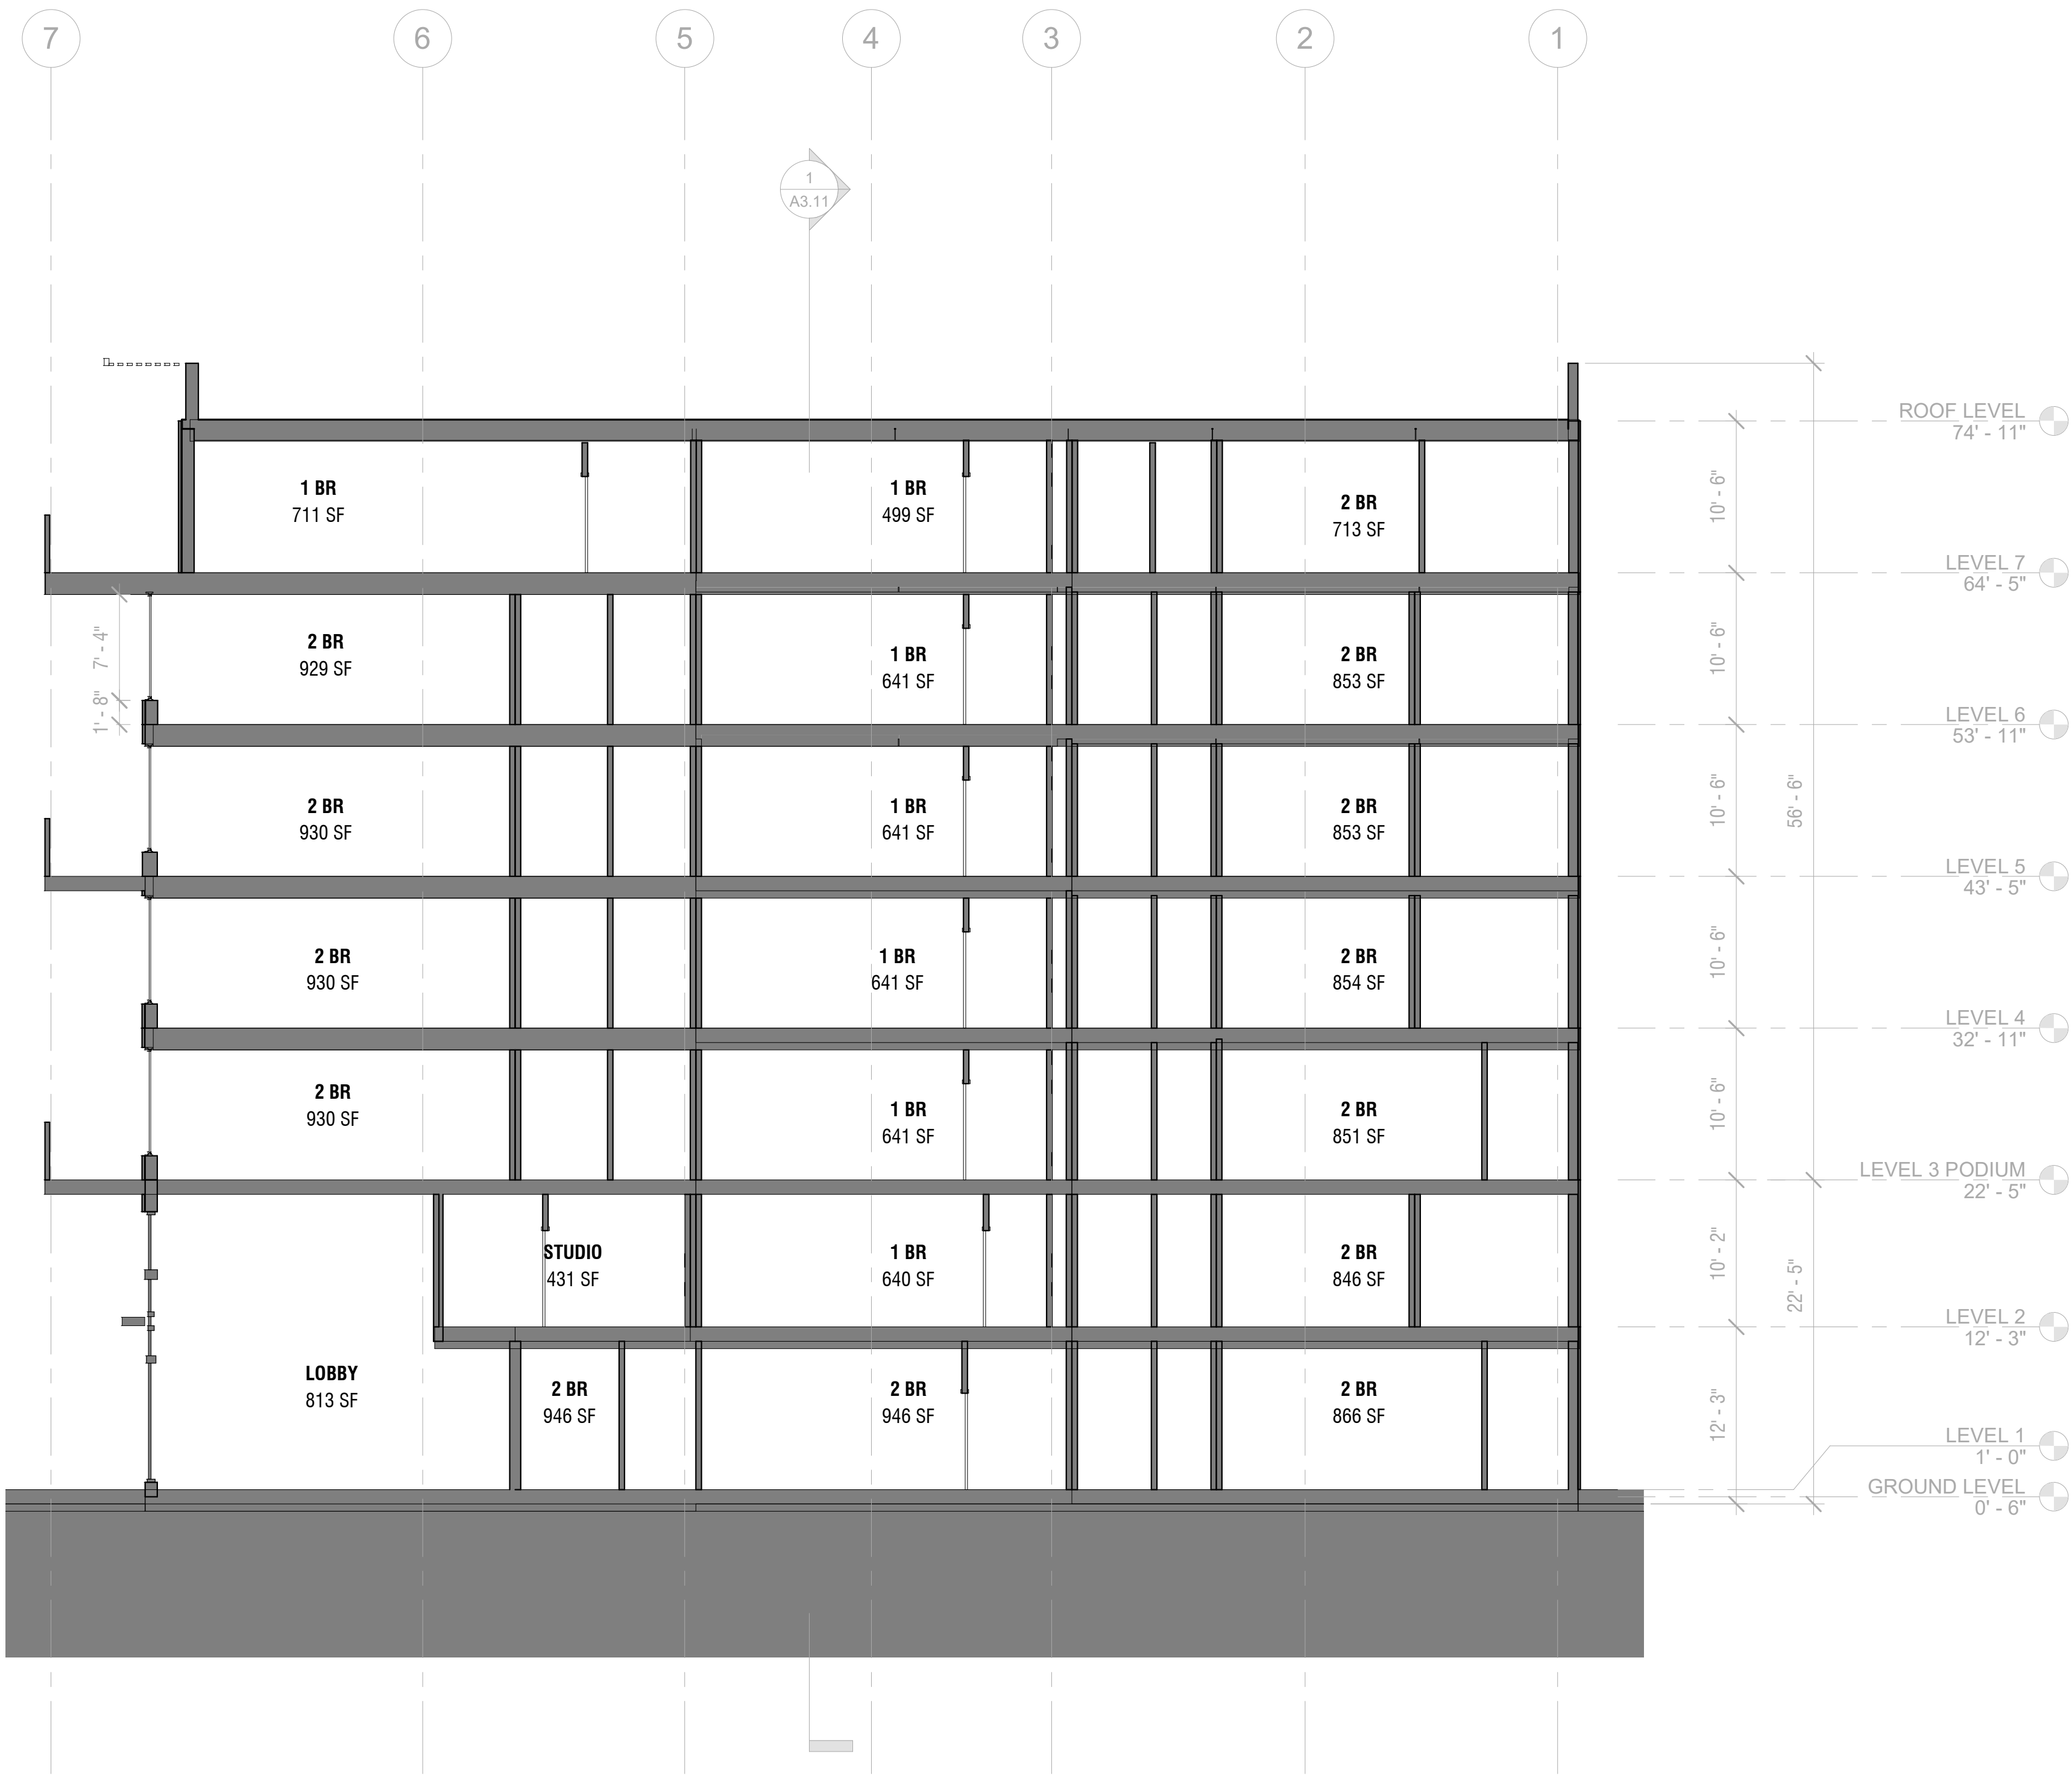

1 CROSS SECTION
1/8" = 1'-0"



ONE SANTA
ROSA AVE

1 SRA LLC
1 Santa Rosa Ave
Santa Rosa, CA 95404

OWNER

1 SRA LLC
PO Box 8001
Napa, CA 94559
Phone: 415.519.7574

ARCHITECT

LOWNEY ARCHITECTURE
360 17th Street, Suite 200
Oakland, CA 94612
Phone: 510.269.1124

STRUCTURAL

INNOVATIVE STRUCTURAL
ENGINEERING, INC.
40810 County Center Dr Suite
110 Temecula, CA 92591
Phone: 951.226.4355

CIVIL ENGINEERING

BFK ENGINEERS
200 4th Street, Suite 300,
Santa Rosa, CA 95401
Phone: 707.583.8528

MEP

FARD ENGINEERS, INC.
309 Lennon Lane, Suite 200
Walnut Creek, CA 94598
Phone: 925.932.5505

LANDSCAPE ARCHITECT

LOWNEY ARCHITECTURE
360 17th Street, Suite 200
Oakland, CA 94612
Phone: 510.836.5400

STAMP

NOT FOR
CONSTRUCTION

#	DATE	ISSUES & REVISIONS	BY
	04/14/202	100% SD	PS
2	04/17/2020	100% SD UPDATES	PS
	05/20/2020	DESIGN REVIEW BOARD	PS
	07/02/2020	REDUCED REVIEW AUTHORITY DESIGN REVIEW	PS


DRAWN BY: SDLP
PROJECT NUMBER: 19-186
SHEET ISSUE DATE: 03/18/2020
SHEET TITLE:

BUILDING
SECTION

SHEET NUMBER

A3.11

ALL DRAWINGS AND WRITTEN MATERIAL APPEARING HEREIN
CONSTITUTE ORIGINAL AND UNPUBLISHED WORK OF THE
ARCHITECT AND MAY NOT BE DUPLICATED, USED OR DISCLOSED
WITHOUT WRITTEN CONSENT OF THE ARCHITECT

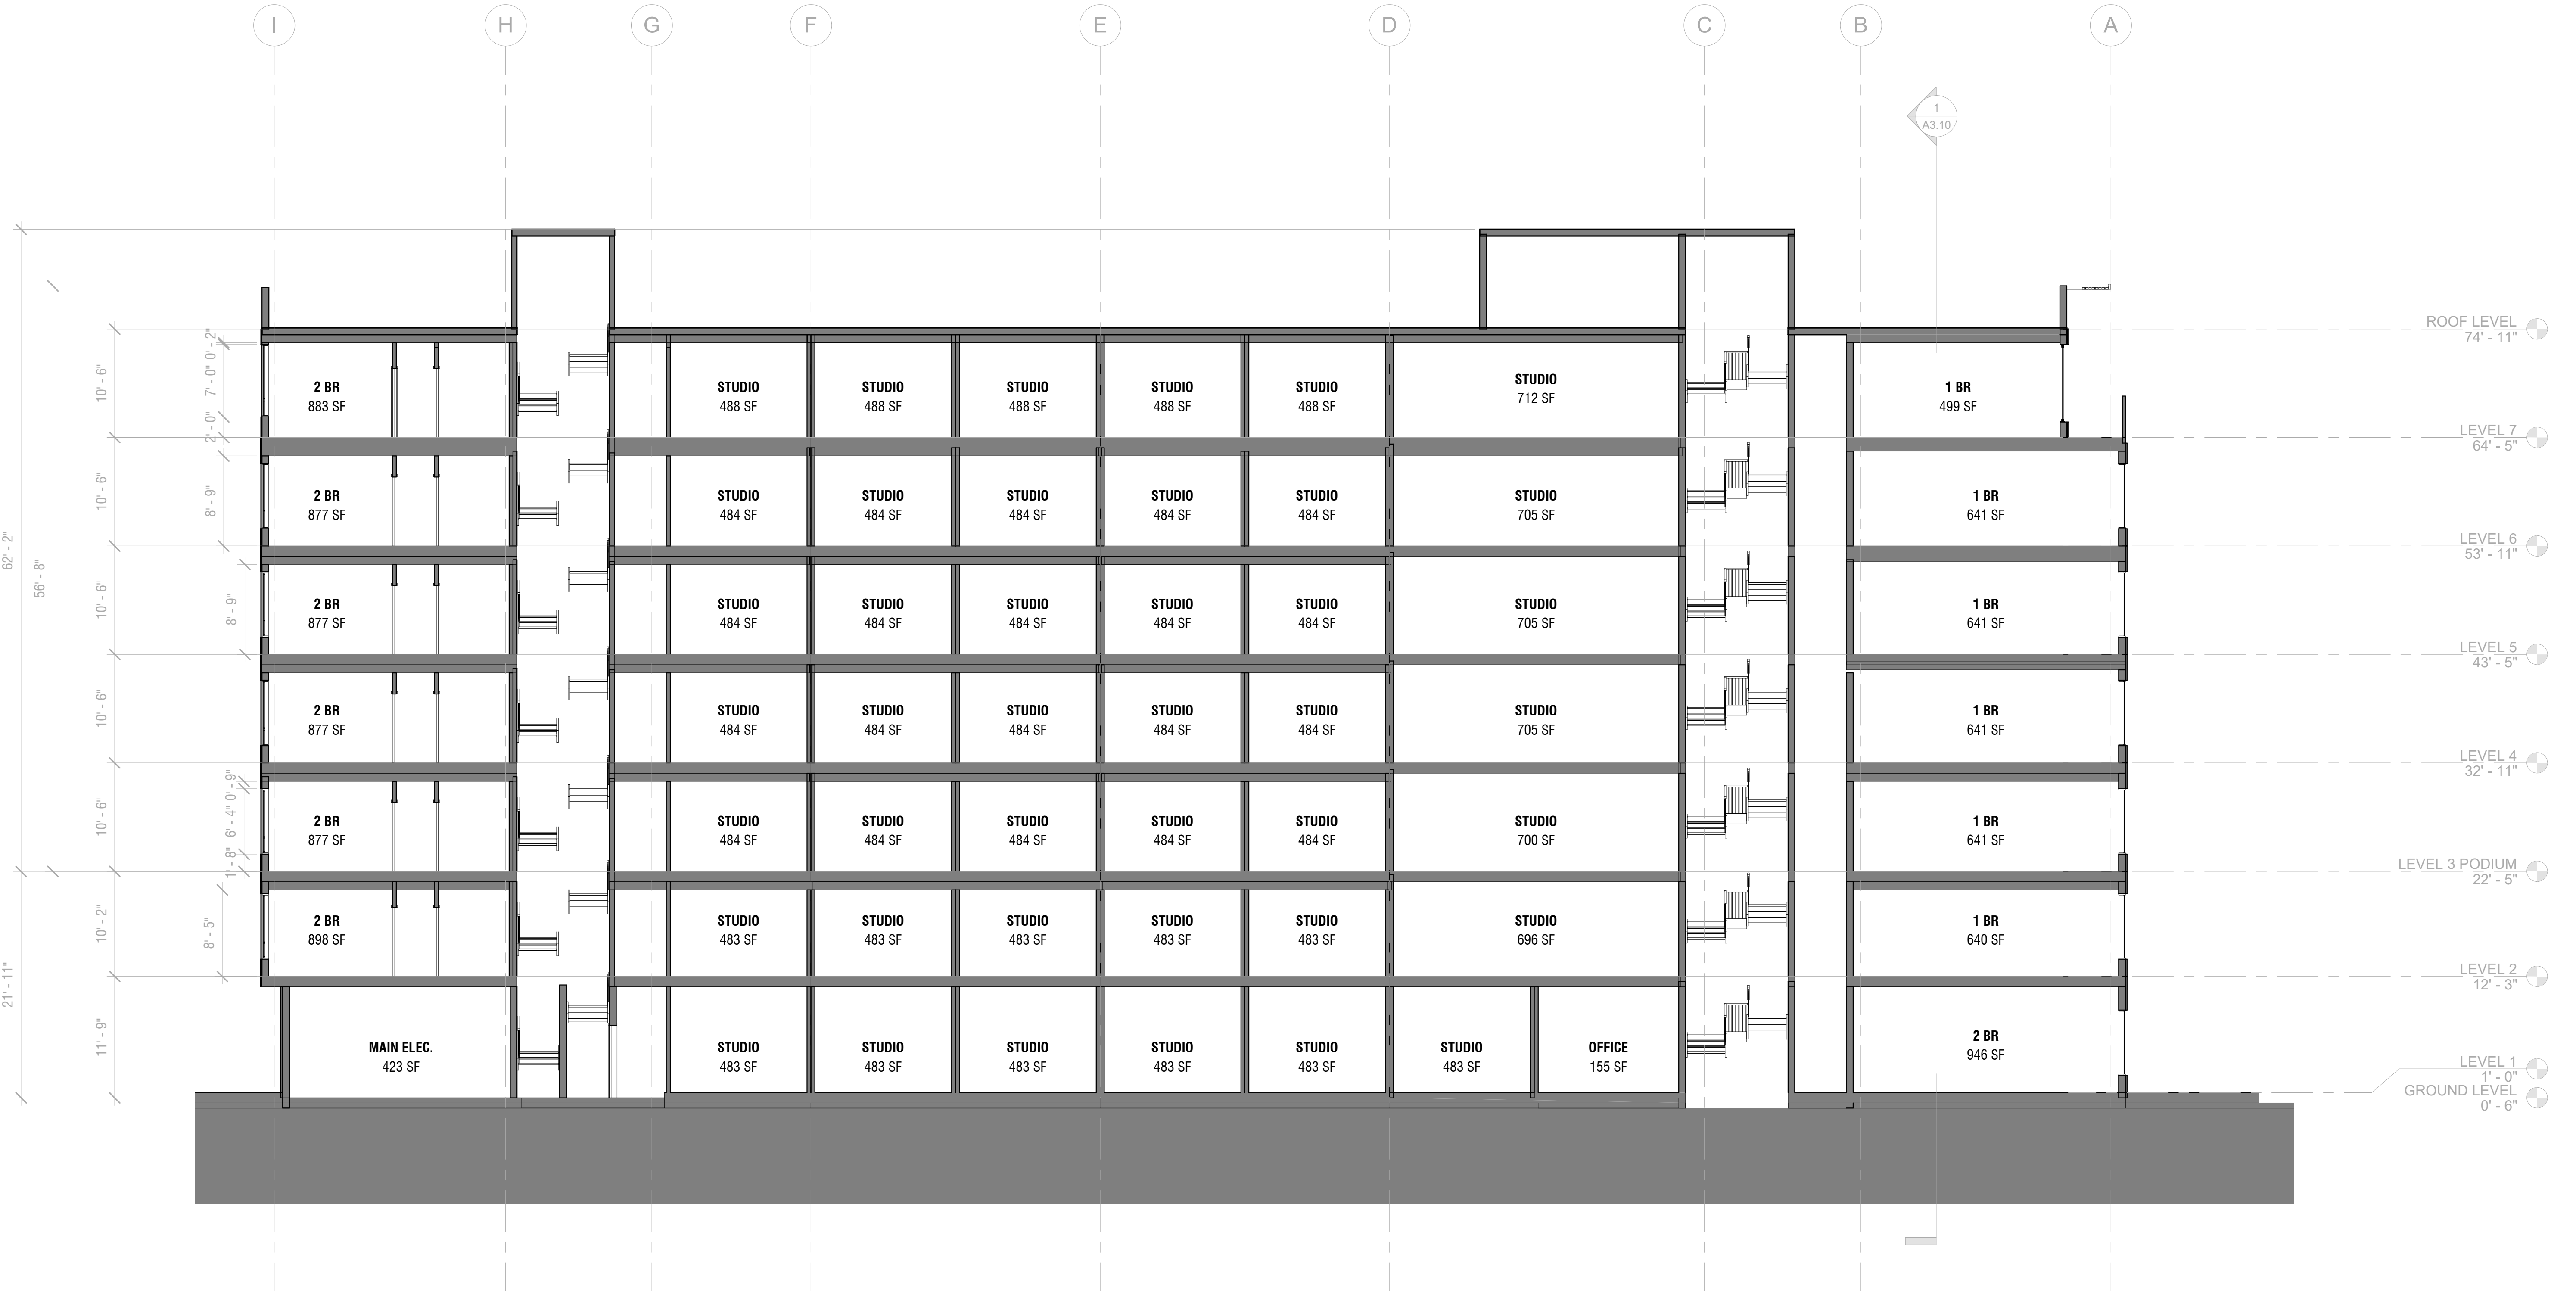

ONE SANTA
ROSA AVE

1 SRA LLC

1 Santa Rosa Ave
Santa Rosa, CA 95404

OWNER

1 SRA LLC
PO Box 8001
Napa, CA 94559
Phone: 415.519.7574

ARCHITECT

LOWNEY ARCHITECTURE
360 17th Street, Suite 200
Oakland, CA 94612
Phone: 510.269.1124

STRUCTURAL

INNOVATIVE STRUCTURAL
ENGINEERING, INC.
40810 County Center Dr Suite
110 Temecula, CA 92591
Phone: 951.226.4355

CIVIL ENGINEERING

BFK ENGINEERS
200 4th Street, Suite 300,
Santa Rosa, CA 95401
Phone: 707.583.8528

MEP

FARD ENGINEERS, INC.
309 Lennon Lane, Suite 200
Walnut Creek, CA 94598
Phone: 925.932.5505


LANDSCAPE ARCHITECT

LOWNEY ARCHITECTURE
360 17th Street, Suite 200
Oakland, CA 94612
Phone: 510.836.5400

STAMP

NOT FOR
CONSTRUCTION

#	DATE	ISSUES & REVISIONS	BY
	04/14/202	100% SD	PS
2	04/17/2020	100% SD UPDATES	PS
	05/20/2020	DESIGN REVIEW BOARD	PS
	07/02/2020	REDUCED REVIEW AUTHORITY DESIGN REVIEW	PS

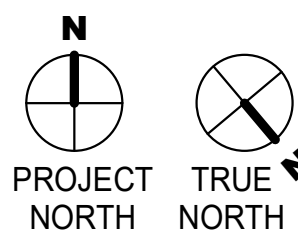


DRAWN BY: Author
PROJECT NUMBER: 19-186
SHEET ISSUE DATE: 04/06/20
SHEET TITLE:

BUILDING
SECTION


SHEET NUMBER

A3.12


ALL DRAWINGS AND WRITTEN MATERIAL APPEARING HEREIN
CONSTITUTE ORIGINAL AND UNPUBLISHED WORK OF THE
ARCHITECT AND MAY NOT BE DUPLICATED, USED OR DISCLOSED
WITHOUT WRITTEN CONSENT OF THE ARCHITECT

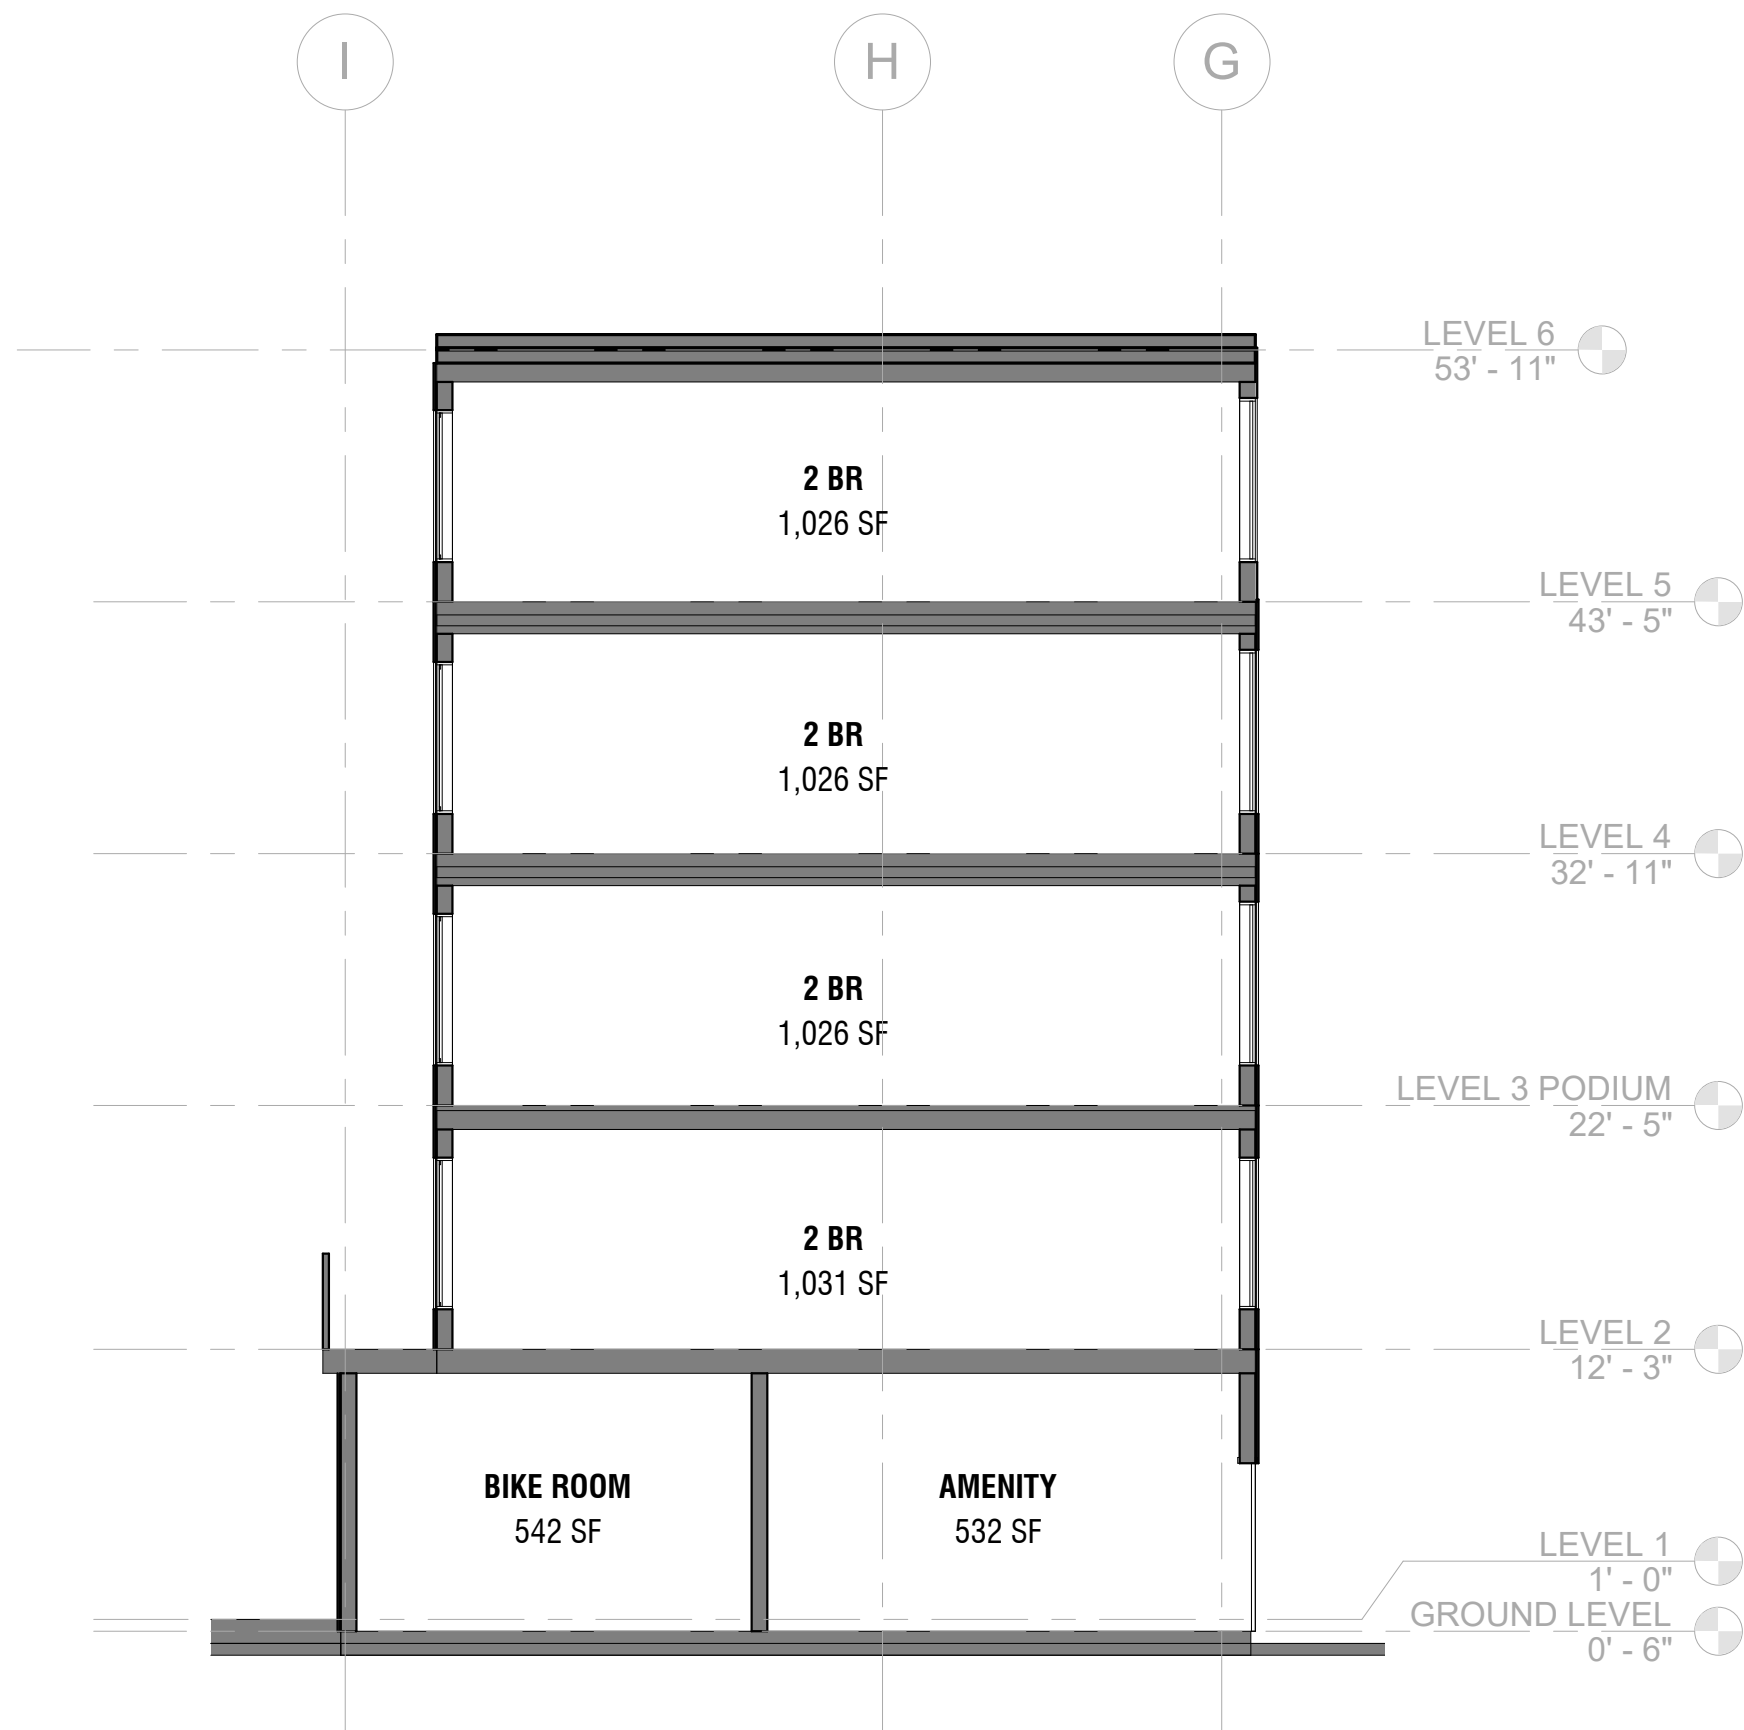

③ AMENITY SECTION
1/8" = 1'-0"

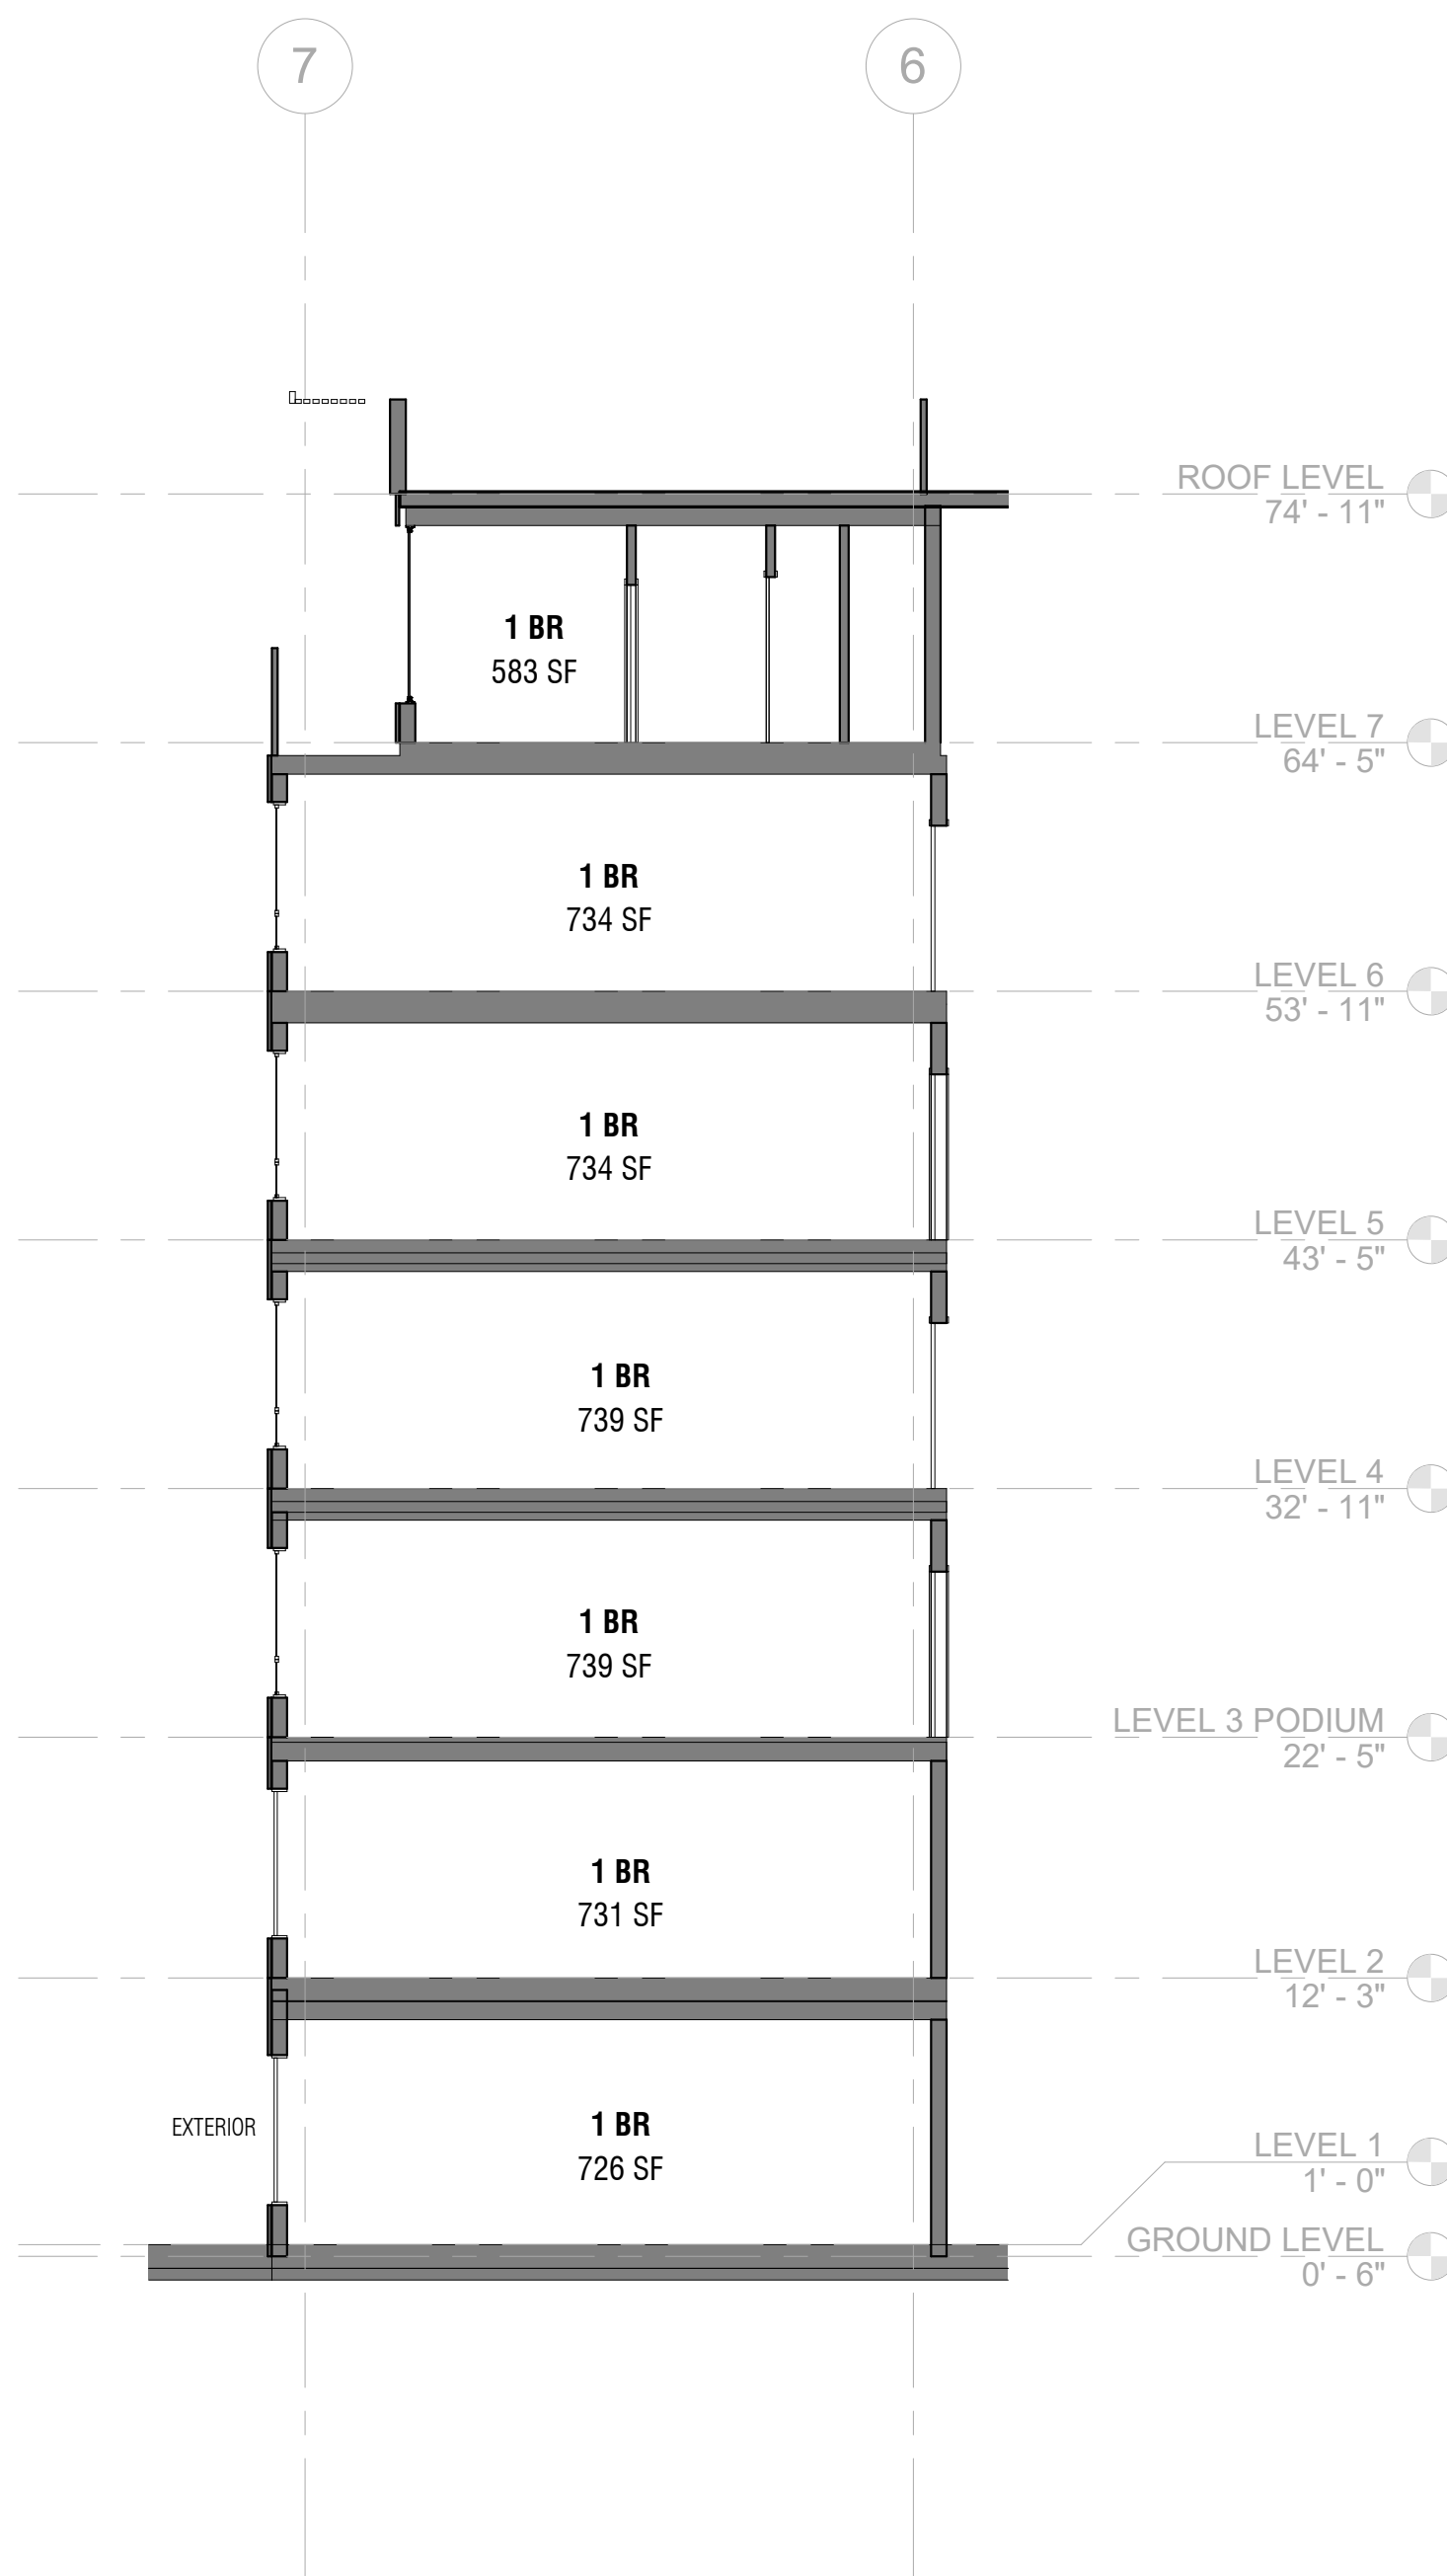

② STOOP SECTION
1/8" = 1'-0"

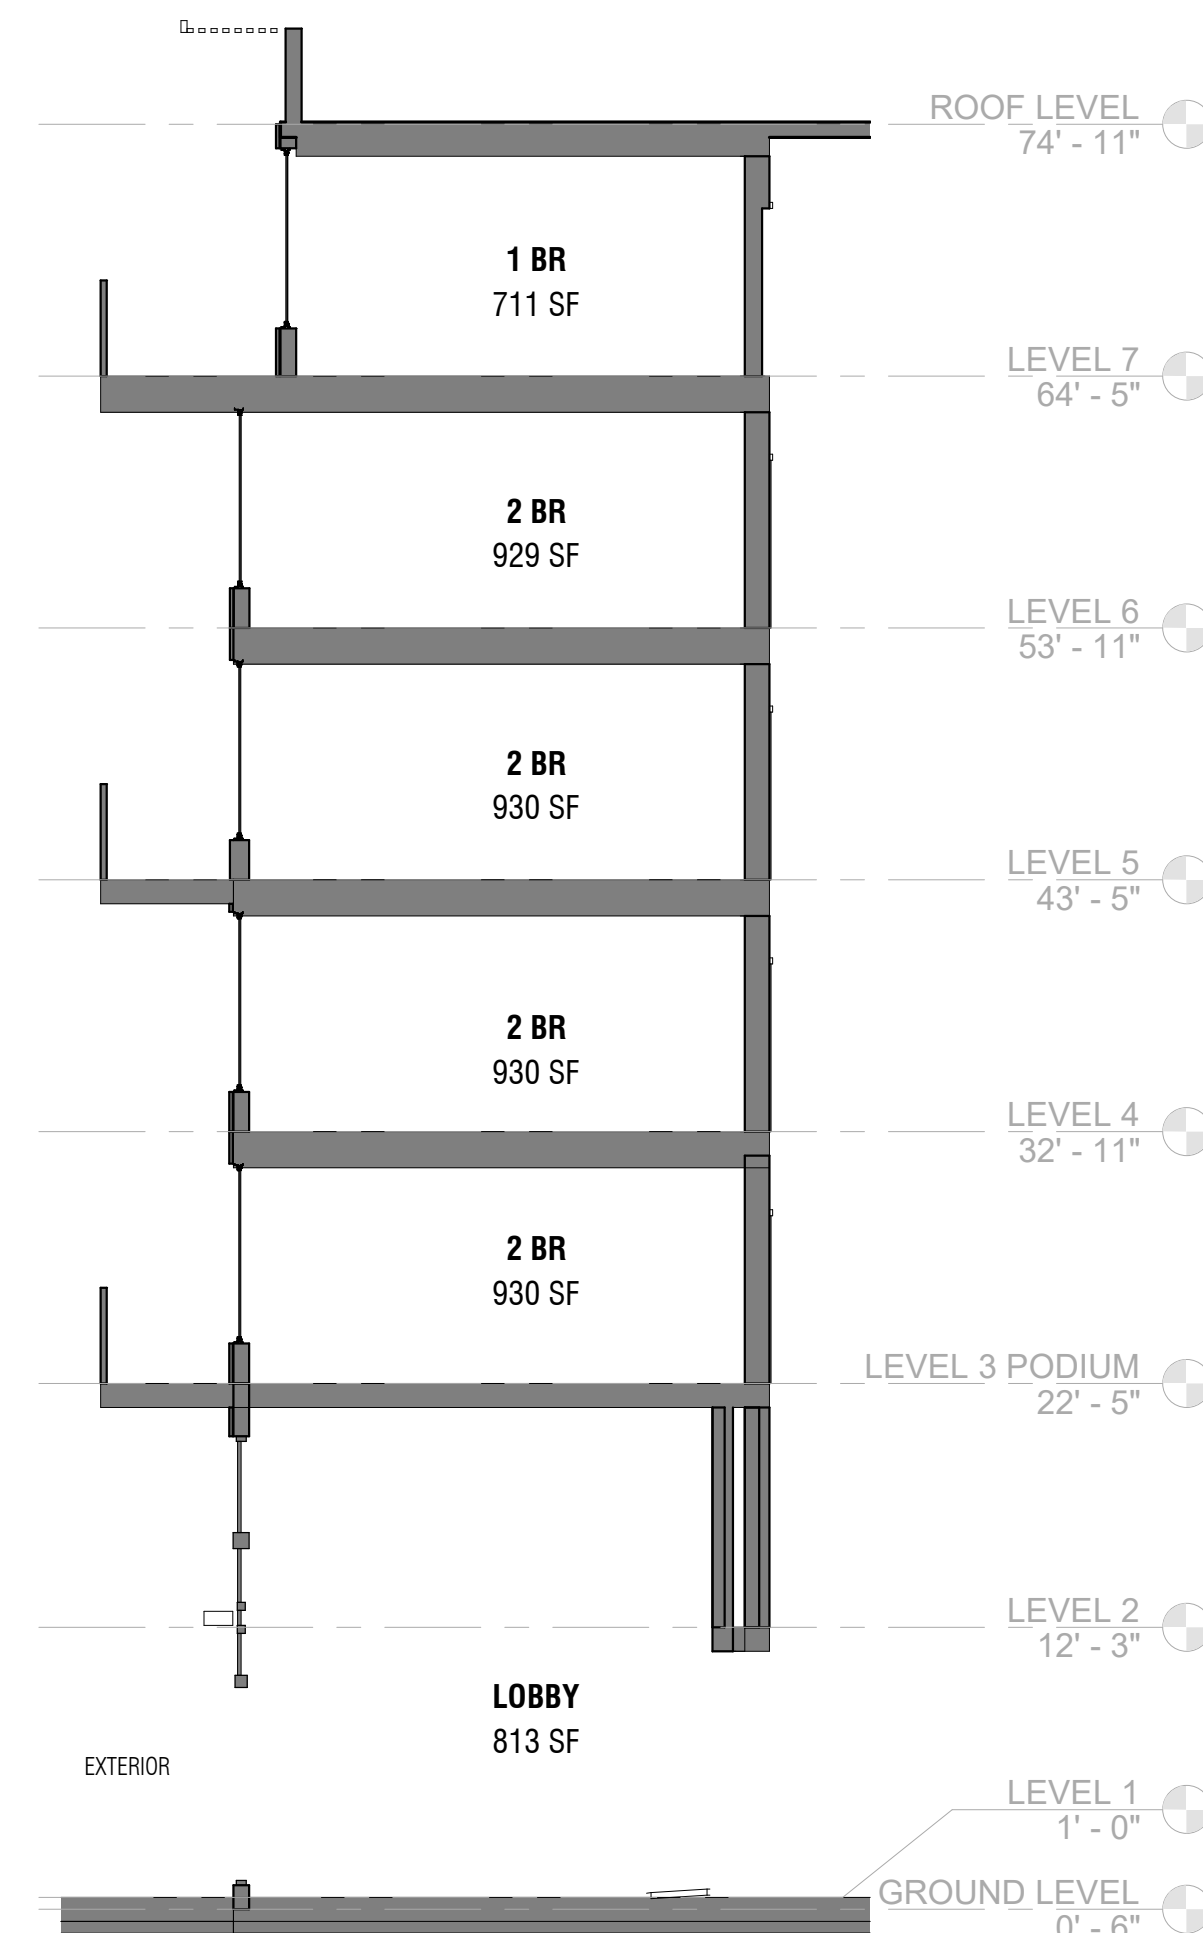

① CHAMFER SECTION
1/8" = 1'-0"

