Klein A+D and Goguette Shared Office

59 & 61 Montgomery Dr

DEMOLITION NOTES


- Contractor and his subcontractors are to verify all existing conditions before commencing with work, in order to ensure conformance with design drawings. All inconsistencies shall be brought to the attention of the owner prior to proceeding with any work.
- Layout of new work is largely based upon relationships to existing conditions. Any questions regarding the intent related to the layout of the new work shall be brought to the attention of the designer prior to proceeding with any

CONTRACTOR REQUIREMENTS

- All work to be performed must be by a licensed contractor and or subcontractor.
- All construction shall conform to the applicable building codes and any other local codes and ordinances in force at the time of construction. All materials shall conform to and be installed in accordance with manufacturer's specifications for the specific product and/or service.
- The intent of the documents is to include all labor, materials, equipment and transportation necessary for the complete and proper execution of the work, consistent with good practice. Any work or item not specifically called for in the drawings but required for a complete and fully functioning installation consistent with the intent of the documents shall be supplied by the contractor and his subcontractors.
- Deviations or alterations to any portion of the work of specific details shall not be done unless approved by the owner and/or designer prior to work being
- Any changes and or additional work to be performed must be submitted on a written change order with a cost estimate prior to work being performed. Contractor to supply owner with schedule of work to be performed with a
- completion date.
- Contractor to provide toilet facilities.
- Protect all areas outside of the project area. Contractor to protect and store all materials from weather and elements.
- On a daily basis, clean up and cart away debris; broom sweep all areas involved in the project.
- Contractor to haul away debris as necessary. Contractor to provide dumpster 12. Contractor shall be held responsible for all loss and damage that may happen to work or the any of the materials used thereon until the acceptance of the work by the owner. Damage incurred to existing conditions to remain are to
- be returned to their original condition. 13. General contractor and any subcontractors shall guarantee all work installed by him/her for a period of one (1) year, unless noted otherwise.
- 14. At the completion of the work, all glass, floors, plumbing fixtures, etc., shall be thoroughly cleaned and polished. All plumbing, heating, electrical systems shall be in satisfactory working condition. All exterior areas shall be left clean and free from debris, rubbish and miscellaneous materials.
- 15. The contractor and subcontractors agree that during the guarantee period, any defective work and any other work damaged thereby, shall be replaced promptly and properly without cost to the owner.
- 16. Manufacturers' printed or published instructions shall be strictly complied with for the incorporation of all manufactured materials and equipment into the building.
- 17. A punch list of missing items, uncompleted work, and defective work shall be made by the contractor prior to the owner's occupancy of the work under contract. The owner, contractor and designer shall review and accept the punch list, on site, which will be incorporated into the notice of substantial completion filed by the owner.
- 18. The filing of the notice of substantial completion by the owner starts the warranty and guarantee period, as well as the lien period for the subcontractors.
- 19. When the owner occupies the space prior to completion, the contractor is not responsible for damages that have not been documented as defective before owner occupancy, except for defective or missing items.
- 20. Remove existing work as indicated on the drawings and as necessary for new work. Verify with the owner before discarding any removed salvageable
- 21. The owner shall be instructed as to the use and maintenance of each piece of equipment

GENERAL CONSTRUCTION NOTES

1. Plans are not to be scaled, refer to written dimensions or contact Architect for information.

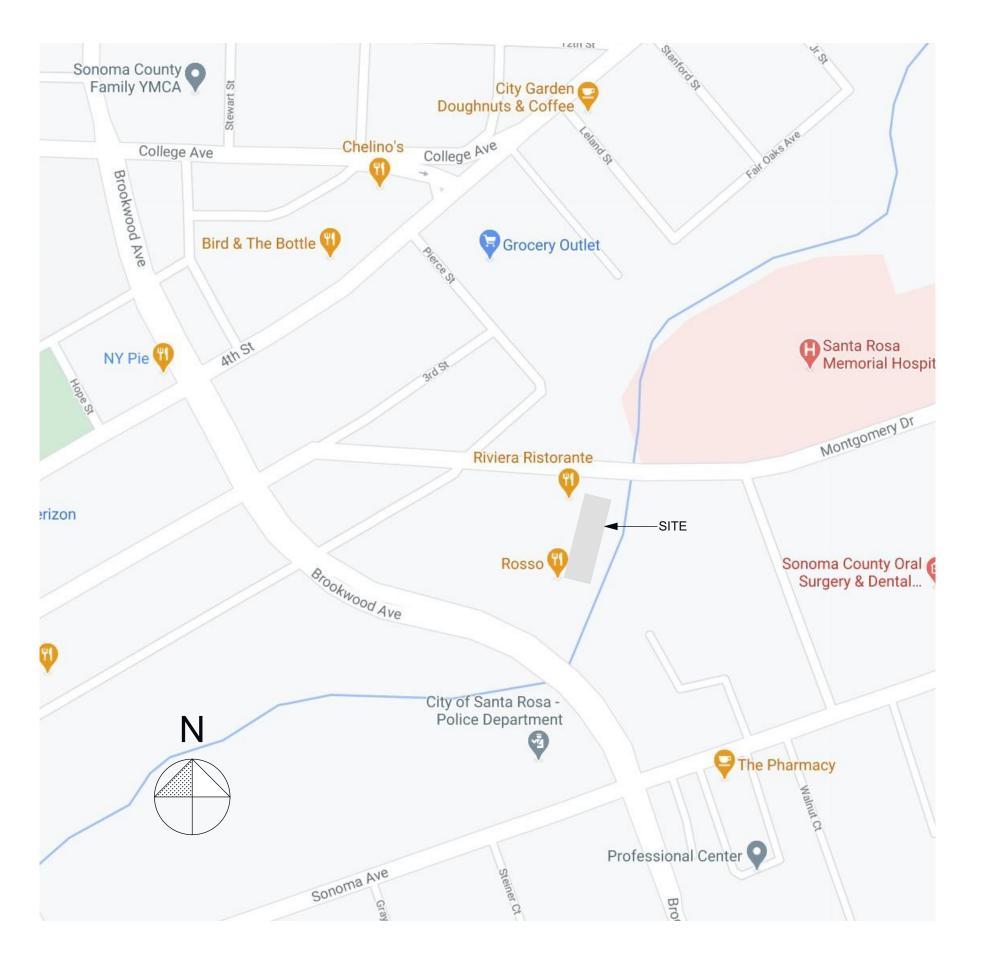

Vicinity Map NOT TO SCALE COUNTY ASSESSOR'S PARCEL MAP TAX RATE AREA Parcel Map 376 8k-339 Pg. \$15/16, Rec. 10/11/ C of Santy Roso Greek per ... BLOCK 2 DOYLE'S SUBD. BLOCKS C & D PIERCE'S SUBD Assessor's Map Bk.009, Pg.08 Sonoma County, Calif. (ACAD) HYBRID 12-31-12 KB

Assessor's Parcel Map

NOT TO SCALE

Code Summary

2019 California Residential Code 2019 California Electrical Code 2019 California Mechanical Code 2019 California Plumbing Code 2019 California Energy Code 2019 California Fire Code 2019 Green Building Code

City of Santa Rosa local ordinances & regulations

Project Information

Occupancy Load:

Construction Type:

Electrical Service Size:

Project Name: Goguette Bread 59 & 61 Montgomery Dr Project Location: 009-081-054 1.98 Acres Acres: CO Zoning: Building Type: Commerical Occupancy Type: Business

448 / 150 = 3 V-B sprinklered 200A 3-phase, 4 wire

Area Summary

BUILDING AREA Remodel Area:

BUILDING HEIGHT No change to building height

OWNER **Brad Fruiht** Santa Rosa, CA 95404 (707) 331-6009

ryan@walkconstruction.com (707) 322-4002

Scope of Work

Construct partition wall and install two

None

Sheet Index

A001 Cover Sheet Site Plan A002 A101 Floor Plan A102 A501 Details A502 Details

448 sq. ft.

Directory

3400 Rolling Oaks Road brad@tuxhornhomes.com

TENANT Nas Salamati 1315 Fourteenth Street Santa Rosa, CA 95404 (707) 360-8827 salamati@sonic.net

ARCHITECT Winfield Klein 1011 2nd Street, Suite 205 Santa Rosa, California 95404 winfield@kleinarch.design (707) 364-3589

CONTRACTOR Ryan Walker Walker & Associates 52 Mission Cir #205 Santa Rosa, CA 95409

REVISIONS:

Deferred Submittals

Electrical Plan A503 Details



1011 Second Street #205 Santa Rosa, CA 95404 (707) 364 - 3589 vinfield@kleinarch.desigr

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oguette

DESIGNER: WK + TK

December 17, 2020 LAYOUT NAME:

Cover Sheet SHEET NO.






R99C (CA)



ADA Parking Signage

SCALE: 1' = 1'-0"


Van Space Signage

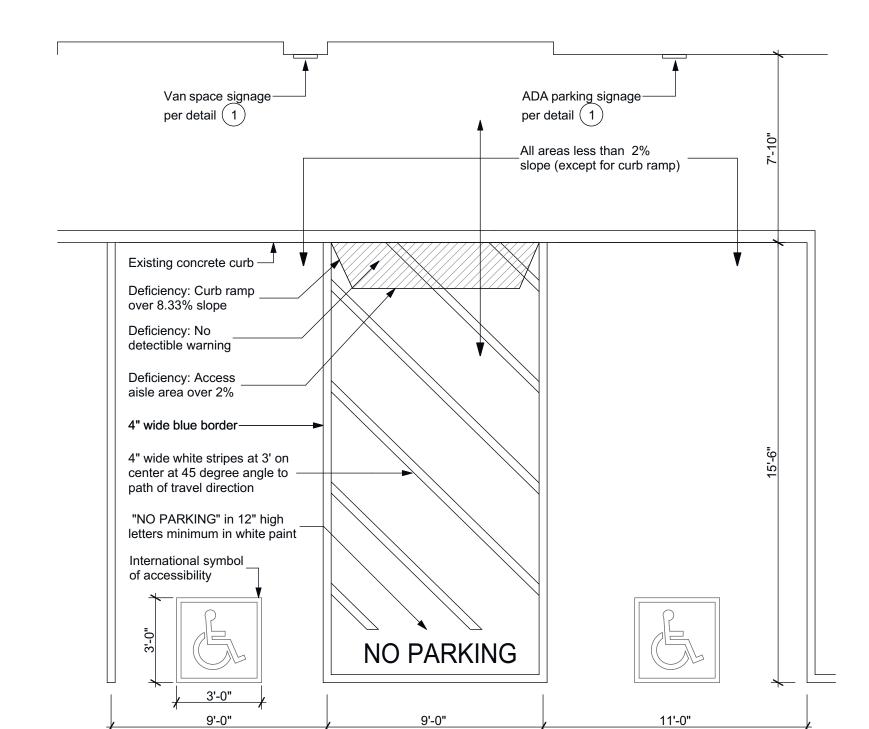



SCALE: 1" = 30'

Site Plan

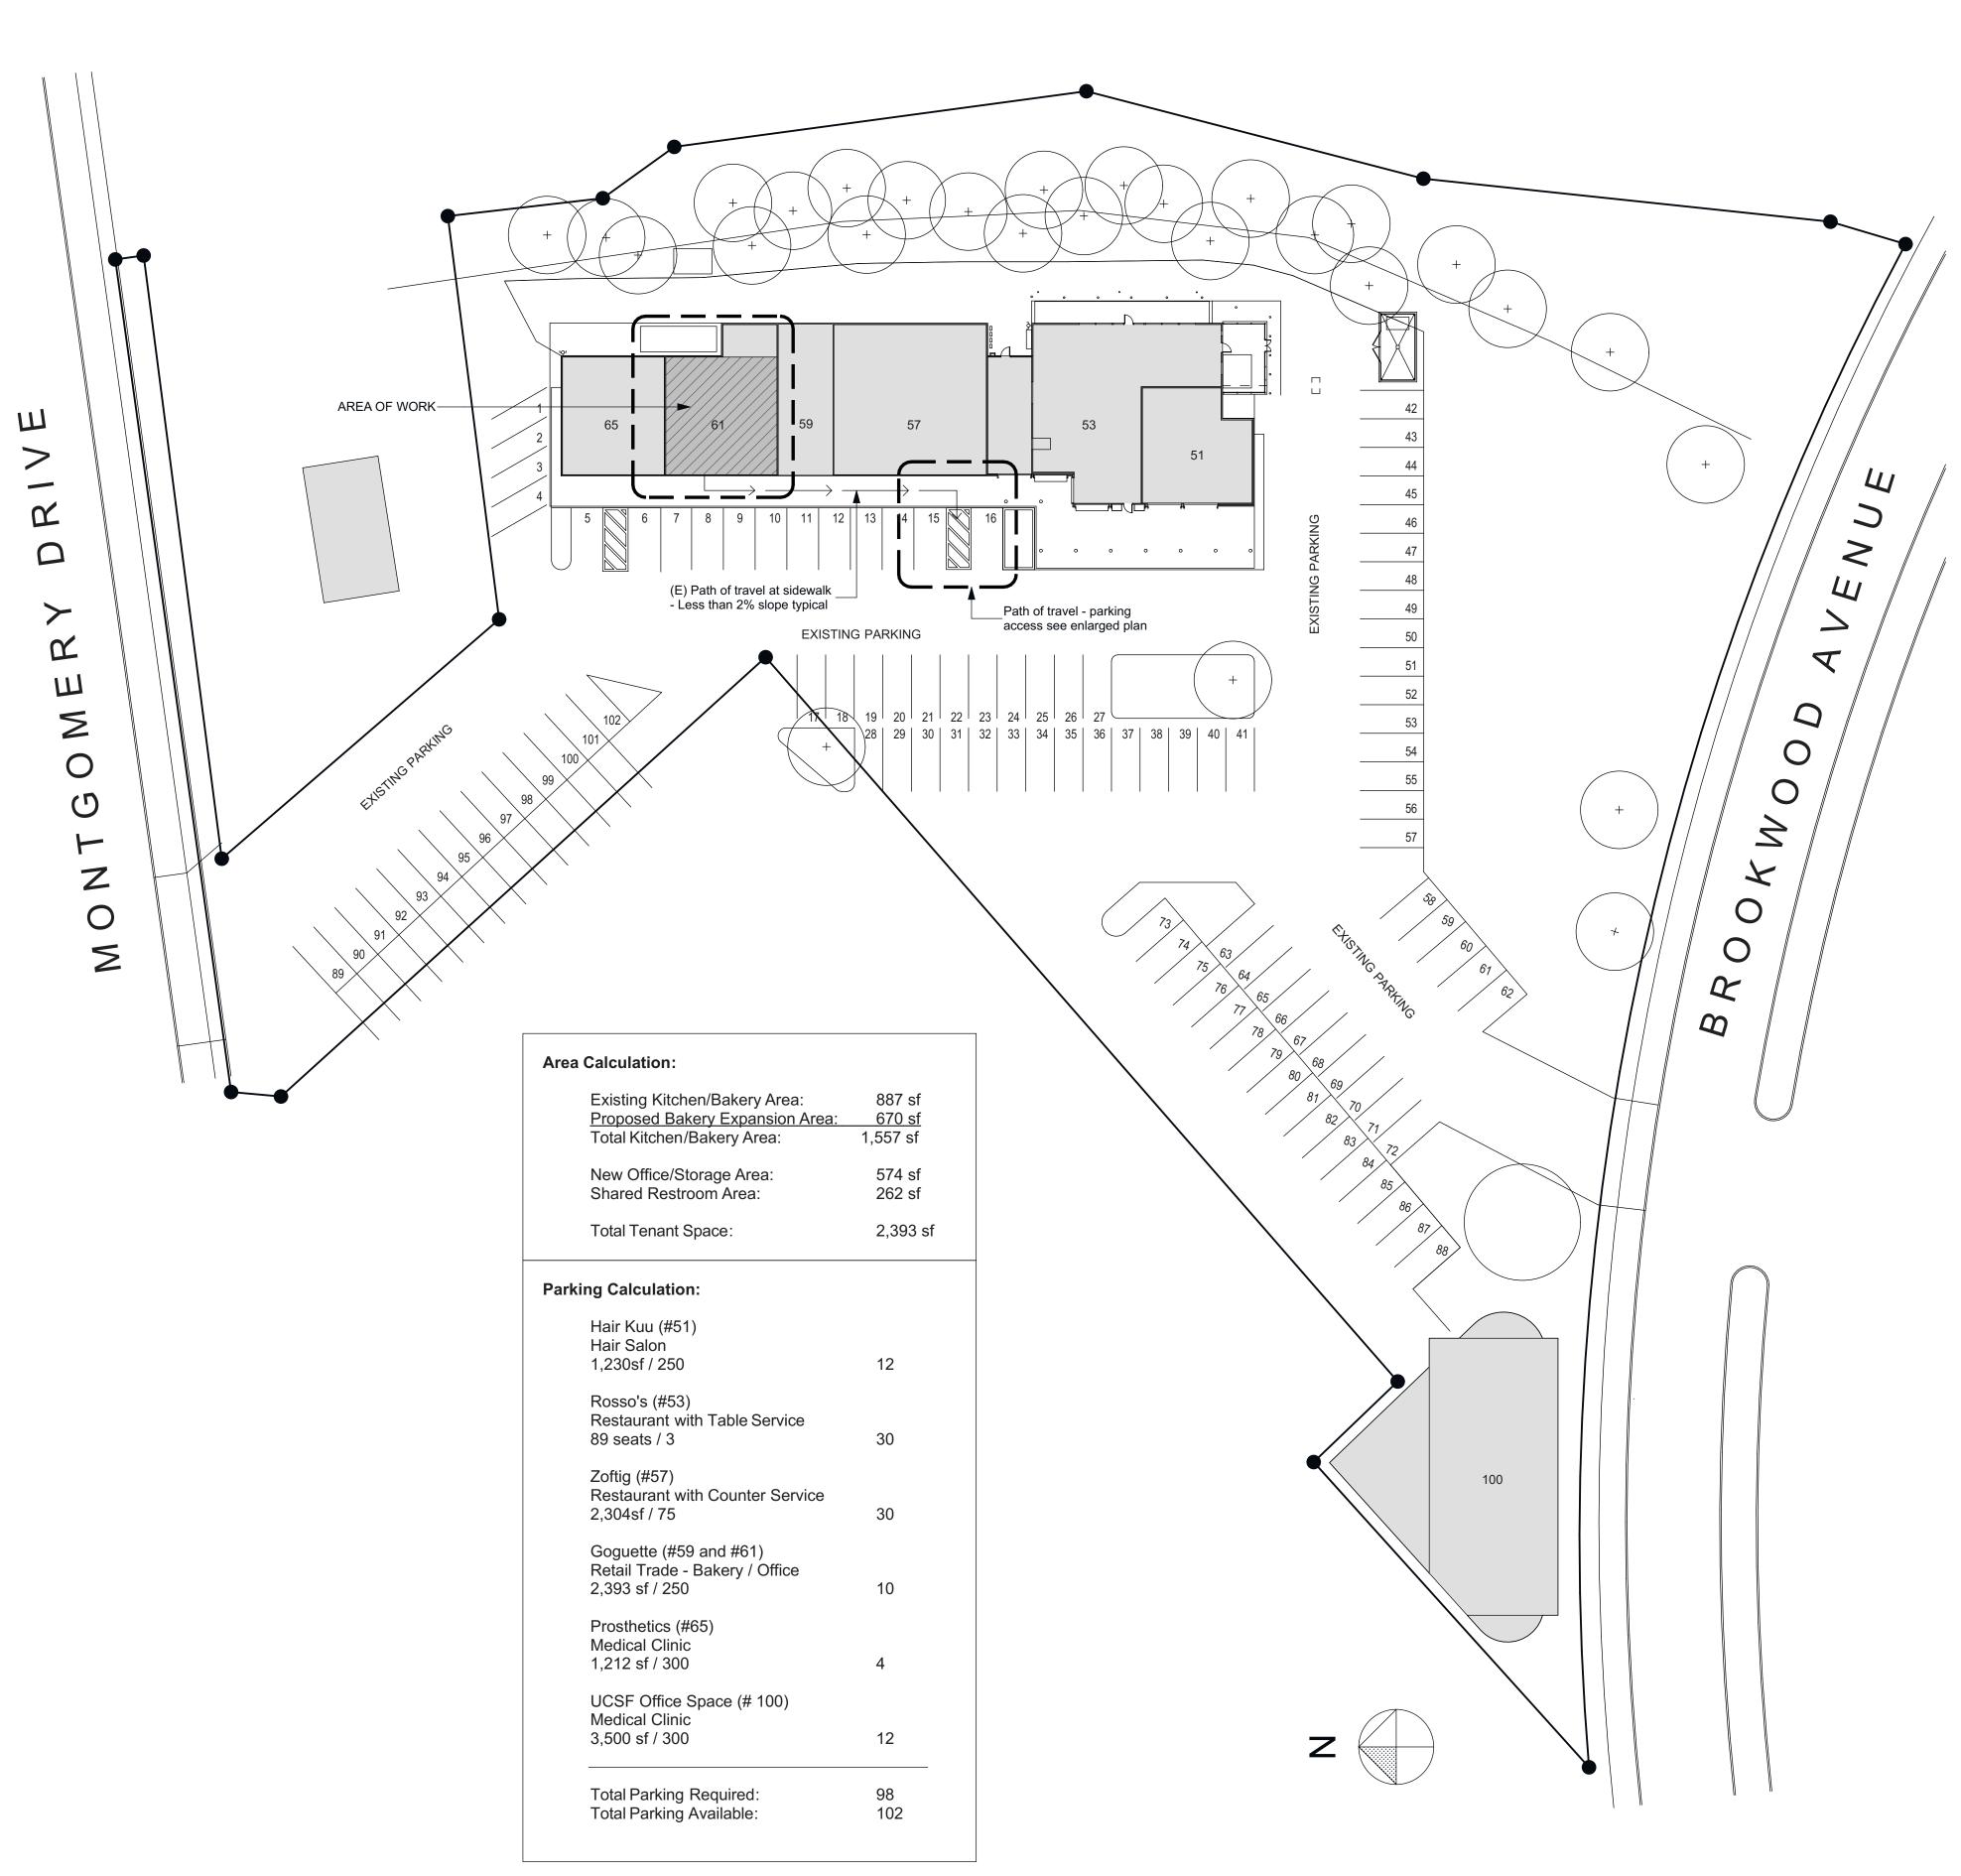

architecture + design

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(707) 364 - 3589 vinfield@kleinarch.des

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+D/Goguette Sh 59 & 61 Montgomery D Santa Rosa , California 95

REVISIONS:

★ C-36713 Sept. 30, 2021 RENEWAL DATE


OF CALIFORNIA


DESIGNER: WK + TK

DATE:
December 17, 2020


LAYOUT NAME:
Site Plan

SHEET NO.

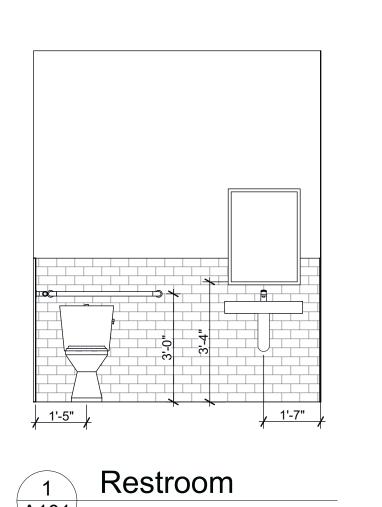

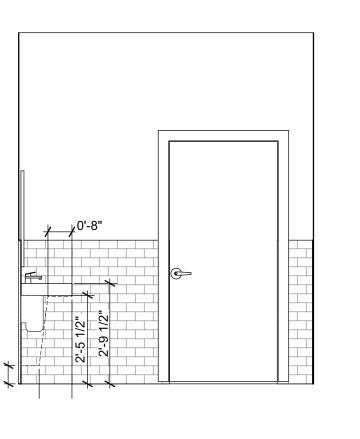


Restroom

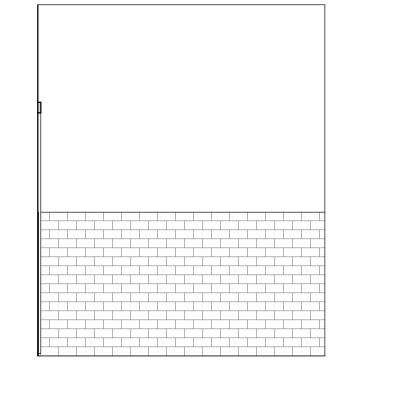

Restroom


A101 SCALE: 3/8" = 1'-0"

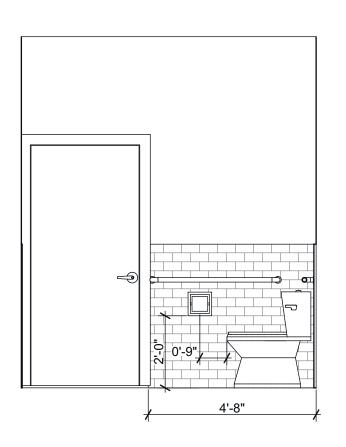

Restroom

A101 SCALE: 3/8" = 1'-0"



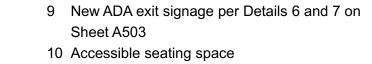

ADA KEY NOTES

at proper height

Sheet A501

1 ADA Improvement - Replace and rehang mirror

2 ADA compliant transition strip per Detail 1,

3 Existing 3'0 x 6'8 door with latch and closer

4 New 3'0 x 6'8 door with ADA lever handle

correct deficiencies as necessary 6 60" diameter circular turning space

verify or provide ADA approved lever or handle, verify clearances per Detail 6 and 7 on Sheet

5 Verify accessible bathroom items per details on

Sheet A502 and Detail 2 on Sheet A503,

8 New ADA restroom signage per Details 5, 6


7 30" x 48" clear space


and 7 on Sheet A503

11 Verify reach rances and accessibility of operable parts throughout tenant space per Details 4 and 5 on Sheet A501

12 2% max. slope in any direction 13 International sign of accessibility per Details 6

and 7 on Sheet A503 14 60" x 56" clear space

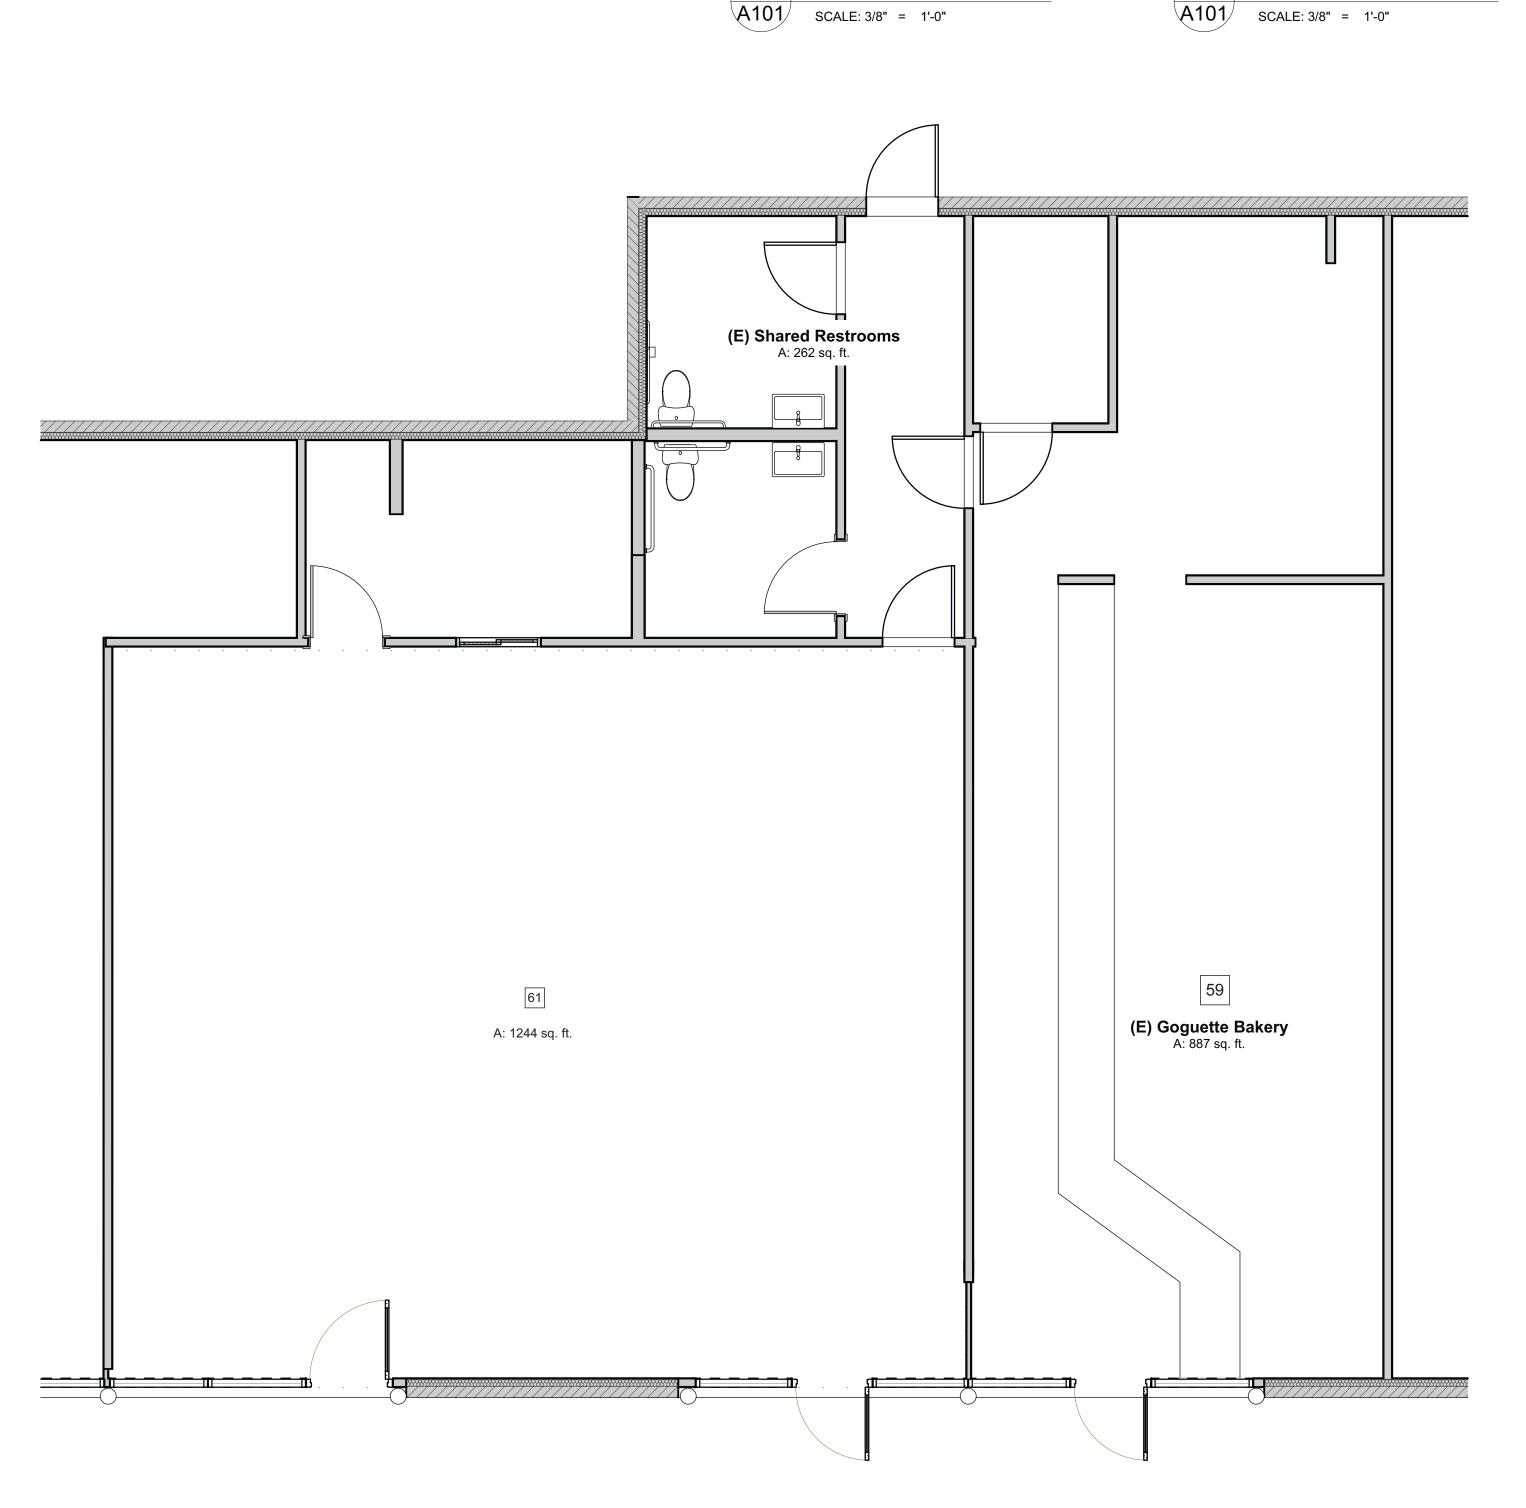

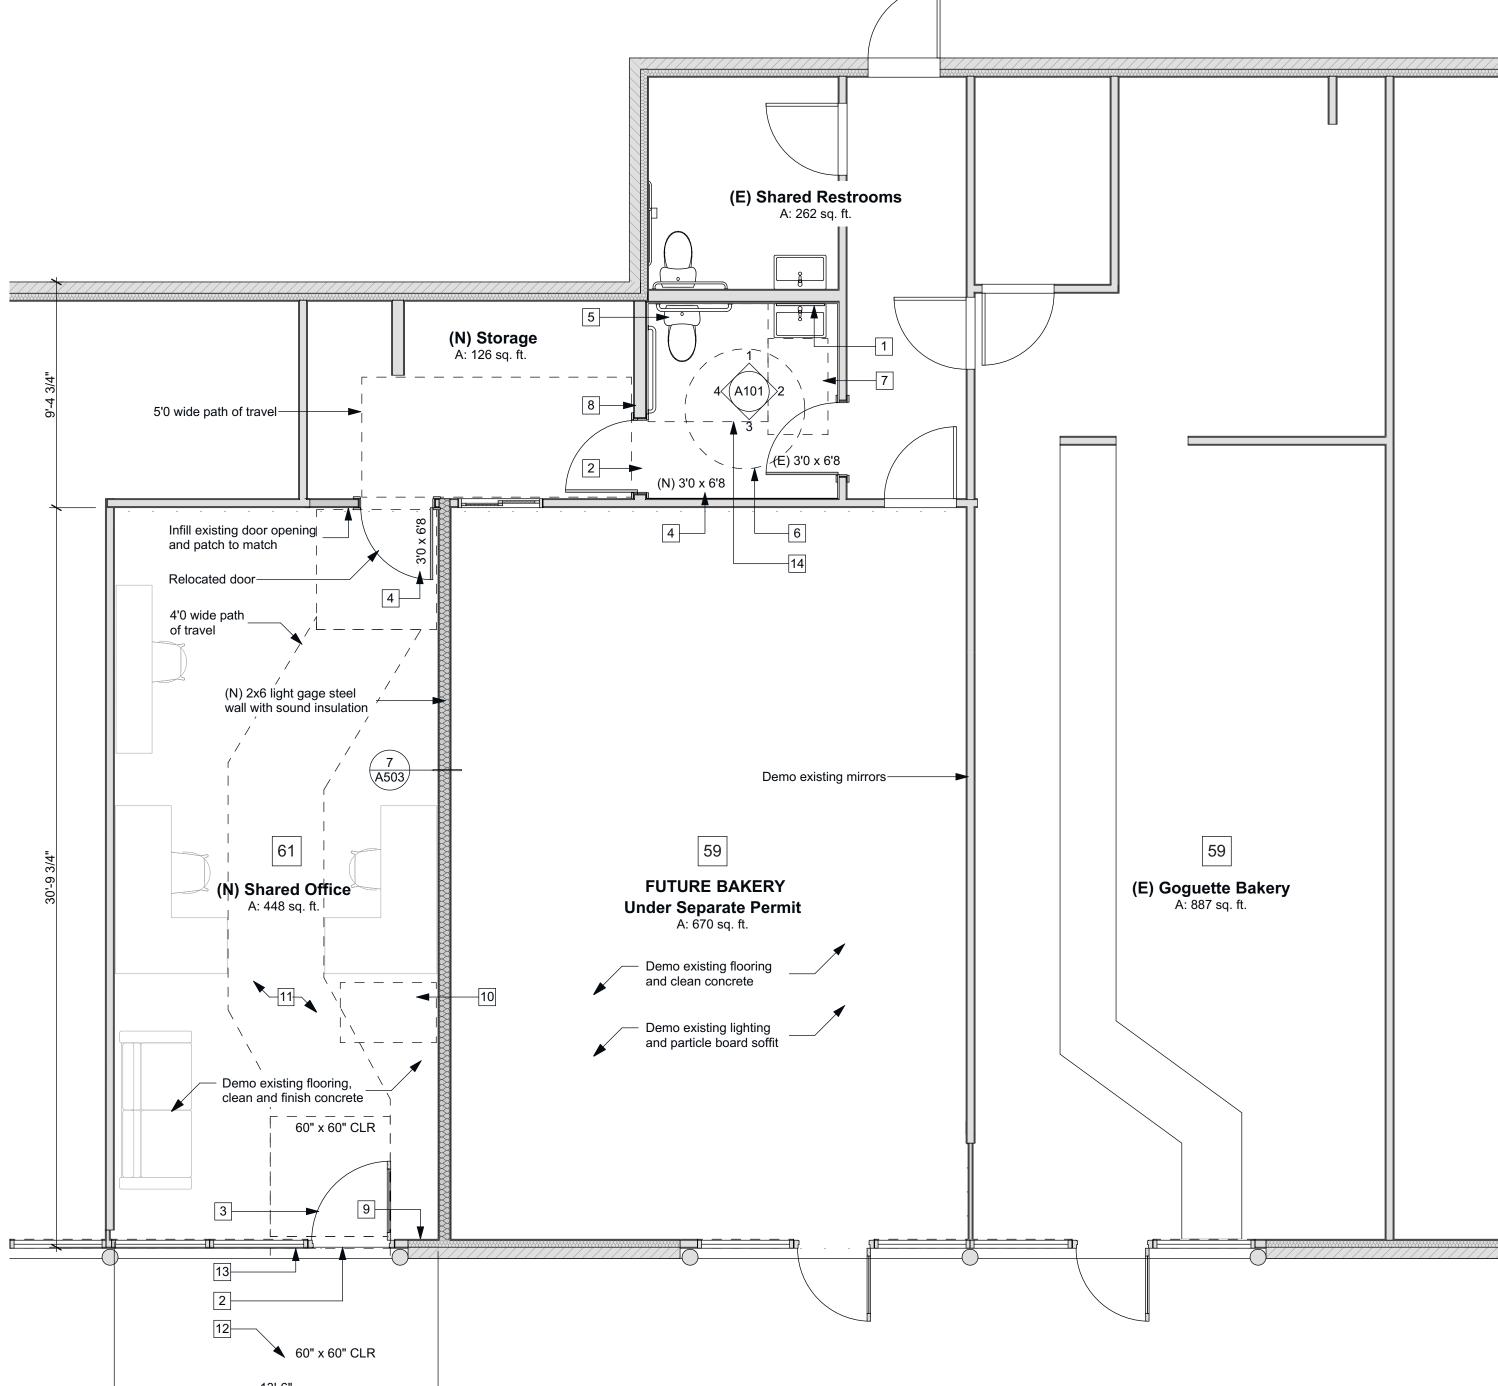

Existing Floor Plan

SCALE: 1/4" = 1'-0"

Proposed Floor Plan

SCALE: 1/4" = 1'-0"

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Office Shared

oguette

REVISIONS:



DESIGNER: WK + TK

December 17, 2020 LAYOUT NAME:

Floor Plan SHEET NO.



Lighting and Electrical SCALE: 1/4" = 1'-0"

ELECTRICAL SYMBOLS

AFCI Duplex Wall, AFCI gfcl ⊕ Duplex Wall, GFCI

wp

Duplex Wall, Waterproof 240 Duplex Wall, 240V

-
Switch ო ← 3-way Switch

> □ → Dimmer Switch ద్ద — 3-way Dimmer Switch

ਛਿ—∽ Jamb Switch

ELECTRICAL SYMBOLS PLUMBING SYMBOLS

AFCI Duplex Wall, AFCI ── Water stub —cw— Cold water supply GFCI ⊕ Duplex Wall, GFCI $-\,\mathrm{HW}--$ Hot water supply wp

Duplex Wall, Waterproof ——— Drain line 240 Duplex Wall, 240V — Drain inlet → Switch ო-∽ 3-way Switch

NEW VS. EXISTING

Existing

→ New

□ → Dimmer Switch [∞]
Occupancy Sensor Recessed LED Troffer (2x2 = 30 Watt, 2x4 = 40 Watt) Surface Mounted LED Track Light

(180 Watt Circuit Limited) Surface Mounted LED Ceiling Fixture

├─ Wall Mounted Fixture

4" LED Recessed Light (800 lumen, 10 Watt)

150 CFM Ceiling-Mounted Exhaust with Damper, Vent Termination Shall Be > 3' From Any Building Opening

Data Communication Jack (CO-AX & CAT. 6)

Phone line

G Gas Valve Existing Supply Register Thermostat Existing Return Air Grill

Wall Mounted Fire Extinguisher FA Fire Alarm EXIT Illuminated Exit Signage (New)

ELECTRICAL NOTES 1. All electrical work shall be performed in compliance with the most current codes and regulations.

Install all equipment, applicances and accessories in strict accordance with the manufacturer's specifications.

The electrician shall verify all requirements with the owner prior to installation.

Verify with owner color and style of outlets and switches prior to purchase. The electrician shall verify the size of the existing and

proposed electrical service to accommodate any additional electrical load.

6. All exterior outlets shall have a waterproof housing, GFI protection and tamper resistant rating. All kitchen and bath outlets shall be GFI protected with a

tamper resistant rating. All outlets shall be located 12" above floor unless otherwise indicated with a +X" to designate an alternative elevation. Outlets shown at countertops to be +40-44" typical unless

otherwise noted. 11. Provide one separate 20 amp circuit for all bathrooms with no other outlets on circuit.

13. Mechanical ventilation for toilet compartments, bathrooms and laundry rooms shall be capable of providing (5) air changes per hour and exhaust to the exterior.

14. All phone lines to be a minimum 4-pair cat. 6 typical unless otherwise noted.

LIGHTING NOTES

All work shall comply with the latest edition of the CEC and all local codes and ordinances.

2. Electrical contractor shall possess all necessary licenses to complete work and shall carry general liability and worker's compensation insurance.

Electrical contractor shall determine where IC and non-IC housings are required based on CEC and local codes.

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REVISIONS:



DESIGNER:

WK + TK

DATE:

December 17, 2020

LAYOUT NAME: Electrical Plan

SHEET NO.

Advisory 302.2 Carpet. Carpets and permanently affixed mats can significantly increase the amount of force (roll resistance) needed to propel a wheelchair over a surface. The firmer the carpeting and backing, the lower the roll resistance. A pile thickness up to ½ inch (13 mm) (measured to the backing, cushion, or pad) is allowed, although a lower pile provides easier wheelchair maneuvering. If a backing, cushion or pad is used, it must be firm. Preferably, carpet pad should not be used because the soft padding increases roll resistance.


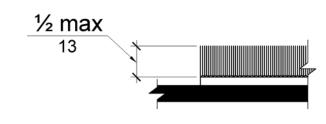



Figure 302.2 Carpet Pile Height

303.2 Vertical. Changes in level of ¼ inch (6.4 mm) high maximum shall be permitted to be vertical.

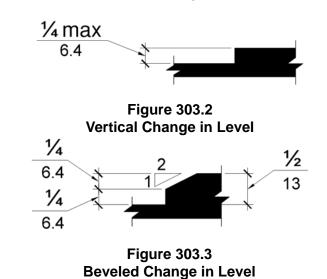

303.4 Ramps. Changes in level greater than ½ inch (13 mm) high shall be *ramped*, and shall comply with 405 or 406.

404.2.5 Thresholds. Thresholds, if provided at doorways, shall be ½ inch (13 mm) high maximum. Raised thresholds and changes in level at doorways shall comply with 302 and 303. **EXCEPTION:** Existing or altered thresholds ¾ inch (19 mm) high maximum that have a beveled edge on each side with a slope not steeper than 1:2 shall not be required to comply with 404.2.5.

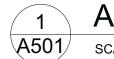

ADA Threshold

A501 | SCALE: 1' = 1'-0"

Toor or Ground Space

ral. Clear floor or ground space shall comply with 305.

or Ground Surfaces. Floor or ground surfaces of a clear floor or ground space shall 302. Changes in level are not permitted. **FION:** Slopes not steeper than 1:48 shall be permitted.

The clear floor or ground *space* shall be 30 inches (760 mm) minimum by 48 inches (1220

Figure 305.3 Clear Floor or Ground Space

305.4 Knee and Toe Clearance. Unless otherwise specified, clear floor or ground *space* shall be permitted to include knee and toe clearance complying with 306.

305.5 Position. Unless otherwise specified, clear floor or ground *space* shall be positioned for either forward or parallel approach to an *element*.

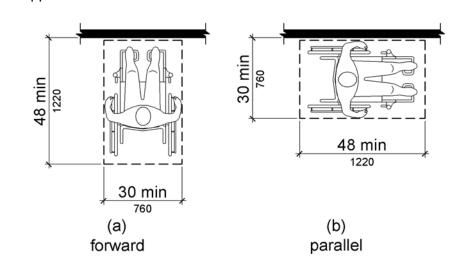



Figure 305.5 Position of Clear Floor or Ground Space

305.6 Approach. One full unobstructed side of the clear floor or ground *space* shall adjoin an accessible route or adjoin another clear floor or ground space.

305.7 Maneuvering Clearance. Where a clear floor or ground *space* is located in an alcove or otherwise confined on all or part of three sides, additional maneuvering clearance shall be provided in accordance with 305.7.1 and 305.7.2.



SCALE: 1' = 1'-0"

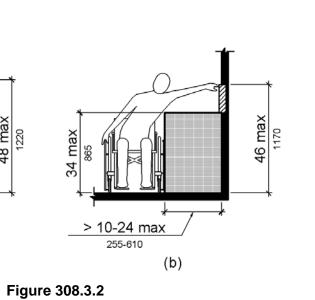

Obstructed High Side Reach

309 Operable Parts

309.1 General. Operable parts shall comply with 309.

309.2 Clear Floor Space. A clear floor or ground *space* complying with 305 shall be provided.

309.3 Height. Operable parts shall be placed within one or more of the reach ranges specified in 308.

309.4 Operation. Operable parts shall be operable with one hand and shall not require tight grasping, pinching, or twisting of the wrist. The force required to activate *operable parts* shall be 5 pounds (22.2 N) maximum.

EXCEPTION: Gas pump nozzles shall not be required to provide *operable parts* that have an activating force of 5 pounds (22.2 N) maximum.

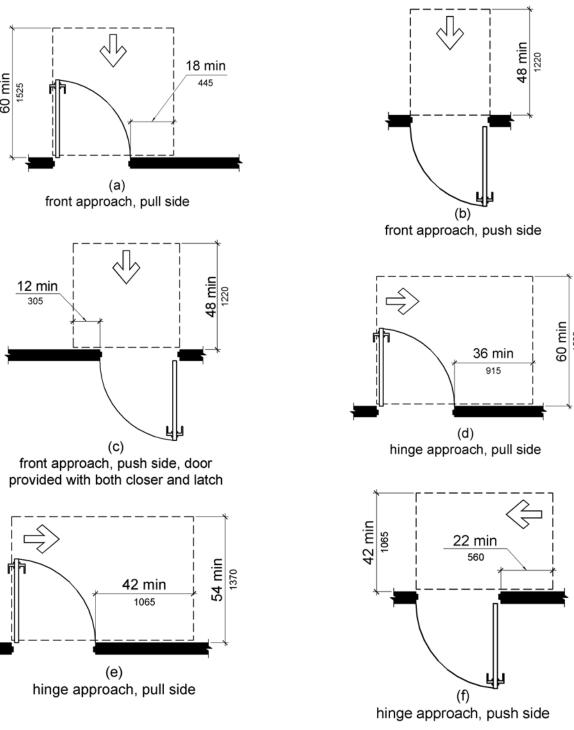


Figure 404.2.4.1 **Maneuvering Clearances at Manual Swinging Doors and Gates**

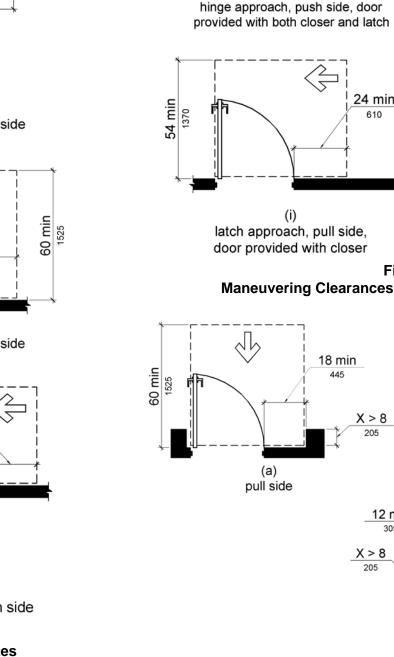


Figure 404.2.4.3 **Maneuvering Clearances at Recessed Doors and Gates**

SCALE: 1' = 1'-0"

ADA Maneuvering Clearances

Knee Clearance

ADA Knee and Toe Clearance

306.2.1 General. Space under an element between the finish floor or ground and 9 inches (230 mm)

above the finish floor or ground shall be considered toe clearance and shall comply with 306.2.

306.2.2 Maximum Depth. Toe clearance shall extend 25 inches (635 mm) maximum under an

306.2.3 Minimum Required Depth. Where toe clearance is required at an element as part of a

306.2.4 Additional Clearance. Space extending greater than 6 inches (150 mm) beyond the

Figure 306.2

Toe Clearance

306.3.4 Clearance Reduction. Between 9 inches (230 mm) and 27 inches (685 mm) above the finish floor or ground, the knee clearance shall be permitted to reduce at a rate of 1 inch (25 mm) in

available knee clearance at 9 inches (230 mm) above the finish floor or ground shall not be

306.2.5 Width. Toe clearance shall be 30 inches (760 mm) wide minimum.

306.3.5 Width. Knee clearance shall be 30 inches (760 mm) wide minimum.

elevation

elevation


depth for each 6 inches (150 mm) in height.


SCALE: 1' = 1'-0"

clear floor space, the toe clearance shall extend 17 inches (430 mm) minimum under the element.


element.

considered toe clearance.

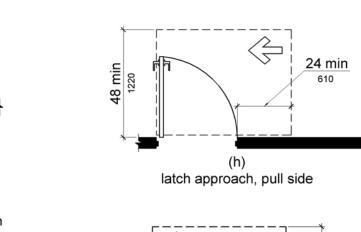

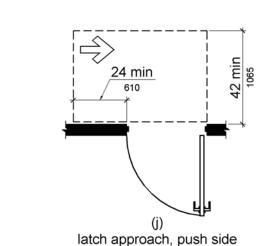

door provided with closer Figure 404.2.4.1 Maneuvering Clearances at Manual Swinging Doors and Gates

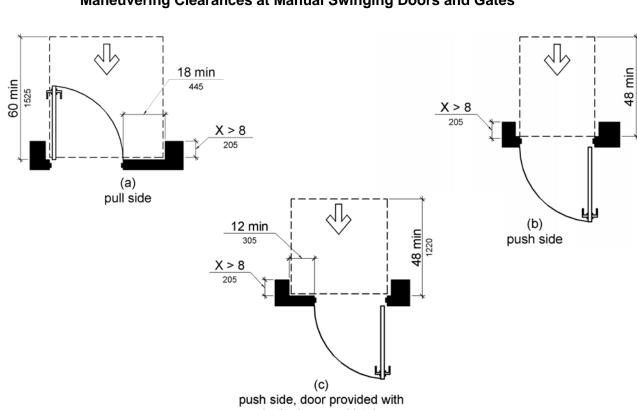

both closer and latch

SCALE: 1' = 1'-0"

308.2.1 Unobstructed. Where a forward reach is unobstructed, the high forward reach shall be 48 inches (1220 mm) maximum and the low forward reach shall be 15 inches (380 mm) minimum above the finish floor or ground.

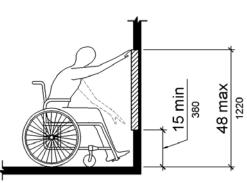


Figure 308.2.1 **Unobstructed Forward Reach**

308.2.2 Obstructed High Reach. Where a high forward reach is over an obstruction, the clear floor space shall extend beneath the element for a distance not less than the required reach depth over the obstruction. The high forward reach shall be 48 inches (1220 mm) maximum where the reach depth is 20 inches (510 mm) maximum. Where the reach depth exceeds 20 inches (510 mm), the high forward reach shall be 44 inches (1120 mm) maximum and the reach depth shall be 25 inches (635 mm) maximum.

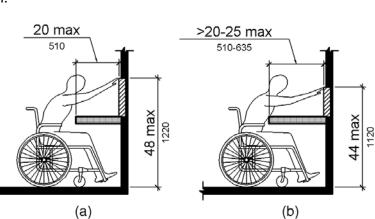


Figure 308.2.2 **Obstructed High Forward Reach**

ADA Reach Ranges

SCALE: 1' = 1'-0"

combination lock.

404.2.7 Door and Gate Hardware. Handles, pulls, latches, locks, and other *operable parts* on doors and gates shall comply with 309.4. *Operable parts* of such hardware shall be 34 inches (865 mm) minimum and 48 inches (1220 mm) maximum above the finish floor or ground. Where sliding doors are in the fully open position, operating hardware shall be exposed and usable from both sides.

EXCEPTIONS: 1. Existing locks shall be permitted in any location at existing glazed doors without stiles, existing overhead rolling doors or grilles, and similar existing doors or grilles that are designed with locks that are activated only at the top or bottom rail. 2. Access gates in barrier walls and fences protecting pools, spas, and hot tubs shall be permitted to have operable parts of the release of latch on self-latching devices at 54 inches (1370 mm) maximum above the finish floor or ground provided the self-latching devices are not also self-locking devices and operated by means of a key, electronic opener, or integral

Advisory 404.2.7 Door and Gate Hardware. Door hardware that can be operated with a closed fist or a loose grip accommodates the greatest range of users. Hardware that requires simultaneous hand and finger movements require greater dexterity and coordination, and is not recommended.

404.2.8 Closing Speed. Door and gate closing speed shall comply with 404.2.8.

404.2.8.1 Door Closers and Gate Closers. Door closers and gate closers shall be adjusted so that from an open position of 90 degrees, the time required to move the door to a position of 12 degrees from the latch is 5 seconds minimum.

404.2.8.2 Spring Hinges. Door and gate spring hinges shall be adjusted so that from the open position of 70 degrees, the door or gate shall move to the closed position in 1.5 seconds

404.2.9 Door and Gate Opening Force. Fire doors shall have a minimum opening force allowable by the appropriate administrative authority. The force for pushing or pulling open a door or gate other than fire doors shall be as follows:

1. Interior hinged doors and gates: 5 pounds (22.2 N) maximum.

2. Sliding or folding doors: 5 pounds (22.2 N) maximum.

These forces do not apply to the force required to retract latch bolts or disengage other devices that hold the door or gate in a closed position.

Advisory 404.2.9 Door and Gate Opening Force. The maximum force pertains to the

continuous application of force necessary to fully open a door, not the initial force needed to overcome the inertia of the door. It does not apply to the force required to retract bolts or to disengage other devices used to keep the door in a closed position.

404.2.10 Door and Gate Surfaces. Swinging door and gate surfaces within 10 inches (255 mm) of the finish floor or ground measured vertically shall have a smooth surface on the push side extending the full width of the door or gate. Parts creating horizontal or vertical joints in these surfaces shall be within 1/16 inch (1.6 mm) of the same plane as the other. Cavities created by added kick plates shall be capped.

EXCEPTIONS: 1. Sliding doors shall not be required to comply with 404.2.10. 2. Tempered glass doors without stiles and having a bottom rail or shoe with the top leading edge tapered at 60 degrees minimum from the horizontal shall not be required to meet the 10 inch (255 mm) bottom smooth surface height requirement.

3. Doors and gates that do not extend to within 10 inches (255 mm) of the finish floor or ground shall not be required to comply with 404.2.10. 4. Existing doors and gates without smooth surfaces within 10 inches (255 mm) of the finish floor

or ground shall not be required to provide smooth surfaces complying with 404.2.10 provided that if added kick plates are installed, cavities created by such kick plates are capped.

ADA Doors and Hardware

1011 Second Street #205 Santa Rosa, CA 95404 (707) 364 - 3589 winfield@kleinarch.design C

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REVISIONS:



DESIGNER: WK + TK

LAYOUT NAME:

December 17, 2020

Details

SHEET NO.

Printed: 12/17/2020

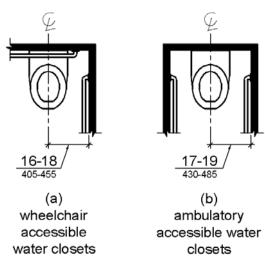


Figure 604.2 Water Closet Location

604.3 Clearance. Clearances around water closets and in toilet compartments shall comply with 604.3.

604.3.1 Size. Clearance around a water closet shall be 60 inches (1525 mm) minimum measured perpendicular from the side wall and 56 inches (1420 mm) minimum measured perpendicular from the rear wall.

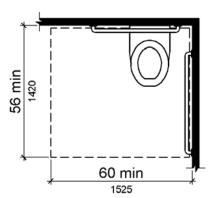


Figure 604.3.1 **Size of Clearance at Water Closets**

604.3.2 Overlap. The required clearance around the water closet shall be permitted to overlap the water closet, associated grab bars, dispensers, sanitary napkin disposal units, coat hooks, shelves, accessible routes, clear floor space and clearances required at other fixtures, and the turning space. No other fixtures or obstructions shall be located within the required water closet clearance.

Advisory 604.3.2 Overlap. When the door to the toilet room is placed directly in front of the

water closet, the water closet cannot overlap the required maneuvering clearance for the

EXCEPTION: In residential dwelling units, a lavatory complying with 606 shall be permitted on the rear wall 18 inches (455 mm) minimum from the water closet centerline where the clearance at the water closet is 66 inches (1675 mm) minimum measured perpendicular from the rear wall.

Figure 604.3.2 (Exception) Overlap of Water Closet Clearance in Residential Dwelling Units

604.8.1.1 Size. Wheelchair accessible compartments shall be 60 inches (1525 mm) wide minimum measured perpendicular to the side wall, and 56 inches (1420 mm) deep minimum for wall hung water closets and 59 inches (1500 mm) deep minimum for floor mounted water closets measured perpendicular to the rear wall. Wheelchair accessible compartments for children's use shall be 60 inches (1525 mm) wide minimum measured perpendicular to the side wall, and 59 inches (1500 mm) deep minimum for wall hung and floor mounted water closets measured

Advisory 604.8.1.1 Size. The minimum space required in toilet compartments is provided

so that a person using a wheelchair can maneuver into position at the water closet. This

space cannot be obstructed by baby changing tables or other fixtures or conveniences,

except as specified at 604.3.2 (Overlap). If toilet compartments are to be used to house

the minimum space requirements. Convenience fixtures such as baby changing tables

may not provide adequate space for maneuvering into position at a baby changing table.

must also be accessible to people with disabilities as well as to other users. Toilet

fixtures other than those associated with the water closet, they must be designed to exceed

compartments that are designed to meet, and not exceed, the minimum space requirements

ADA Clearance at Water Closet

A502 | SCALE: 1' = 1'-0"

perpendicular to the rear wall.



ADA Water Closet Location

604.6 Flush Controls. Flush controls shall be hand operated or automatic. Hand operated flush controls shall comply with 309. Flush controls shall be located on the open side of the water closet except in ambulatory *accessible* compartments complying with 604.8.2.

Advisory 604.6 Flush Controls. If plumbing valves are located directly behind the toilet seat, flush valves and related plumbing can cause injury or imbalance when a person leans back against them. To prevent causing injury or imbalance, the plumbing can be located behind walls or to the side of the toilet; or if approved by the local authority having jurisdiction, provide a toilet seat lid.

604.7 Dispensers. Toilet paper dispensers shall comply with 309.4 and shall be 7 inches (180 mm) minimum and 9 inches (230 mm) maximum in front of the water closet measured to the centerline of the dispenser. The outlet of the dispenser shall be 15 inches (380 mm) minimum and 48 inches (1220 mm) maximum above the finish floor and shall not be located behind grab bars. Dispensers shall not be of a type that controls delivery or that does not allow continuous paper flow.

Advisory 604.7 Dispensers. If toilet paper dispensers are installed above the side wall grab bar, the outlet of the toilet paper dispenser must be 48 inches (1220 mm) maximum above the finish floor and the top of the gripping surface of the grab bar must be 33 inches (840 mm) minimum and 36 inches (915 mm) maximum above the finish floor.

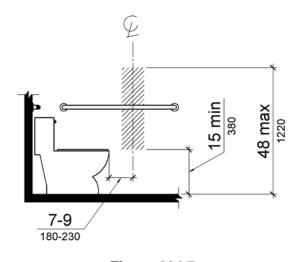


Figure 604.7 Dispenser Outlet Location

adult wall hung adult floor mounted water closet water closet and children's water closet

Figure 604.8.1.1 Size of Wheelchair Accessible Toilet Compartment

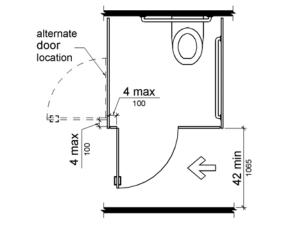


Figure 604.8.1.2 **Wheelchair Accessible Toilet Compartment Doors**



ADA Wheelchair Accessible Compartments A502 SCALE: 1' = 1'-0"

604.4 Seats. The seat height of a water closet above the finish floor shall be 17 inches (430 mm) minimum and 19 inches (485 mm) maximum measured to the top of the seat. Seats shall not be sprung to return to a lifted position.

EXCEPTIONS: 1. A water closet in a toilet room for a single occupant accessed only through a private office and not for *common use* or *public use* shall not be required to comply with 604.4. 2. In residential dwelling units, the height of water closets shall be permitted to be 15 inches (380 mm) minimum and 19 inches (485 mm) maximum above the finish floor measured to the top of the

604.5 Grab Bars. Grab bars for water closets shall comply with 609. Grab bars shall be provided on the side wall closest to the water closet and on the rear wall.

EXCEPTIONS: 1. Grab bars shall not be required to be installed in a toilet room for a single occupant accessed only through a private office and not for common use or public use provided that reinforcement has been installed in walls and located so as to permit the installation of grab bars complying with 604.5.

2. In residential dwelling units, grab bars shall not be required to be installed in toilet or bathrooms provided that reinforcement has been installed in walls and located so as to permit the installation of grab bars complying with 604.5.

3. In detention or correction *facilities*, grab bars shall not be required to be installed in housing or holding cells that are specially designed without protrusions for purposes of suicide prevention.

Advisory 604.5 Grab Bars Exception 2. Reinforcement must be sufficient to permit the installation of rear and side wall grab bars that fully meet all accessibility requirements including, but not limited to, required length, installation height, and structural strength.

604.5.1 Side Wall. The side wall grab bar shall be 42 inches (1065 mm) long minimum, located 12 inches (305 mm) maximum from the rear wall and extending 54 inches (1370 mm) minimum from the

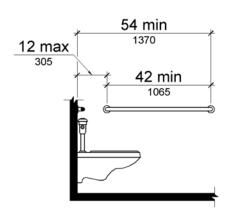


Figure 604.5.1 Side Wall Grab Bar at Water Closets

604.5.2 Rear Wall. The rear wall grab bar shall be 36 inches (915 mm) long minimum and extend from the centerline of the water closet 12 inches (305 mm) minimum on one side and 24 inches (610 mm) minimum on the other side.

EXCEPTIONS: 1. The rear grab bar shall be permitted to be 24 inches (610 mm) long minimum, centered on the water closet, where wall space does not permit a length of 36 inches (915 mm) minimum due to the location of a recessed fixture adjacent to the water closet.

2. Where an *administrative authority* requires flush controls for flush valves to be located in a position that conflicts with the location of the rear grab bar, then the rear grab bar shall be permitted to be split or shifted to the open side of the toilet area.

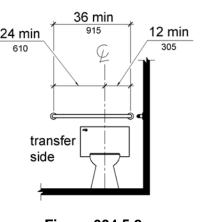


Figure 604.5.2 Rear Wall Grab Bar at Water Closets

ADA Seats and Grab Bars

the water closet.

SCALE: 1' = 1'-0"

604.8.1.3 Approach. Compartments shall be arranged for left-hand or right-hand approach to

604.8.1.4 Toe Clearance. The front partition and at least one side partition shall provide a toe clearance of 9 inches (230 mm) minimum above the finish floor and 6 inches (150 mm) deep minimum beyond the compartment-side face of the partition, exclusive of partition support members. Compartments for children's use shall provide a toe clearance of 12 inches (305 mm) minimum above the finish floor.

EXCEPTION: Toe clearance at the front partition is not required in a compartment greater than 62 inches (1575 mm) deep with a wall-hung water closet or 65 inches (1650 mm) deep with a floor-mounted water closet. Toe clearance at the side partition is not required in a compartment greater than 66 inches (1675 mm) wide. Toe clearance at the front partition is not required in a compartment for *children*'s use that is greater than 65 inches (1650 mm)

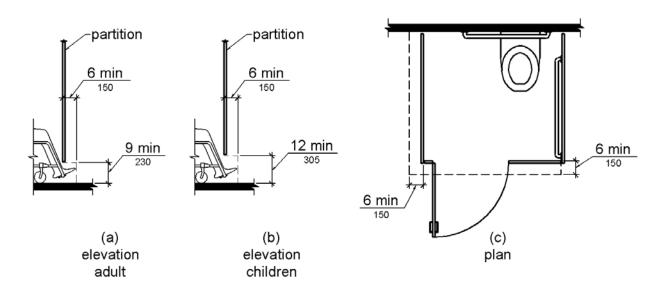


Figure 604.8.1.4 **Wheelchair Accessible Toilet Compartment Toe Clearance**

604.8.1.5 Grab Bars. Grab bars shall comply with 609. A side-wall grab bar complying with 604.5.1 shall be provided and shall be located on the wall closest to the water closet. In addition, a rear-wall grab bar complying with 604.5.2 shall be provided.

605.2 Height and Depth. Urinals shall be the stall-type or the wall-hung type with the rim 17 inches (430 mm) maximum above the finish floor or ground. Urinals shall be 13½ inches (345 mm) deep minimum measured from the outer face of the urinal rim to the back of the fixture.

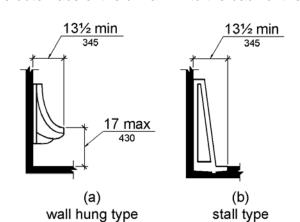


Figure 605.2 Height and Depth of Urinals

605.3 Clear Floor Space. A clear floor or ground *space* complying with 305 positioned for forward approach shall be provided.

605.4 Flush Controls. Flush controls shall be hand operated or automatic. Hand operated flush controls shall comply with 309.

8 ADA Urinal Requirements
SCALE: 1' = 1'-0"

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REVISIONS:



DESIGNER: WK + TK

December 17, 2020

LAYOUT NAME:

SHEET NO.

Printed: 12/17/2020

Figure 308.3.2 **Obstructed High Side Reach**

309 Operable Parts

309.1 General. Operable parts shall comply with 309.

309.2 Clear Floor Space. A clear floor or ground *space* complying with 305 shall be provided.

309.3 Height. Operable parts shall be placed within one or more of the reach ranges specified in 308.

309.4 Operation. Operable parts shall be operable with one hand and shall not require tight grasping, pinching, or twisting of the wrist. The force required to activate operable parts shall be 5 pounds (22.2 N) maximum.

EXCEPTION: Gas pump nozzles shall not be required to provide *operable parts* that have an activating force of 5 pounds (22.2 N) maximum.

606 Lavatories and Sinks

606.1 General. Lavatories and sinks shall comply with 606.

Advisory 606.1 General. If soap and towel dispensers are provided, they must be located within the reach ranges specified in 308. Locate soap and towel dispensers so that they are conveniently usable by a person at the accessible lavatory.

606.2 Clear Floor Space. A clear floor *space* complying with 305, positioned for a forward approach, and knee and toe clearance complying with 306 shall be provided.

- **EXCEPTIONS: 1.** A parallel approach complying with 305 shall be permitted to a kitchen sink in a space where a cook top or conventional range is not provided and to wet bars.
- 2. A lavatory in a toilet room or bathing facility for a single occupant accessed only through a private office and not for common use or public use shall not be required to provide knee and toe clearance complying with 306.
- 3. In residential dwelling units, cabinetry shall be permitted under lavatories and kitchen sinks provided that all of the following conditions are met:
- (a) the cabinetry can be removed without removal or replacement of the fixture;
- (b) the finish floor extends under the cabinetry; and (c) the walls behind and surrounding the cabinetry are finished.
- 4. A knee clearance of 24 inches (610 mm) minimum above the finish floor or ground shall be permitted at lavatories and sinks used primarily by children 6 through 12 years where the rim or
- counter surface is 31 inches (785 mm) maximum above the finish floor or ground. **5.** A parallel approach complying with 305 shall be permitted to lavatories and sinks used primarily by children 5 years and younger.
- **6.** The dip of the overflow shall not be considered in determining knee and toe clearances. 7. No more than one bowl of a multi-bowl sink shall be required to provide knee and toe clearance complying with 306.

606.3 Height. Lavatories and sinks shall be installed with the front of the higher of the rim or counter surface 34 inches (865 mm) maximum above the finish floor or ground.

- **EXCEPTIONS:** 1. A lavatory in a toilet or bathing *facility* for a single occupant accessed only through a private office and not for common use or public use shall not be required to comply with
- 2. In residential dwelling unit kitchens, sinks that are adjustable to variable heights, 29 inches (735) mm) minimum and 36 inches (915 mm) maximum, shall be permitted where rough-in plumbing permits connections of supply and drain pipes for sinks mounted at the height of 29 inches (735

606.4 Faucets. Controls for faucets shall comply with 309. Hand-operated metering faucets shall remain open for 10 seconds minimum.

606.5 Exposed Pipes and Surfaces. Water supply and drain pipes under lavatories and sinks shall be insulated or otherwise configured to protect against contact. There shall be no sharp or abrasive surfaces under lavatories and sinks.

EXCEPTION: Braille provided on elevator car controls shall be separated 3/16 inch (4.8 mm)

minimum and shall be located either directly below or adjacent to the corresponding raised

REFUGE

Figure 703.3.2

Position of Braille

703.4.1 Height Above Finish Floor or Ground. *Tactile characters* on signs shall be located 48 inches (1220 mm) minimum above the finish floor or ground surface, measured from the baseline of

the lowest tactile character and 60 inches (1525 mm) maximum above the finish floor or ground

Figure 703.4.1

Height of Tactile Characters Above Finish Floor or Ground

EXCEPTION: Tactile characters for elevator car controls shall not be required to comply with

AREA OF

REFUGE_

703.4 Installation Height and Location. Signs with tactile characters shall comply with 703.4.

surface, measured from the baseline of the highest tactile character.

ADA Lavatories and Sinks

SCALE: 1' = 1'-0"

characters or symbols.



CALIFORNIA PUBLIC FACILITIES AND BUSINESSES:


NEW CALIFORNIA AB1732 RESTROOM SIGNS ARE REQUIRED

Any California restroom that is single-occupant (if you can lock the door behind you, it is a single-occupant restroom) must be designated with all gender accessible signs meeting AB1732 regulations.

Single-occupant/single-user restrooms that have gender-specific signs such as these on the wall

Will need one of these all gender or gender neutral signs to be compliant with AB1732

RESTROOM

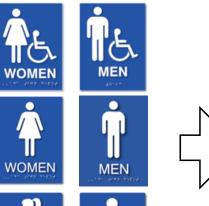












Single-occupant/single-user restrooms that have any gender-specific signs such as these on the door





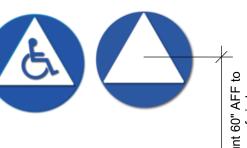

Will need one of these signs

Unisex Restroom Door Signage

A circle, 1/4 inch (6.4 mm) thick and 12 inches (305 mm) in diameter with a 1/4 inch (6.4 mm) thick triangle with a vertex pointing upward, superimposed on and geometrically inscribed within the circle and within the 12-inch (305 mm) diameter, shall be provided at entrances to unisex toilet and bathing facilities. The vertices of the triangle shall be located 1/4 inch (6.4 mm) maximum from the edge of the circle. The triangle symbol shall contrast with the circle symbol, either light on a dark background or dark on a light background. The circle symbol shall contrast with the door, either light on a dark background or dark on a light background.

ADA Inclusive Restroom Signage



SCALE: 1:1.60

703.4.1.

ADA Signage Mounting Height





Wall Section SCALE: 3" = 1'-0"

703.6.1 Pictogram Field. *Pictograms* shall have a field height of 6 inches (150 mm) minimum.

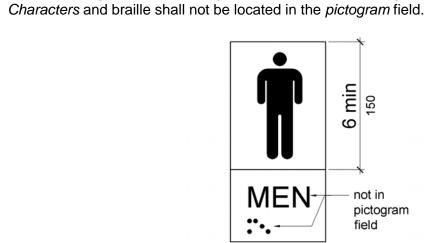


Figure 703.6.1 **Pictogram Field**

703.6.2 Finish and Contrast. *Pictograms* and their field shall have a non-glare finish. *Pictograms* shall contrast with their field with either a light pictogram on a dark field or a dark pictogram on a light

Advisory 703.6.2 Finish and Contrast. Signs are more legible for persons with low vision when characters contrast as much as possible with their background. Additional factors affecting the ease with which the text can be distinguished from its background include shadows cast by lighting sources, surface glare, and the uniformity of the text and background colors and textures.

703.6.3 Text Descriptors. Pictograms shall have text descriptors located directly below the pictogram field. Text descriptors shall comply with 703.2, 703.3 and 703.4.

703.7 Symbols of Accessibility. Symbols of accessibility shall comply with 703.7.

703.7.1 Finish and Contrast. Symbols of *accessibility* and their background shall have a non-glare finish. Symbols of accessibility shall contrast with their background with either a light symbol on a dark background or a dark symbol on a light background.

Advisory 703.7.1 Finish and Contrast. Signs are more legible for persons with low vision when characters contrast as much as possible with their background. Additional factors affecting the ease with which the text can be distinguished from its background include shadows cast by lighting sources, surface glare, and the uniformity of the text and background colors and textures.

1 Existing beam 2 Existing plywood


3 6" wide 15mil deflection track with 1 1/2" slots, attach with (2) #8 screws x 3 1/2" long at 24"oc 4 (2) #8 screws, (1) each side of stud 5 5/8" Type X gypsum board, fasten

with #8 screws at 6"oc edge and 12"oc field 6" wide 15mil steel studs at 24"oc

with 6" mineral wool batt (2) #8 screws, (1) each side of stud Midspan flat bracing

Future 5/8" Quiterock gypsum 10 6" wide15mil min. bottom track,

attach with (2) PAF at 24"oc 11 Existing concrete slab

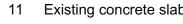



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