SONOMA ACADEMY VISUAL AND PERFORMING ARTS CENTER

2500 FARMERS LN, SANTA ROSA, CA 95404

DESIGN REVIEW MARCH 9, 2020



PROJECT TEAM

OWNER

Sonona Academy 2500 Farmers Lane Santa Rosa, CA 95404 Phone: 707-545-1770 Email: steve@vra-arch.com

ARCHITECT OF RECORD

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CIVIL ENGINEER

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maura@shalleck.com


QUATTROCCHI KWOK
ARCHITECTS

Main Office:
636 Fifth Street, Santa Rosa, CA 95404
Pleasanton Office:
600 Main Street, Suite E,
Pleasanton, CA 94566

SONOMA ACADEMY

VISUAL AND PERFORMING ARTS CENTER

2500 FARMERS LN SANTA ROSA, CA 95404

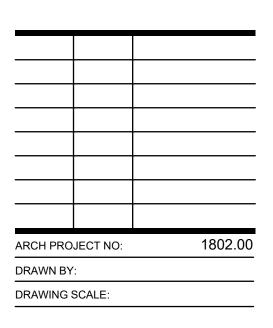

DESIGN REVIEW
MARCH 9, 2020

COVER SHEET

ARREVIATIONS

ABBREVIATIONS			
& L @ G	AND ANGLE AT CENTERLINE	GA GALV GB GC	GAUGE GALVANIZED GRAB BAR GENERAL CONTRACTOR
, - " d #	FEET INCHES PENNY POUND/ NUMBER	GI GL GLB GND GR GYP BD	GALVANIZED IRON GLASS/ GLAZING GLUE LAMINATED BEAM GROUND GRADE GYPSUM BOARD
ABBREV AC A/C ACC ACOUS AC T AD	ANCHOR BOLT ABBREVIATION ASPHALT CONCRETE AIR CONDITIONING ACCESSIBLE ACOUSTICAL ACOUSTICAL TILE AREA DRAIN	HB HC HDR HDWD HDWR HM	HOSE BIBB HOLLOW CORE HEADER HARDWOOD HARDWARE HOLLOW METAL
ADJ A.F.F. AGG ALUM ANOD APPROX ARCH ASPH	ADJUSTABLE ABOVE FINISH FLOOR AGGREGATE ALUMINUM ANODIZED APPROXIMATE ARCHITECTURAL ASPHALT	HOR HP HR HSS HT HTG HVAC	HORIZONTAL HIGH POINT HOUR HOLLOW STEEL SECTION HEIGHT HEATING HEATING, VENTILATING, AIR-CONDITIONING
BD BITUM BLDG BLK BLKG BM BOT	BOARD BITUMINOUS BUILDING BLOCK BLOCKING BEAM BOTTOM	ID INSUL INT INTEG INTERMED INV	INSIDE DIAMETER INSULATION INTERIOR INTEGRAL INTERMEDIATE INVERT
BO BRK BRG BTWN	BY OWNER BREAK BEARING BETWEEN	JH JST JT	JOIST HANGER JOIST JOINT
BU BUR CAB	BUILT-UP BUILT-UP ROOFING CABINET	KIT KP LAB	KITCHEN KICK PLATE LABORATORY
CB CBC CEM CER CI CIR	CATCH BASIN CALIFORNIA BUILDING CODE CEMENT CERAMIC CAST IRON CIRCLE	LAM LAV LL LP LT	LAMINATE LAVATORY LIVE LOAD LOW POINT LIGHT
CJ CORR CL CLG CLR CLS CMU CO	CONTROL JOINT CORRIDOR CLOSET/ CENTER LINE CEILING CLEAR CLOSURE CONCRETE MASONRY UNIT CLEANOUT	MAT MAX MB MC MECH MED MEMB MFR	MATERIAL MAXIMUM MACHINE BOLT MEDICINE CABINET MECHANICAL MEDIUM MEMBRANE MANUFACTURER
COL COMB COMP CONC CONN CONST	COLUMN COMBINATION COMPOSITION CONCRETE CONNECTION CONSTRUCTION	MH MIN MIR MISC MO MOD MR	MANHOLE MINIMUM MIRROR MISCELLANEOUS MASONRY OPENING MODULAR MOISTURE RESISTANT
CONT CONTR CT CTR CTSK CUST CW	CONTINUOUS CONTRACTOR CERAMIC TILE CENTER COUNTERSINK CUSTODIAN COLD WATER	MTD MTL MUL N (N)	MOUNTED METAL MULLION NORTH NEW
DBL DEPT DET DF	DOUBLE DEPARTMENT DETAIL DRINKING FOUNTAIN	NAT N.I.C. NO NOM N.T.S.	NATURAL NOT IN CONTRACT NUMBER NOMINAL NOT TO SCALE
DG DI DIA	DECOMPOSED GRANITE DRAIN INLET DIAMETER	O/ OA OBS OC	OVER OVERALL OBSCURE ON CENTER
DIAG DIM DISP DIV DN DO	DIAGONAL DIMENSION DISPOSAL DIVISION DOWN DOOR OPENING	OD OF OFCI O.L.F.	OUTSIDE DIAMETER OVERFLOW OWNER FURNISHED/ CONTRACTOR INSTALLED OCCUPANT LOAD FACTOR OFFICE
DIR DR DSA DS DSP DT	DIRECTLY DOOR DIVISION OF STATEARCHITECT DOWN SPOUT DRY STAND PIPE DRAIN TILE	OPNG OPP OVHD	OPENING OPPOSITE OVERHEAD PORTLAND CEMENT
DW DWG DWR	DISHWASHER DRAWING DRAWER EAST	P.C.F. PDA PERF PH PL P/L	POUNDS PER CUBIC FOOT POWER DRIVEN ANCHOR PERFORATED PLATE HEIGHT PLATE PROPERTY LINE
(E) EA EB EE EF EJ	EXISTING EACH EXPANSION BOLT EACH END EXHAUST FAN EXPANSION JOINT	PLAM PLAS PLF PLYWD P.O.C. PR	PLASTIC LAMINATE PLASTER/ PLASTIC POUNDS PER LINEAL FOOT PLYWOOD POINT OF CONTACT PAIR
EL ELEC ELEV EMER EMT ENCL	ELEVATION GRADE ELECTRICAL ELEVATION EMERGENCY ELECTRIC METALLIC TUBING ENCLOSURE	PROP PSF PSI PT PTDF	PROPERTY POUNDS PER SQUARE FOOT POUNDS PER SQUARE INCH POINT PRESSURE TREATED DOUGLAS FIR
EP EQ EQUIP EQUIV ES EW	ELECTRIC PANEL EQUAL EQUIPMENT EQUIVALENT EACH SIDE EACH WAY	PTN PTR PVC PVMT	PARTITION PAPER TOWEL RECEPTACLE POLYVINYL CHLORIDE PAVEMENT
EXH EXIST EXP EXT	EXHAUST EXISTING EXPANSION EXTERIOR	R R / RAD RD REF REFR REG	RISER RADIUS ROOF DRAIN REFERENCE REFRIGERATOR REGULAR
FA FCO FD FDN	FIRE ALARM FLOOR CLEAN OUT FLOOR DRAIN FOUNDATION	REQD REINF RH RHMS RHWS	REQUIRED REINFORCED ROOF HATCH ROUND HEAD MACHINE SCREW ROUND HEAD WOOD SCREW
FE FEC FF FG FGL	FIRE EXTINGUISHER FIRE EXTINGUISHER CABINET FINISH FLOOR FINISH GRADE FIBERGLAS FIRE HYDRANT	RM RO RWL RWD	ROOM ROUGH OPENING RAIN WATER LEADER REDWOOD
FHMS FHS FHWS FIN FIXT FL	FLAT HEAD MACHINE SCREW FIRE HOSE STATION FLAT HEAD WOOD SCREW FINISH FIXTURE FLOOR LINE		

FLASHING

FACE NAIL

FRAMING FIRE-RESISTANT

FEET FOOTING

FURRING

FLOOR FM / FOM FACE OF MASONRY

FLUORESCENT

FACE OF CONCRETE

FIBERGLASS REINFORCED

FACE OF FINISH

FACE OF STUD

FLASH

FLUOR

FLR

FRMG

FURR

LEGEND

SOUTH

SOLID CORE

SCHEDULE

SECTION

SHOWER

SHEATHING SIMILAR SLIDING

SHEET METAL

SHUT OFF VALVE

SPECIFICATION

STAINLESS STEEL

SPEAKER

SQUARE

STATION

STANDARD STEEL

STORAGE

TREAD

STRUCTURAL

SUSPENDED

SYMMETRICAL

TOP & BOTTOM

TOP OF CURB

TONGUE & GROOVE

TELEPHONE

TERRAZZO

THICK

THROUGH

TOE NAIL

TOOL JOINT

TOP OF DECK

TOP OF PLATE

TOP OF ROOF

TRANSPARENT

TUBE STEEL

TOP OF PAVEMENT

TOP OF WALL

TRANSOM

TUBULAR

TACKWALL

TYPICAL

URINAL

UTILITY

VERTICAL

WEST

WITH

WOOD

WINDOW WATER HEATER

WITHOUT

WAINSCOT WEIGHT

YARD

VESTIBULE

TELEVISION

UNFINISHED

VAPOR BARRIER

VERIFY IN FIELD

WATER CLOSET

WATER PROOF

WATER RESISTANT

WORK POINT

UNLESS OTHERWISE NOTED

VINYL COMPOSITION TILE

VENT THROUGH ROOF

VINYL WALL COVERING

STORM DRAIN

SEPARATION

SEE CIVIL DRAWINGS

SEE ARCHITECTURAL DRAWINGS

SEE AUDIOVIDEO DRAWINGS

SEE ELECTRICAL DRAWINGS

SEE LANDSCAPE DRAWINGS

SEE MECHANICAL DRAWING

SEE PLUMBING DRAWINGS

SEE STRUCTURAL DRAWINGS

SEE THEATER DRAWINGS

S.A.D.

S.AV.D.

S.C.D.

SECT

S.E.D.

SEP

SHR

SHTG

S.L.D.

S.M.D.

SOV

S.P.D.

SPEC

SPKR

S.S.D.

S.TH.D.

STA

STD

STL STOR

STRUCT

SUSP

SYM

T&B

TER

T&G

THRU

T.O.D.

T.O.P.

T.O.R.

T.O.W.

TRANS

U.O.N.

UTIL

VCT

V.I.F.

VTR

VWC

WSCT

VERT

TUB

T.P.

SCHED

ALL NOTES AND SYMBOLS ARE INTENDED TO APPLY AT ALL OTHER LOCATIONS OF SIMILAR GRAPHIC REPRESENTATION. SUCH INDICATIONS MAY BE LIMITED TO PROMOTE CLARITY. NO LIMITATION OF APPLICATION IS INTENDED EXCEPT AS SPECFICALLY NOTED.

COLUMN GRIDS A AND 1 IN BUILDING A DIMENSION TO FACE OF STUD OR MASONRY DIMENSION TO FACE OF FINISH


DIMENSION TO CENTER LINE OR COLUMN LINE

RELATIVE ELEVATION DIMENSION


DOOR A IN ROOM NUMBER 101 IN BUILDING B

ACCESSIBLE CLEARANCES SHOWN DASHED

WINDOW NUMBER 009

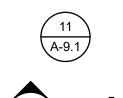

DETAIL NUMBER 11 ON SHEET NUMBER A-9.1

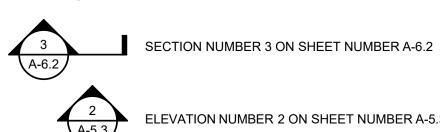

ELEVATION NUMBER 2 ON SHEET NUMBER A-5.3

CLASSROOM **FLOOR** PLAN **CLASSROOM** ROOM NAME

ROOM NUMBER 204 IN BUILDING A FLOOR FINISH CODE F-4 INTERIOR ELEVATION SHOWN ON SHEET A-7.6

REFLECTED ROOM NUMBER 204 IN BUILDING A CEILING FINISH CODE CL-6 CLG PLAN FINISH CEILING HEIGHT 10'-0" **KEYNOTE NUMBER 33**


METAL WALL FRAMING SIZE 8"

WALL ACOUSTIC RATING OF STC 50 TOILET ACCESSORY C

ARCHITECTURAL WOODWORK STANDARDS (AWS)
CABINET DESIGN SERIES IDENTIFIER FINISH CODE, WALL FINISH 2 SHOWN

ROOM / BUILDING ACCESSIBLE SIGNAGE TYPE E1. SEE ARCHITECTURAL GRAPHICS PLAN AND ACCESSIBLE SIGNAGE DETAIL

VICINITY MAP

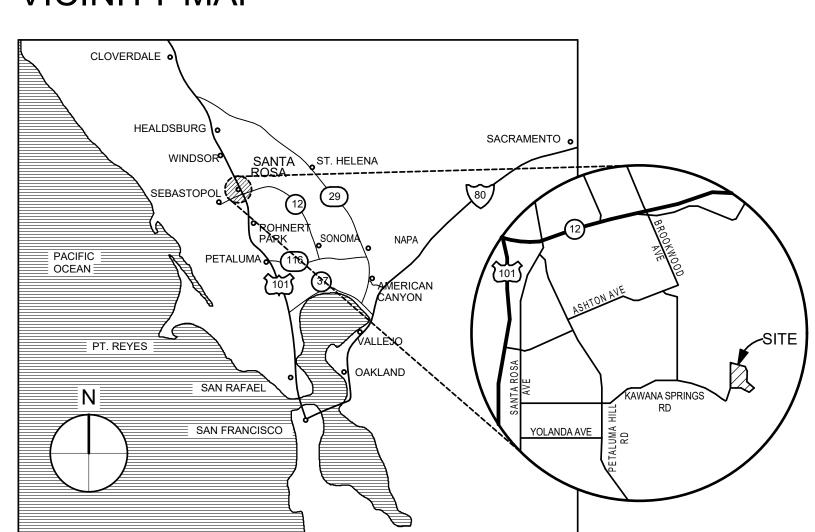

PROJECT DESCRIPTON

THE PROJECT CONSISTS OF A NEW PERFORMING ARTS BUILDING WITH ASSOCIATED SITE WORK. AT SONOMA ACADEMY IN SANTA ROSA, CALIFORNIA. THE BUILDING WILL BE FULLY SPRINKLERED, TYPE II-B CONSTRUCTION. THERE WILL BE A 450 SEAT HOUSE INCLUDING A MEZZANINE, STAGE, CLASSROOM/GREEN ROOM, REHEARSAL SPACE, RESTROOMS, SCENE SHOP, STORAGE AND UTILITY SPACES, AND A SMALL ENTRY LOBBY. SITE WORK WILL INCLUDE UPPER AND LOWER ENTRY PLAZAS, GARDEN AREAS, STAIRS BETWEEN THE PLAZAS, AND SITE LIGHTING, PROVIDING ACCESSIBILITY TO THE BUILDING.

DESIGN CONCEPT NARRATIVE

The design for the new Performing Arts Center (PAC) is comprised of a 350 seat performance hall (with 100 additional seats available in mezzanine and orchestra pit areas) and support academic teaching spaces. This building will support the vibrant arts program and provide a much needed "community space" where the whole school can come together regularly. The PAC will complete the campus plaza and form.

Inspired By Place

The new PAC is located in roughly the same place as the (previously approved) 2015 design and connects directly to the existing Guild and Commons building (GAC) completed in 2018. The primary difference from the 2015 design is that the new PAC shifts it's orientation from East/West to North South and increases the setback from the West. This revision works with the existing topography and will significantly reduce earthwork excavation, retaining, and offhaul. The new design orients the building entry toward the upper-campus's central plaza facing the Music, Library, Administration and Dining buildings - reinforcing the heart of campus.

Great care has been taken to help this building fit in to its place. Heights of various building elements are tuned to enhance the building program, support existing campus spaces, and reduce its visual impact from the surrounding neighborhood. The tallest volume of the House is defined with "softer" geometries that help support the acoustic of the performance space as well as reduce its visual impact. The subtle curve of the parapet rolls from north to south and helps frame views of the hills to the east. The 4 walls of the House each gently bend inward - forming curved surfaces that will play with sunlight and shadow in stark contrast to the "blunt" western façade of the existing Gymnasium.

Pre-function, support, teaching and learning spaces embrace the House and are connected to one another under a lower "flat" roof that mirrors and aligns with the roof of the GAC to the South. These program spaces are placed in front of the lager house volume thereby visually articulating and reducing the overall mass of the building. Like the GAC, this lower roof extends past the façade of the building to shade windows and create a covered entry "porch" that helps scale the project into campus plaza. The lower level of the PAC is comprised mechanical and storage spaces that directly engage the lower level of the GAC and help frame the lower campus Garden.

The PAC takes is cues from the existing campus buildings, which is comprised of board and batten and wood rain screen siding, "zinc" metal cladding, cross laminated timber (CLT), cement plaster, and exposed concrete masonry units (CMU). The palette is simple and robust and will be designed to last and reduce maintenance. The palette aims to reflect and compliment the natural and rugged nature of the site.

Sustainability

BUILDING ADDRESS:

The project is designed to resource efficient, healthy, and regionally relevant. Building systems work in concert with the building envelope to help reduce energy and water use. Views and daylighting are incorporated in to every occupied spaces to help connect students and staff to their place and the natural cycles of the day. Windows and skylights help reduce the need for artificial illumination and low flow fixtures will greatly reduce potable water use. Interior finish materials, like the GAC, will bias toward local suppliers and illuminate the use of toxic and harmful chemicals.

SONOMA ACADEMY

PROJECT DATA

	2500 FARMERS LANE SANTA ROSA, CA 95404
PARCEL NUMBER:	044-180-016
ZONE:	PD - 96-001D
SITE AREA:	33.8 ACRES (1,472,328 SF)
EXISTING SITE COVERAGE:	61,595 GSF (SITE COVERAGE) - 4.3%
PROPOSED NEW BUILDING FOOTPRINT:	18,945 GSF - 1.2%
PROPOSED TOTAL SITE COVERAGE:	80,540 GSF (SITE COVERAGE) - 5.5%
EXISTING BUILDING AREA:	119,488 GSF (ALL FLOORS)
EXISTING BOILDING AREA.	110,400 GOI (ALL'I LOOKG)
PROPOSED NEW BUILDING AREA:	26,930 GSF (ALL FLOORS)
PROPOSED TOTAL BUILDING AREA:	146,418 GSF
OCCUPANCY:	A-1 / E

PARKING COUNT

CONSTRUCTION TYPE:

ALL PARKING IS EXISTING. NO NEW PARKING PLANNED WITH THE PERFORMING ARTS CENTER PROJECT.

IIB - SPRINKLED

	REQUIRED	PROVIDED
TOTAL PARKING: SCHOOL USE	0.33 X 185 STUDENTS + 1 X 56 STAFF = 151 REQUIRED	169 PROVIDED
TOTAL PARKING: PUBLIC ASSEMBLY AT THEATER	110 SPACES REQUIRED PER TABLE 3-4 NON-CONCURRENT WITH SCHOOL USE	169 PROVIDED
LEV / FEV VEHICLES	10% X 169 = 17 REQUIRED	17 PROVIDED
ACCESSIBLE PARKING CBC 11B-208.2	7 REQUIRED 2 VAN SPACES	7 ACCESSIBLE SPACES PROVIDED, 2 VAN

SHEET INDEX

GENERAL	
G-0.1	COVER SHEET
G-0.2	SHEET INDEX AND NOTES
G-0.3	SITE MAPS AND PHOTOS
G-0.4	OVERALL CAMPUS PLAN
G-0.5	UPPER AND LOWER PLAZA PLANS
G-0.6	RENDERINGS
G-0.7	MATERIALS / COLOR
G-0.8	MATERIALS / COLOR

CIVIL SHEETS REVISE NOVEMBER, 202

	CIVIL	
	C1	PRELIMINARY GRADING PLAN LOWER LEVEL
	C2	PRELIMINARY GRADING PLAN MAIN LEVEL
ED	C3	PRELIMINARY GRADING PLAN UPPER ORCHARD
20	C4	PRELIMINARY UTILITY PLAN
	C5	PRELIMINARY UTILITY PLAN
	C6	BIORETENTION PLAN

LANDSCAPI	E
L0.01	SCOPE OF WORK, SHEET LAYOUT, AND SHEET LIST
L0.02	TREE REMOVALAND PROTECTION PLAN
L1.00	MATERIALS LEGEND
L1.01	MATERIALS PLAN
L1.02	MATERIALS PLAN
L2.03	CONSTRUCTION DETAILS - SECTIONS
L3.00	IRRIGATION LEGEND
L3.01	IRRIGATION PLAN
L3.02	IRRIGATION PLAN
L6.00	PLANTING LEGEND
L6.01	PLANTING PLAN

L6.02

ELECTRICAL	-
E-0.2	LUMINAIRE SCHEDULE
E-1.2	SITE PLAN - LIGHTING - LOWER PLAZA
E-1.3	SITE PLAN - LIGHTING - UPPER PLAZA
E-2.1	GROUND FLOOR PLAN - LIGHTING
E-2.3	MAIN FLOOR PLAN - LIGHTING

PLANTING PLAN

ARCHITECTURAL

A-2.1	GROUND FLOOR AND ORCH PIT PLAN
A-2.2	MAIN FLOOR PLAN
A-2.3	MEZZANINE FLOOR PLAN
A-2.4	CATWALK FLOOR PLAN
A-5.1	EXTERIOR ELEVATIONS
A-5.2	EXTERIOR ELEVATIONS
A-6.1	BUILDING SECTIONS
A-6.2	BUILDING SECTIONS
A-6.3	BUILDING SECTIONS
A-6.4	WALL SECTIONS

ATTACHMENTS (8.5 X 11)

PRELIMINARY STORM WATER LOW IMPACT DEVELOPMENT REPORT LUMINAIRE CATALOG PAGES

QUATTROCCHI KWOK ARCHITECTS Main Office: 636 Fifth Street, Santa Rosa, CA 95404

Pleasanton Office:

600 Main Street, Suite E,


Pleasanton, CA 94566

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SONOMA **ACADEMY**

VISUAL AND PERFORMING ARTS CENTER


2500 FARMERS LN SANTA ROSA, CA 95404

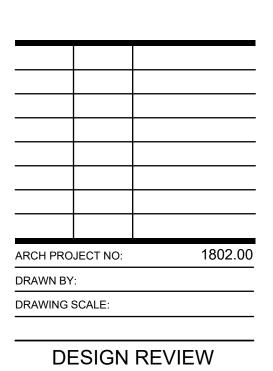


SHEET INDEX AND **NOTES**

MARCH 9, 2020

NEIGHBORHOOD CONTEXT / LOCATION MAP

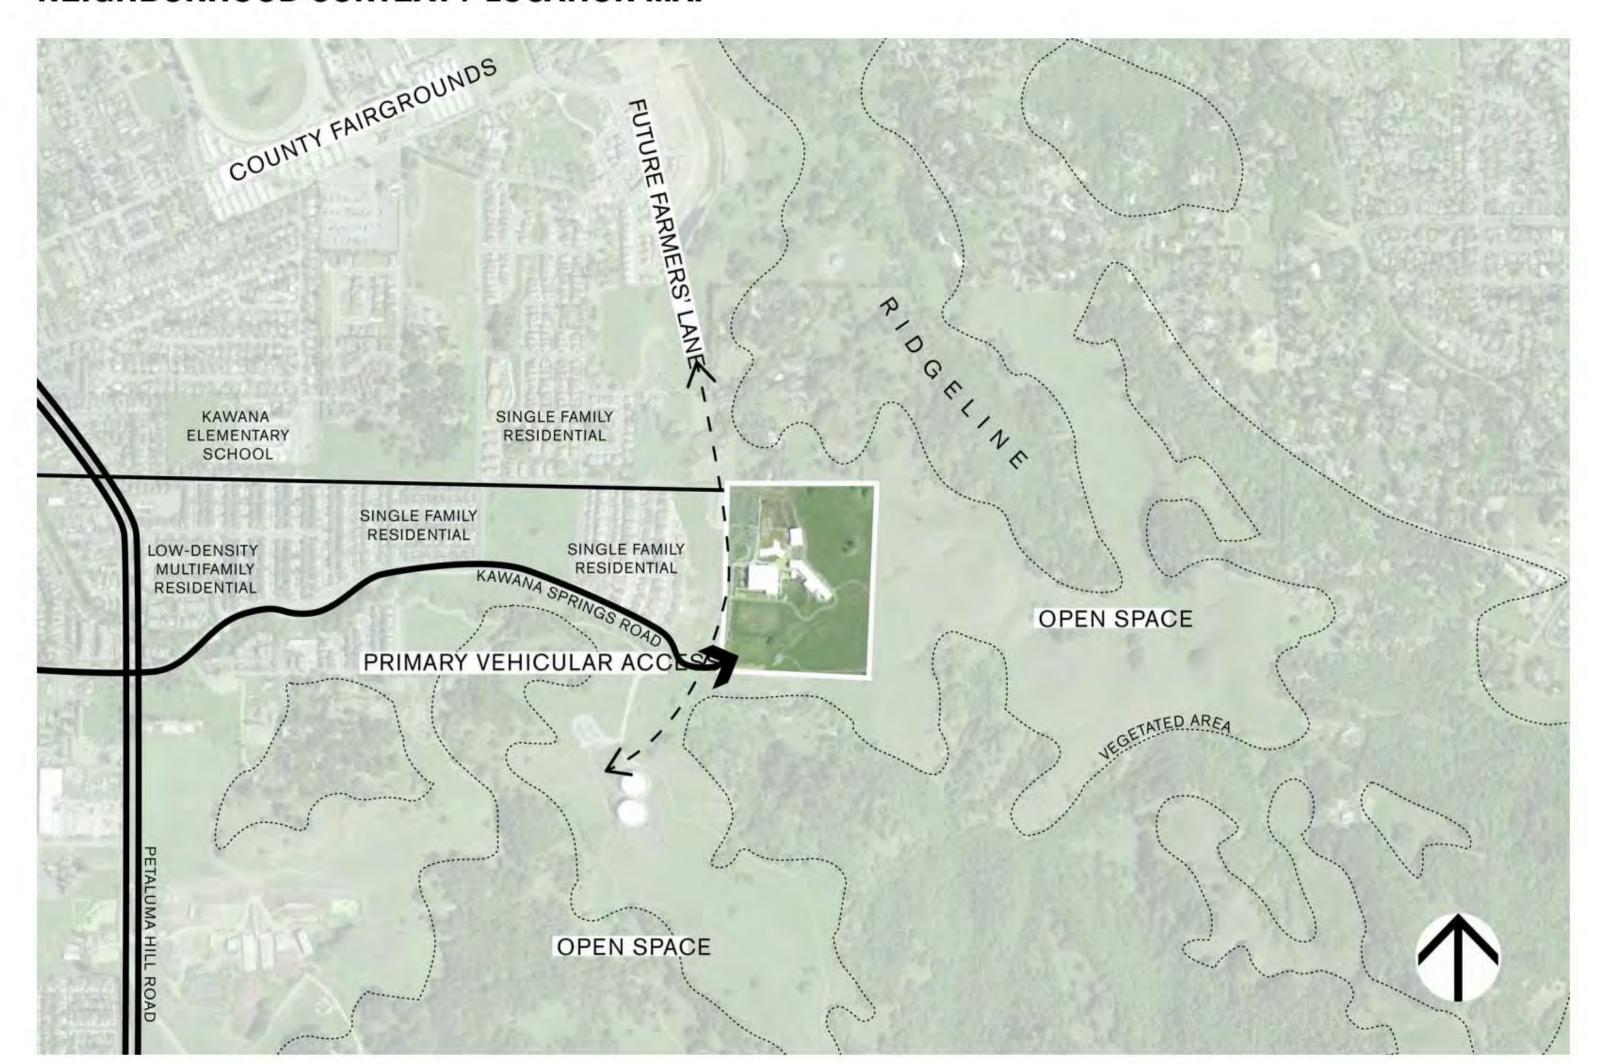


SITE ANALYSIS

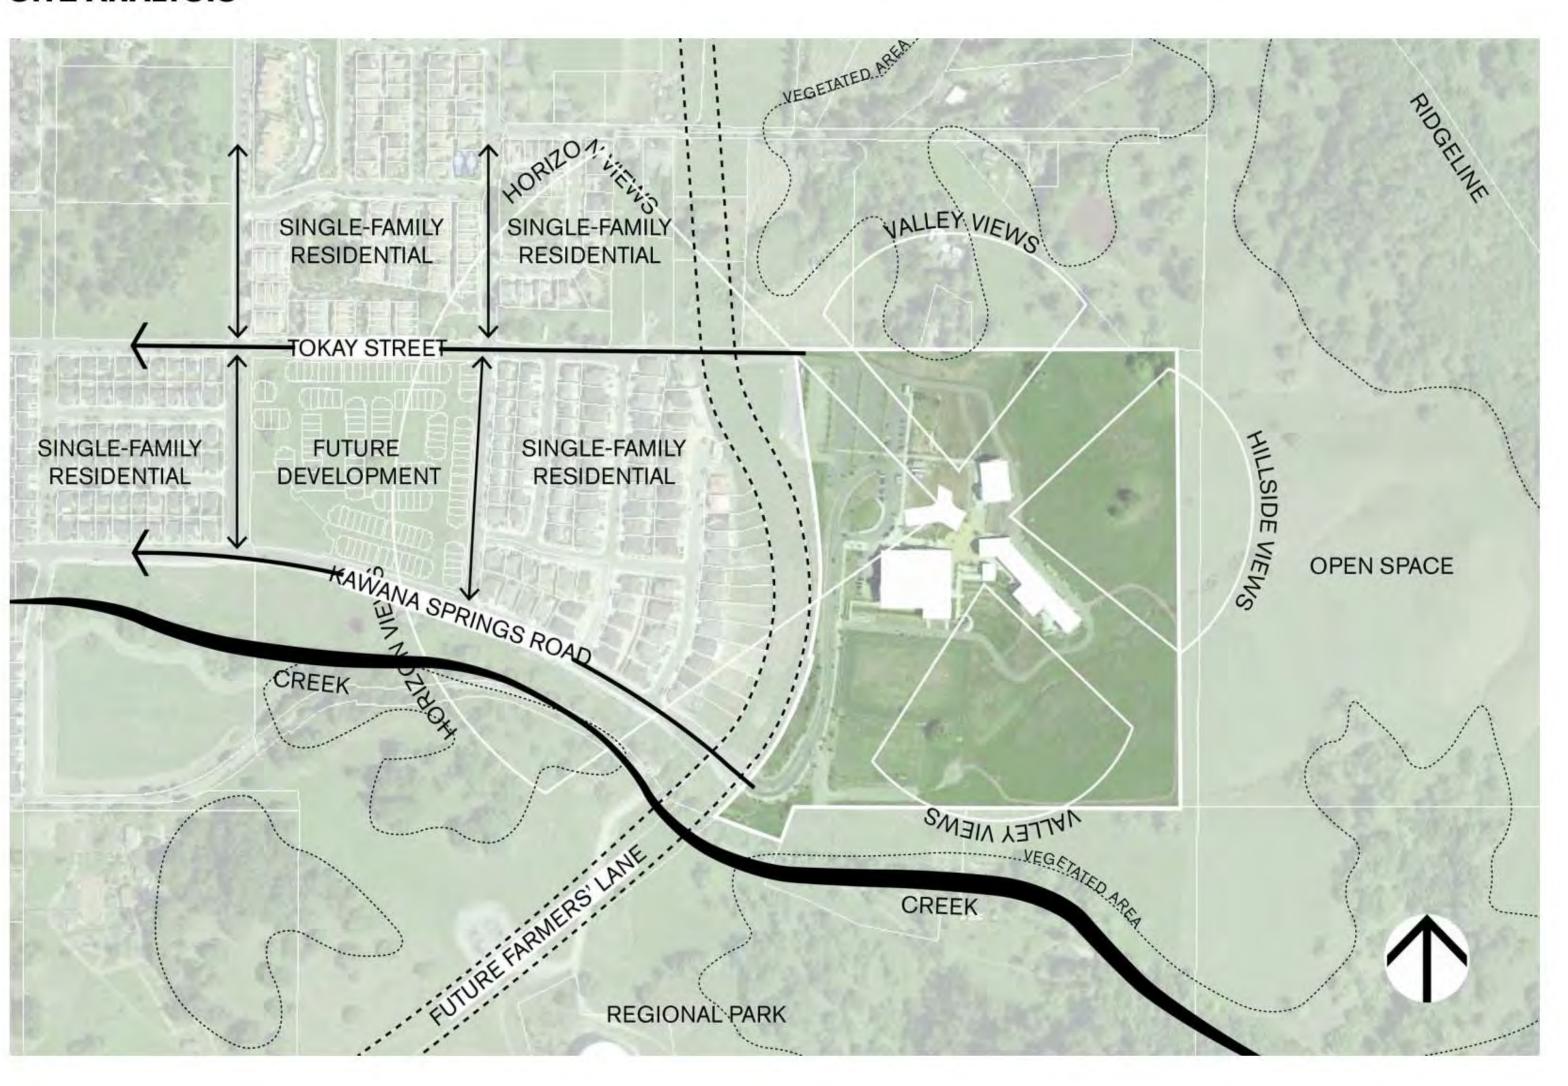


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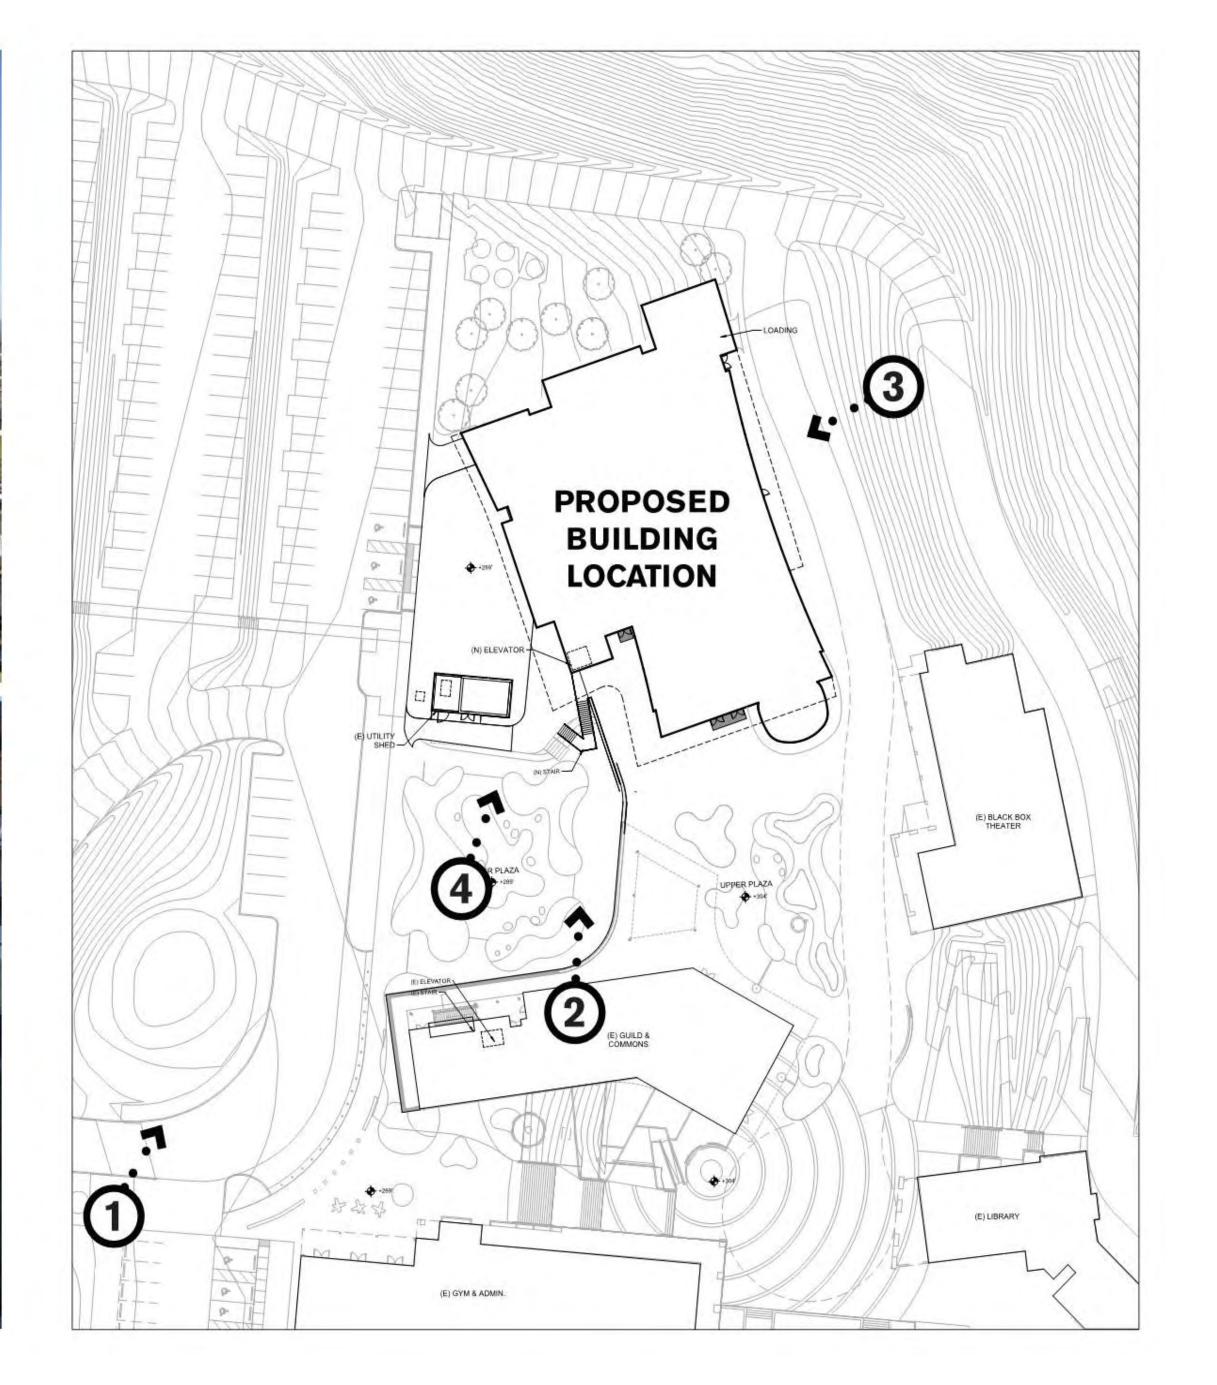
SITE PHOTOS



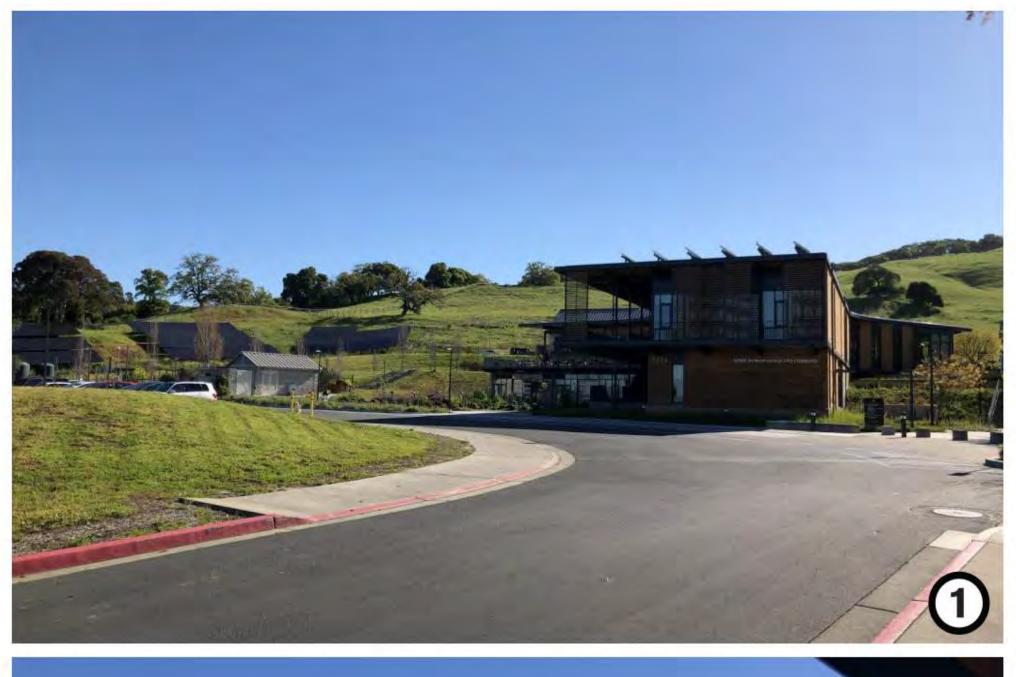



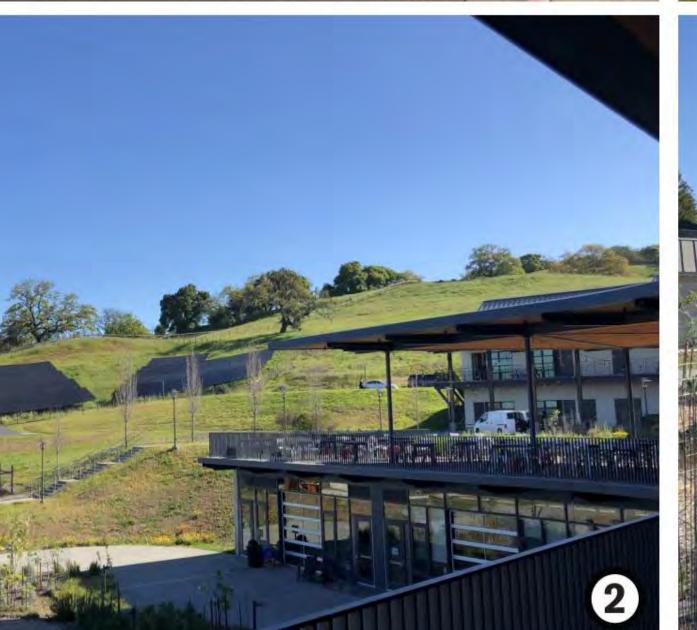




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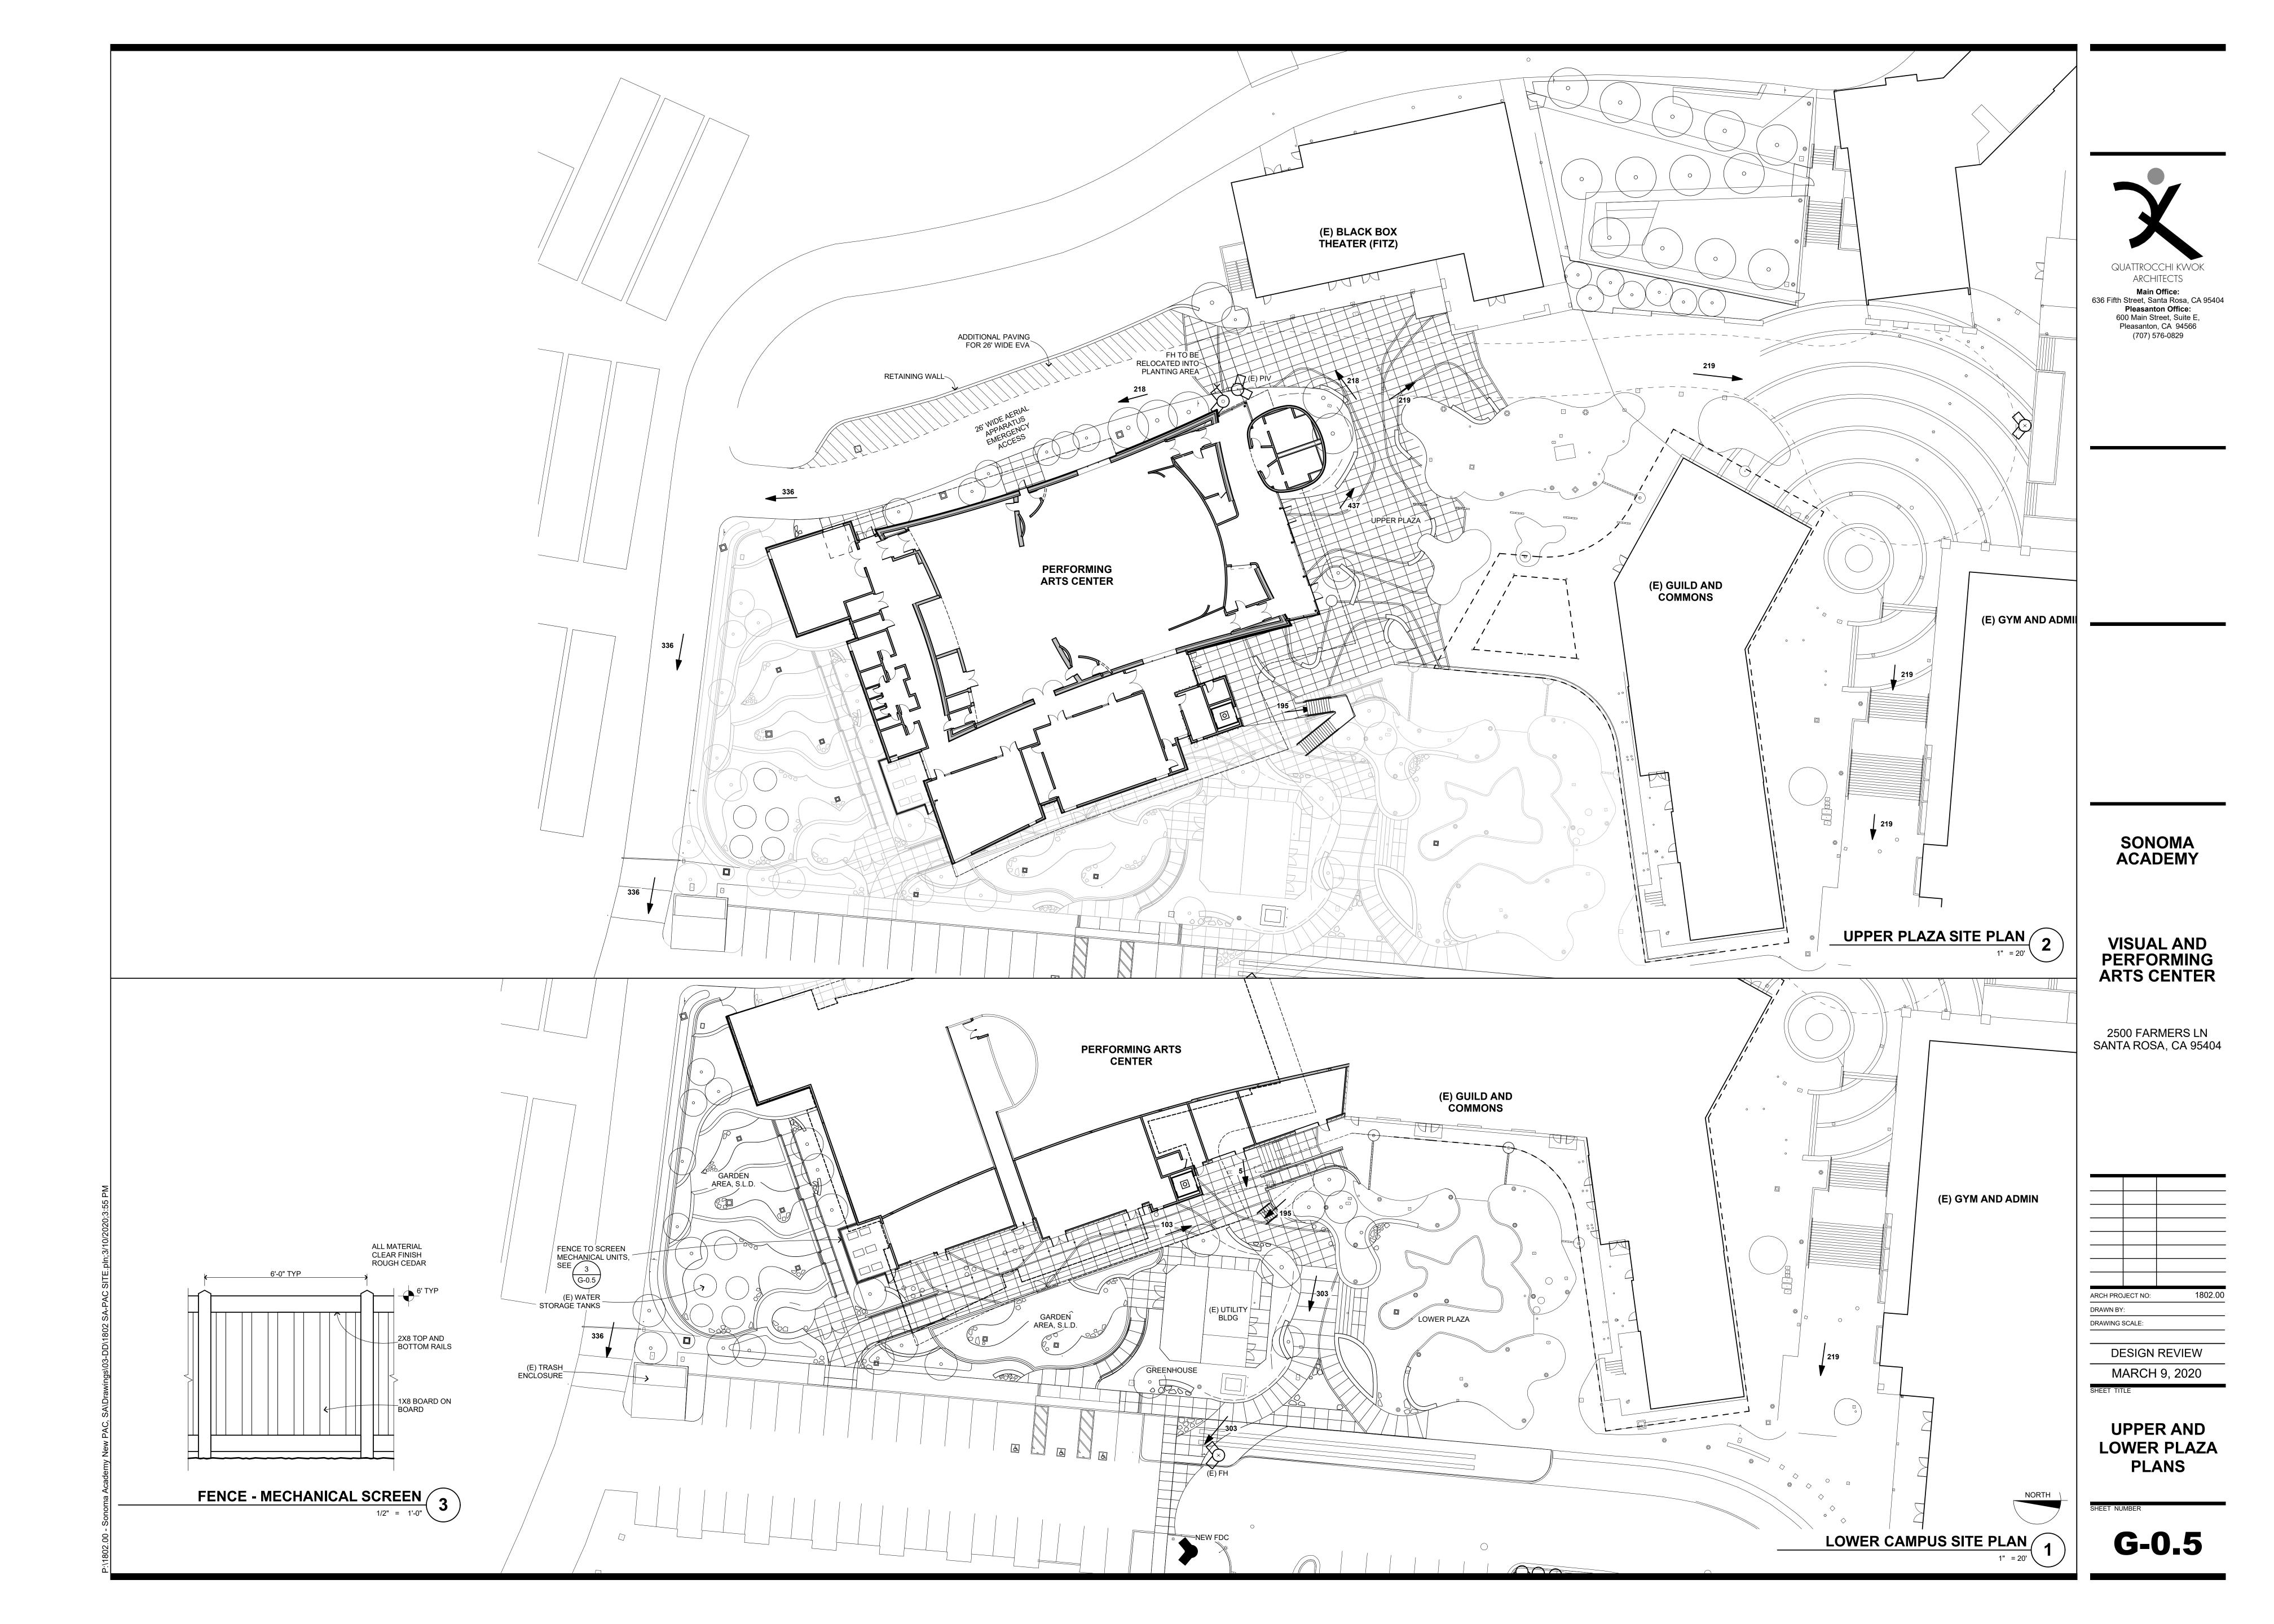
DESIGN REVIEW
MARCH 9, 2020

HEET TITLE

SITE MAPS AND PHOTOS

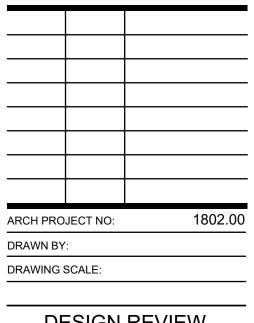SHEET NUMBE










VIEW FROM THE GUILD AND COMMONS



VISUAL AND PERFORMING ARTS CENTER

2500 FARMERS LN SANTA ROSA, CA 95404

AERIAL VIEW

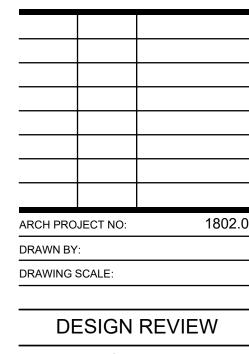

MARCH 9, 2020

RENDERINGS

G-0.6

LOWER GARDEN




NORTH ELEVATION PERSPECTIVE, N.T.S.

NORTH ELEVATION PERSPECTIVE, N.T.S.





TEXTURED CEMENT PLASTER

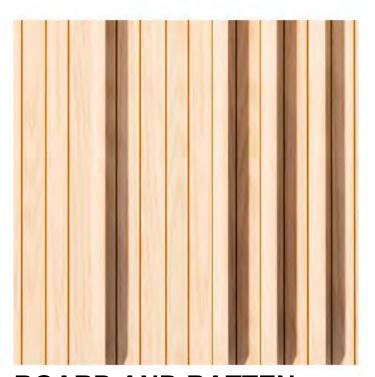


BOARD AND BATTEN



CONCRETE BLOCK



PAINTED METAL

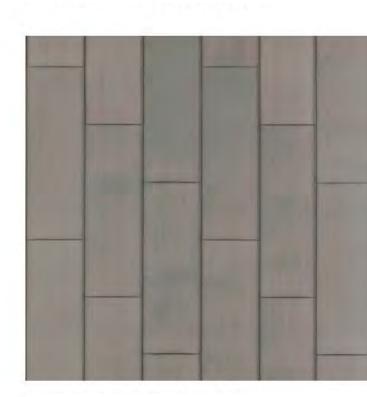

ZINC PANELING



BOARD-FORMED CONCRETE

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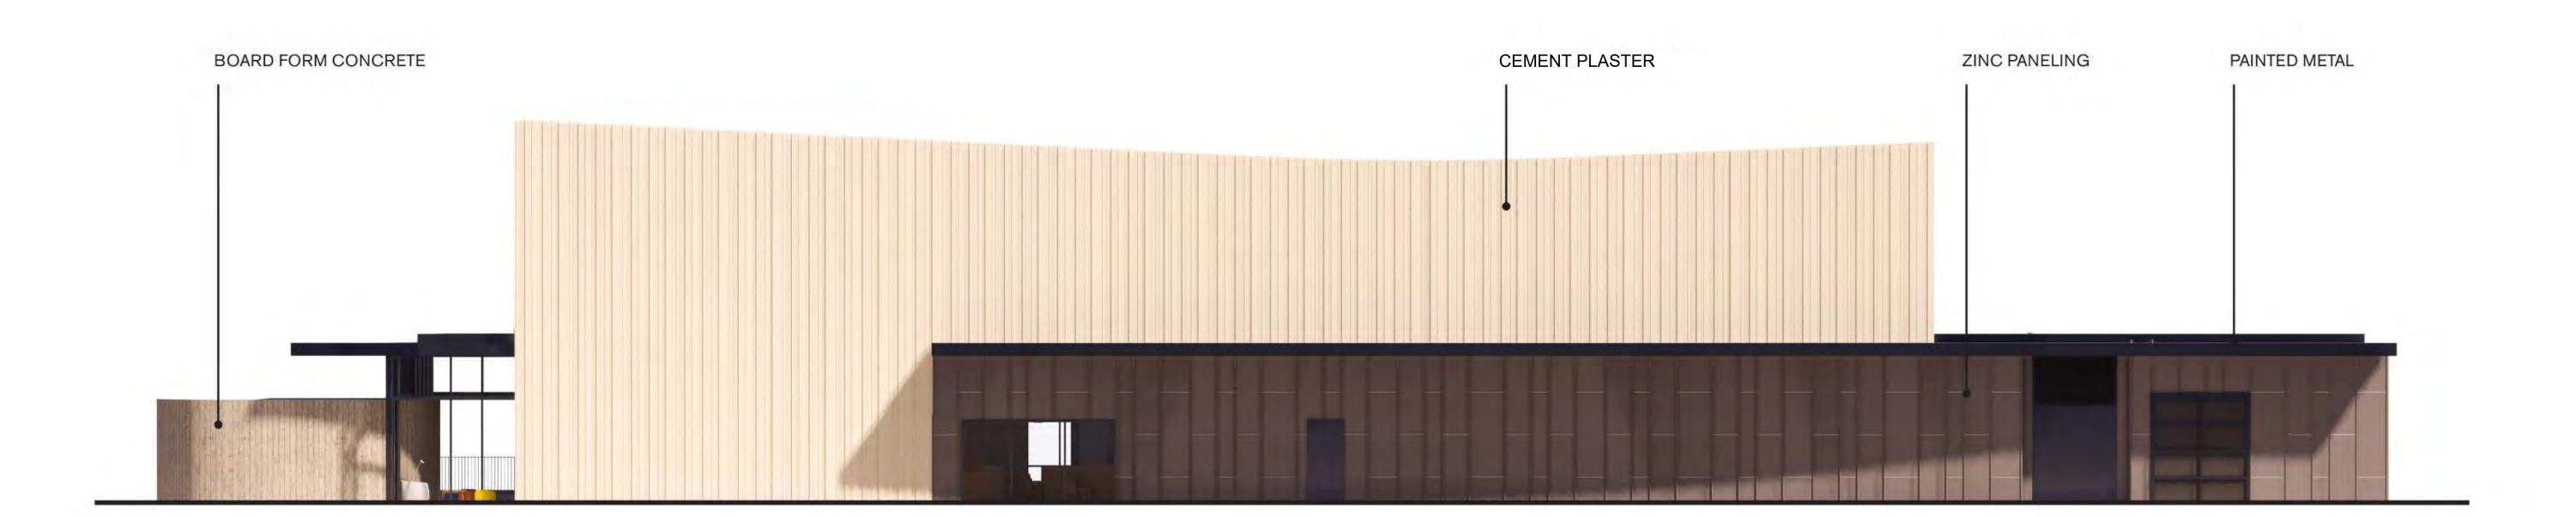
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RAWN BY	:	
RAWING	SCALE:	
DESIGN REVIEW		
MARCH 9, 2020		

MATERIALS / COLOR

IEET NUMBER



WEST ELEVATION PERSPECTIVE, N.T.S.



EAST ELEVATION PERSPECTIVE, N.T.S.



TEXTURED CEMENT PLASTER




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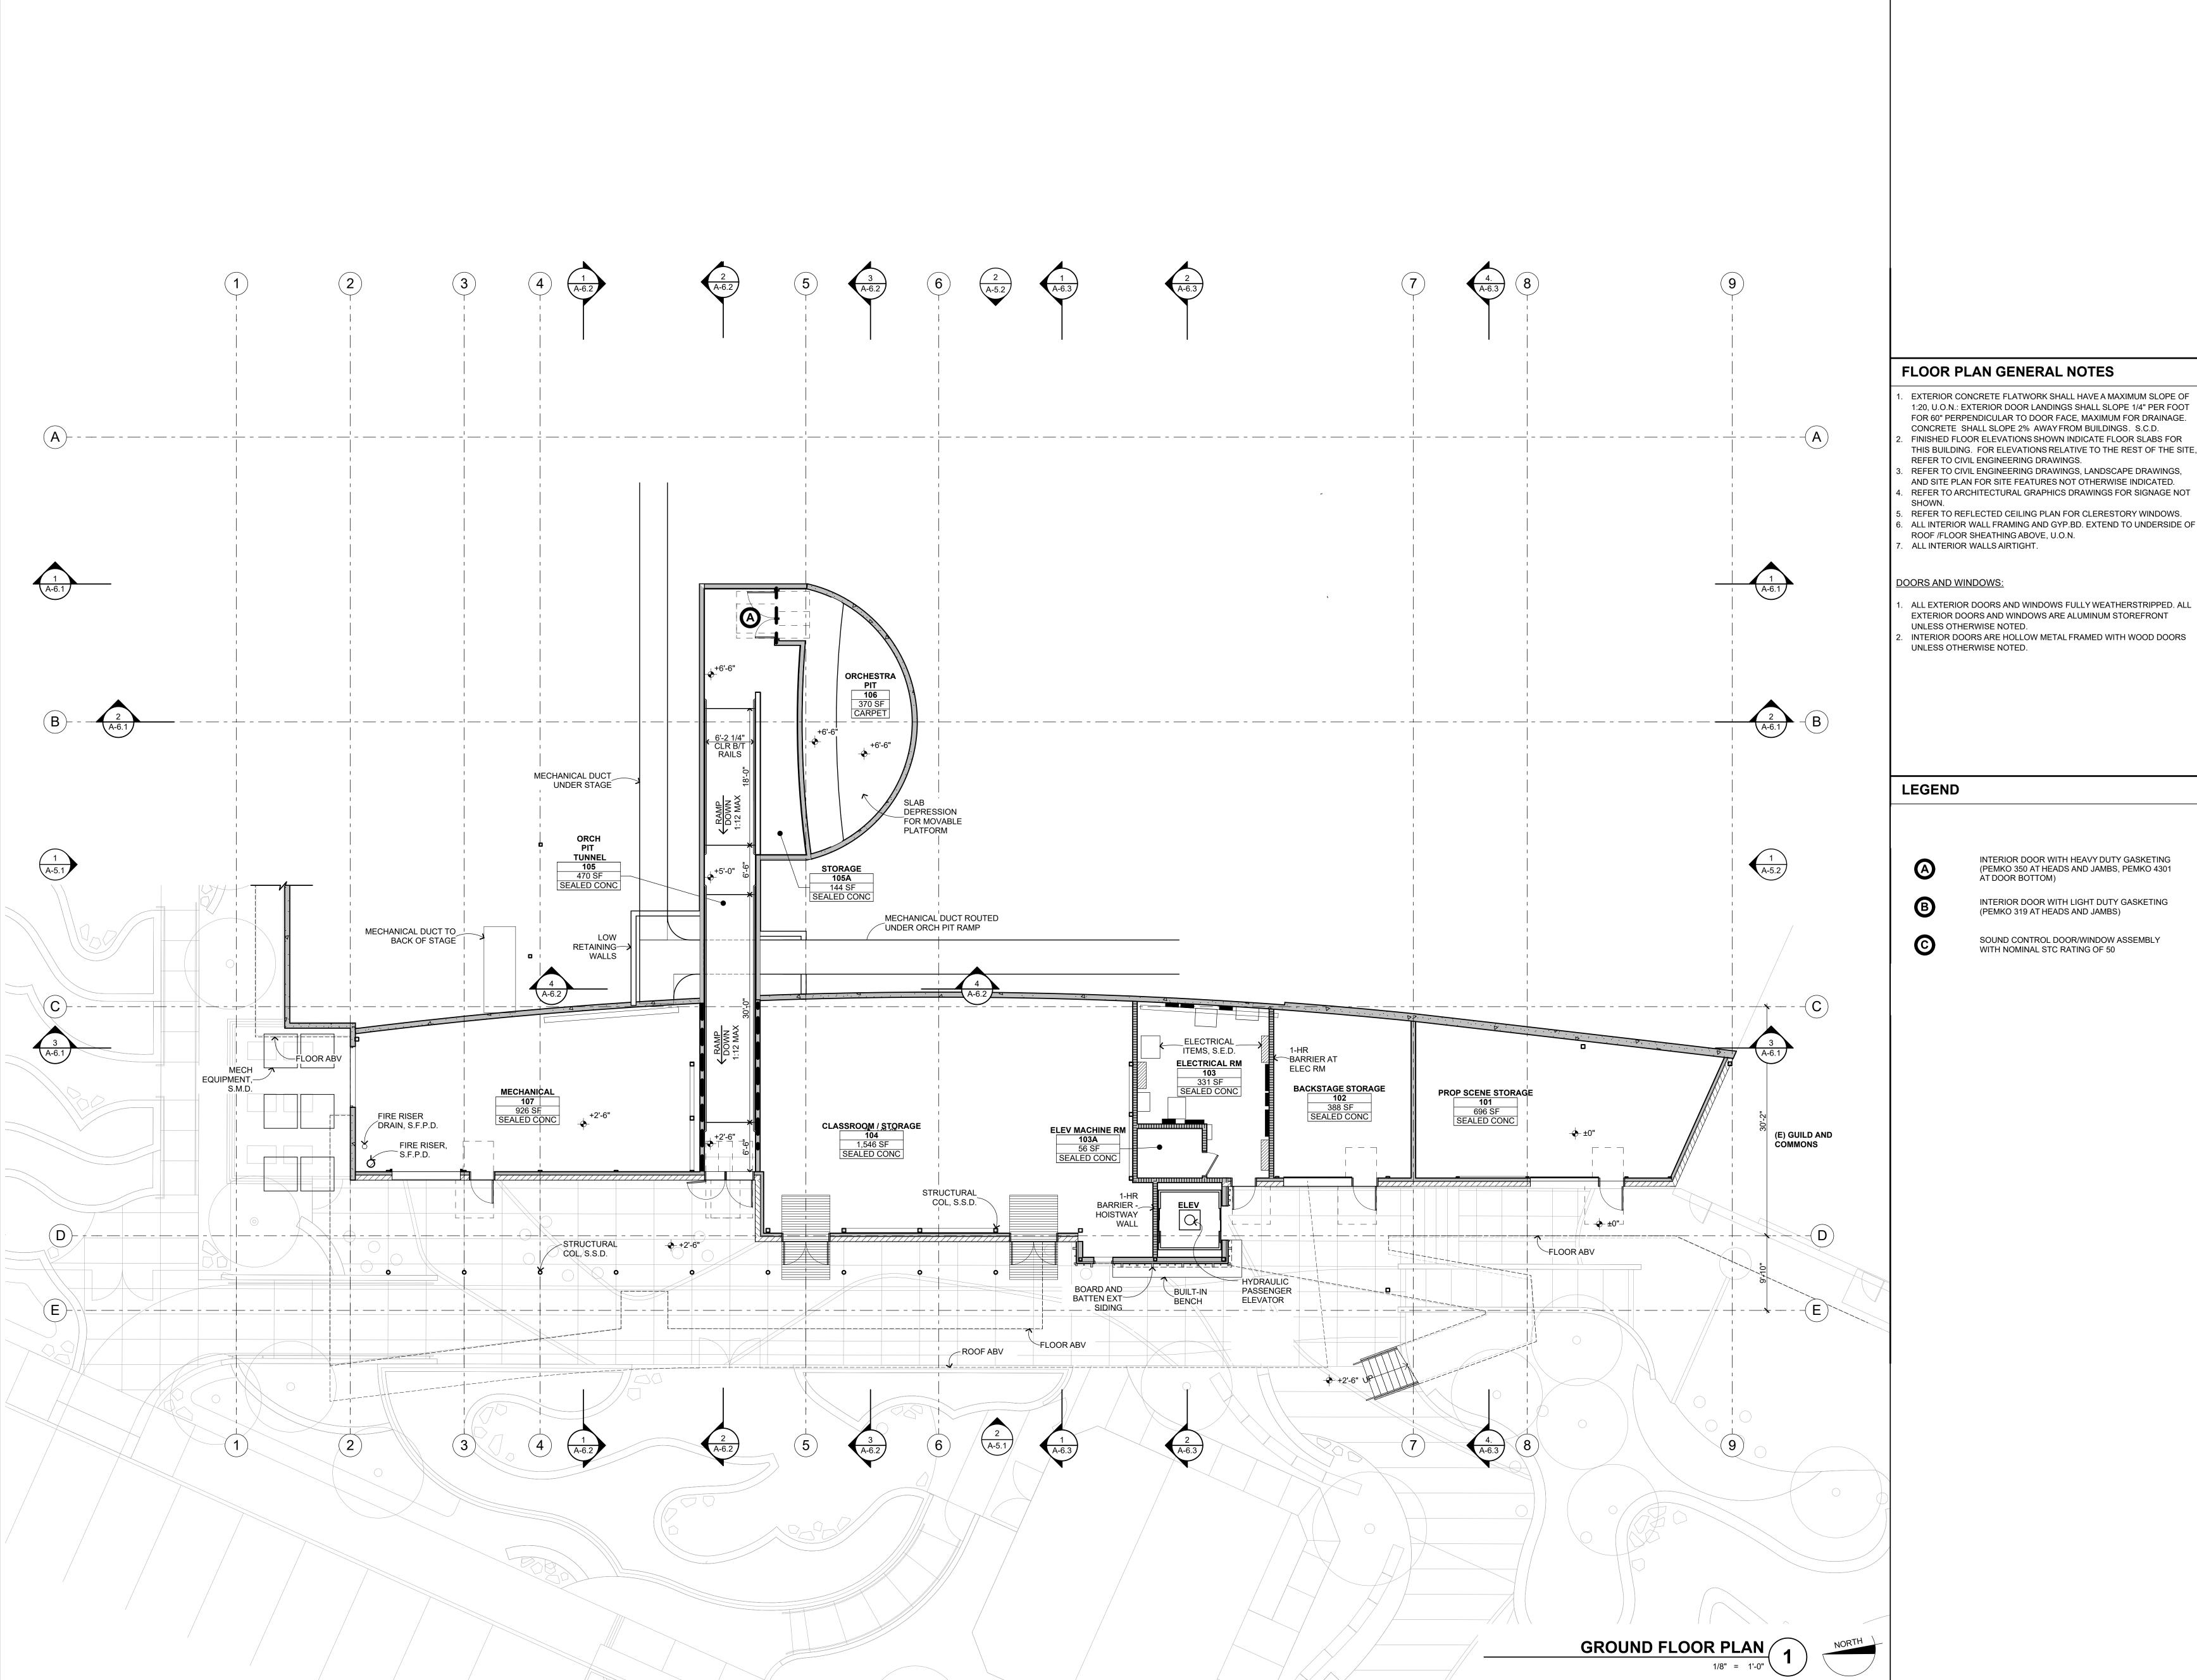
VISUAL AND PERFORMING ARTS CENTER

2500 FARMERS LN SANTA ROSA, CA 95404

ARCH PRO	JECT NO:	1802	
DRAWN BY	:		
DRAWING S	SCALE:		
DESIGN REVIEW			
N 4	MARCH 9, 2020		

MATERIALS / COLOR

SHEET NUMBER

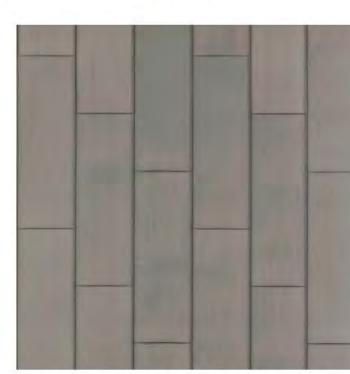



(707) 576-0829

FLOOR PLAN GENERAL NOTES

- EXTERIOR CONCRETE FLATWORK SHALL HAVE A MAXIMUM SLOPE OF 1:20, U.O.N.: EXTERIOR DOOR LANDINGS SHALL SLOPE 1/4" PER FOOT FOR 60" PERPENDICULAR TO DOOR FACE, MAXIMUM FOR DRAINAGE. CONCRETE SHALL SLOPE 2% AWAY FROM BUILDINGS. S.C.D. FINISHED FLOOR ELEVATIONS SHOWN INDICATE FLOOR SLABS FOR
- REFER TO CIVIL ENGINEERING DRAWINGS. REFER TO CIVIL ENGINEERING DRAWINGS, LANDSCAPE DRAWINGS,
- AND SITE PLAN FOR SITE FEATURES NOT OTHERWISE INDICATED. REFER TO ARCHITECTURAL GRAPHICS DRAWINGS FOR SIGNAGE NOT
- REFER TO REFLECTED CEILING PLAN FOR CLERESTORY WINDOWS. ALL INTERIOR WALL FRAMING AND GYP.BD. EXTEND TO UNDERSIDE OF ROOF /FLOOR SHEATHING ABOVE, U.O.N. 7. ALL INTERIOR WALLS AIRTIGHT.

DOORS AND WINDOWS:

- ALL EXTERIOR DOORS AND WINDOWS FULLY WEATHERSTRIPPED. ALL EXTERIOR DOORS AND WINDOWS ARE ALUMINUM STOREFRONT
- UNLESS OTHERWISE NOTED. INTERIOR DOORS ARE HOLLOW METAL FRAMED WITH WOOD DOORS UNLESS OTHERWISE NOTED.

INTERIOR DOOR WITH HEAVY DUTY GASKETING (PEMKO 350 AT HEADS AND JAMBS, PEMKO 4301 AT DOOR BOTTOM)


SOUND CONTROL DOOR/WINDOW ASSEMBLY WITH NOMINAL STC RATING OF 50

INTERIOR DOOR WITH LIGHT DUTY GASKETING (PEMKO 319 AT HEADS AND JAMBS)

SONOMA ACADEMY

VISUAL AND PERFORMING ARTS CENTER

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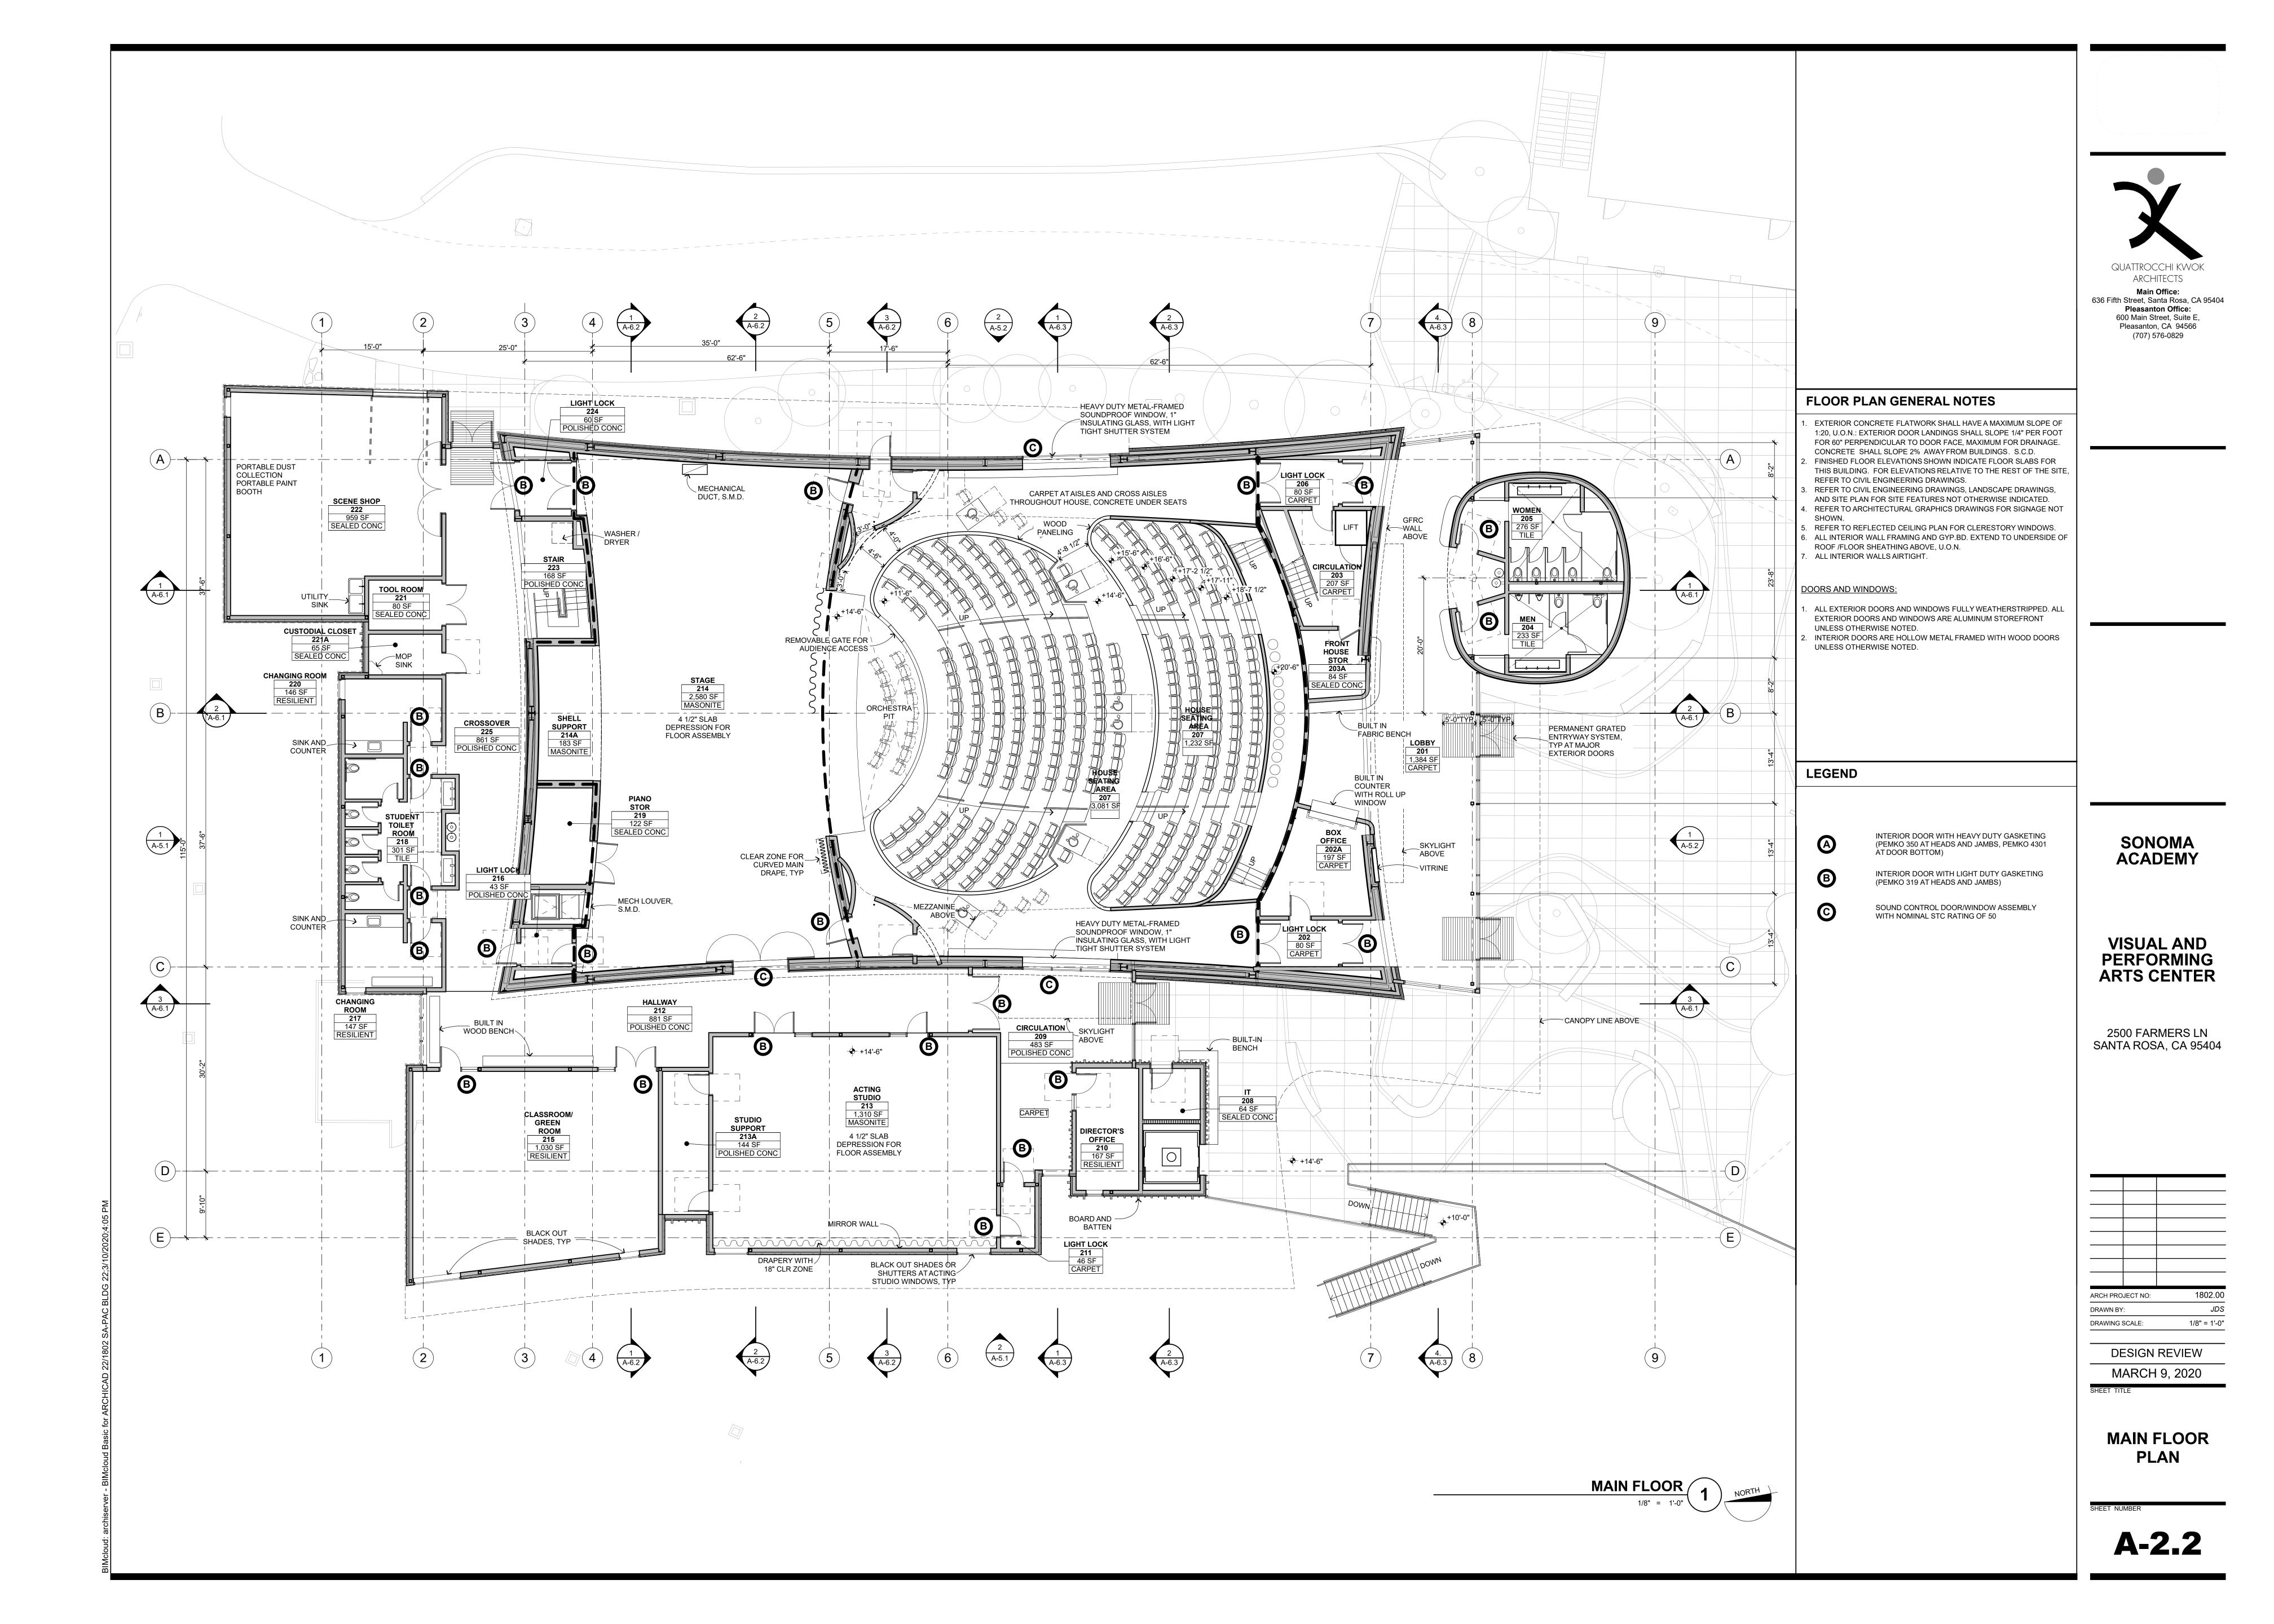
DESIGN REVIEW

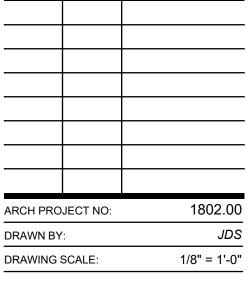
MARCH 9, 2020

GROUND FLOOR AND ORCH PIT

PLAN

A-2.1



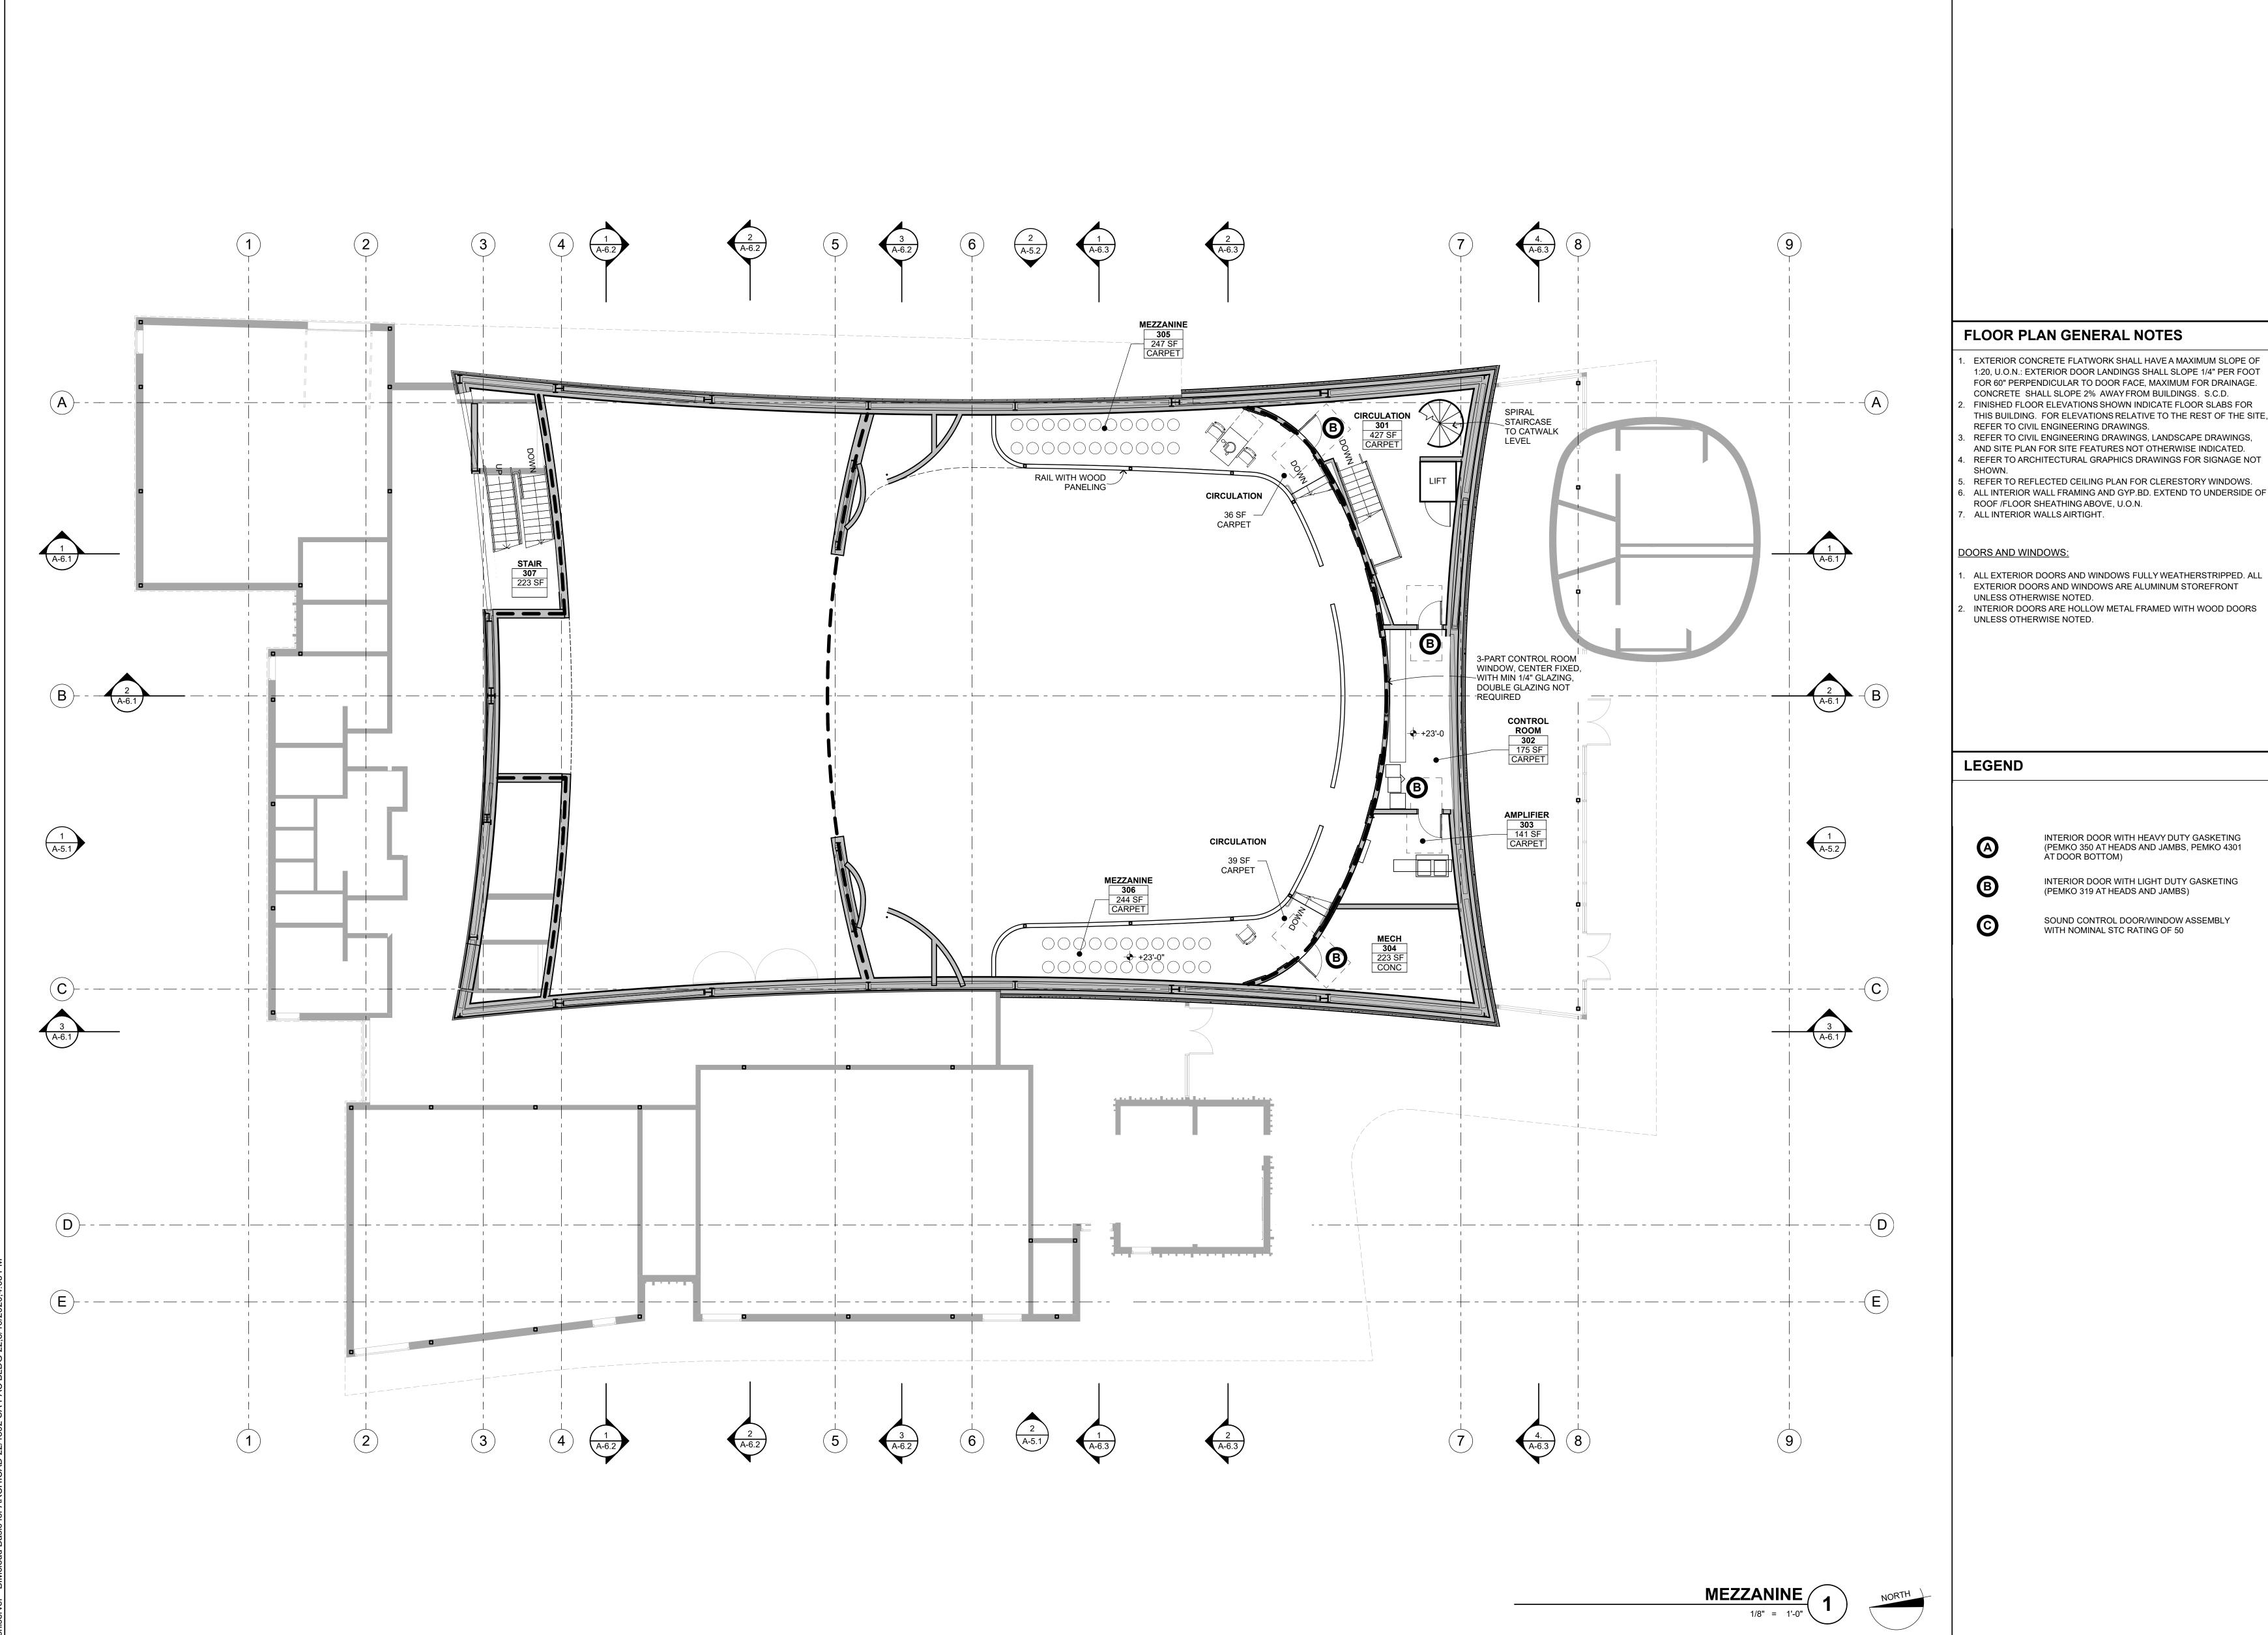



FLOOR PLAN GENERAL NOTES

- EXTERIOR CONCRETE FLATWORK SHALL HAVE A MAXIMUM SLOPE OF 1:20, U.O.N.: EXTERIOR DOOR LANDINGS SHALL SLOPE 1/4" PER FOOT FOR 60" PERPENDICULAR TO DOOR FACE, MAXIMUM FOR DRAINAGE. CONCRETE SHALL SLOPE 2% AWAY FROM BUILDINGS. S.C.D. FINISHED FLOOR ELEVATIONS SHOWN INDICATE FLOOR SLABS FOR
- REFER TO CIVIL ENGINEERING DRAWINGS. REFER TO CIVIL ENGINEERING DRAWINGS, LANDSCAPE DRAWINGS,
- AND SITE PLAN FOR SITE FEATURES NOT OTHERWISE INDICATED. REFER TO ARCHITECTURAL GRAPHICS DRAWINGS FOR SIGNAGE NOT
- REFER TO REFLECTED CEILING PLAN FOR CLERESTORY WINDOWS. ALL INTERIOR WALL FRAMING AND GYP.BD. EXTEND TO UNDERSIDE OF ROOF /FLOOR SHEATHING ABOVE, U.O.N. 7. ALL INTERIOR WALLS AIRTIGHT.

DOORS AND WINDOWS:

- ALL EXTERIOR DOORS AND WINDOWS FULLY WEATHERSTRIPPED. ALL EXTERIOR DOORS AND WINDOWS ARE ALUMINUM STOREFRONT
- UNLESS OTHERWISE NOTED. INTERIOR DOORS ARE HOLLOW METAL FRAMED WITH WOOD DOORS UNLESS OTHERWISE NOTED.

LEGEND

INTERIOR DOOR WITH HEAVY DUTY GASKETING (PEMKO 350 AT HEADS AND JAMBS, PEMKO 4301 AT DOOR BOTTOM)


INTERIOR DOOR WITH LIGHT DUTY GASKETING (PEMKO 319 AT HEADS AND JAMBS)

SOUND CONTROL DOOR/WINDOW ASSEMBLY WITH NOMINAL STC RATING OF 50

VISUAL AND PERFORMING ARTS CENTER

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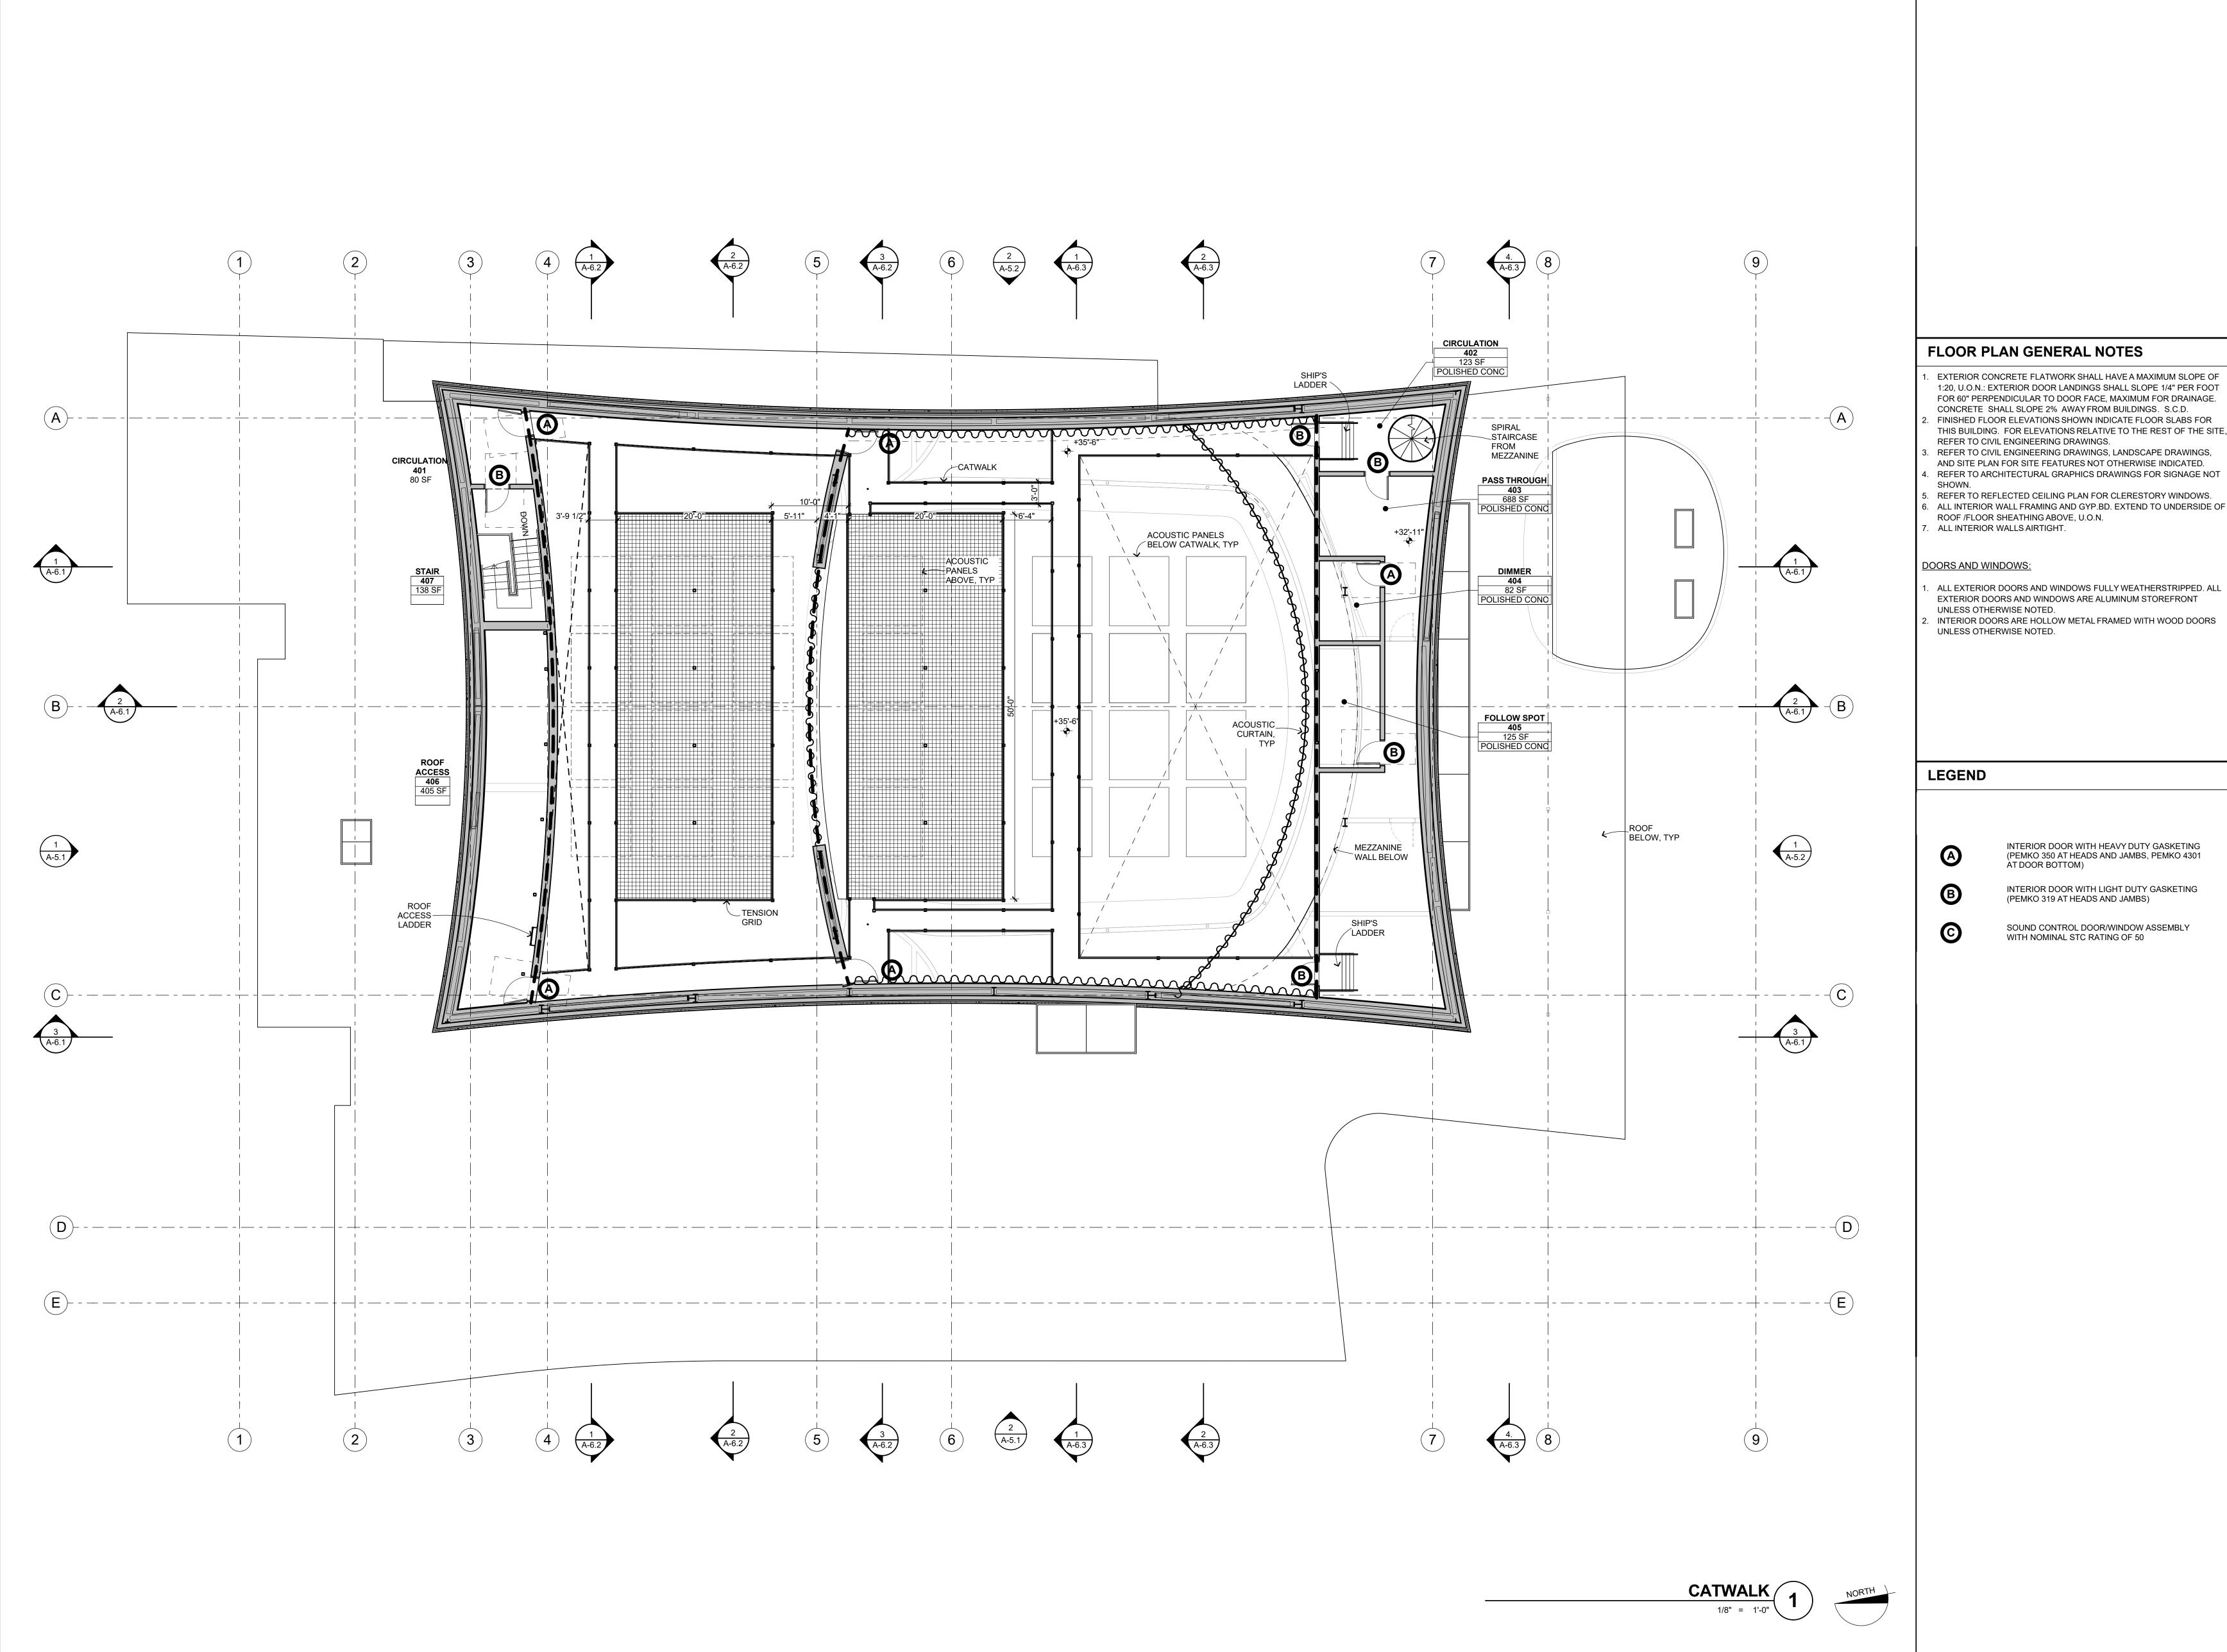


DESIGN REVIEW

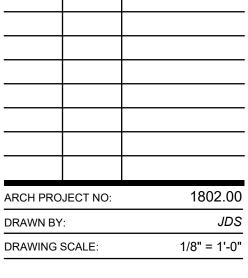MARCH 9, 2020

MEZZANINE FLOOR PLAN

A-2.3





FLOOR PLAN GENERAL NOTES

- EXTERIOR CONCRETE FLATWORK SHALL HAVE A MAXIMUM SLOPE OF 1:20, U.O.N.: EXTERIOR DOOR LANDINGS SHALL SLOPE 1/4" PER FOOT FOR 60" PERPENDICULAR TO DOOR FACE, MAXIMUM FOR DRAINAGE. CONCRETE SHALL SLOPE 2% AWAY FROM BUILDINGS. S.C.D. FINISHED FLOOR ELEVATIONS SHOWN INDICATE FLOOR SLABS FOR
- REFER TO CIVIL ENGINEERING DRAWINGS. REFER TO CIVIL ENGINEERING DRAWINGS, LANDSCAPE DRAWINGS, AND SITE PLAN FOR SITE FEATURES NOT OTHERWISE INDICATED.
- REFER TO ARCHITECTURAL GRAPHICS DRAWINGS FOR SIGNAGE NOT
- REFER TO REFLECTED CEILING PLAN FOR CLERESTORY WINDOWS. ALL INTERIOR WALL FRAMING AND GYP.BD. EXTEND TO UNDERSIDE OF ROOF /FLOOR SHEATHING ABOVE, U.O.N. . ALL INTERIOR WALLS AIRTIGHT.

DOORS AND WINDOWS:

- ALL EXTERIOR DOORS AND WINDOWS FULLY WEATHERSTRIPPED. ALL EXTERIOR DOORS AND WINDOWS ARE ALUMINUM STOREFRONT
- UNLESS OTHERWISE NOTED. INTERIOR DOORS ARE HOLLOW METAL FRAMED WITH WOOD DOORS UNLESS OTHERWISE NOTED.

LEGEND

INTERIOR DOOR WITH HEAVY DUTY GASKETING (PEMKO 350 AT HEADS AND JAMBS, PEMKO 4301 AT DOOR BOTTOM)


INTERIOR DOOR WITH LIGHT DUTY GASKETING (PEMKO 319 AT HEADS AND JAMBS)

SOUND CONTROL DOOR/WINDOW ASSEMBLY WITH NOMINAL STC RATING OF 50

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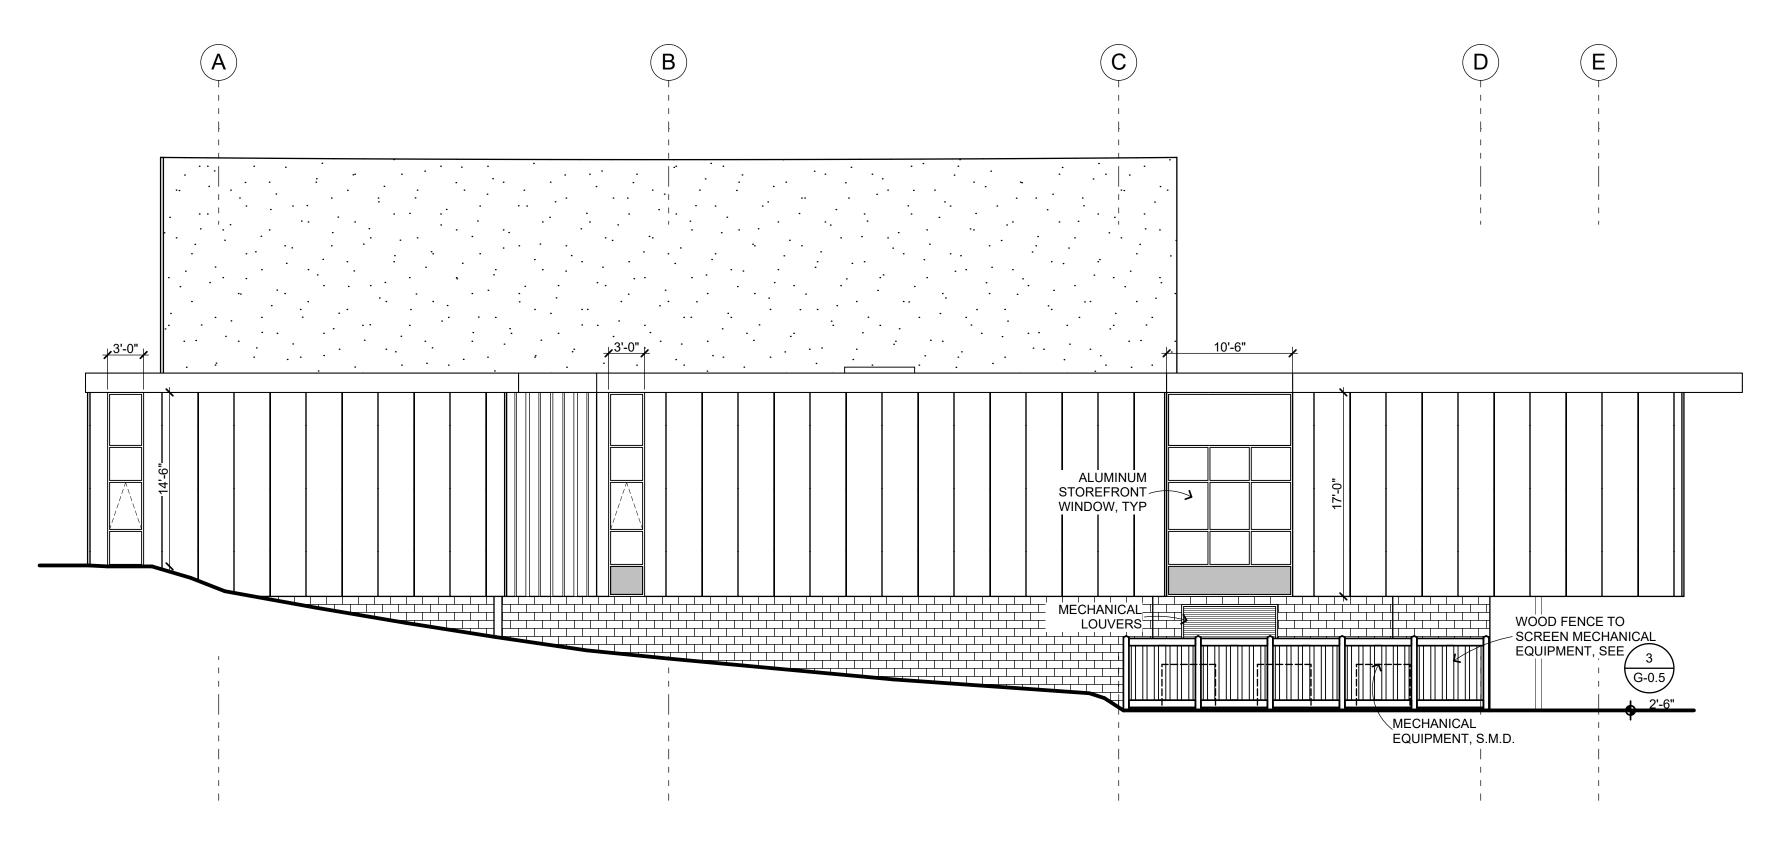
2500 FARMERS LN SANTA ROSA, CA 95404




DESIGN REVIEW MARCH 9, 2020

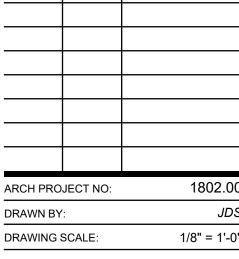CATWALK FLOOR PLAN

A-2.4





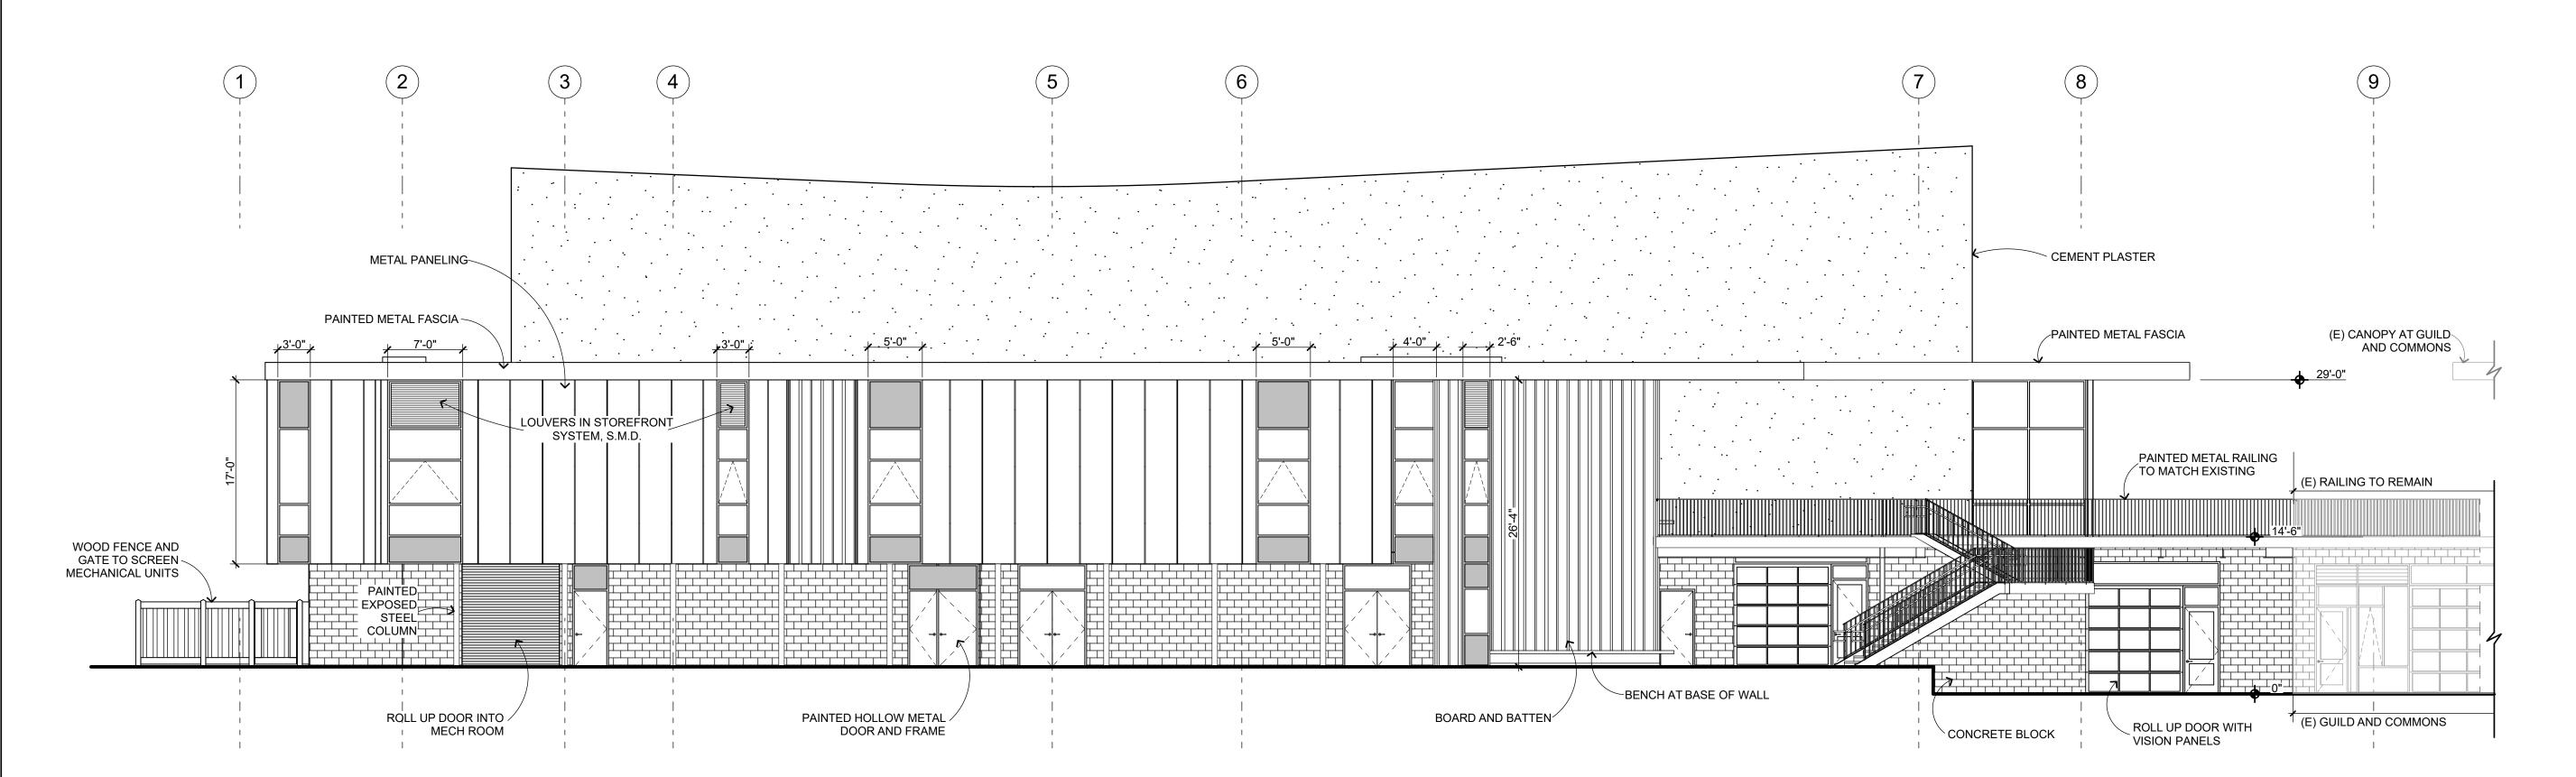

WEST ELEVATION

1/8" = 1'-0"

2



EXTERIOR ELEVATION GENERAL NOTES

- NOTES AND SYMBOLS ARE TO APPLY ATALL AREAS OF SIMILAR GRAPHIC REPRESENTATION. SUCH INDICATIONS MAY BE LIMITED TO PROMOTE CLARITY OR AVOID REDUNDANCY. NO LIMITATION OF APPLICATION SHALL BE CONSTRUED WITHOUT SPECIFIC NOTATION.
 ALL PENETRATIONS THROUGH EXTERIOR ROOF AND WALLS, AND FLOORS SHALL BE FLASHED AND SEALED WEATHER TIGHT. ALL PENETRATIONS THROUGH THE BUILDING INSULATION ENVELOPE SHALL BE PACKED WITH INSULATION.
- 4. REFER TO MECHANICAL DRAWINGS FOR REGISTERS AND VENTS NOT OTHERWISE SHOWN.

REFER TO ELECTRICAL DRAWINGS FOR HORNS, SPEAKERS, PULL STATIONS AND OTHER FEATURES NOT OTHERWISE SHOWN.

EXTERIOR ELEVATION LEGEND

CEMENT PLASTER

METAL WALL PANELS

BOARD AND BATTEN SIDING TYPE 1—

BOARD AND BATTEN SIDING TYPE 2 -

EARTH BLOCK WALL

METAL PANEL IN STOREFRONT FRAME

SONOMA ACADEMY

VISUAL AND PERFORMING ARTS CENTER

2500 FARMERS LN SANTA ROSA, CA 95404

ARCH PROJECT NO: 1802.00

DRAWN BY: JDS

DRAWING SCALE: 1/8" = 1'-0"


DESIGN REVIEW
MARCH 9, 2020


IEET TITLE

ELEVATIONS

SHEET NUMBER

A-5.1

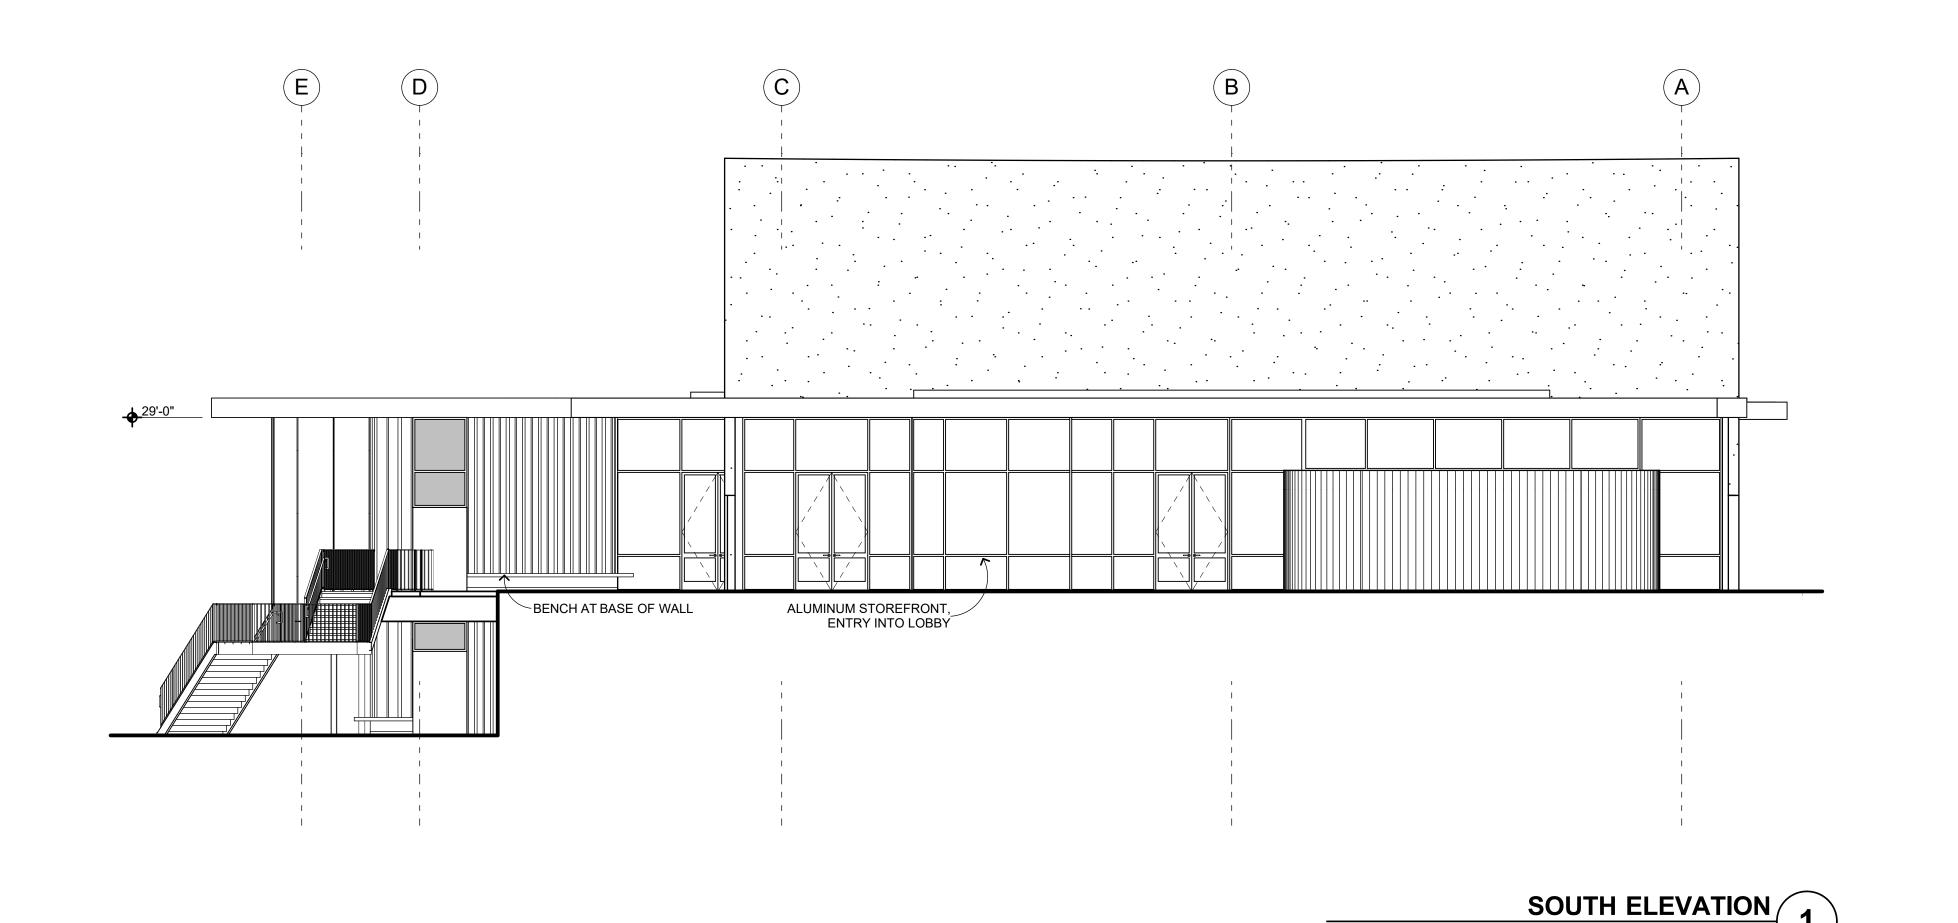

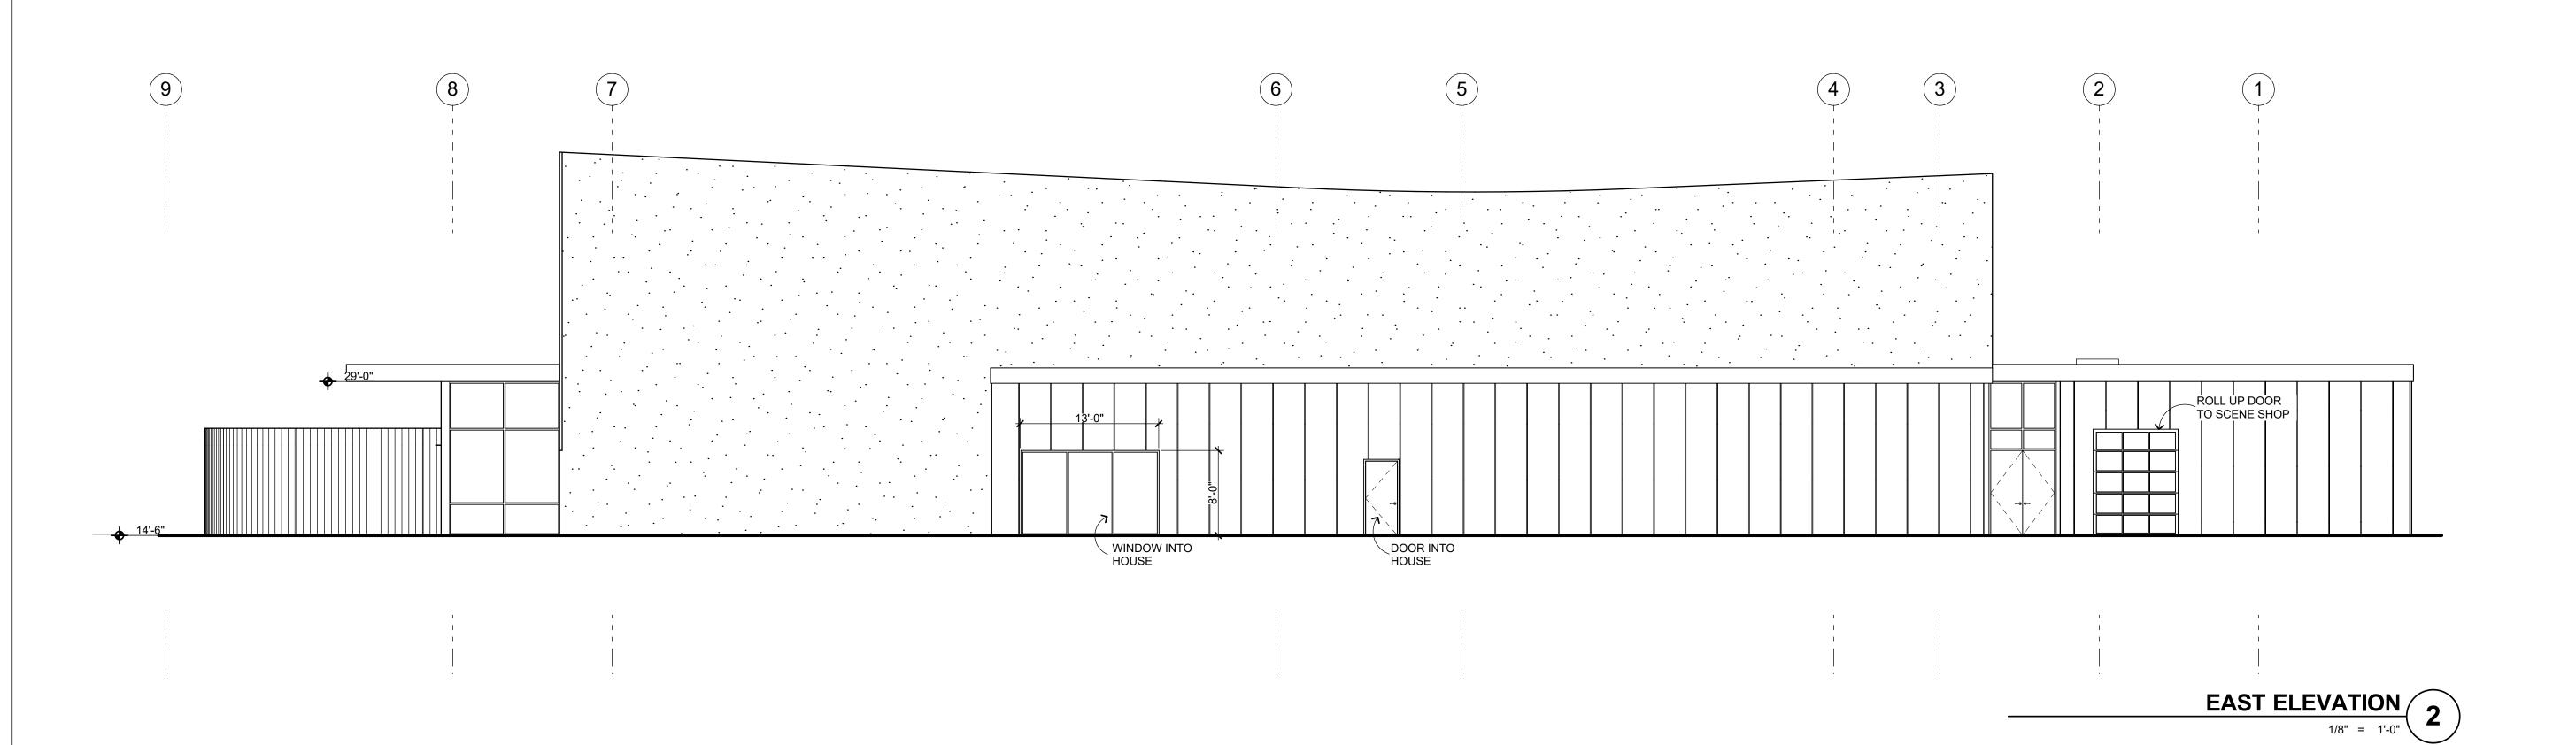



Pleasanton, CA 94566 (707) 576-0829

EXTERIOR ELEVATION GENERAL NOTES

- NOTES AND SYMBOLS ARE TO APPLY ATALL AREAS OF SIMILAR GRAPHIC REPRESENTATION. SUCH INDICATIONS MAY BE LIMITED TO PROMOTE CLARITY OR AVOID REDUNDANCY. NO LIMITATION OF APPLICATION SHALL BE CONSTRUED WITHOUT SPECIFIC NOTATION. ALL PENETRATIONS THROUGH EXTERIOR ROOF AND WALLS, AND FLOORS SHALL BE FLASHED AND SEALED WEATHER TIGHT. ALL PENETRATIONS THROUGH THE BUILDING INSULATION ENVELOPE SHALL BE PACKED WITH INSULATION.
- PROVIDE OPENING FLASHINGS AT ALL WINDOWS, DOORS, LOUVERS AND SIMILAR WALL OPENINGS PER ----
- REFER TO MECHANICAL DRAWINGS FOR REGISTERS AND VENTS NOT OTHERWISE SHOWN. REFER TO ELECTRICAL DRAWINGS FOR HORNS, SPEAKERS, PULL

STATIONS AND OTHER FEATURES NOT OTHERWISE SHOWN.

EXTERIOR ELEVATION LEGEND

CEMENT PLASTER ————— METAL WALL PANELS BOARD AND BATTEN SIDING TYPE 1-BOARD AND BATTEN SIDING TYPE 2 -

EARTH BLOCK WALL

METAL PANEL IN STOREFRONT FRAME

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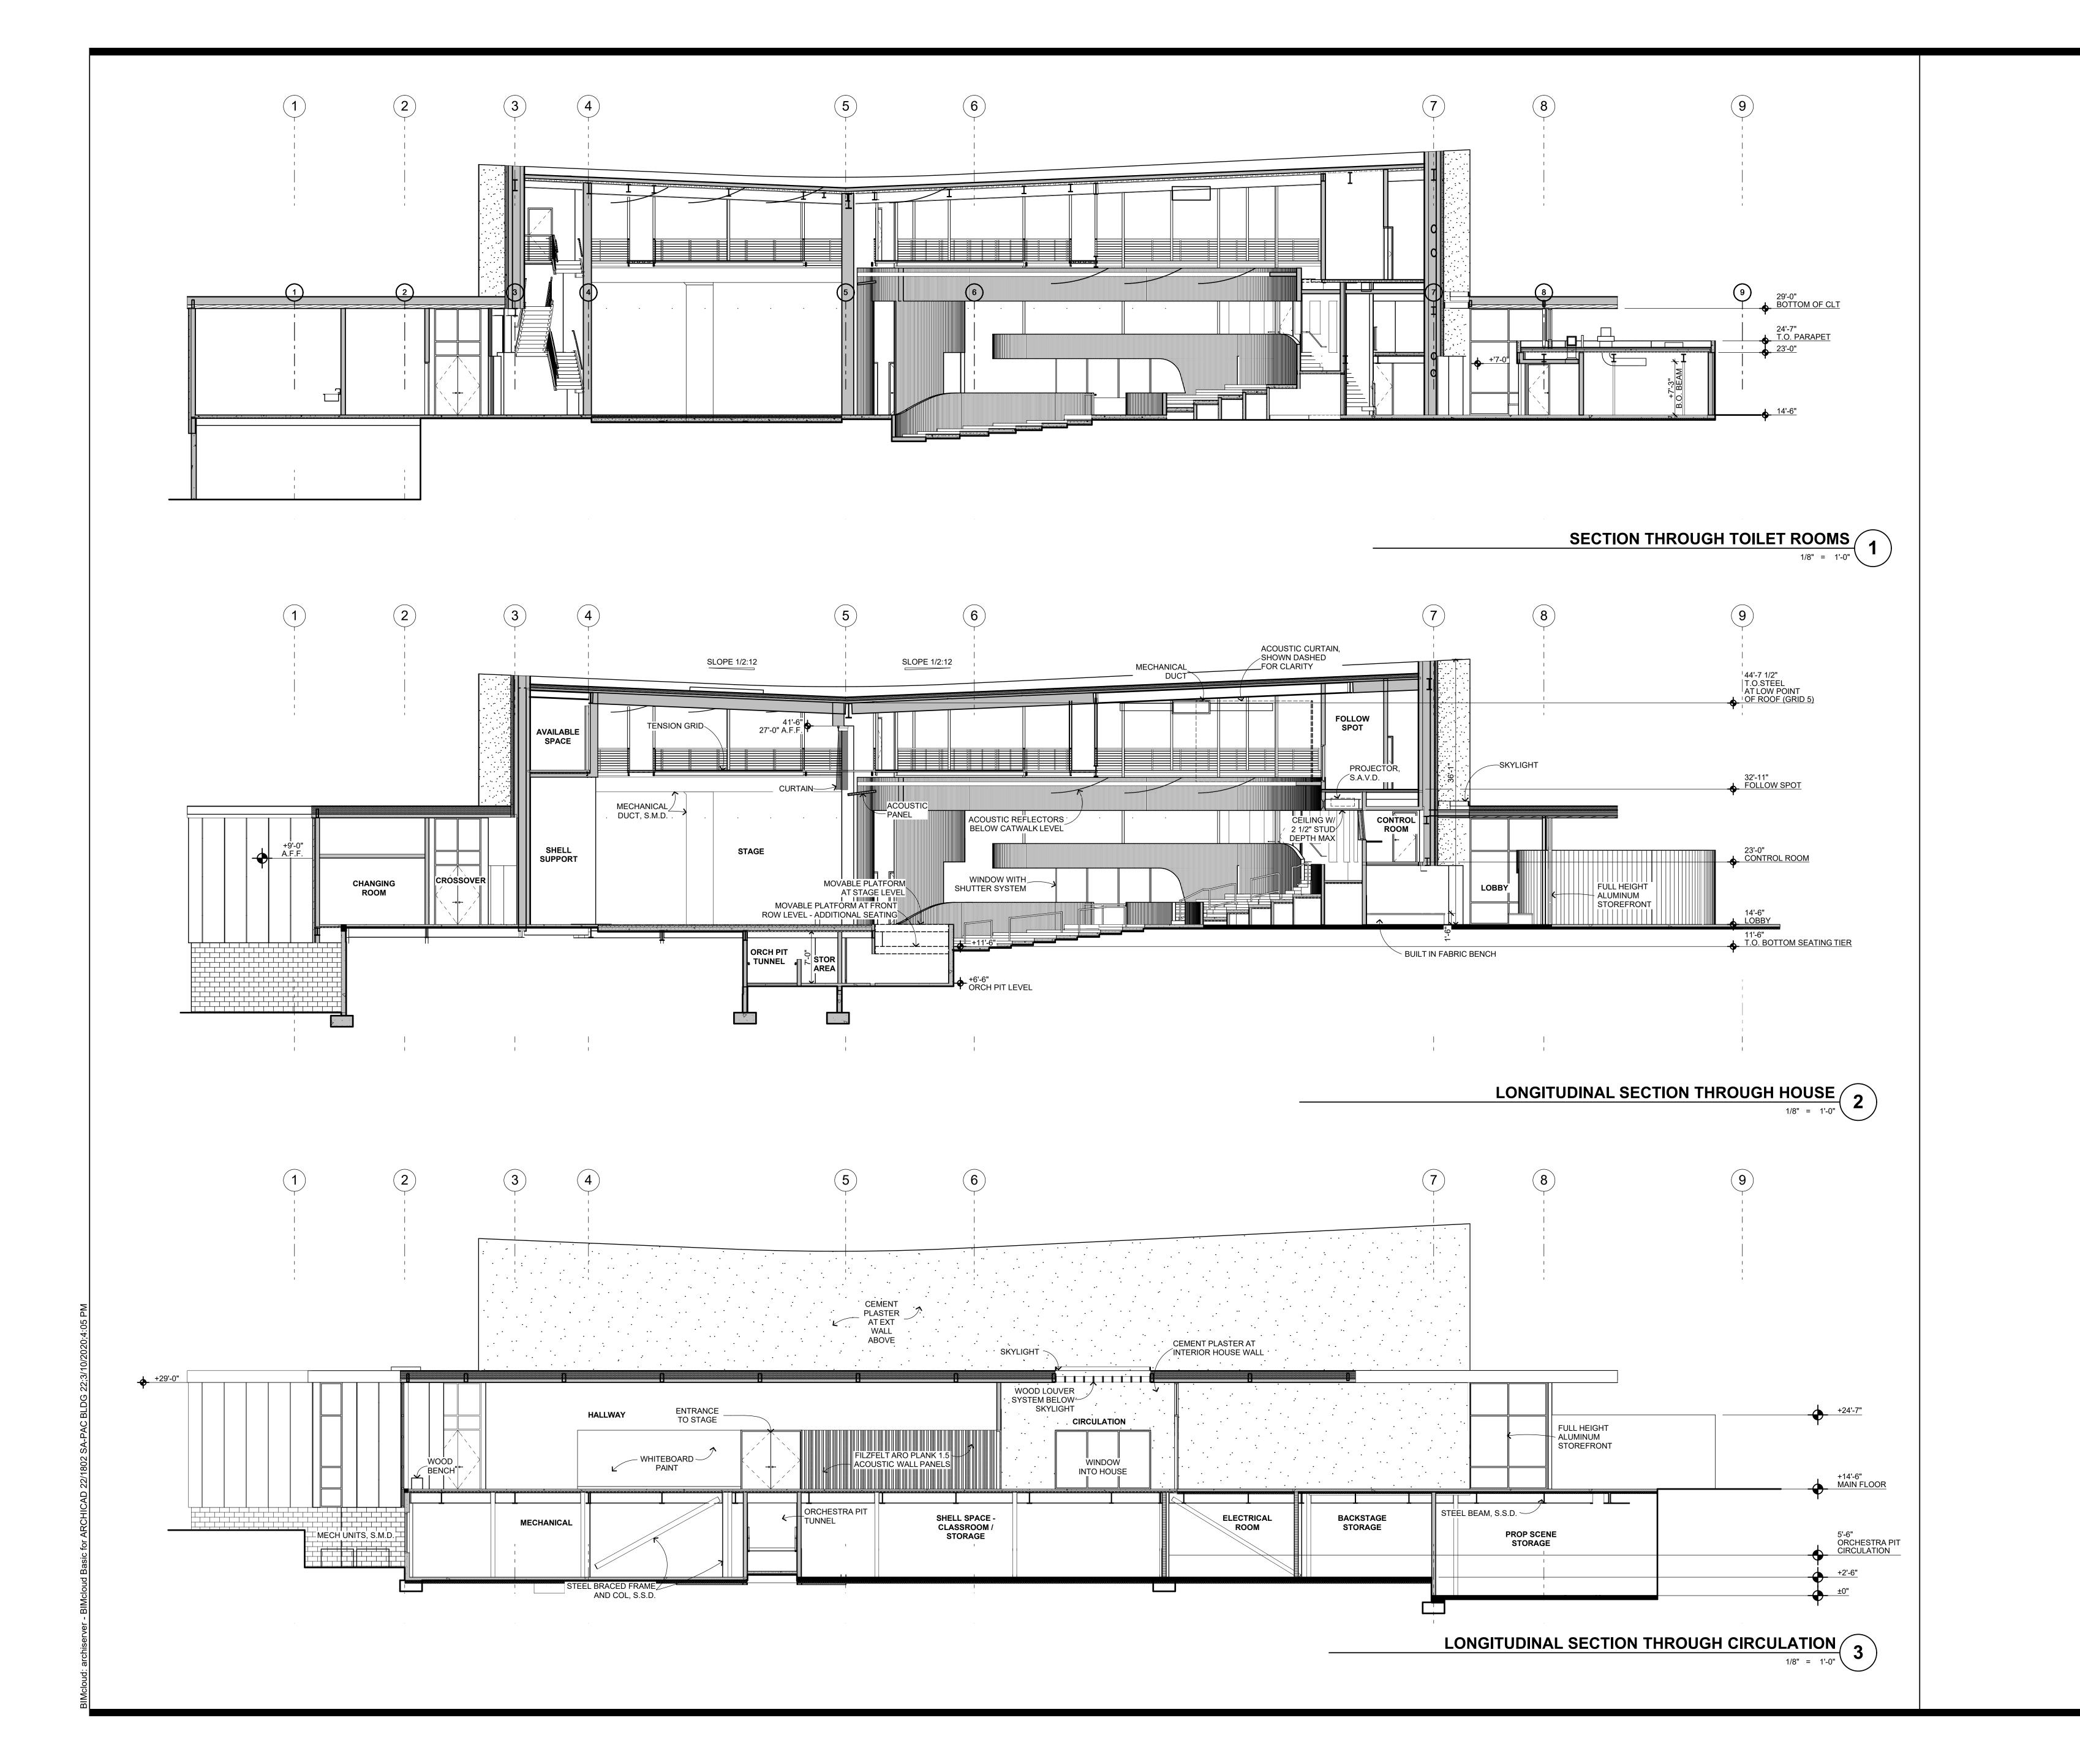
2500 FARMERS LN SANTA ROSA, CA 95404

1802.00 ARCH PROJECT NO: DRAWN BY: DRAWING SCALE:

DESIGN REVIEW MARCH 9, 2020

ELEVATIONS


A-5.2





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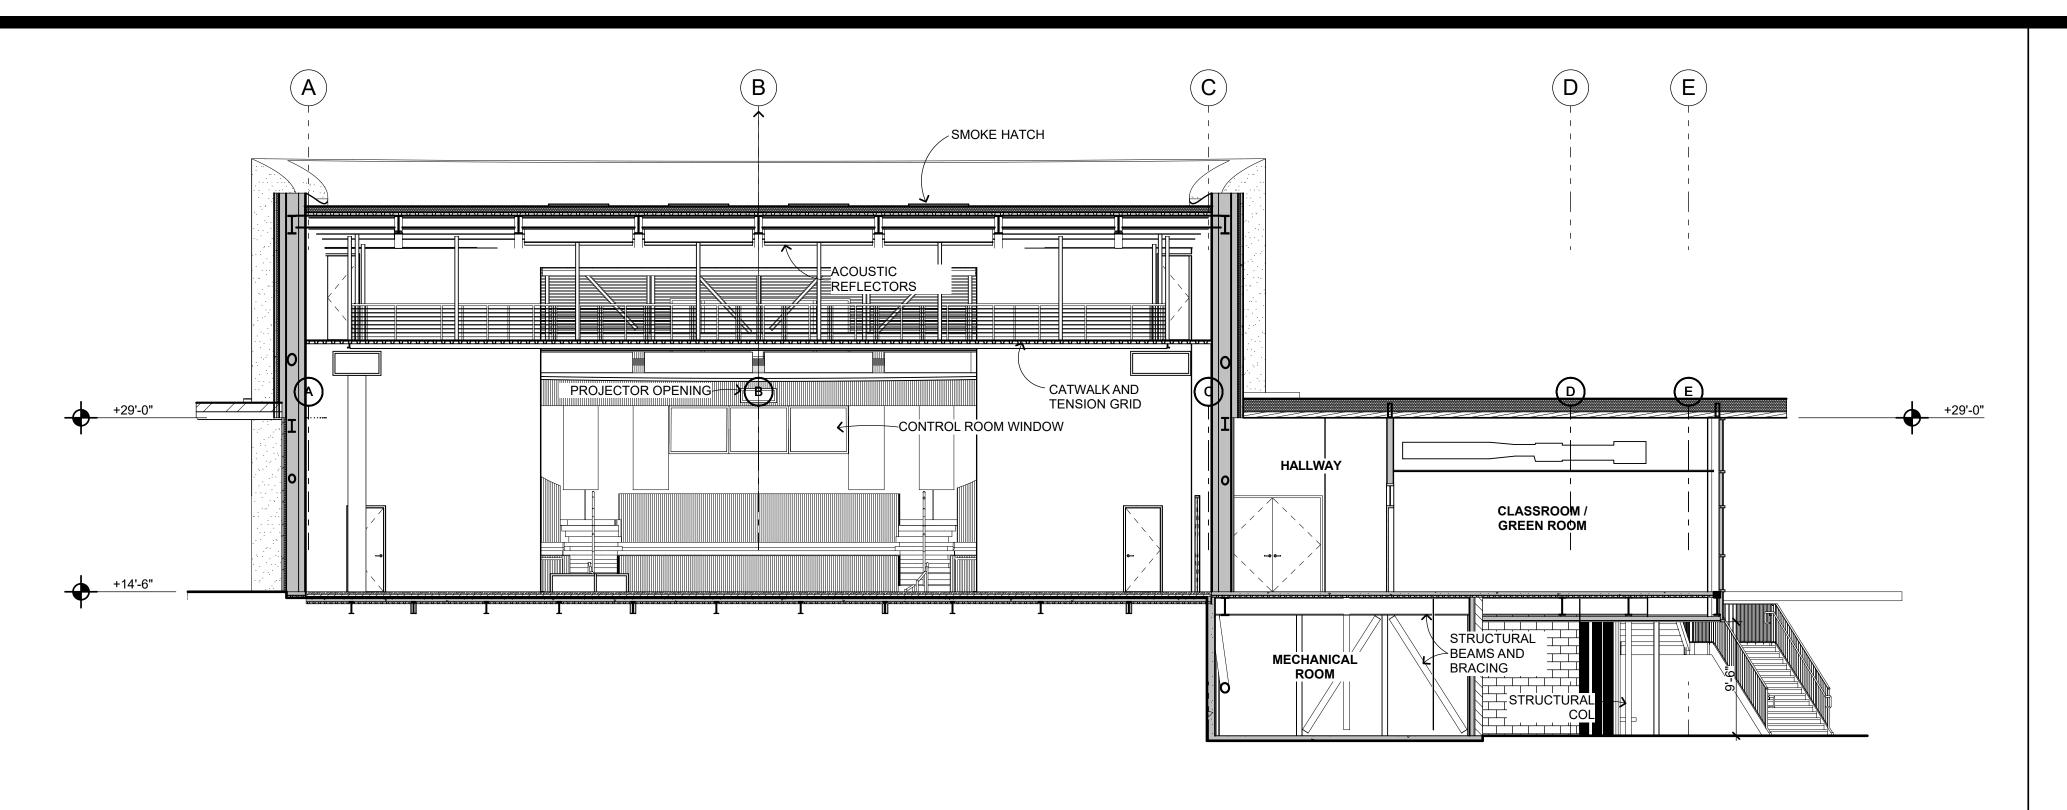
DESIGN REVIEW
MARCH 9, 2020

SHEET TITLE

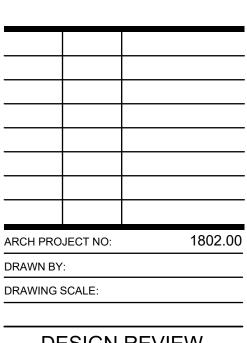BUILDING SECTIONS


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A-6.1








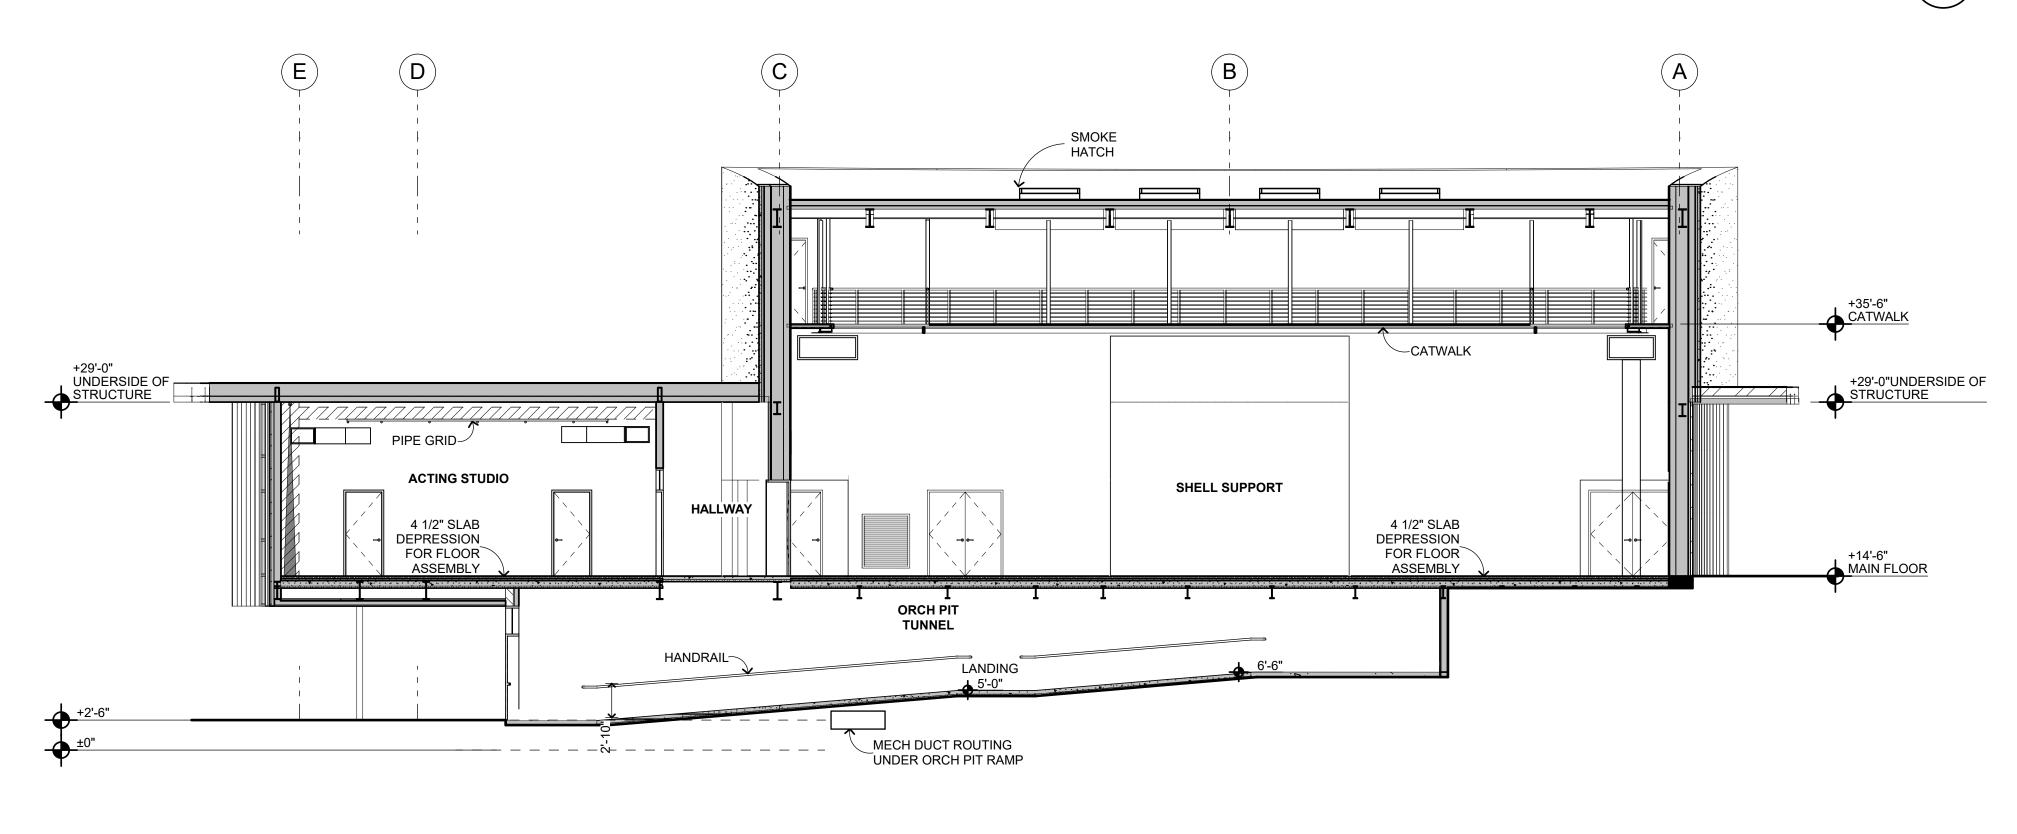

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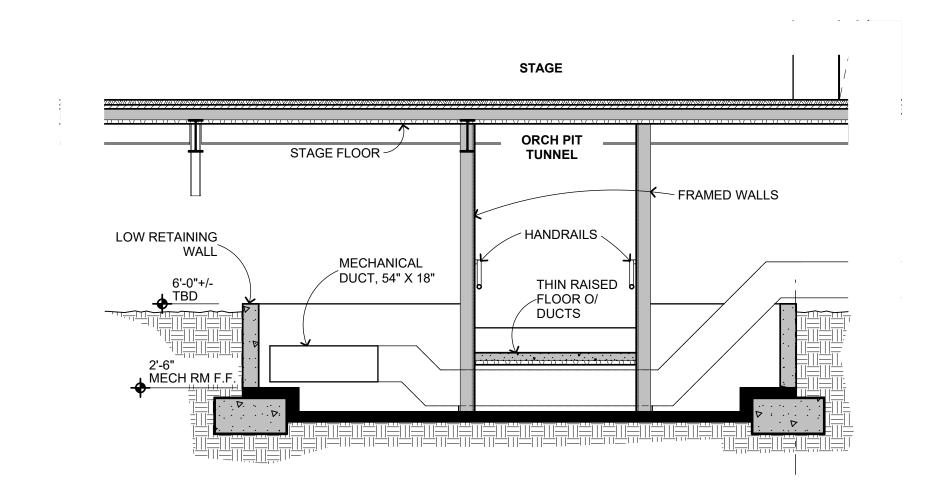
DESIGN REVIEW
MARCH 9, 2020

SHEET TITLE

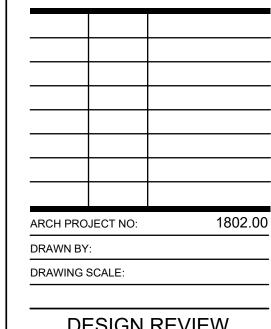BUILDING SECTIONS

SHEET NUMBER

A-6.2









TRANSVERSE BLDG SECTION THROUGH HOUSE AND ACTING STUDIO

1/8" = 1'-0"

3

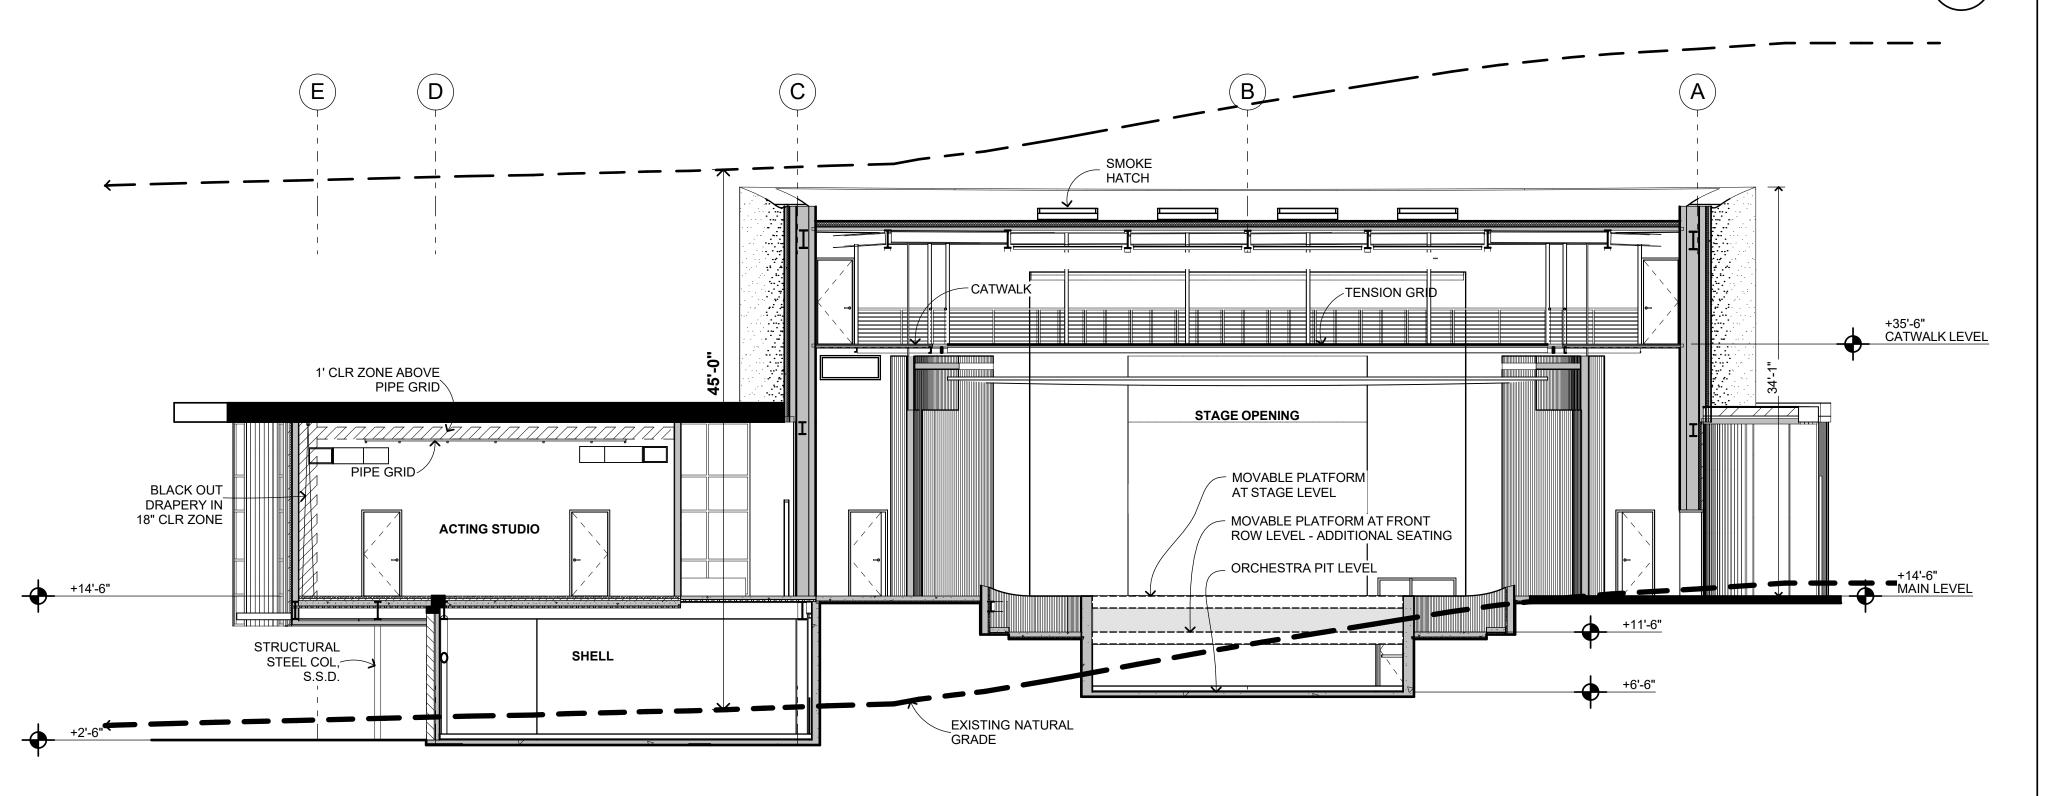


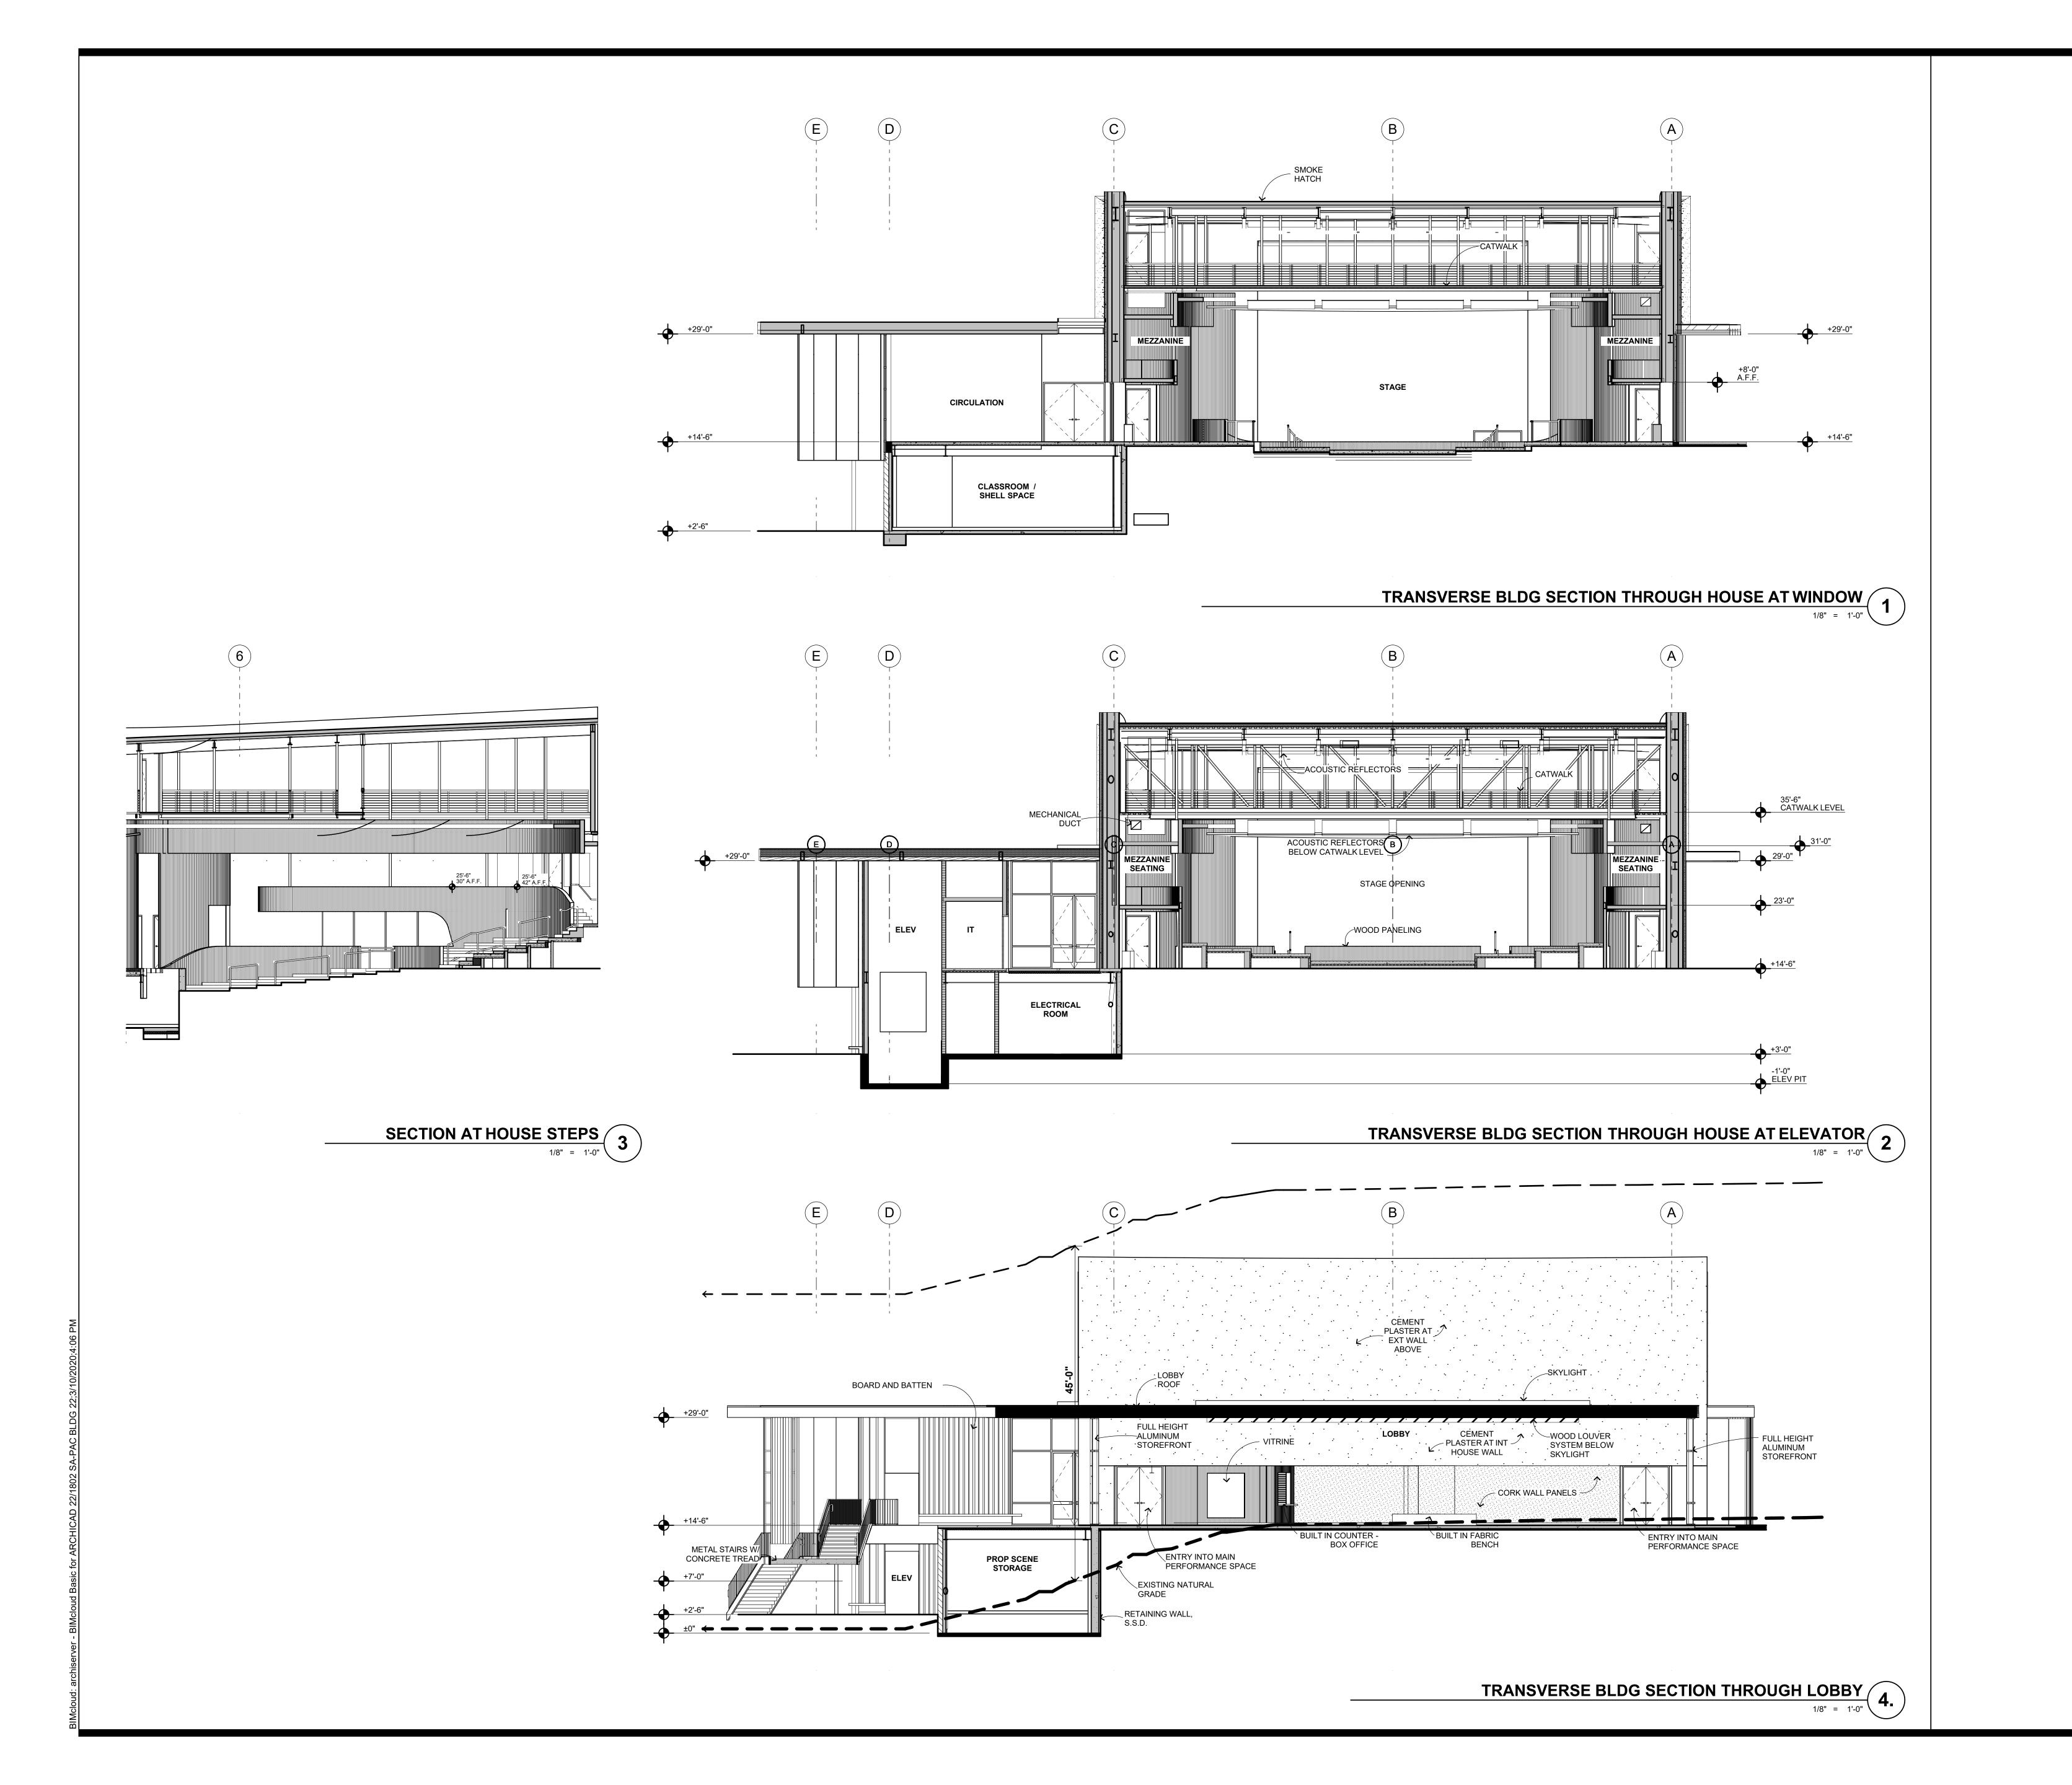



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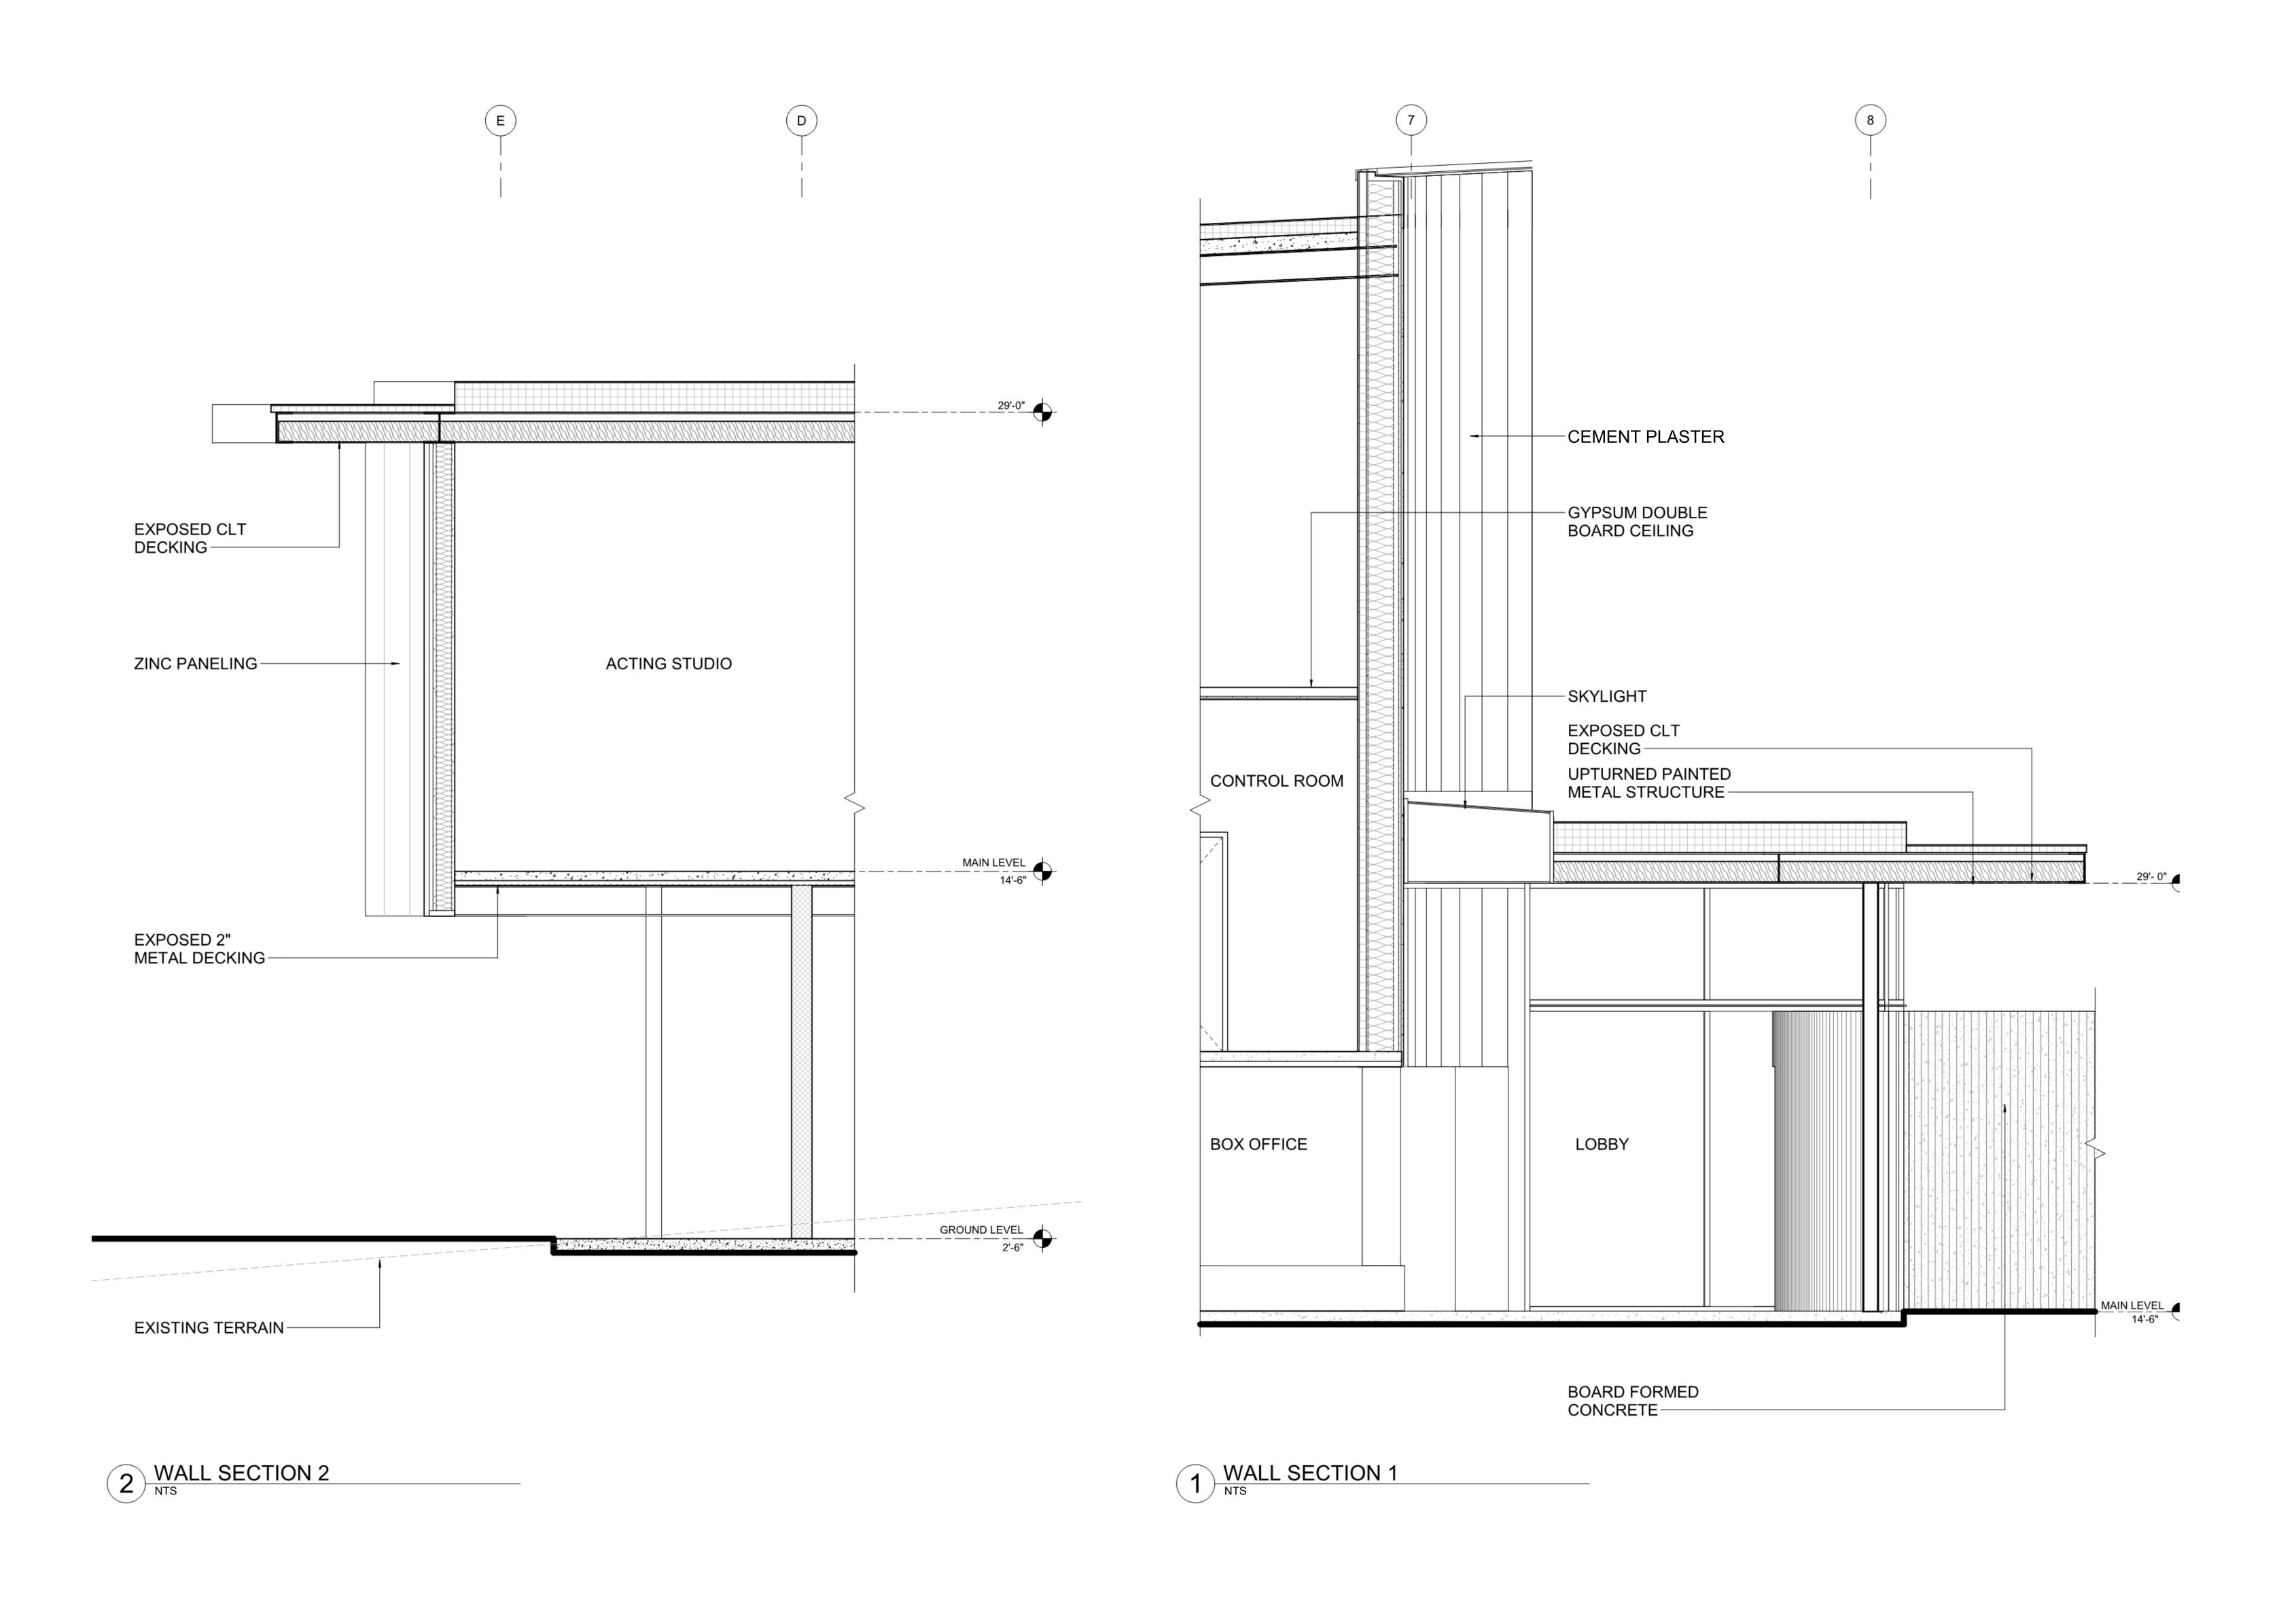


DESIGN REVIEW

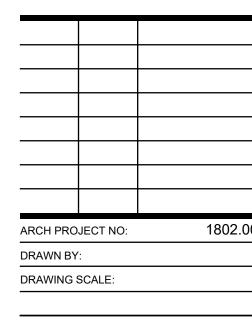MARCH 9, 2020

BUILDING SECTIONS

A-6.3



QUATTROCCHI KWOK ARCHITECTS Main Office:
636 Fifth Street, Santa Rosa, CA 95404
Pleasanton Office:
600 Main Street, Suite E,
Pleasanton, CA 94566 (707) 576-0829

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1802.00 ARCH PROJECT NO: DRAWN BY: DRAWING SCALE: 1/8" = 1'-0"

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WALL SECTIONS

SHEET NUMBER

A-6.4