


LUMINAIRE SCHEDULE							
Type	Mounting	Description	Manufacturer Catalog #	Wattage	Dimensions	Image	
AA1	SURFACE CEILING	SURFACE MOUNTED LED DOWNLIGHT WITH MACHINED COPPER FREE ALUMINUM CONSTRUCTION HOUSING WITH 1" DEEP BEZEL WITH 3" CUTOFF CAPS, 3" MACHINED STEM, AND 5" DIAMETER CANOPY. SHOCK RESISTANT, TEMPERED, SOFT FOCUS REGRESSED GLASS LENS. MEDIUM FLOOD DISTRIBUTION INTERCHANGEABLE OPTIC. 3000K CCT. FIELD ADJUSTABLE ONBOARD OUTPUT ADJUSTMENT. STANDARD PAINTED FINISH TO BE DETERMINED BY THE ARCHITECT.	BR LIGHTING: SM-STEM LENGTH-AR-LED-B65-MF LA9-FINISH-12-E	8W	2 1/4" DIAMETER 4 3/8" HIGH + STEM LENGTH		
AO1	WALL MOUNTED	SURFACE WALL MOUNTED LED DOWNLIGHT WITH DIE CAST LOW COPPER CONTENT ALUMINUM CONSTRUCTION HOUSING, MEMORY RETENTIVE SILICON GASKET, 10KV SURGE SUPPRESSION, UV STABILIZED BAKED POWDER COAT FINISH TO BE DETERMINED BY THE ARCHITECT. STAINLESS STEEL HARDWARE. LOW IRON, TEMPERED, IMPACT RESISTANT GLASS LENS, AND IES TYPE III FULL CUTOFF OPTICS. 3000K CCT.	LIGMAN: ULEE-30021-20W LED-T3-W30-FINISH-120 /277V	20W	10.2" WIDTH 3.7" HEIGHT 3.7" DEPTH		
BA1	POLE MOUNTED	POLE MOUNTED LED DOWNLIGHT WITH DIE CAST LOW COPPER CONTENT ALUMINUM CONSTRUCTION HOUSING, MEMORY RETENTIVE SILICON GASKET, 10KV SURGE SUPPRESSION, UV STABILIZED BAKED POWDER COAT FINISH TO BE DETERMINED BY THE ARCHITECT, STAINLESS STEEL HARDWARE. LOW IRON, TEMPERED, IMPACT RESISTANT GLASS LENS, AND IES EXTRA VADE (10° DISTRIBUTION) FULL CUTOFF OPTICS. 3000K CCT.	LIGMAN: UVK-90001-37W-EW-W3 0-FINISH-120/277V	37W	12.5" DEEP 10.2" WIDE 3.7" HIGH		
BA2	POLE MOUNTED	SIMILAR TO TYPE BA1 EXCEPT WITH IES TYPE III OPTICAL DISTRIBUTION.	LIGMAN: UVK-90001-37W-EW-W3 0-FINISH-120/277V	37W	12.5" DEEP 10.2" WIDE 3.7" HIGH		
BB1	POLE MOUNTED	POLE MOUNTED LED DOWNLIGHT WITH DIE CAST LOW COPPER CONTENT ALUMINUM CONSTRUCTION HOUSING, MEMORY RETENTIVE SILICON GASKET, 10KV SURGE SUPPRESSION, UV STABILIZED BAKED POWDER COAT FINISH TO BE DETERMINED BY THE ARCHITECT, STAINLESS STEEL HARDWARE. LOW IRON, TEMPERED, IMPACT RESISTANT GLASS LENS, AND IES EXTRA VADE (10° DISTRIBUTION) FULL CUTOFF OPTICS. 3000K CCT.	LIGMAN: UMS-90281-38W-EW-W 30-FINISH-120/277V	38W	28.7" DEEP 12.6" WIDE 3.5" HIGH		
BB2	POLE MOUNTED	SIMILAR TO TYPE BB1 EXCEPT WITH TYPE III OPTICAL DISTRIBUTION.	LIGMAN: UMS-90281-38W-EW-W 30-FINISH-120/277V	38W	28.7" DEEP 12.6" WIDE 3.5" HIGH		
BC1	SURFACE	COMPACT, ONE-PIECE LED STEP LIGHT, UL WET LOCATION LISTED, LUMINAIRE PROVIDED WITH DIECAST FACE FRAME/LENS HOOD, INTEGRAL NON-DIM ELECTRONIC DIMMING DRIVER, MOUNTED IN CONTRACTOR-SUPPLIED DIECAST ALUMINUM W/TYPE FD J-BOX, ON CUSTOM STEEL MOUNTING PLATE. OPTIONAL FINISH AS SELECTED BY THE ARCHITECT. 3000K CCT.	SIGNIFY/CHLORIDE: PH-2-S-CUSTOM RAL FINISH	6W	4.5" HIGH 2.75" WIDE 1.5" DEEP		
BC2	SURFACE	SIMILAR TO TYPE BC1 EXCEPT RECESS MOUNTED IN CONCRETE WALL.	SIGNIFY/CHLORIDE: PH-2-S-CUSTOM RAL FINISH	6W	4.5" HIGH 2.75" WIDE 1.5" DEEP		
BD1	RECESSED IN-GRADE	RECESSED MOUNTED LED UPLIGHT WITH MACHINED COPPER FREE ALUMINUM CONSTRUCTION HOUSING WITH 4.5" DIAMETER SCHEDULE 80 PVC HOUSING FOR DIRECT BURIAL WITH 7.5" DIAMETER STABILITY FLANGE. MACHINED BRASS FACEPLATE. SHOCK RESISTANT, TEMPERED, LINEAR SPREAD GLASS LENS, SPOT DISTRIBUTION INTERCHANGEABLE OPTIC. 3000K CCT. STANDARD PAINTED FINISH TO BE DETERMINED BY THE ARCHITECT.	BR LIGHTING: B-UL-S-DE-LED-X59-SP-FI NISH-13	12W	5" DIAMETER 11.125" DEEP		

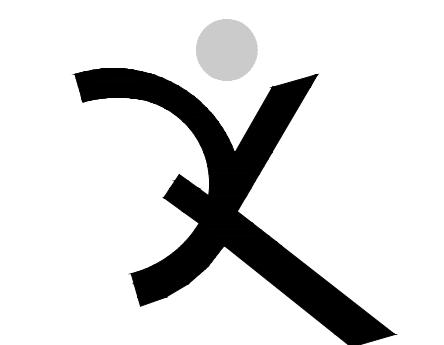

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REVISIONS	

ARCH PROJECT NO: 1802.00
DRAWN BY: DRAWING SCALE: AS NOTED


PRELIM DESIGN REVIEW
MARCH 3, 2020

SHEET TITLE:

LUMINAIRE SCHEDULE

SHEET NUMBER:

E-0.2

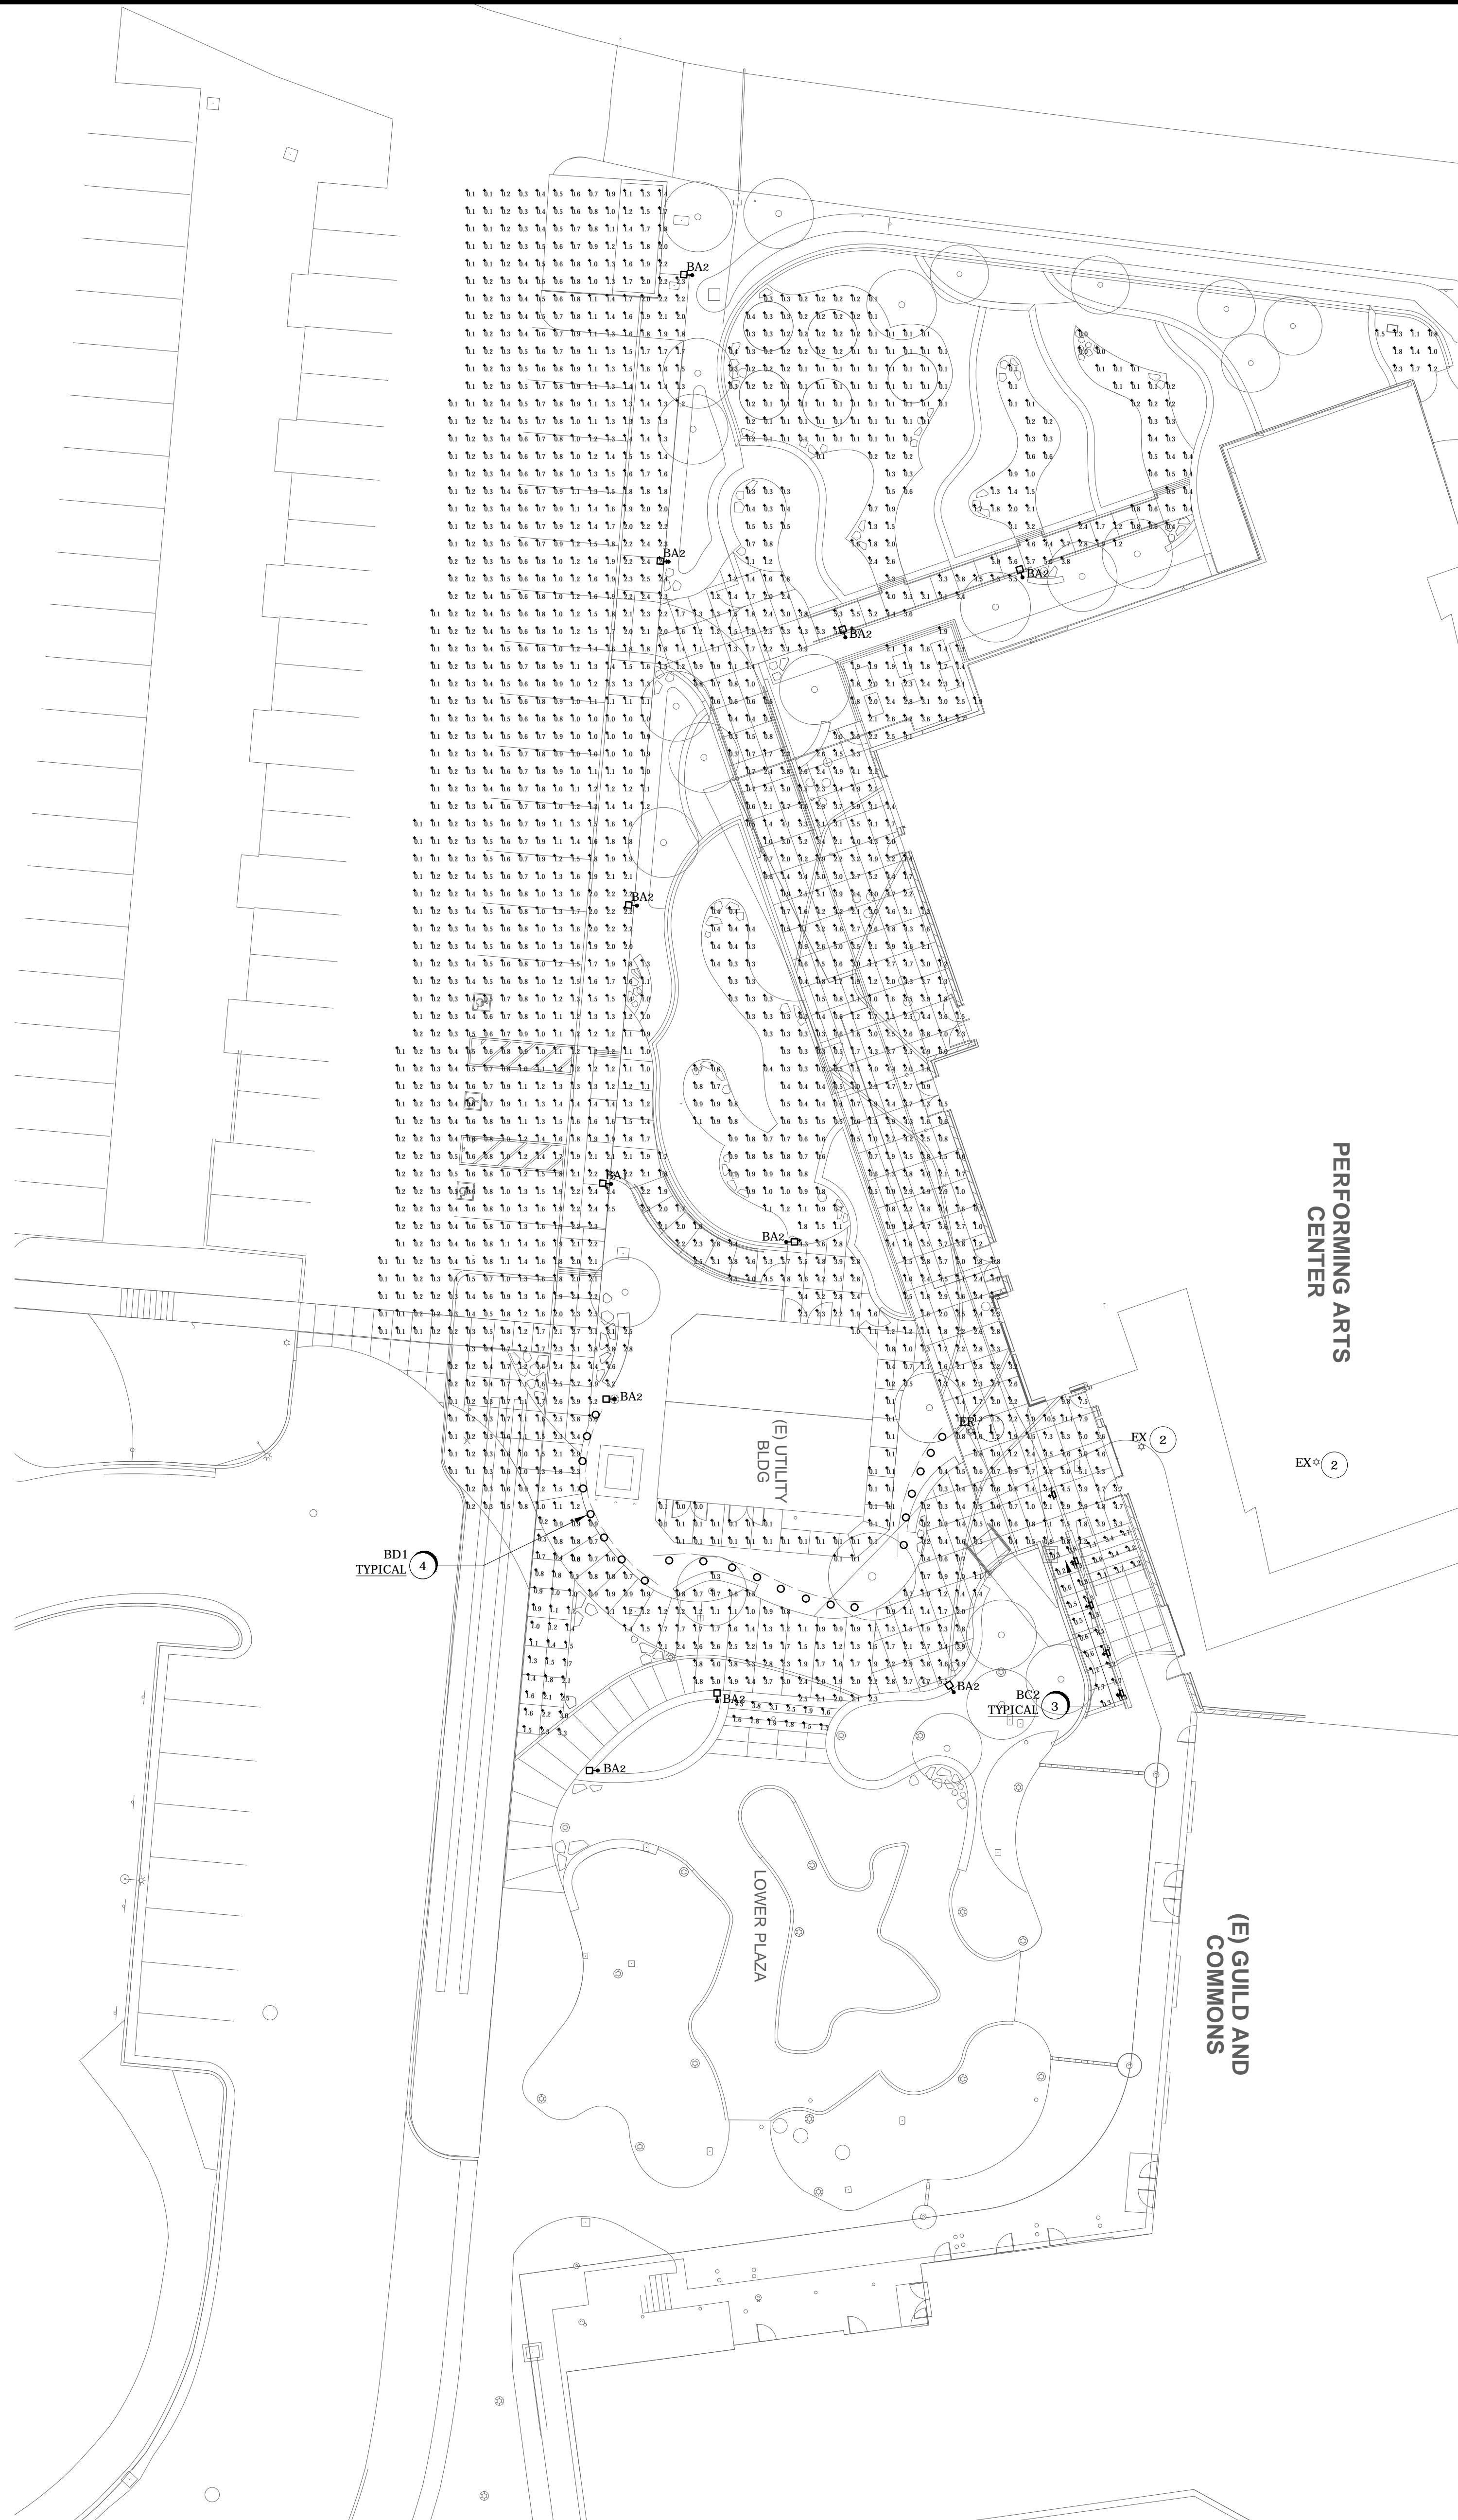

Luminaire Schedule							
Symbol	Qty	Label	Arrangement	LIF	Description	Tag	Lum. Lumens
○	20	LED-e66-MFL-13-ITL85924	SINGLE	0.800	AR-LED-TR-e66-MFL-13	AA1-LS	394
○	3	LED-e66-MFL-12-ITL85922	SINGLE	0.800	AR-LED-TR-e66-MFL-12	AA1	458
○	3	LEE-30011-T3-W30	SINGLE	0.800	LEE-30011-T3-W30	A01	1376
□	7	VK-90001-T3-W30	SINGLE	0.800	VK-90001-T3-W30	BA2	3192
□	1	MS-90281-EW-W30	SINGLE	0.800	MS-90281-EW-W30	BB1	3586
□	3	MS-90281-T3-W30	SINGLE	0.800	MS-90281-T3-W30	BB2	3351
□	4	id68147	SINGLE	0.800	PATHMASTER-P1S (HIGH)	BC1	149


Calculation Summary							
Label	CalcType	Units	Avg	Max	Min	Avg/Min	Max/Min
+3° GRADE_Top	Illuminance	Fc	1.38	11.1	0.0	N.A.	N.A.
RAMP_Planar	Illuminance	Fc	1.26	8.1	0.2	6.30	40.50
RAMP1_RAMP1	Illuminance	Fc	1.35	3.3	0.0	N.A.	N.A.
STAIRS_1_Planar	Illuminance	Fc	2.97	4.7	0.9	3.30	5.22
STAIRS_Planar	Illuminance	Fc	2.28	4.5	1.3	1.75	3.46

GENERAL NOTES


- SEE SHEET E-2.1 AND E-2.3 FOR BUILDING MOUNTED LUMINAIRES.
- TYPE BA POLE MOUNTED LUMINAIRES HAVE A 12' OVERALL HEIGHT.
- TYPE BB POLE MOUNTED LUMINAIRES HAVE A 20' OVERALL HEIGHT TO MATCH EXISTING PARKING LOT LUMINAIRES.
- EXISTING LIGHTING TO REMAIN AT EXISTING UTILITY BUILDING AND GUILD AND COMMONS: U.O.N.

NUMBERED NOTES

- EXISTING POLE MOUNTED AREA LIGHT TO BE RELOCATED. REMOVE LUMINAIRE, DEMO EXISTING CONCRETE ANCHOR BASE, AND INSTALL IN NEW LOCATION (T.B.D) ON NEW ANCHOR BASE.
- EXISTING POLE MOUNTED AREA LIGHT TO BE DISCONNECTED, REMOVED, AND RETURNED TO OWNER.
- RECESSED AT 1'-6" A.F.G.
- IN-GRADE UPLIGHT FOR DECORATIVE PANEL ACCENT.

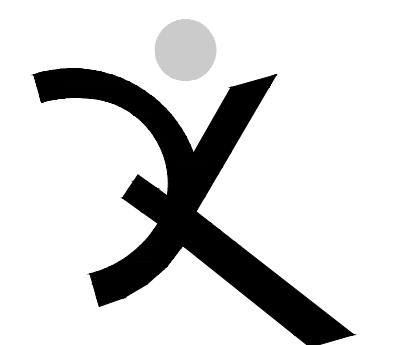

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ARCH PROJECT NO: 1802.00
DRAWN BY:
DRAWING SCALE: AS NOTEDPRELIM DESIGN REVIEW
MARCH 3, 2020

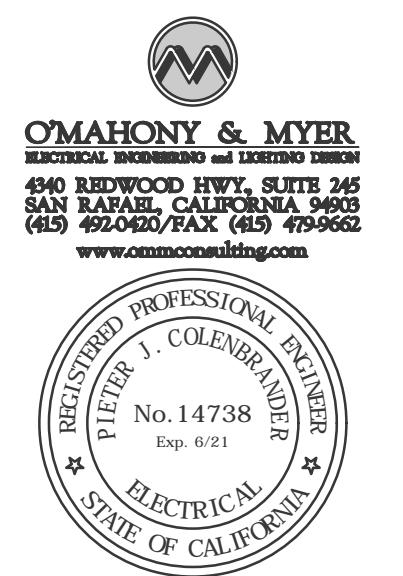SHEET TITLE:

SITE PLAN -
LIGHTING -
LOWER PLAZA

SHEET NUMBER:

E-1.2



Luminaire Schedule		Label	Arrangement	LLF	Description	Tag	Lum. Lumens
Symbol	Qty						
○	5	LED-e66-MFL-12-IT185922	SINGLE	0.800	AR-LED-TR-e66-MFL-12	AA1	458
○	16	LED-e66-MFL-13-IT185924	SINGLE	0.800	AR-LED-TR-e66-MFL-13	AA1-LS	394
□	2	LEE-30011-T3-W30	SINGLE	0.800	LEE-30011-T3-W30	AO1	1376
□	2	VK-90001-EW-W30	SINGLE	0.800	VK-90001-EW-W30	BA1	3457
□	5	VK-90001-T3-W30	SINGLE	0.800	VK-90001-T3-W30	BA2	3192
□	10	itl68147	SINGLE	0.800	PATHMASTER - P1S (HIGH)	BC1	149

Calculation Summary						
Label	CalcType	Units	Avg	Max	Min	Avg/Min
CENTRAL EAST WALK	Illuminance	Fc	2.46	5.8	0.2	12.30
NORTHEAST WALK	Illuminance	Fc	4.32	8.5	0.0	N.A.
UPPER PLAZA GRADE	Illuminance	Fc	2.08	9.1	0.0	N.A.


GENERAL NOTES

1. SEE SHEETS E-2.1 AND E2.3 FOR BUILDING MOUNTED LUMINAIRES.

2. TYPE BA POLE MOUNTED LUMINAIRES HAVE A 12' OVERALL HEIGHT.

NUMBERED NOTES

- 1 EXISTING POLE MOUNTED AREA LIGHT TO BE RELOCATED. REMOVE LUMINAIRE, DEMO EXISTING CONCRETE ANCHOR BASE, AND INSTALL IN NEW LOCATION (T.B.D) ON NEW ANCHOR BASE.
- 2 EXISTING POLE MOUNTED AREA LIGHT TO BE DISCONNECTED, REMOVED, AND RETURNED TO OWNER.
- 3 RAIL INTEGRATED STEP LIGHTS AT 2'-0" A.F.G.
- 4 IN-GRADE UPLIGHT FOR DECORATIVE PANEL ACCENT.

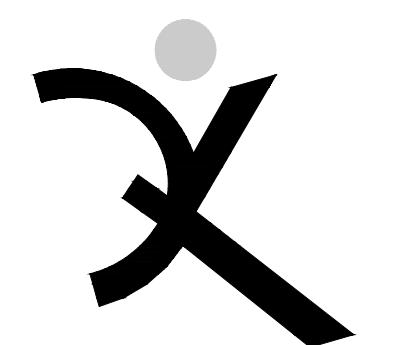

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ARCH PROJECT NO: 1802.00

DRAWN BY:

DRAWING SCALE: AS NOTED




PRELIM DESIGN REVIEW
MARCH 3, 2020

SHEET TITLE


SITE PLAN -
LIGHTING -
UPPER PLAZA

SHEET NUMBER

E-1.3

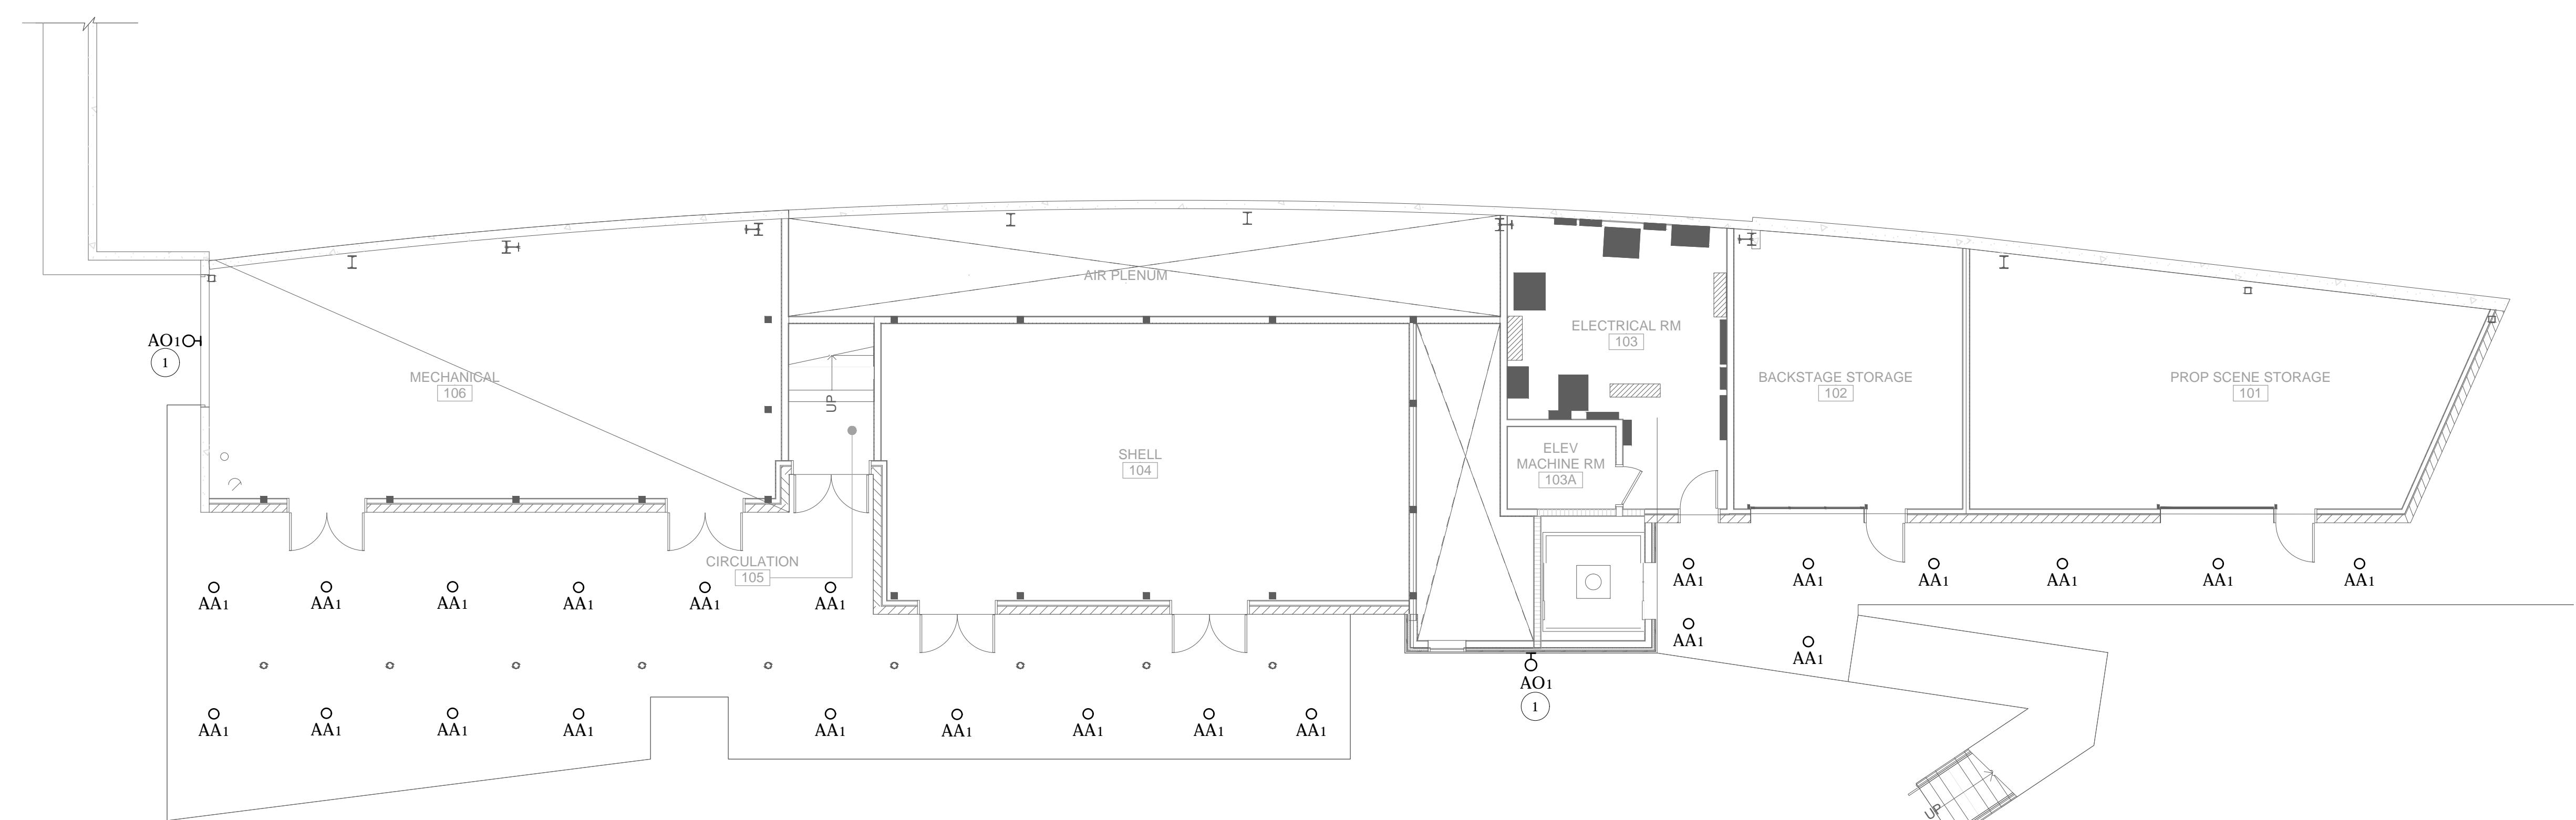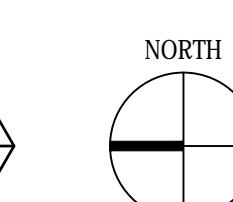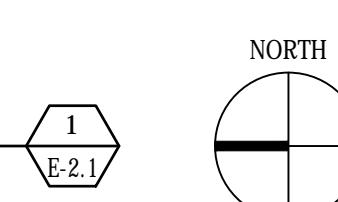GROUND FLOOR PLAN - LIGHTING
SCALE: 1/8" = 1'-0"


NUMBERED SHEET NOTES	
(1)	WALL MOUNTED AT 10'-0" A.F.F. TO THE BOTTOM OF THE LUMINAIRE.
GENERAL NOTES	
1.	SEE SHEETS E-1.2 AND E-1.3 FOR SITE LIGHTING.
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ARCH PROJECT NO:	1802.00
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DRAWING SCALE:	AS NOTED
PRELIM DESIGN REVIEW	
MARCH 3, 2020	
SHEET TITLE	
GROUND FLOOR PLAN - LIGHTING	
SHEET NUMBER	
E-2.1	

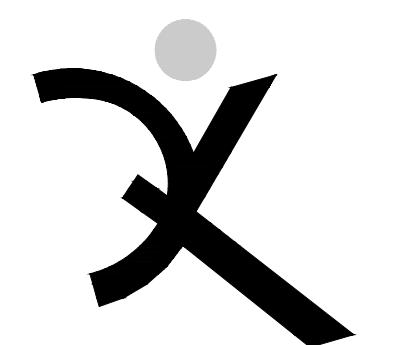

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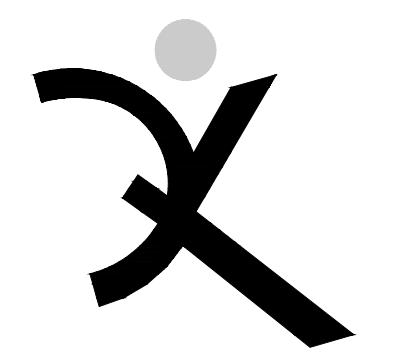


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NUMBERED SHEET NOTES

① WALL MOUNTED AT 10'-0" A.F.F. TO THE BOTTOM OF THE LUMINAIRE.

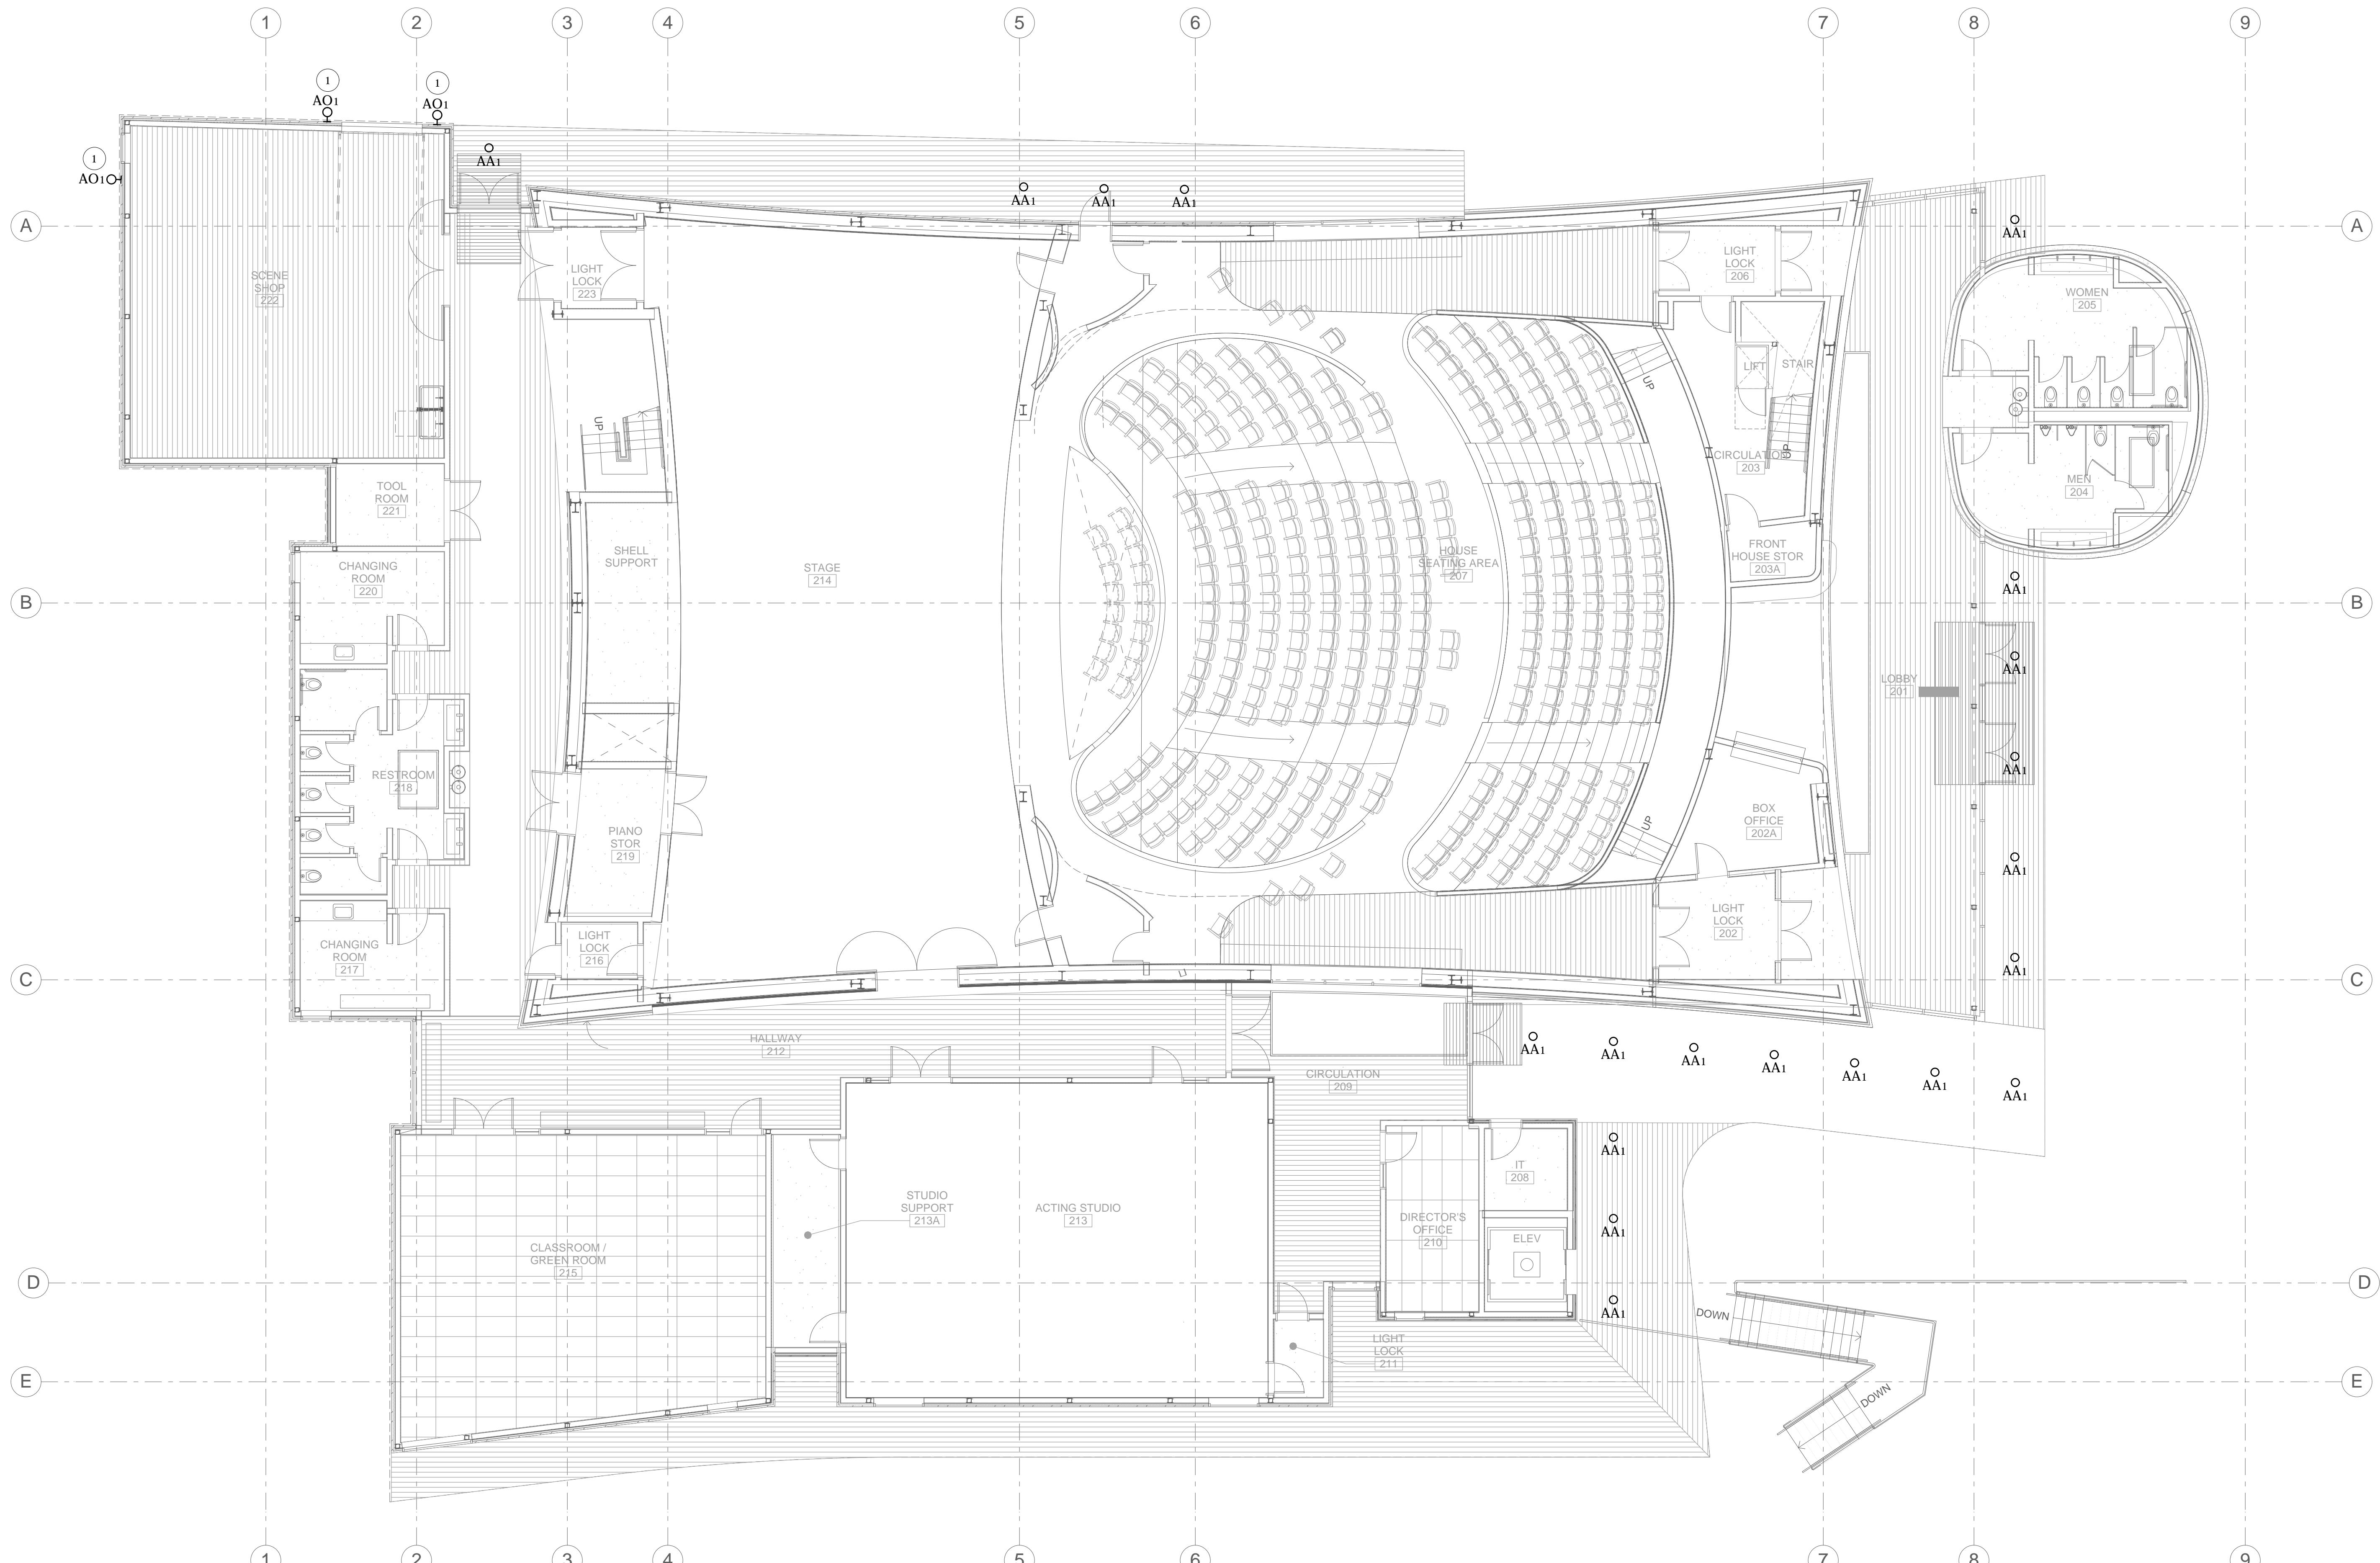

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ARCH PROJECT NO: 1802.00
DRAWN BY:
DRAWING SCALE: AS NOTED

PRELIM DESIGN REVIEW
MARCH 3, 2020

SHEET TITLE
MAIN FLOOR
PLAN -
LIGHTING

SHEET NUMBER

E-2.3