AT&T

CCL02094 FIRSTNET/AT&T SITE ID: FIRSTNET/AT&T SITE NAME: NORTHPOINT FA LOCATION CODE: 10547968 **USID:** 325581

PACE ID: MRSFR002840 PSTC SITE #: **CANC-SROSA01 2715 GIFFEN AVE** SITE ADDRESS: SANTA ROSA, CA 95407

COUNTY: SONOMA SITE TYPE: MONOPINE

80'-0" **TOWER HEIGHT:** 

**LOCATION MAP** 

Giffen Ave Giffen Ave Giffen Ave

# 1903 WRIGHT PLACE, SUITE 140 CARLSBAD, CA 92008





AT&T/FIRSTNET ID: CCL02094 NORTHPOINT

PSTC #: CANC-SROSA01 **GIFFEN AVENUE PROPERTY** 

**2715 GIFFEN AVE** SANTA ROSA, CA 95407 (SONOMA COUNTY)

PROPOSED 80'-0" **MONOPINE TOWER** 

4		PROJECT MANAGER:			ISSUE	D FOR:	
╛		DATE:	REV	DATE	DRWN	DESCRIPTION	QA
	NO SCALI		G	02-01-23	550	ZONING	НММ
1			Н	03-28-23	550	ZONING	НММ
1			1	04-21-23	RCH	ZONING	HMM
-	DIRECTIONS FROM 5005 EXECUTIVE PARKWAY, SAN RAMON, CA:		J	09-29-23	CAM	ZONING	НММ
	HEAD WEST AND TURN RIGHT ONTO EXECUTIVE PARKWAY. MAKE A LEFT ON	, , , , , , , , , , , , , , , , , , ,	K	01-04-24	SKK	ZONING	НММ
$\checkmark$	ONTO I-680 N TO SACRAMENTO. CONTINUE ON I-680 N AND TAKE EXIT 58A FOR	-780 TOWARD BENICIA/VALLEJO. CONTINUE ON I-780 W THEN TAKE EXIT					

SEAL:

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IT IS A VIOLATION OF LAW FOR ANY PERSON, UNLESS THEY ARE ACTING UNDER THE DIRECTION OF A LICENSED PROFESSIONAL ENGINEER,

SHEET TITLE:

TITLE SHEET

**SHEET NUMBER:** 

**REVISION:** 

TEP #: 314201.336187

#### SITE INFORMATION

**NORTHPOINT** 

**PSTC SITE NAME:** 

SITE ADDRESS:

**2715 GIFFEN AVE** 

SANTA ROSA, CA 95407

SONOMA **COUNTY:** 010-450-008

**AREA OF CONSTRUCTION:** 2,640 SQ FT N 38° 25' 03.16" (38.417544°) [NAD83] LATITUDE:

LONGITUDE: W 122° 45' 01.67" (-122.750464°) [NAD83] **GROUND ELEVATION:** 109.0' [NAVD88]

**CURRENT ZONING: SONOMA COUNTY** JURISDICTION:

OCCUPANCY CLASSIFICATION: U **TYPE OF CONSTRUCTION:** 

A.D.A. COMPLIANCE: **FACILITY IS UNMANNED AND NOT FOR HUMAN** 

**PROPERTY OWNER:** GIFFEN AVENUE PROPERTY LLC

1206 4TH ST SANTA ROSA, CA 95404

CARLSBAD, CA 92008

PROJECT TEAM

1903 WRIGHT PLACE, SUITE 140

T.AVENA@PSTCTOWERS.COM

4710 E ELWOOD ST, STE 9

DWAITE@TEPGROUP.NET

ANDREW T. HALDANE, PE

MARK QUAKENBUSH, PE

AHALDANE@TEPGROUP.NET

MQUAKENBUSH@TEPGROUP.NET

**TOWER ENGINEERING PROFESSIONALS** 

CARLSBAD, CA 92008

**TANYA AVENA** 

(661) 755-1471

(231) 409-5439

(919) 661-6351

(919) 661-6351

**AHMAD WAQAS** 

AW564W@ATT.COM

**PHOENIX, AZ 85040** 

**TOWER OWNER: PUBLIC SAFETY TOWERS, LLC** 1903 WRIGHT PLACE, SUITE 140

**CARRIER/APPLICANT:** AT&T

**5005 EXECUTIVE PKWY** SAN RAMON, CA 94583

**ELECTRIC PROVIDER:** PG&E **TBD** TELCO PROVIDER:

**PUBLIC SAFETY TOWERS, LLC** 

**SITE ACQUISITION CONTACT:** 

**TEP PROJECT TEAM:** 

**CIVIL ENGINEER:** 

**AT&T PROJECT TEAM:** 

RF ENGINEER:

**ELECTRICAL ENGINEER:** 

**CONTACT:** 

# **DRAWING INDEX**

SHEET#	SHEET DESCRIPTION	REV
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LS-2	SITE SURVEY	1
LS-3	SITE SURVEY	1
LS-4	NOTES	1
C-1.1	SITE PLAN	J
C-1.2	COMPOUND LAYOUT	J
C-2.1	FINAL SOUTH ELEVATION	J
C-2.2	FINAL NORTH ELEVATION	J
C-2.3	FINAL EAST ELEVATION	J
C-2.4	FINAL WEST ELEVATION	J
C-3	FINAL ANTENNA LAYOUT & SCHEDULE	J
C-4	WALK-UP-CABINET DETAILS	J
C-5	GENERATOR DETAILS	J
C-6	BATTERY DETAILS	J
E-1	ELECTRICAL AC PANEL SCHEDULE	J
E-2	ELECTRICAL ONE-LINE DIAGRAM	J
CONTRACTOR	GS CONTAINED HEREIN ARE FORMATTED FOR 2 SHALL VERIFY ALL PLANS AND EXISTING DIMEI NS ON THE JOB SITE AND SHALL IMMEDIATELY	VSIONS

THE ENGINEER IN WRITING OF ANY DISCREPANCIES BEFORE PROCEEDING WITH THE WORK OR BE RESPONSIBLE FOR SAME.

#### PROJECT DESCRIPTION

THE PURPOSE OF THIS PROJECT IS TO ENHANCE BROADBAND CONNECTIVITY AND CAPACITY IN THE AREA FOR EMERGENCY SERVICE AND WIRELESS CUSTOMERS.

- **INSTALL (18) RADIOS**
- **INSTALL (3) DC9 FIBER SQUIDS**
- **DEREK WAITE**

#### GROUND SCOPE OF WORK

- **INSTALL GRAVEL DRIVEWAY**

- **INSTALL (1) WALK-UP-CABINET (WUC)**
- **INSTALL (1) 30 KW DIESEL GENERATOR**
- **INSTALL (8) BATTERIES**

#### TOWER SCOPE OF WORK

- **INSTALL 80'-0" MONOPINE TOWER**
- **INSTALL (12) ANTENNAS ON (9) MOUNT PIPES**
- **INSTALL (9) DC POWER TRUNKS**
- **INSTALL (3) FIBER TRUNKS**
- **INSTALL (3) SECTOR MOUNTS**

INSTALL 23'-0"x98'-0"x6'-0"(LxWxH) CMU WALL COMPOUND

- INSTALL (1) 600A GUTTER AND 200A METER ON PROPOSED H-FRAME
- **INSTALL (1) EQUIPMENT PLATFORM INSTALL (1) 17'-7"x10'-4" CONCRETE PAD**
- **INSTALL (1) ICE BRIDGE**
- **INSTALL (1) RAYCAP DC50 SURGE SUPPRESSION CABINET**
- INSTALL (1) PTLC W/CAMLOCK AND INTEGRATED ATS

# APPLICABLE CODES/REFERENCE DOCUMENTS

1B TOWARD SACRAMENTO. MERGE ONTO I-80 E THEN TAKE EXIT 33 FOR CA-37 TOWARD NAPA. CONTINUE ON CA-37 W THEN TURN RIGHT ONTO

THEN TURN RIGHT ONTO STONY POINT ROAD. TURN LEFT ONTO NORTHPOINT PARKWAY. TURN RIGHT ONTO LOMBARDI LANE. TURN LEFT.

LAKEVILLE HIGHWAY. TURN RIGHT TO MERGE ONTO US-101 N TOWARD EUREKA. TAKE EXIT 487 TOWARD YOLANDA AVE/HEARN AVE. TAKE HEARN AVE,

ALL WORK SHALL BE PERFORMED AND MATERIALS INSTALLED IN ACCORDANCE WITH THE CURRENT EDITIONS OF THE FOLLOWING CODES AS ADOPTED BY THE LOCAL GOVERNING AUTHORITIES. NOTHING IN THESE PLANS IS TO BE CONSTRUED TO PERMIT WORK NOT CONFORMING TO THESE CODES:

CODE TYPE 2023 CBC (2021 IBC) BUILDING 2023 CMC (2021 UMC) **MECHANICAL ELECTRICAL** 

2023 CEC (2020 NEC) **STRUCTURAL** EIA/TIA-222-H

**REFERENCE DOCUMENTS:** 

RFDS VERSION: 1.00 DATED: 12/21/2022



SITE AQUISITION

**CONSTRUCTION MANAGER** 

**PROPERTY OWNER** 

**ZONING:** 

**CALL CALIFORNIA ONE CALL** (800) 227-2600 **CALL 3 WORKING DAYS BEFORE YOU DIG!** 

**APPROVALS** 

# PROJECT NOTES:

- 1. ALL REFERENCES MADE TO OWNER IN THESE DOCUMENTS SHALL BE CONSIDERED PUBLIC SAFETY TOWERS. LLC OR ITS DESIGNATED REPRESENTATIVE.
- 2. ALL WORK PRESENTED ON THESE DRAWINGS MUST BE COMPLETED BY THE CONTRACTOR UNLESS NOTED OTHERWISE. THE CONTRACTOR MUST HAVE CONSIDERABLE EXPERIENCE IN THE PERFORMANCE OF WORK SIMILAR TO THAT DESCRIBED HEREIN. BY ACCEPTANCE OF THIS ASSIGNMENT, THE CONTRACTOR IS ATTESTING TO HAVE SUFFICIENT EXPERIENCE AND ABILITY, IS KNOWLEDGEABLE OF THE WORK TO BE PERFORMED AND THAT IS PROPERLY LICENSED AND PROPERLY REGISTERED TO DO THIS WORK IN THE STATE THE TOWER IS LOCATED.
- 3. THE STRUCTURE SHALL BE DESIGNED IN ACCORDANCE WITH ANSI/TIA-222-H AND CONFORM TO THE REQUIREMENTS OF THE 2022 CALIFORNIA BUILDING CODE.
- 4. WORK SHALL BE COMPLETED IN ACCORDANCE WITH THE 2022 CALIFORNIA BUILDING CODE.
- 5. UNLESS SHOWN OR NOTED OTHERWISE ON THE CONTRACT DRAWINGS, OR IN THE SPECIFICATIONS, THE FOLLOWING NOTES SHALL APPLY TO THE MATERIALS LISTED HEREIN, AND TO THE PROCEDURES TO BE USED ON THIS PROJECT.
- 6. ALL HARDWARE ASSEMBLY MANUFACTURER'S INSTRUCTION SHALL BE FOLLOWED EXACTLY AND SHALL SUPERSEDE ANY CONFLICTING NOTES ENCLOSED HEREIN.
- 7. IT IS THE CONTRACTOR'S SOLE RESPONSIBILITY TO DETERMINE ERECTION PROCEDURE AND SEQUENCE TO ENSURE THE SAFETY OF THE STRUCTURE AND ITS COMPONENT PARTS DURING ERECTION AND/OR FIELD MODIFICATIONS. THIS INCLUDES, BUT NOT LIMITED TO, THE ADDITION OF TEMPORARY BRACING, GUYS OR TIE DOWNS THAT MAY BE NECESSARY. SUCH MATERIAL SHALL BE REMOVED AND SHALL REMAIN THE PROPERTY OF THE CONTRACTOR AFTER THE COMPLETION OF THE PROJECT.
- 8. ALL DIMENSIONS, ELEVATIONS, AND EXISTING CONDITIONS SHOWN ON THE DRAWINGS SHALL BE FIELD VERIFIED BY THE CONTRACTOR PRIOR TO BEGINNING ANY MATERIALS ORDERING, FABRICATION OF CONSTRUCTION WORK ON THIS PROJECT. CONTRACTOR SHALL NOT SCALE CONTRACT DRAWINGS IN LIEU OF FIELD VERIFICATION. ANY DISCREPANCIES SHALL BE IMMEDIATELY BROUGHT TO THE ATTENTIONS OF THE OWNER AND THE OWNER'S ENGINEER. THE DISCREPANCIES MUST BE RESOLVED BEFORE THE CONTRACTOR IS TO PROCEED WITH THE WORK. THE CONTRACT DOCUMENTS DO NOT INDICATE THE METHOD OF CONSTRUCTION THE CONTRACTOR SHALL SUPERVISE AND DIRECT THE WORK AND SHALL BE SOLELY RESPONSIBLE FOR ALL CONSTRUCTION MEANS, METHODS, TECHNIQUES, SEQUENCES, AND PROCEDURES, OBSERVATION VISITS TO THE SITE BY THE OWNER AND/OR THE ENGINEER SHALL NOT INCLUDE INSPECTION OF THE PROTECTIVE MEASURES OR THE PROCEDURES.
- 9. ALL MATERIALS AND EQUIPMENT FURNISHED SHALL BE NEW AND OF GOOD QUALITY, FREE FROM FAULTS AND DEFECTS AND IN CONFORMANCE WITH THE CONTRACT DOCUMENTS. ANY AND ALL SUBSTITUTIONS MUST BE PROPERLY APPROVED AND AUTHORIZED IN WRITING BY THE OWNER AND ENGINEER PRIOR TO INSTALLATION. THE CONTRACTOR SHALL FURNISH SATISFACTORY EVIDENCE AS TO THE KIND AND QUALITY OF THE MATERIALS AND EQUIPMENT BEING SUBSTITUTED.
- 10. THE CONTRACTOR SHALL BE RESPONSIBLE FOR INITIATING, MAINTAINING, AND SUPERVISING ALL SAFETY PRECAUTIONS AND PROGRAMS IN CONNECTION WITH THE WORK. THE CONTRACTOR IS RESPONSIBLE FOR ENSURING THAT THIS PROJECT AND RELATED WORK COMPLIES WITH ALL APPLICABLE LOCAL. STATE, AND FEDERAL SAFETY CODES AND REGULATIONS GOVERNING THIS WORK. RENTAL CHARGES. SAFETY. PROTECTION. AND MAINTENANCE OF RENTED EQUIPMENT SHALL BE THE CONTRACTOR'S RESPONSIBILITY.
- 11. ACCESS TO THE PROPOSED WORK SITE MAY BE RESTRICTED. THE CONTRACTOR SHALL COORDINATE INTENDED CONSTRUCTION ACTIVITY, INCLUDING WORK SCHEDULE AND MATERIALS ACCESS, WITH THE OWNER PROJECT MANAGER. THIS INCLUDES ALL SPECIFIC MILITARY INSTALLATION INSTRUCTIONS INCLUDING STAFF ACCESS AND GATE SPECIFIC INSTRUCTIONS.
- 12. BILL OF MATERIALS AND PART NUMBERS LISTED ON CONSTRUCTION DRAWINGS ARE INTENDED TO AID CONTRACTOR/OWNER. CONTRACTOR/OWNER SHALL VERIFY PARTS AND QUANTITIES WITH MANUFACTURER PRIOR TO BIDDING AND/OR ORDERING MATERIALS.
- 13. ALL PERMITS THAT MUST BE OBTAINED ARE THE RESPONSIBILITY OF THE CONTRACTOR. THE CONTRACTOR WILL BE RESPONSIBLE FOR ABIDING BY ALL CONDITIONS AND REQUIREMENTS OF THE PERMITS.
- 14. 24 HOURS PRIOR TO THE BEGINNING OF ANY CONSTRUCTION, THE CONTRACTOR MUST NOTIFY THE APPLICABLE JURISDICTIONAL (STATE, COUNTY OR CITY) ENGINEER AS WELL AS ANY REQUIRED NOTICES SPECIFIC TO THE MILITARY INSTITUTION.
- 15. THE CONTRACTOR SHALL REWORK (DRY, SCARIFY, ETC.) ALL MATERIAL NOT SUITABLE FOR SUBGRADE IN ITS PRESENT STATE. AFTER REWORKING, IF THE MATERIAL REMAINS UNSUITABLE, THE CONTRACTOR SHALL UNDERCUT THIS MATERIAL AND REPLACE WITH APPROVED MATERIAL. ALL SUBGRADES SHALL BE PROOFROLLED WITH A FULLY LOADED TANDEM AXLE DUMP TRUCK PRIOR TO PAVING. ANY SOFT MATERIALS HALL BE REWORKED OR REPLACED.
- 16. THE CONTRACTOR IS REQUIRED TO MAINTAIN ALL PIPES, DITCHES, AND OTHER DRAINAGE STRUCTURES FREE FROM OBSTRUCTION UNTIL WORK IS ACCEPTED BY THE OWNER. THE CONTRACTOR IS RESPONSIBLE FOR ANY DAMAGES CAUSED BY FAILURE TO MAINTAIN DRAINAGE STRUCTURE IN OPERABLE CONDITION.
- 17. THE OWNER OR OWNERS REPRESENTATIVE SHALL HAVE A SET OF APPROVED PLANS AVAILABLE AT THE SITE AT ALL TIMES WHILE WORK IS BEING PERFORMED. A DESIGNATED RESPONSIBLE EMPLOYEE SHALL BE AVAILABLE FOR CONTACT BY GOVERNING AGENCY INSPECTORS.

- 18. ANY BUILDINGS ON THIS SITE ARE INTENDED TO SHELTER EQUIPMENT WHICH WILL ONLY BE PERIODICALLY MAINTAINED AND ARE NOT INTENDED FOR HUMAN OCCUPANCY.
- 19. TEMPORARY FACILITIES FOR PROTECTION OF TOOLS AND EQUIPMENT SHALL CONFORM TO LOCAL REGULATIONS AND SHALL BE THE CONTRACTOR'S RESPONSIBILITY.
- 20. THE CONTRACTOR AND ITS SUBCONTRACTORS SHALL CARRY LIABILITY INSURANCE IN THE AMOUNTS AND FORM IN ACCORDANCE WITH OWNER SPECIFICATIONS. CERTIFICATES DEMONSTRATING PROOF OF COVERAGE SHALL BE PROVIDED TO OWNER PRIOR TO THE START OF THE WORK ON THE PROJECT.
- 21. THE CONTRACTOR SHALL CONTACT ALL APPLICABLE UTILITY SERVICES TO VERIFY LOCATIONS OF EXISTING UTILITIES AND REQUIREMENTS FOR NEW UTILITY CONNECTIONS PRIOR TO EXCAVATING.
- 22. THE CONTRACTOR SHALL MAINTAIN THE JOB CLEAR OF TRASH AND DEBRIS. ALL WASTE MATERIALS SHALL BE REMOVED FROM THE SITE PRIOR TO THE SUBSTANTIAL COMPLETION AND PRIOR TO FINAL ACCEPTANCE. THE CONTRACTOR SHALL FURNISH ONE 55 GALLON BARREL OR EQUIVALENT, AND TRASH BAGS, AND SHALL REMOVE TRASH, DEBRIS, ETC., ON A DAILY BASIS.
- 23. THE CONTRACTOR SHALL VISIT THE SITE AND BECOME FAMILIAR WITH ALL CONDITIONS PRIOR TO SUBMITTING THE PROPOSAL. CONTRACTOR SHALL VERIFY ALL DIMENSIONS AND CONDITIONS SHOWN ON THESE DRAWINGS WITH THOSE AT THE SITE. ANY VARIATION WHICH REQUIRES PHYSICAL CHANGE SHALL BE BROUGHT TO THE ATTENTION OF THE OWNER PROJECT ENGINEER FOR FACILITIES/CONSTRUCTION.
- 24. THE CONTRACTOR SHALL GUARANTEE THE WORK PERFORMED ON THE PROJECT BY THE CONTRACTOR AND ANY OR ALL OF THE SUBCONTRACTORS WHO PERFORMED WORK FOR THE CONTRACTOR ON THIS PROJECT. THE GUARANTEE SHALL BE FOR A FULL YEAR FOLLOWING ISSUANCE OF THE FINAL PAYMENT OF RETAINAGE. ALL MATERIALS AND WORKMANSHIP SHALL BE WARRANTED FOR ONE YEAR FROM ACCEPTANCE DATE.
- 25. THE CONTRACTOR SHALL PROVIDE DAILY UPDATES IN THE FORM OF WRITTEN NOTIFICATION VIA EMAIL OR APP PHOTOS TO THE BOINGO CONSTRUCTION MANAGER.

# **UTILITY NOTES:**

- 1. APPLY FOR THE UTILITY SERVICE (ELECTRIC) NO LATER THAN THE NEXT BUSINESS DAY FOLLOWING AWARD OF CONTRACT. COORDINATE WITH THE ELECTRIC UTILITY COMPANY FOR EXACT TRANSFORMER LOCATION. METERING REQUIREMENTS. AND THE SERVICE ROUTING. COORDINATE WITH THE TELEPHONE UTILITY COMPANY FOR EXACT TELEPHONE REQUIREMENTS AND ROUTING OF
- 2. ALL UTILITY RELATED WORK SHALL BE PERFORMED IN ACCORDANCE WITH APPLICABLE UTILITY REQUIREMENTS. FIELD TO VERIFY EXISTING UTILITY LOCATIONS PRIOR TO CONSTRUCTION.
- 3. THE CONTRACTOR SHALL CONTACT UTILITIES AND LOCATOR SERVICE A MINIMUM OF 72 HOURS PRIOR TO THE START OF CONSTRUCTION.
- 4. CONTRACTOR SHALL PROVIDE TRENCHING AND CONDUITS AS SHOWN OR AS REQUIRED BY LOCAL UTILITY.
- 5. NO PENETRATIONS TO THE TOWER FOUNDATION OF ANY KIND.







AT&T/FIRSTNET ID: CCL02094 NORTHPOINT

PSTC #: CANC-SROSA01 **GIFFEN AVENUE PROPERTY** 

2715 GIFFEN AVE SANTA ROSA, CA 95407 (SONOMA COUNTY)

PROPOSED 80'-0" MONOPINE TOWER

	ISSUED FOR:						
	REV	DATE	DRWN	DESCRIPTION	QA		
I	G	02-01-23	550	ZONING	НММ		
	Н	03-28-23	550	ZONING	НММ		
	1	04-21-23	RCH	ZONING	НММ		
	J	09-29-23	CAM	ZONING	НММ		
I	K	01-04-24	SKK	ZONING	НММ		

SEAL:




IT IS A VIOLATION OF LAW FOR ANY PERSON, UNLESS THEY ARE ACTING UNDER THE DIRECTION OF A LICENSED PROFESSIONAL ENGINEER, TO ALTER THIS DOCUMENT.

SHEET TITLE:

**GENERAL NOTES** 

SHEET NUMBER: REVISION: GN-1

TEP #: 314201.336187

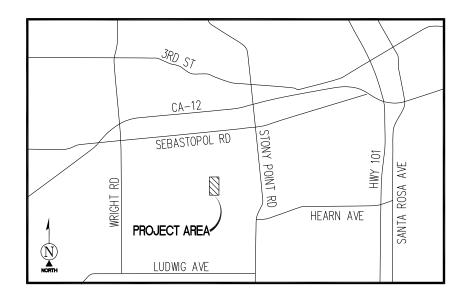

<u>VICINITY MAP</u> N.T.S.

SURVEY DATE 10/05/2022

#### BASIS OF BEARING

BEARINGS SHOWN HEREON ARE BASED UPON THE CALIFORNIA ZONE 2 STATE PLANE COORDINATE SYSTEM BASED ON THE NORTH AMERICAN DATUM OF 1983(2011) (EPOCH 2019.25). DETERMINED BY GLOBAL POSITIONING SYSTEM EQUIPMENT ON THE SMARTNET REFERENCE NETWORK.

#### BENCHMARK

PROJECT ELEVATIONS ESTABLISHED FROM GPS DERIVED
ORTHOMETRIC HEIGHTS BY APPLICATION OF NGS 'GEOID 12B'
MODELED SEPARATIONS TO ELLIPSOID HEIGHTS DETERMINED BY
OBSERVATIONS OF THE 'SMARTNET' REAL TIME NETWORK. ALL
ELEVATIONS SHOWN HEREON ARE REFERENCED TO NAVD88.

GRID-TO-GROUND SCALE FACTOR NOTE

ALL BEARINGS AND DISTANCES ARE BASED ON THE CALIFORNIA
TWO STATE PLANE COORDINATE ZONE GRID. TO DERIVE GROUND
DISTANCES DIVIDE BY 0.99998248

#### FLOOD ZONE

THIS PROJECT APPEARS TO BE LOCATED WITHIN FLOOD ZONE "X". ACCORDING TO FEDERAL EMERGENCY MANAGEMENT AGENCY FLOOD INSURANCE RATE MAP(S), MAP ID #06097C0717G, DATED 07/19/2022

#### UTILITY NOTES

SURVEYOR DOES NOT GUARANTEE THAT ALL UTILITIES ARE SHOWN OR THEIR LOCATIONS ARE DEFINITE. IT IS THE RESPONSIBILITY OF THE CONTRACTOR AND DEVELOPER TO CONTACT 811 AND ANY OTHER INVOLVED AGENCIES TO LOCATE ALL UTILITIES PRIOR TO CONSTRUCTION. REMOVAL, RELOCATION AND/OR REPLACEMENT IS THE RESPONSIBILITY OF THE CONTRACTOR.


#### SURVEYOR'S NOTES


CONTOURS DERIVED FROM DIRECT FIELD OBSERVATIONS AND FOLLOW THE CURRENT NATIONAL MAP STANDARDS FOR VERTICAL ACCURACY.

THE BOUNDARY SHOWN HEREON IS PLOTTED FROM RECORD INFORMATION AND DOES NOT CONSTITUTE A BOUNDARY SURVEY OF THE PROPERTY.

#### ALL DISTANCES SHOWN HEREON ARE GRID DISTANCES.

SURVEYOR HAS NOT PERFORMED A SEARCH OF PUBLIC RECORDS TO DETERMINE ANY DEFECT IN TITLE ISSUED.

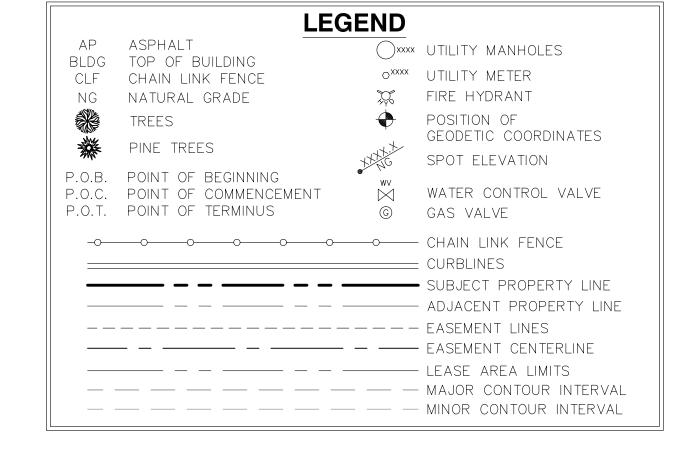

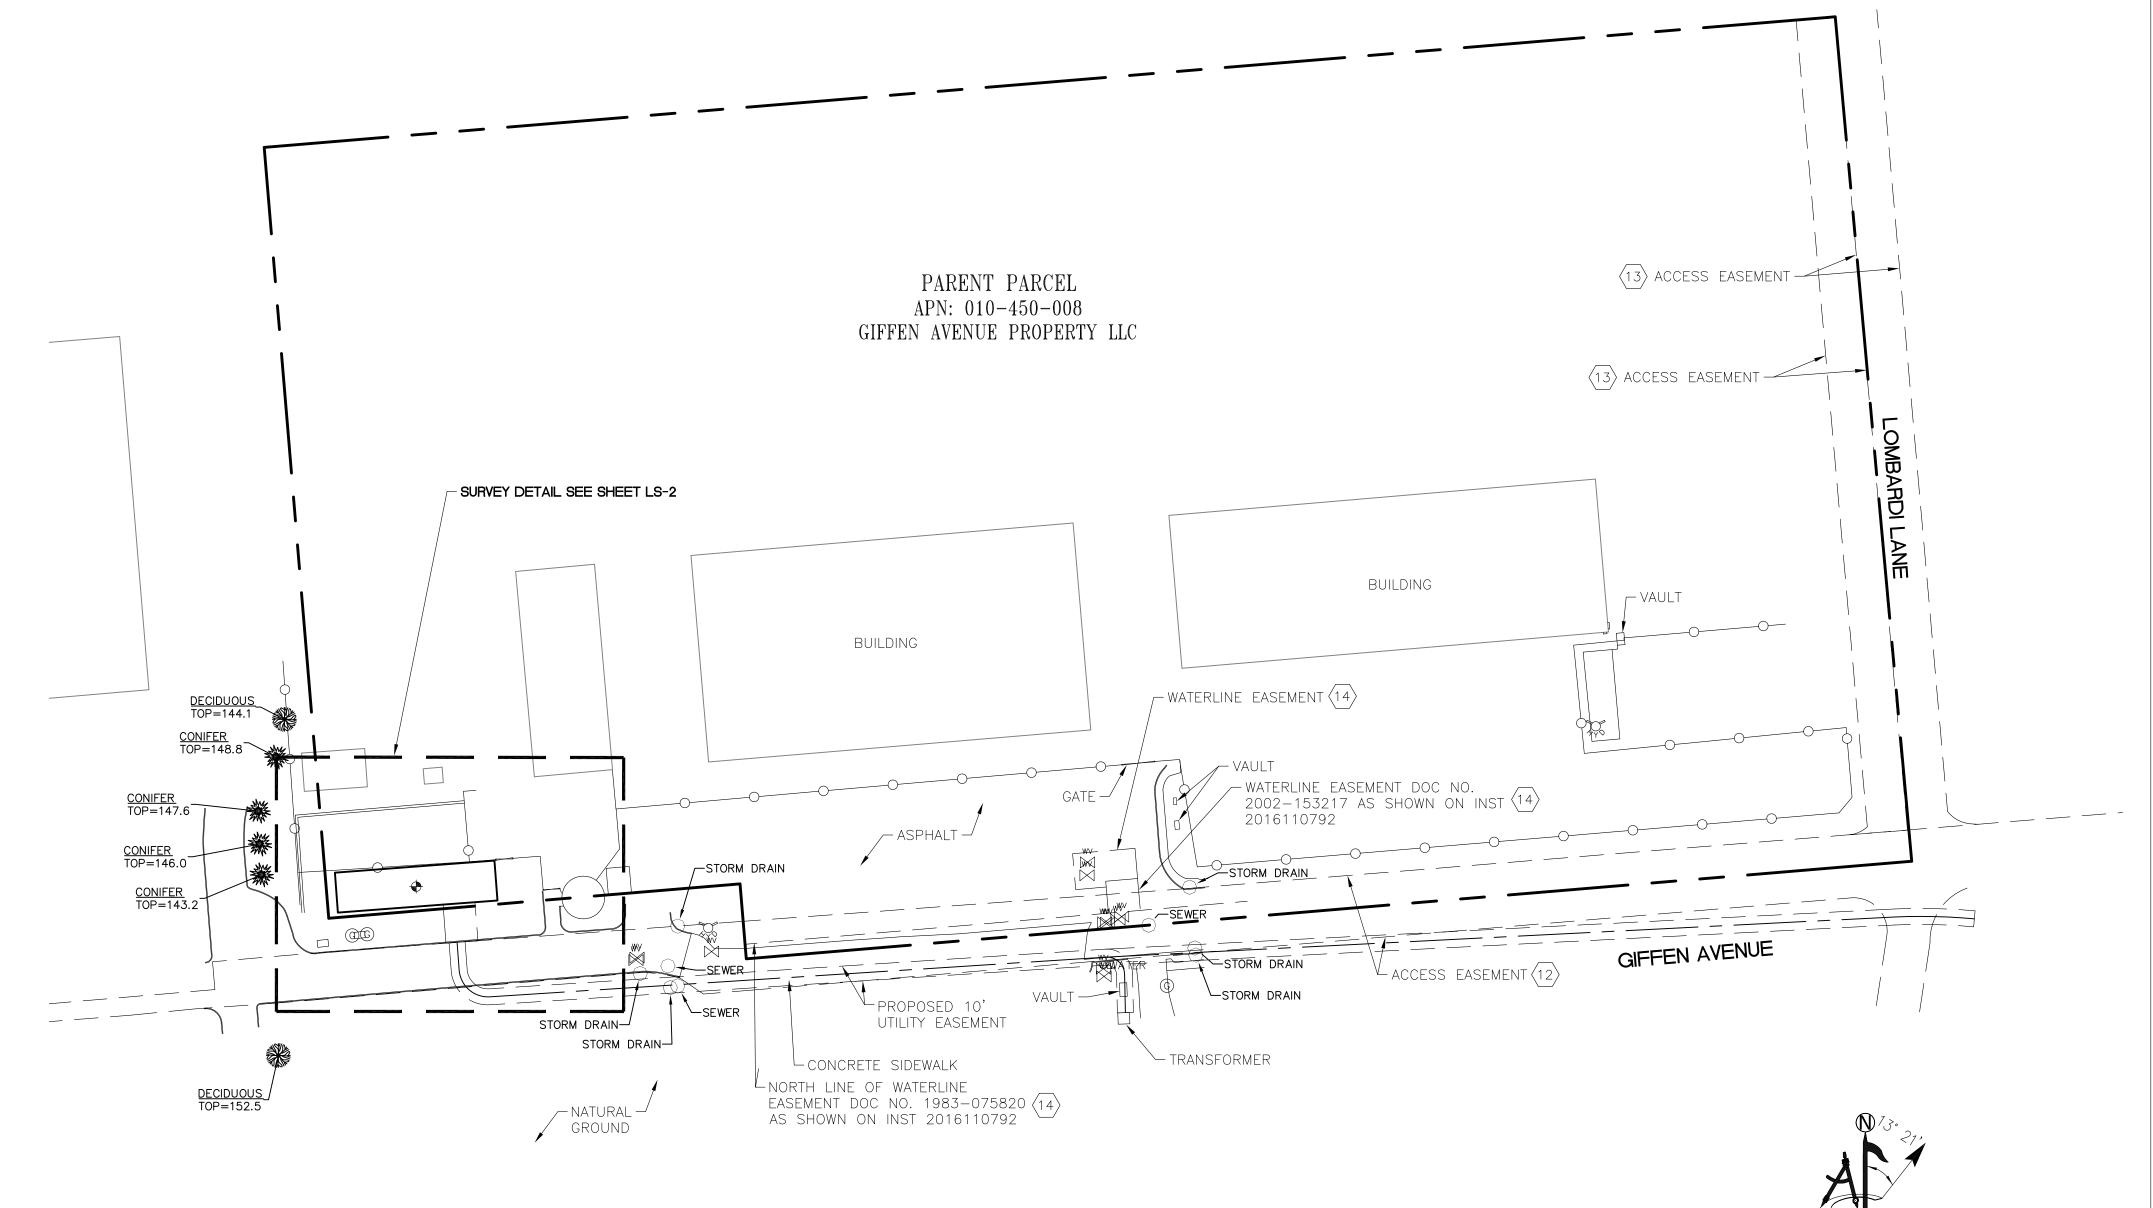



PROJECT INFORMATION:

# CCU02094 SW SANTA ROSA CORPORATE CENTER PKWY & ROSELAND 2715 GRIFFEN AVENUE

SANTA ROSA, CA 95404

SONOMA COUNTY

FORIGINAL ISSUE DATE:

10/07/2022

FREV.:	-DAIL:	DESCRIPTION:	BY:-
А	10/07/22	PRELIMINARY	СК
0	01/04/23	DESIGN(C)	SM

PLANS PREPARED BY:



**428 MAIN STREET** 

PH. (480) 659-4072

HUNTINGTON BEACH, CA 92648

www.ambitconsulting.us


SUITE 206

CONSULTANT:



DRAWN BY: CHK.: APV.: PD

LICENSER:

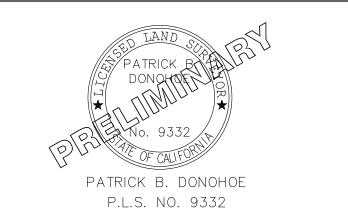

SHEET TITLE:

SITE SURVEY

LSHEET NUMBER:

GRAPHIC SCALE

( IN FEET ) 1 inch = 60 ft.

POSITION OF GEODETIC COORDINATES
LATITUDE 38° 25' 03.16" (38.417544') NORTH (NAD83)
LONGITUDE 122° 45' 01.67" (122.750464') WEST (NAD83)
GROUND ELEVATION @ 109.0' (NAVD88)

LEASE AREA LEGAL DESCRIPTION

A PORTION OF THE LAND OF OPTICAL COATING LABORATORY, INC., A CORPORATION, AS DESCRIBED AS PARCEL ONE IN THE DEED RECORDED JANUARY 11, 1973 IN BOOK 2727 OF OFFICIAL RECORDS AT PAGE 51 IN THE CITY OF SANTA ROSA, COUNTY OF SONOMA, STATE OF CALIFORNIA RECORDS, BEING MORE PARTICULARLY DESCRIBED AS FOLLOWS:

COMMENCING AT A IRON PIPE STAMPED RCE 31909 AT THE SOUTHWEST CORNER OF SAID PARCEL, FROM WHICH AN IRON PIPE STAMPED RCE 31909 BEARS THE FOLLOWING TWO COURSES:

THENCE NORTH 85°12'34" EAST, 257.92 FEET; THENCE SOUTH 04°47'26" EAST, 47.06 FEET AS SHOWN ON RECORD SURVEY RECORDED IN BOOK 814, PAGE 39, RECORDS OF SAID SONOMA COUNTY:

THENCE LEAVING SAID POINT OF COMMENCEMENT, NORTH 85°12'34" EAST, 71.87 FEET; THENCE NORTH 04°20'27" WEST, 2.56 FEET TO THE POINT OF BEGINNING.

THENCE SOUTH 85°40'47" WEST, 65.91 FEET; THENCE NORTH 04°19'13" WEST, 25.00 FEET; THENCE NORTH 85°40'47" EAST, 100.00 FEET; THENCE SOUTH 04°19'13" EAST, 25.00 FEET; THENCE SOUTH 85°40'47" WEST, 34.09 FEET TO THE POINT OF BEGINNING.

CONTAINING 2,500 SQUARE FEET (0.057 ACRES) OF LAND, MORE OR LESS.

#### ACCESS AND UTILITY

EASEMENT LEGAL DESCRIPTION

A PORTION OF THE LAND OF OPTICAL COATING LABORATORY, INC., A CORPORATION, AS DESCRIBED AS PARCEL ONE IN THE DEED RECORDED JANUARY 11, 1973 IN BOOK 2727 OF OFFICIAL RECORDS AT PAGE 51 AND A PORTION OF LOT 1 OF THE LANDS OF PATRIOT NORTHPOINT II REFI LLC AS SHOWN ON RECORD SURVEY RECORDED IN BOOK 814 PAGE 39, IN THE CITY OF SANTA ROSA, COUNTY OF SONOMA, STATE OF CALIFORNIA, BEING MORE PARTICULARLY DESCRIBED AS


COMMENCING AT A IRON PIPE STAMPED RCE 31909 AT THE SOUTHWEST CORNER OF SAID PARCEL, FROM WHICH AN IRON PIPE STAMPED RCE 31909 BEARS THE FOLLOWING TWO COURSES:

THENCE NORTH 85°12'34" EAST, 257.92 FEET; THENCE SOUTH 04°47'26" EAST, 47.06 FEET AS SHOWN ON SAID RECORD SURVEY RECORDED IN BOOK 814, PAGE 39, RECORDS OF SAID SONOMA COUNTY;

THENCE LEAVING SAID POINT OF COMMENCEMENT, NORTH 85°12'34" EAST, 71.87 FEET TO THE POINT OF BEGINNING.

THENCE NORTH 04°20'27" WEST, 2.56 FEET; THENCE NORTH 85°40'47" EAST, 20.00 FEET; THENCE SOUTH 04°20'27" EAST, 24.22 FEET; THENCE SOUTH 85°47'02" WEST, 20.00 FEET; THENCE NORTH 04°20'27" WEST, 21.63 FEET TO THE POINT OF BEGINNING.

CONTAINING 484 SQUARE FEET (0.011 ACRES) OF LAND, MORE OR LESS.

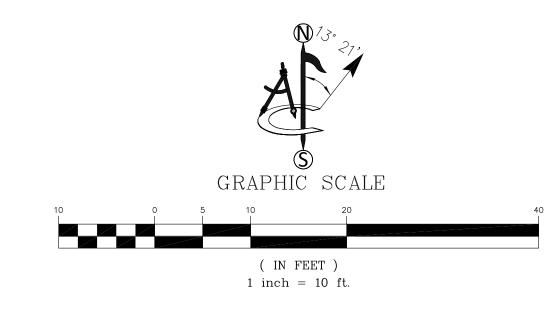





PROJECT INFORMATION:

**LEGEND** 

-O-O-O-O-O-CHAIN LINK FENCE

---- EASEMENT LINES

( )xxxx utility manholes

GEODETIC COORDINATES

SPOT ELEVATION

WATER CONTROL VALVE

o<sup>xxxx</sup> utility meter

FIRE HYDRANT

POSITION OF

© GAS VALVE

CURBLINES

- - SUBJECT PROPERTY LINE

— — — EASEMENT CENTERLINE

— — — ADJACENT PROPERTY LINE

AP ASPHALT

BLDG TOP OF BUILDING

NG NATURAL GRADE

TREES

PINE TREES

CLF CHAIN LINK FENCE

P.O.B. POINT OF BEGINNING

P.O.T. POINT OF TERMINUS

P.O.C. POINT OF COMMENCEMENT

# CCU02094 SW SANTA ROSA CORPORATE CENTER PKWY & ROSELAND 2715 GRIFFEN AVENUE

ORIGINAL ISSUE DATE:

10/07/2022

SANTA ROSA, CA 95404


SONOMA COUNTY

=REV.:=	DATE:	DESCRIPTION:	BY:
А	10/07/22	PRELIMINARY	CK
0	01/04/23	DESIGN(C)	SM

PLANS PREPARED BY:=



CONSULTANT:

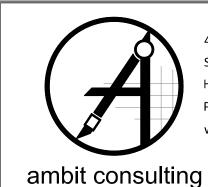

DRAWN BY: CHK.: APV.: PD

**428 MAIN STREET** 


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HUNTINGTON BEACH, CA 92648

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SUITE 206

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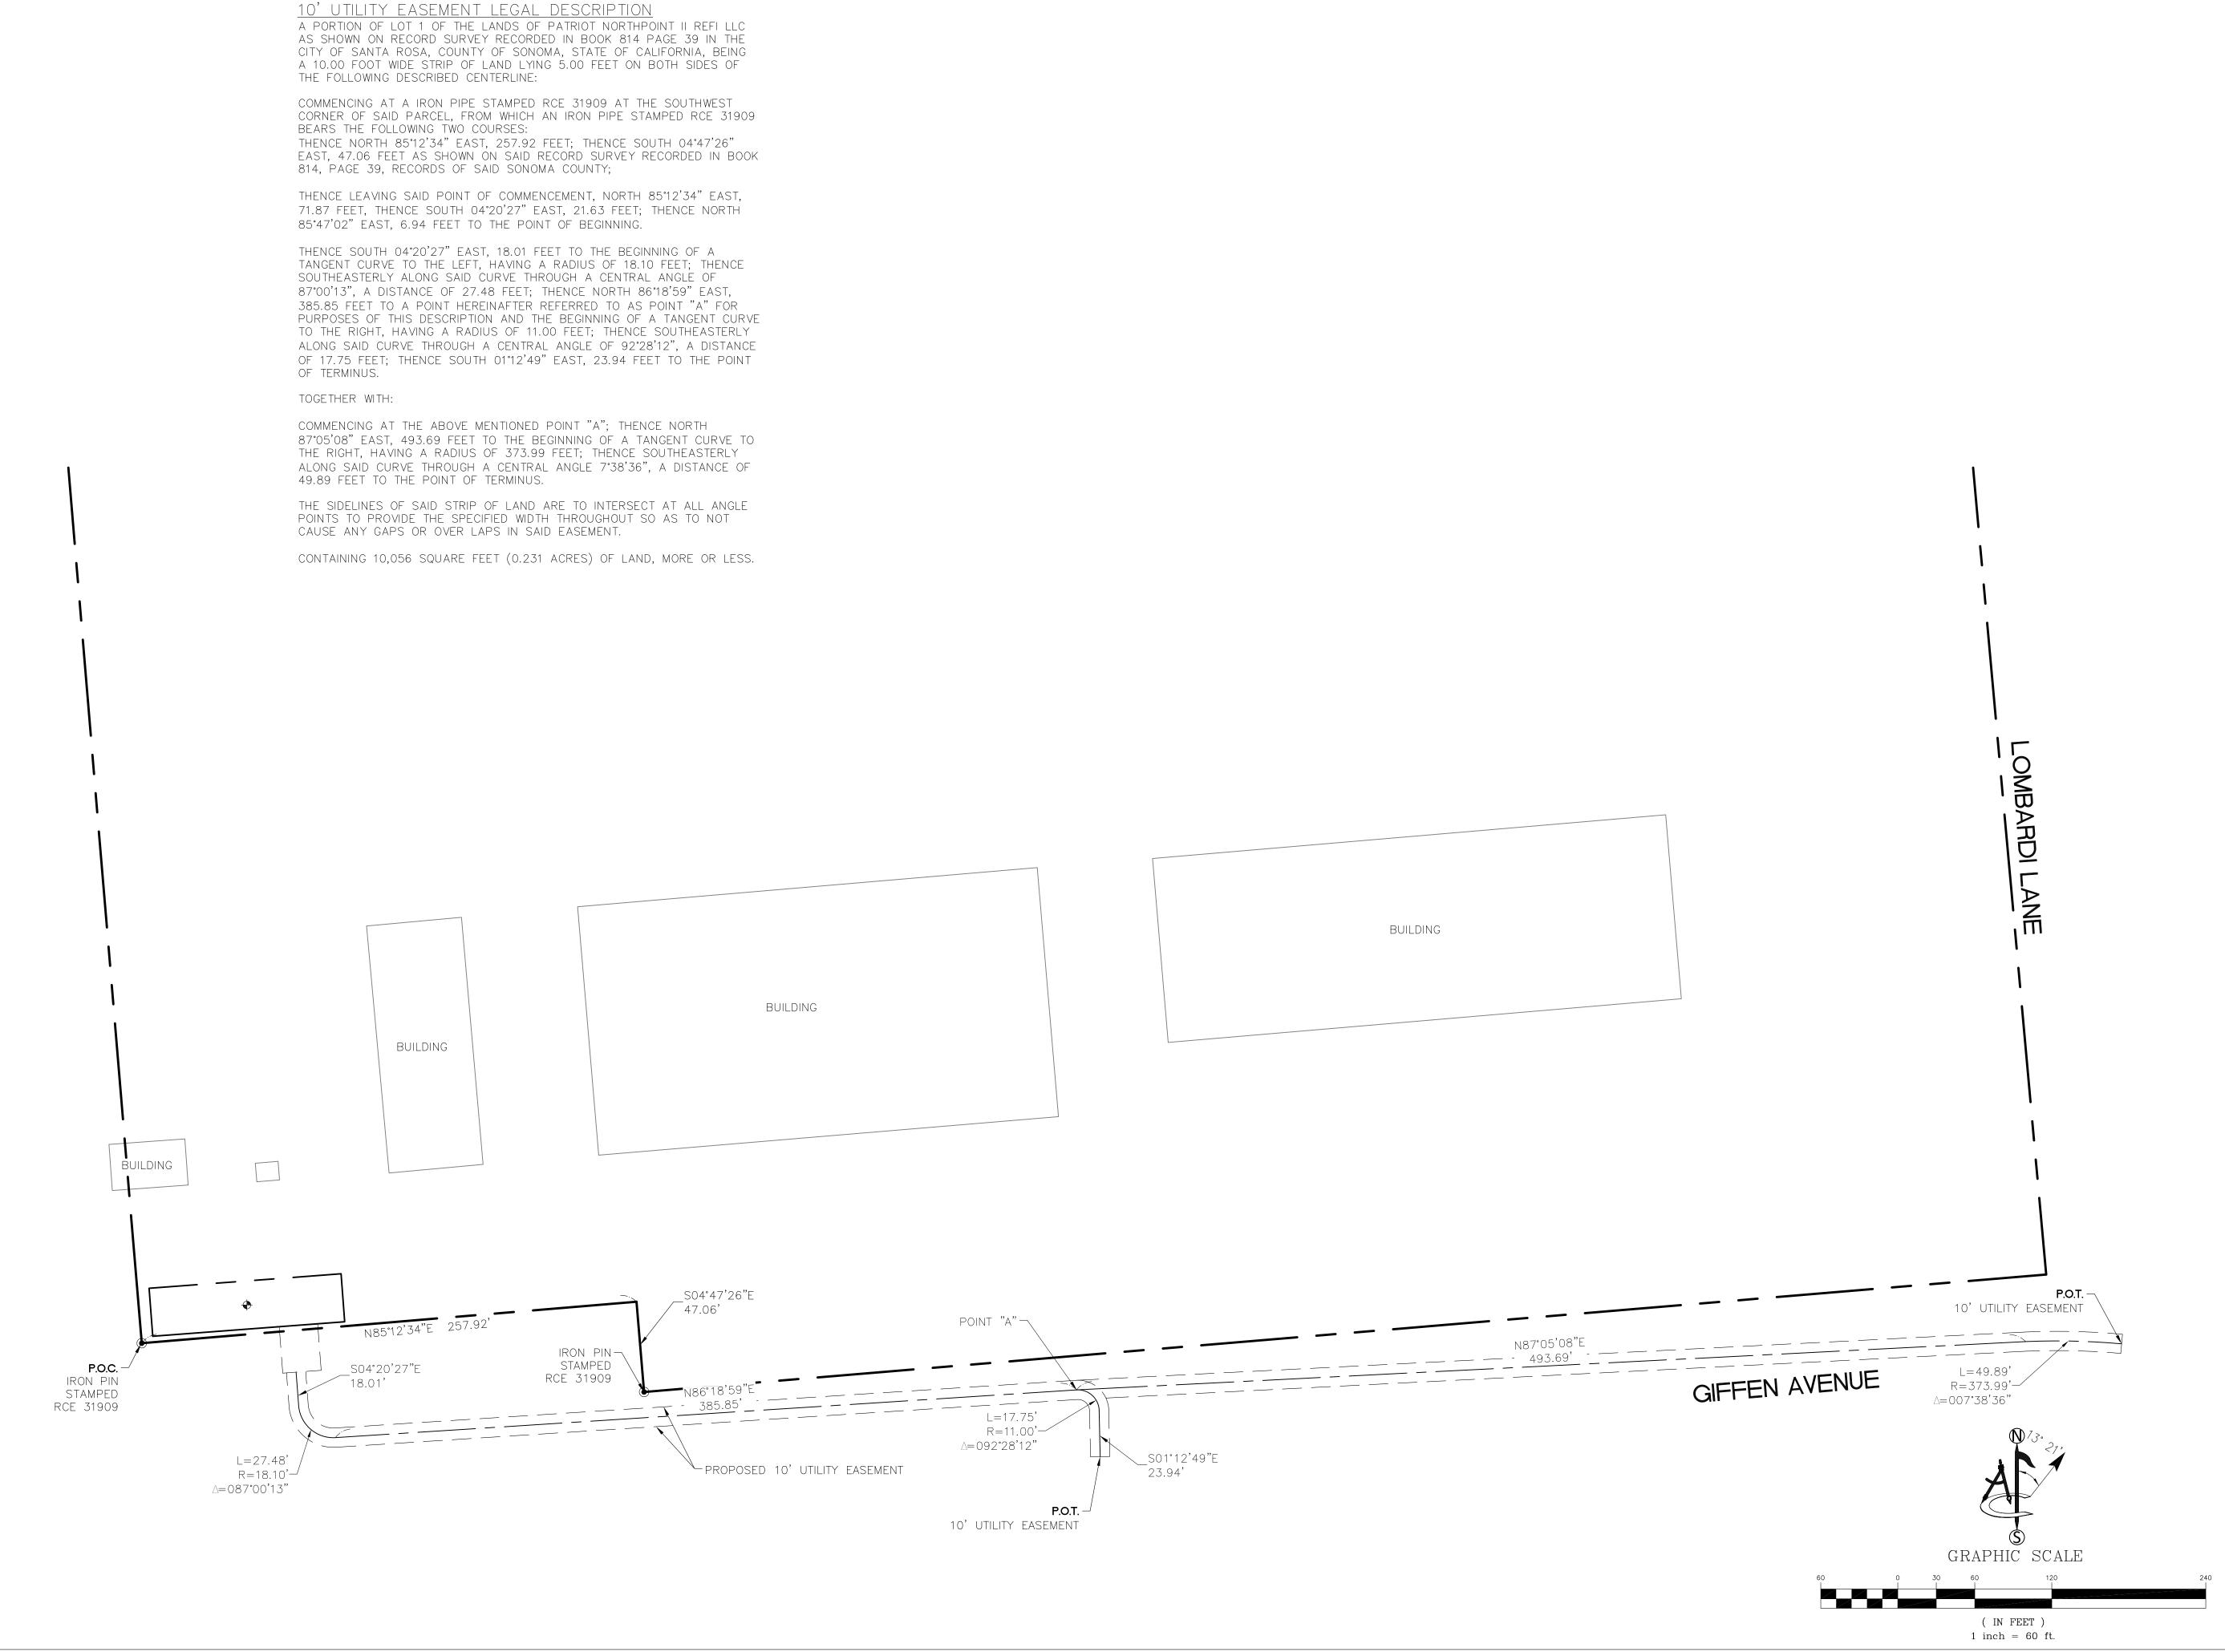


SHEET TITLE:

SITE SURVEY

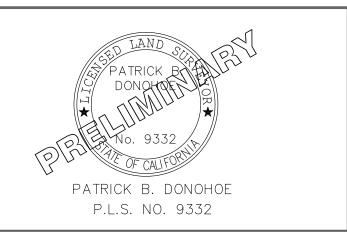SHEET NUMBER:=







-PROJECT INFORMATION:-

FORIGINAL ISSUE DATE:

#### CCU02094 SW SANTA ROSA CORPORATE CENTER PKWY & ROSELAND 2715 GRIFFEN AVENUE SANTA ROSA, CA 95404

SONOMA COUNTY


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PLANS PREPARED BY:




CONSULTANT:



**428 MAIN STREET** SUITE 206 HUNTINGTON BEACH, CA 92648 PH. (480) 659-4072 www.ambitconsulting.us

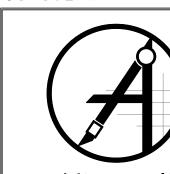ambit consulting

LORAWN BI:	UHK.:	APV.:
CK	MF	PD
LICENSER:		

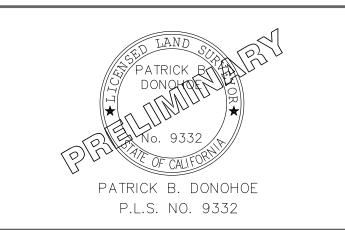

SHEET TITLE:

SITE SURVEY

SHEET NUMBER:



SCHEDULE "B" NOTE

REFERENCE IS MADE TO THE TITLE REPORT ORDER #TEP-138421-I, ISSUED BY TOWER TITLE AND CLOSING, DATED AUGUST 22, 2022. ALL EASEMENTS CONTAINED WITHIN SAID TITLE REPORT AFFECTING THE IMMEDIATE AREA SURROUNDING THE LEASE HAVE BEEN PLOTTED.

ITEMIZED NOTES:

1. DEFECTS, LIENS, ENCUMBRANCES, ADVERSE CLAIMS OR OTHER MATTERS, IF ANY, CREATED, FIRST APPEARING IN THE PUBLIC RECORDS OR ATTACHING SUBSEQUENT TO THE EFFECTIVE DATE BUT PRIOR TO THE DATE THE PROPOSED INSURED ACQUIRES FOR VALUE OF RECORD THE ESTATE OR INTEREST OR MORTGAGE THEREON COVERED BY THIS REPORT, INCLUDING:

A. TAXES OR ASSESSMENTS THAT ARE NOT SHOWN AS EXISTING LIENS BY THE RECORDS OF ANY TAXING AUTHORITY THAT LEVIES TAXES OR ASSESSMENTS ON REAL PROPERTY OR BY THE PUBLIC RECORDS;

B. PROCEEDINGS BY A PUBLIC AGENCY THAT MAY RESULT IN TAXES OR ASSESSMENTS, OR NOTICES OF SUCH PROCEEDINGS, WHETHER OR NOT SHOWN BY THE RECORDS OF SUCH AGENCY OR BY THE PUBLIC RECORDS. (EXCEPTION IS A STANDARD EXCEPTION AND NOT THE TYPE TO BE SHOWN HEREON)

2. THE LIEN OF SUPPLEMENTAL OR ESCAPED ASSESSMENTS OF PROPERTY TAXES, IF ANY. (EXCEPTION IS A STANDARD EXCEPTION AND NOT THE TYPE TO BE SHOWN HEREON)

3. ANY FACTS, RIGHTS, INTERESTS, OR CLAIMS THAT ARE NOT SHOWN BY THE PUBLIC RECORDS BUT THAT COULD BE ASCERTAINED BY AN INSPECTION OF THE LAND OR THAT MAY BE ASSERTED BY PERSONS IN POSSESSION OF THE LAND. (EXCEPTION IS A STANDARD EXCEPTION AND NOT THE TYPE TO BE SHOWN HEREON)

4. EASEMENTS, LIENS OR ENCUMBRANCES, OR CLAIMS THEREOF, NOT SHOWN BY THE PUBLIC RECORDS. (EXCEPTION IS A STANDARD EXCEPTION AND NOT THE TYPE TO BE SHOWN HEREON)

5. ANY ENCROACHMENT, ENCUMBRANCE, VIOLATION, VARIATION, OR ADVERSE CIRCUMSTANCE AFFECTING THE TITLE THAT WOULD BE DISCLOSED BY AN ACCURATE AND COMPLETE LAND SURVEY OF THE LAND AND NOT SHOWN BY THE PUBLIC RECORDS, INCLUDING:

A. UNPATENTED MINING CLAIMS;
B. RESERVATIONS OR EXCEPTIONS IN PATENTS OR IN ACTS
AUTHORIZING THE ISSUANCE THEREOF;
C. WATER RIGHT, CLAIMS OR TITLE TO WATER,
WHETHER OR NOT THE MATTERS EXCEPTED UNDER (A), (B) OR
(C) ARE SHOWN BY THE PUBLIC
RECORDS. (EXCEPTION IS A STANDARD EXCEPTION AND NOT

THE TYPE TO BE SHOWN HEREON)

6. ANY LIEN OR RIGHT TO LIEN FOR SERVICES, LABOR OR MATERIAL NOT SHOWN BY THE PUBLIC RECORDS. (EXCEPTION IS A STANDARD EXCEPTION AND NOT THE TYPE TO BE SHOWN HEREON)

7. TAXES FOR THE CURRENT FISCAL YEAR AND SUBSEQUENT YEARS, A LIEN NOT YET DUE AND PAYABLE. (EXCEPTION IS A STANDARD EXCEPTION AND NOT THE TYPE TO BE SHOWN HEREON)

8. RIGHTS OF FEE SIMPLE OWNERS IN AND TO THE SUBJECT PROPERTY. (EXCEPTION IS A STANDARD EXCEPTION AND NOT THE TYPE TO BE SHOWN HEREON)

9. EASEMENT AGREEMENT BETWEEN JDS UNIPHASE CORPORATION, A DELAWARE CORPORATION (JDSU), PATRIOT NORTHPOINT I, LLC, A DELAWARE LIMITED LIABILITY COMPANY; AND PATRIOT NORTHPOINT II, LLC, A DELAWARE LIMITED LIABILITY COMPANY, DATED AUGUST 21, 2007 AND RECORDED AUGUST 27, 2007 IN (INSTRUMENT) 2007094870, IN SONOMA COUNTY, CALIFORNIA. (BLANKET IN NATURE)

10. TERMS AND CONDITIONS OF AN UNRECORDED LEASE, AS EVIDENCED BY A(N) MEMORANDUM OF LEASE BETWEEN PATRIOT NORTHPOINT I, LLC, A DELAWARE LIMITED LIABILITY COMPANY AND JDS UNIPHASE CORPORATION, A DELAWARE CORPORATION, DATED AUGUST 21, 2007 AND RECORDED SEPTEMBER 6, 2007 IN (INSTRUMENT) 2007098104, IN SONOMA COUNTY, CALIFORNIA. (BLANKET IN NATURE)

11. TERMS AND CONDITIONS OF AN UNRECORDED LEASE, AS EVIDENCED BY A(N) MEMORANDUM OF LEASE BETWEEN PATRIOT NORTHPOINT I, LLC, A DELAWARE LIMITED LIABILITY COMPANY AND JDS UNIPHASE CORPORATION, A DELAWARE CORPORATION, DATED AUGUST 21, 2007 AND RECORDED SEPTEMBER 6, 2007 IN (INSTRUMENT) 2007098105, IN SONOMA COUNTY, CALIFORNIA. (BLANKET IN NATURE)

(12) RECIPROCAL ACCESS AND UTILITY EASEMENT AGREEMENT BÉTWEEN PATRIOT NORTHPOINT I, LLC, A DELAWARE LIMITED LIABILITY COMPANY; AND PATRIOT NORTHPOINT II, LLC, A DELAWARE LIMITED LIABILITY COMPANY, DATED JANUARY 6, 2012 AND RECORDED JANUARY 11, 2012 IN (INSTRUMENT) 2012002560, IN SONOMA COUNTY, CALIFORNIA. AFFECTED BY A(N) AGREEMENT REGARDING RECIPROCAL ACCESS AND UTILITY EASEMENT AGREEMENT BETWEEN PATRIOT NORTHPOINT II. LLC, A DELAWARE LIMITED LIABILITY COMPANY. PATRIOT NORTHPOINT II REFI, LLC, A DELAWARE LIMITED LIABILITY COMPANY, PATRIOT NORTHPOINT | REFI. LLC. A DELAWARE LIMITED LIABILITY COMPANY: AND GIFFEN AVENUE INVESTMENTS, LLC, A CALIFORNIA LIMITED LIABILITY COMPANY, DATED FEBRUARY 3, 2017 AND RECORDED JULY 13, 2017 IN (INSTRUMENT) 2017054238, IN SONOMA COUNTY, CALIFORNIA. (AS SHOWN ON SURVEY)

SCHEDULE "B" NOTE

(3) RECIPROCAL ACCESS AND UTILITY EASEMENT AGREEMENT BETWEEN PATRIOT NORTHPOINT I, LLC, A DELAWARE LIMITED LIABILITY COMPANY; AND PATRIOT NORTHPOINT I REFI, LLC, A DELAWARE LIMITED LIABILITY COMPANY, DATED OCTOBER 24, 2013 AND RECORDED OCTOBER 30, 2013 IN (INSTRUMENT) 2013105800, IN SONOMA COUNTY, CALIFORNIA.

AFFECTED BY A(N) FIRST AMENDMENT TO RECIPROCAL ACCESS AND UTILITY EASEMENT AGREEMENT BETWEEN PATRIOT NORTHPOINT I, LLC, A DELAWARE LIMITED LIABILITY COMPANY; AND PATRIOT NORTHPOINT I REFI, LLC, A DELAWARE LIMITED LIABILITY COMPANY, DATED FEBRUARY 17, 2015 AND RECORDED MARCH 24, 2015 IN (INSTRUMENT) 2015024085, IN SONOMA COUNTY, CALIFORNIA. (AS SHOWN ON SURVEY)

(14) EASEMENT DEED BETWEEN GIFFEN AVENUE PROPERTY, LLC; AND THE CITY OF SANTA ROSA, A MUNICIPAL CORPORATION, DATED NOVEMBER 18, 2016 AND RECORDED NOVEMBER 30, 2016 IN (INSTRUMENT) 2016110792, IN SONOMA COUNTY, CALIFORNIA. (AS SHOWN ON SURVEY)

15. TERMS AND CONDITIONS OF AN UNRECORDED LEASE, AS EVIDENCED BY A(N) MEMORANDUM OF AGREEMENT BETWEEN PATRIOT NORTHPOINT I, LLC, A DELAWARE LIMITED LIABILITY COMPANY AND GIFFEN AVENUE INVESTMENTS, LLC, A CALIFORNIA LIMITED LIABILITY COMPANY, DATED MAY 4, 2016 AND RECORDED MAY 6, 2016 IN (INSTRUMENT) 2016039589, IN SONOMA COUNTY, CALIFORNIA. (BLANKET IN NATURE)

LESSOR'S LEGAL DESCRIPTION

PARCEL ONE:
BEING A PORTION OF THE LAND OF OPTICAL COATING
LABORATORY, INC., A CORPORATION, AS DESCRIBED AS PARCEL
ONE IN THE DEED RECORDED JANUARY 11, 1973 IN BOOK 2727
OF OFFICIAL RECORDS AT PAGE 51 SONOMA COUNTY RECORDS,
DESCRIBED AS FOLLOWS:

BEGINNING AT A POINT ON THE NORTHERN LINE OF SAID PARCEL OF LAND AS DESCRIBED AS PARCEL ONE IN THE DEED TO OPTICAL COATING LABORATORY DISTANT ALONG SAID LINE NORTH 85° 15' 01" EAST 588.69 FEET FROM THE NORTHWESTERN CORNER OF SAID PARCEL; THENCE ALONG THE NORTHERN LINE OF SAID PARCEL OF LAND NORTH 85° 15' 01" EAST 980.29 FEET; THENCE LEAVING SAID LINE SOUTH 05° 42' 31" EAST 529.97 FEET; THENCE SOUTH 85° 12' 45" WEST 730.89 FEET; THENCE NORTH 04° 47' 15" WEST 47.06 FEET; THENCE SOUTH 85° 12' 45" WEST 257.92 FEET; THENCE NORTH 04° 47' 15" WEST 483.49 FEET TO THE POINT OF BEGINNING.

PARCEL TWO: COMMENCING AT THE NORTHWEST CORNER OR PARCEL FOUR AS DESCRIBED IN DOCUMENT NO. 2001-079911; THENCE ALONG THE NORTH LINE OF SAID PARCEL NORTH 85° 15' 01" EAST (DEED= 84° 25' EAST) 543.69 FEET TO THE NORTHEAST CORNER OF THE PARCEL OF LAND DESCRIBED IN DOCUMENT 2001-079913, SONOMA COUNTY RECORDS; THENCE CONTINUING ALONG SAID NORTH LINE NORTH 85° 15' 01" EAST 980.29 FEET TO THE NORTHEAST CORNER OF THE PARCEL OF THE LAND DESCRIBED IN DOCUMENT NO. 2001-079914, SONOMA COUNTY RECORDS, THE TRUE POINT OF BEGINNING OF THE PARCEL HEREIN DESCRIBED; THENCE LEAVING SAID NORTH LINE AND ALONG THE EASTERLY LINE OF THE PARCEL DESCRIBED IN DOCUMENT NO. 2001-079914 SOUTH 05° 42' 31" EAST 529.97 FEET TO THE SOUTHEAST CORNER THEREOF, ALSO BEING THE SOUTHWEST CORNER OF PARCEL ONE AS DESCRIBED IN DOCUMENT NO. 2012-084686. SONOMA COUNTY RECORDS; THENCE LEAVING SAID EASTERLY LINE AND ALONG THE WESTERLY LINE OF SAID PARCEL ONE (2012-084686) NORTH 05° 10' 21" WEST (DEED=05° 56' WEST) 529.91 FEET TO THE NORTHWEST CORNER OF THE SAID PARCEL ONE; THENCE LEAVING SAID WESTERLY LINE AND ALONG THE NORTH LINE OF PARCEL FOUR (2001-079911) SOUTH 85° 15' 01" EAST 4.96 FEET MORE OR LESS TO THE POINT OF BEGINNING. TOGETHER WITH ALL THAT PORTION LYING WEST AND EXCEPTING ALL THAT PORTION LYING EAST OF THE FOLLOWING DESCRIBED BOUNDARY LINE:

BEGINNING AT A 2" BRASS DISK, STAMPED CITY OF SANTA ROSA WITH PUNCH IN A STANDARD MONUMENT WELL AT THE INTERSECTION OF GIFFEN AVENUE AND LOMBARDI LANE (LOMBARDI COURT) AS SHOWN ON THAT CERTAIN MAP ENTITLED DUTTON MANOR WEST NO. 3 FILED IN BOOK 403 OF MAPS PAGES 38-41, SONOMA COUNTY RECORDS FROM WHICH A 2" BRASS DISK, STAMPED RCE 25133 CITY OF SANTA ROSA WITH PUNCH IN A STANDARD MONUMENT WELL AT THE INTERSECTION OF BUSS DRIVE AND GIFFEN AVENUE AS SHOWN ON SAID MAP BEARS NORTH 84° 27' 46" EAST 624.49 FEET (624.43 FEET MAP); THENCE NORTH 05° 56' 29" WEST 20.00 FEET TO THE NORTH LINE OF GIFFEN AVENUE; THENCE CONTINUING NORTH 05° 56' 29" WEST 503.40 FEET TO A SET 1/2" IRON PIPE TAGGED RCE 31909; THENCE CONTINUING NORTH 05° 56' 29" WEST 8.00 FEET MORE OR LESS TO THE NORTH LINE OF SAID PATRIOT NORTHPOINT REFI LLC AND GIFFEN AVENUE PROPERTY LLC LANDS. BASIS OF BEARINGS: NORTH 84° 27' 46" EAST 624.49 FEET (624.43 FEET MAP) BETWEEN 2" BRASS DISKS, STAMPED CITY OF SANTA ROSA WITH PUNCH IN A STANDARD MONUMENT WELL AT THE INTERSECTION OF GIFFEN AVENUE/LOMBARDI LANE AND AT THE INTERSECTION OF GIFFEN AVENUE/BUSS DRIVE AS SHOWN ON THAT CERTAIN MAP ENTITLED DUTTON MANOR WEST NO. 3 FILED IN BOOK 403 OF MAPS PAGES 38-41, SONOMA COUNTY RECORDS.

PARCEL THREE:
AN EASEMENT FOR INGRESS AND EGRESS ALSO INCLUDING PUBLIC AND PRIVATE UTILITIES, AS RESERVED IN THAT CERTAIN GRANT DEED EXECUTED BY OPTICAL COATING LABORATORY, INC., A DELAWARE CORPORATION, RECORDED NOVEMBER 4, 2005, AS INSTRUMENT 2005—165516, SONOMA COUNTY RECORDS.

ARCEL FOU

PARCEL FOUR:
EASEMENTS FOR THE PURPOSES AS SET FORTH IN THAT CERTAIN
"EASEMENT AGREEMENT", EXECUTED BY PATRIOT NORTHPOINT I,
LLC, A DELAWARE LIMITED LIABILITY COMPANY, ET AL, RECORDED
AUGUST 27, 2007 AS INSTRUMENT 2007—094870, SONOMA
COUNTY RECORDS.

PARCEL FIVE:

EASEMENT FOR THE PURPOSE AS SET FORTH IN THAT CERTAIN RECIPROCAL ACCESS AND UTILITY EASEMENT AGREEMENT EXECUTED BY PATRIOT NORTHPOINT I, LLC, A DELAWARE LIMITED LIABILITY COMPANY; AND PATRIOT NORTHPOINT II, LLC, A DELAWARE LIMITED LIABILITY COMPANY, DATED JANUARY 6, 2012 AND RECORDED JANUARY 11, 2012 IN(INSTRUMENT) 2012002560, IN SONOMA COUNTY, CALIFORNIA.

PARCEL SIX:

EASEMENT FOR THE PURPOSE AS SET FORTH IN THAT CERTAIN RECIPROCAL ACCESS AND UTILITY EASEMENT AGREEMENT EXECUTED BY PATRIOT NORTHPOINT I, LLC, A DELAWARE LIMITED LIABILITY COMPANY; AND PATRIOT NORTHPOINT I REFI, LLC, A DELAWARE LIMITED LIABILITY COMPANY, DATED OCTOBER 24, 2013 AND RECORDED OCTOBER 30, 2013 IN (INSTRUMENT) 2013105800, IN SONOMA COUNTY, CALIFORNIA AFFECTED BY A(N) FIRST AMENDMENT TO RECIPROCAL ACCESS AND UTILITY EASEMENT AGREEMENT BETWEEN PATRIOT NORTHPOINT I, LLC, A DELAWARE LIMITED LIABILITY COMPANY; AND PATRIOT NORTHPOINT I REFI, LLC, A DELAWARE LIMITED LIABILITY COMPANY, DATED FEBRUARY 17, 2015, AND RECORDED MARCH 24, 2015 IN (INSTRUMENT) 2015024085, IN SONOMA COUNTY, CALIFORNIA.

PARCEL ID: 010-450-008

THIS BEING THE SAME PROPERTY CONVEYED TO GIFFEN AVENUE PROPERTY, LLC, A CALIFORNIA LIMITED LIABILITY COMPANY, IN A DEED FROM GIFFEN AVENUE INVESTMENTS, LLC, A CALIFORNIA LIMITED LIABILITY COMPANY DATED 5/4/2016 AND RECORDED 5/6/2016 AS INSTRUMENT NO. 2016039590.



PROJECT INFORMATION:

# CCU02094 SW SANTA ROSA CORPORATE CENTER PKWY & ROSELAND 2715 GRIFFEN AVENUE

SANTA ROSA, CA 95404

SONOMA COUNTY

ORIGINAL ISSUE DATE:

10/07/2022

10/0//2022

- \L\	DATE.	DESCRIPTION:	<u> — Б Г</u>
А	10/07/22	PRELIMINARY	СК
0	01/04/23	DESIGN(C)	SM

PLANS PREPARED BY:



CONSULTANT:=




428 MAIN STREET
SUITE 206
HUNTINGTON BEACH, CA 92648
PH. (480) 659-4072
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ambit consulting

	)RAWN	BY:	CHK.:===	APV.:
		CK	MF	PD

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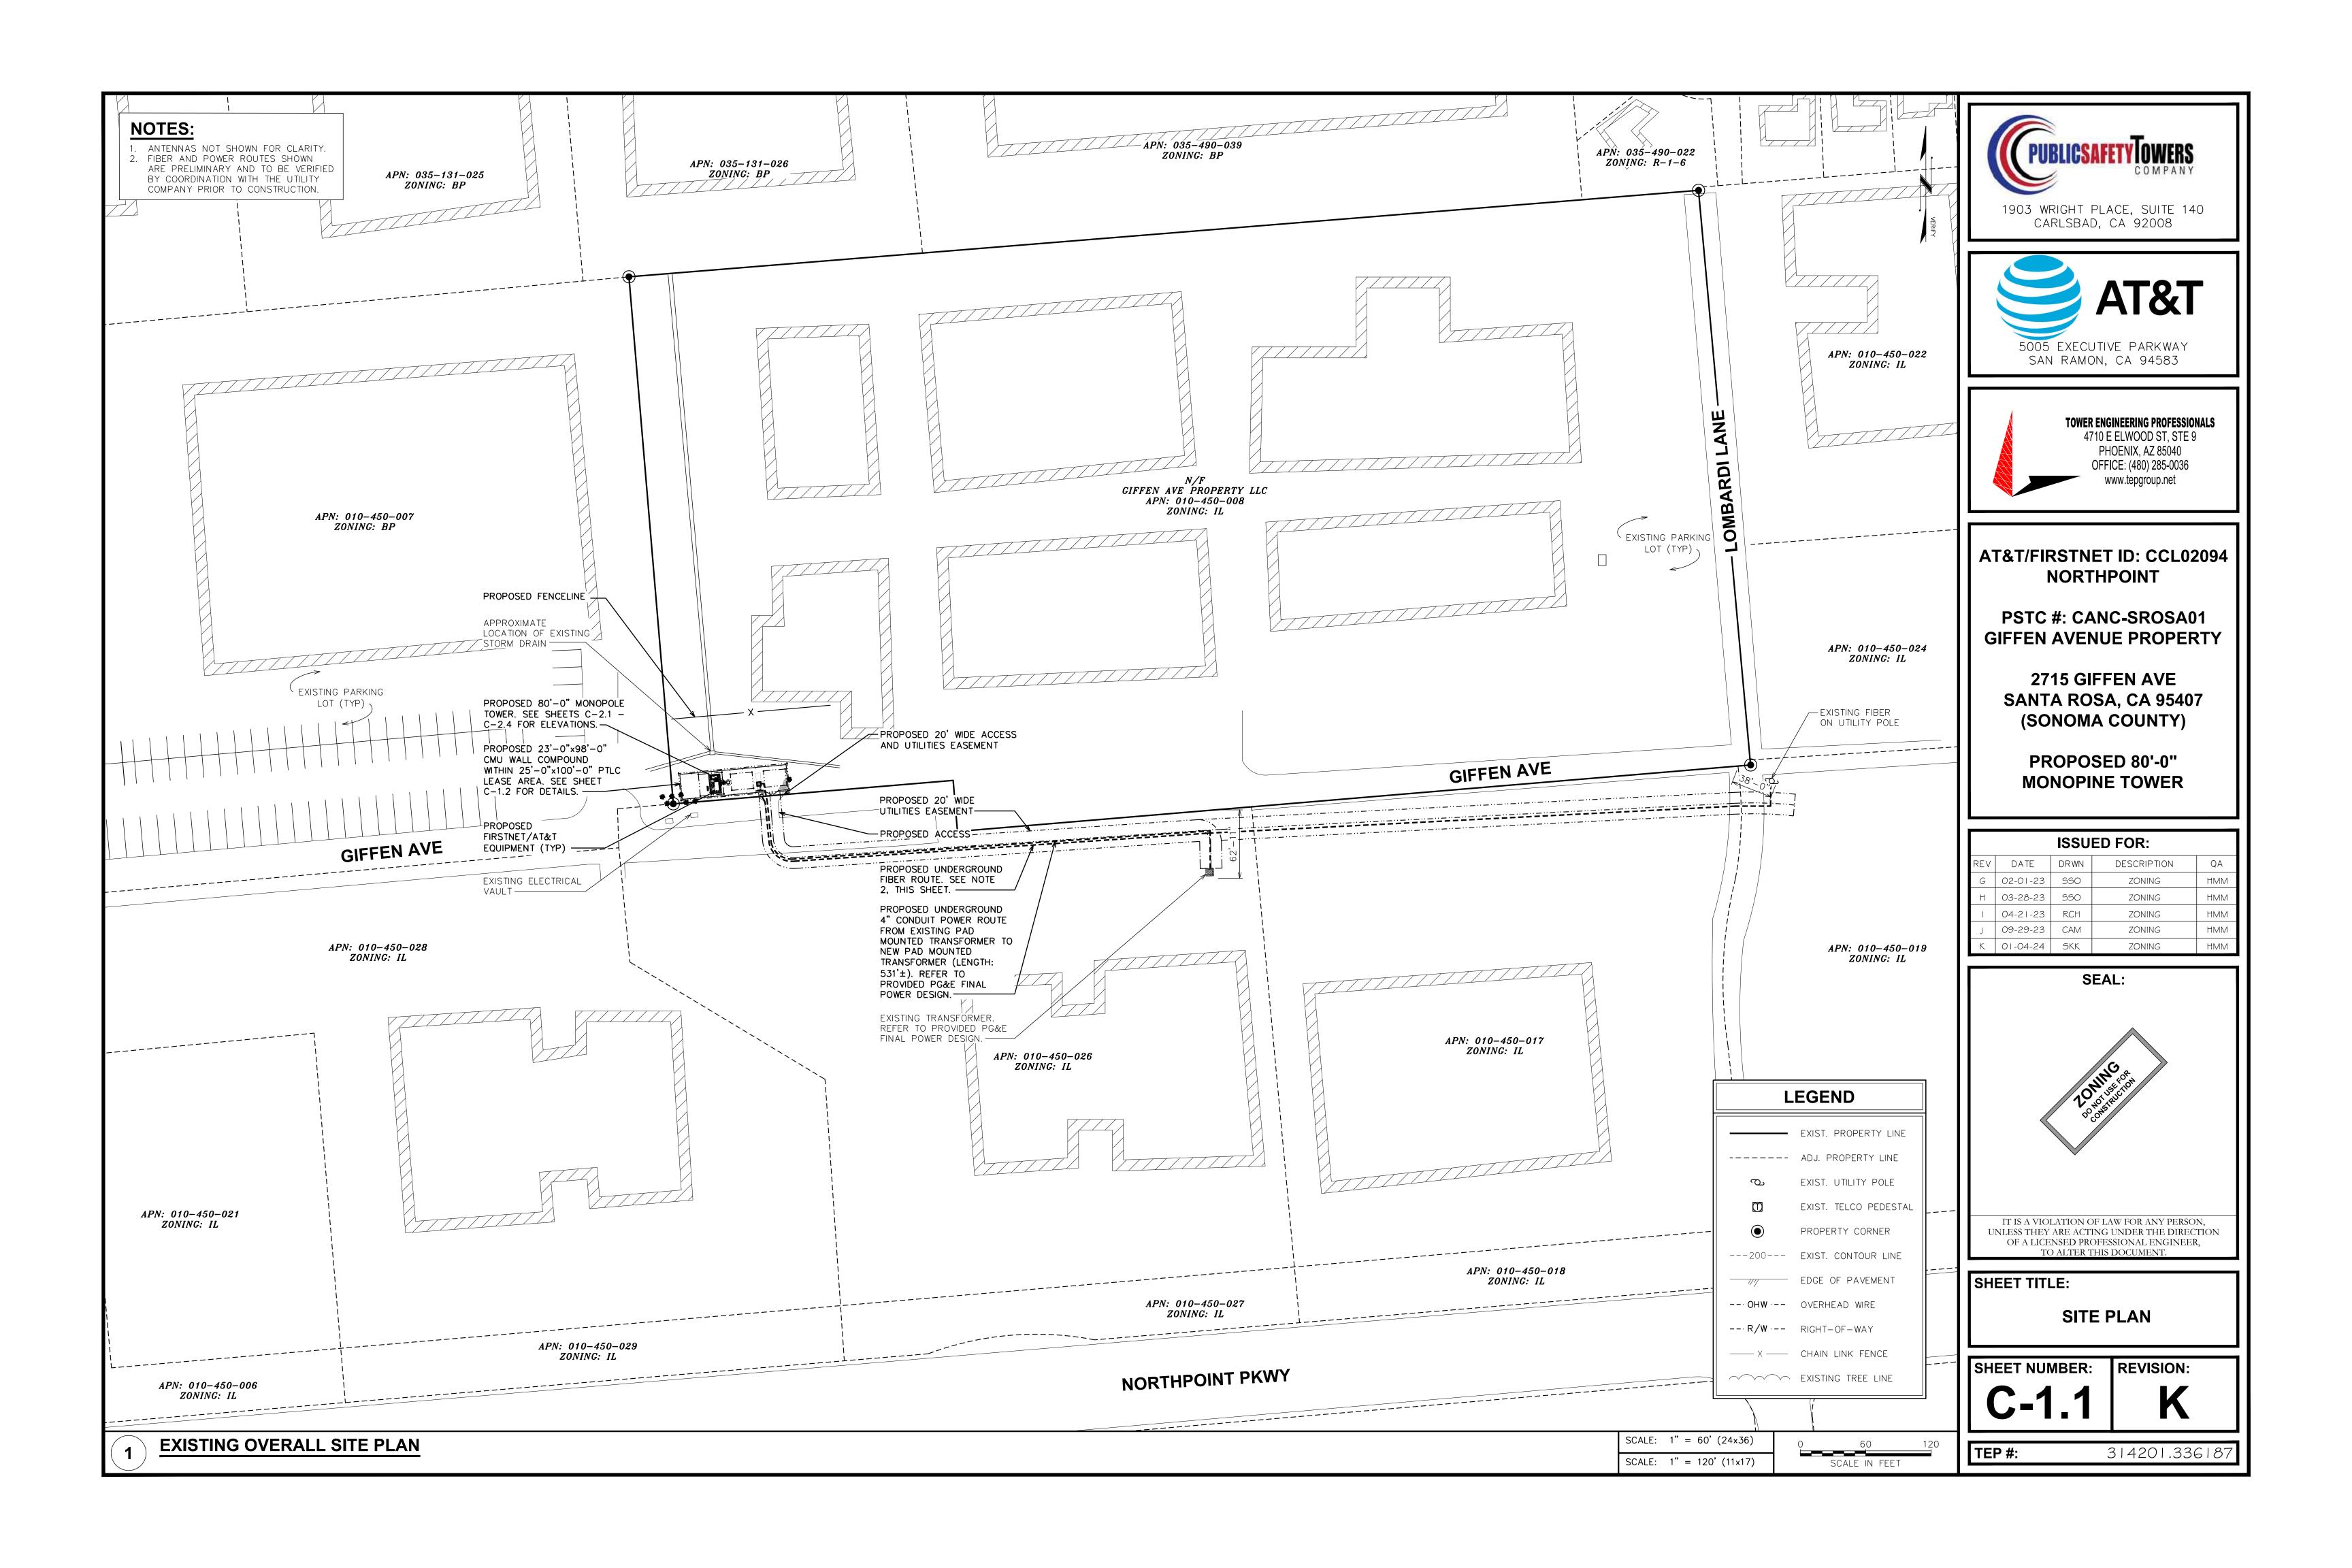



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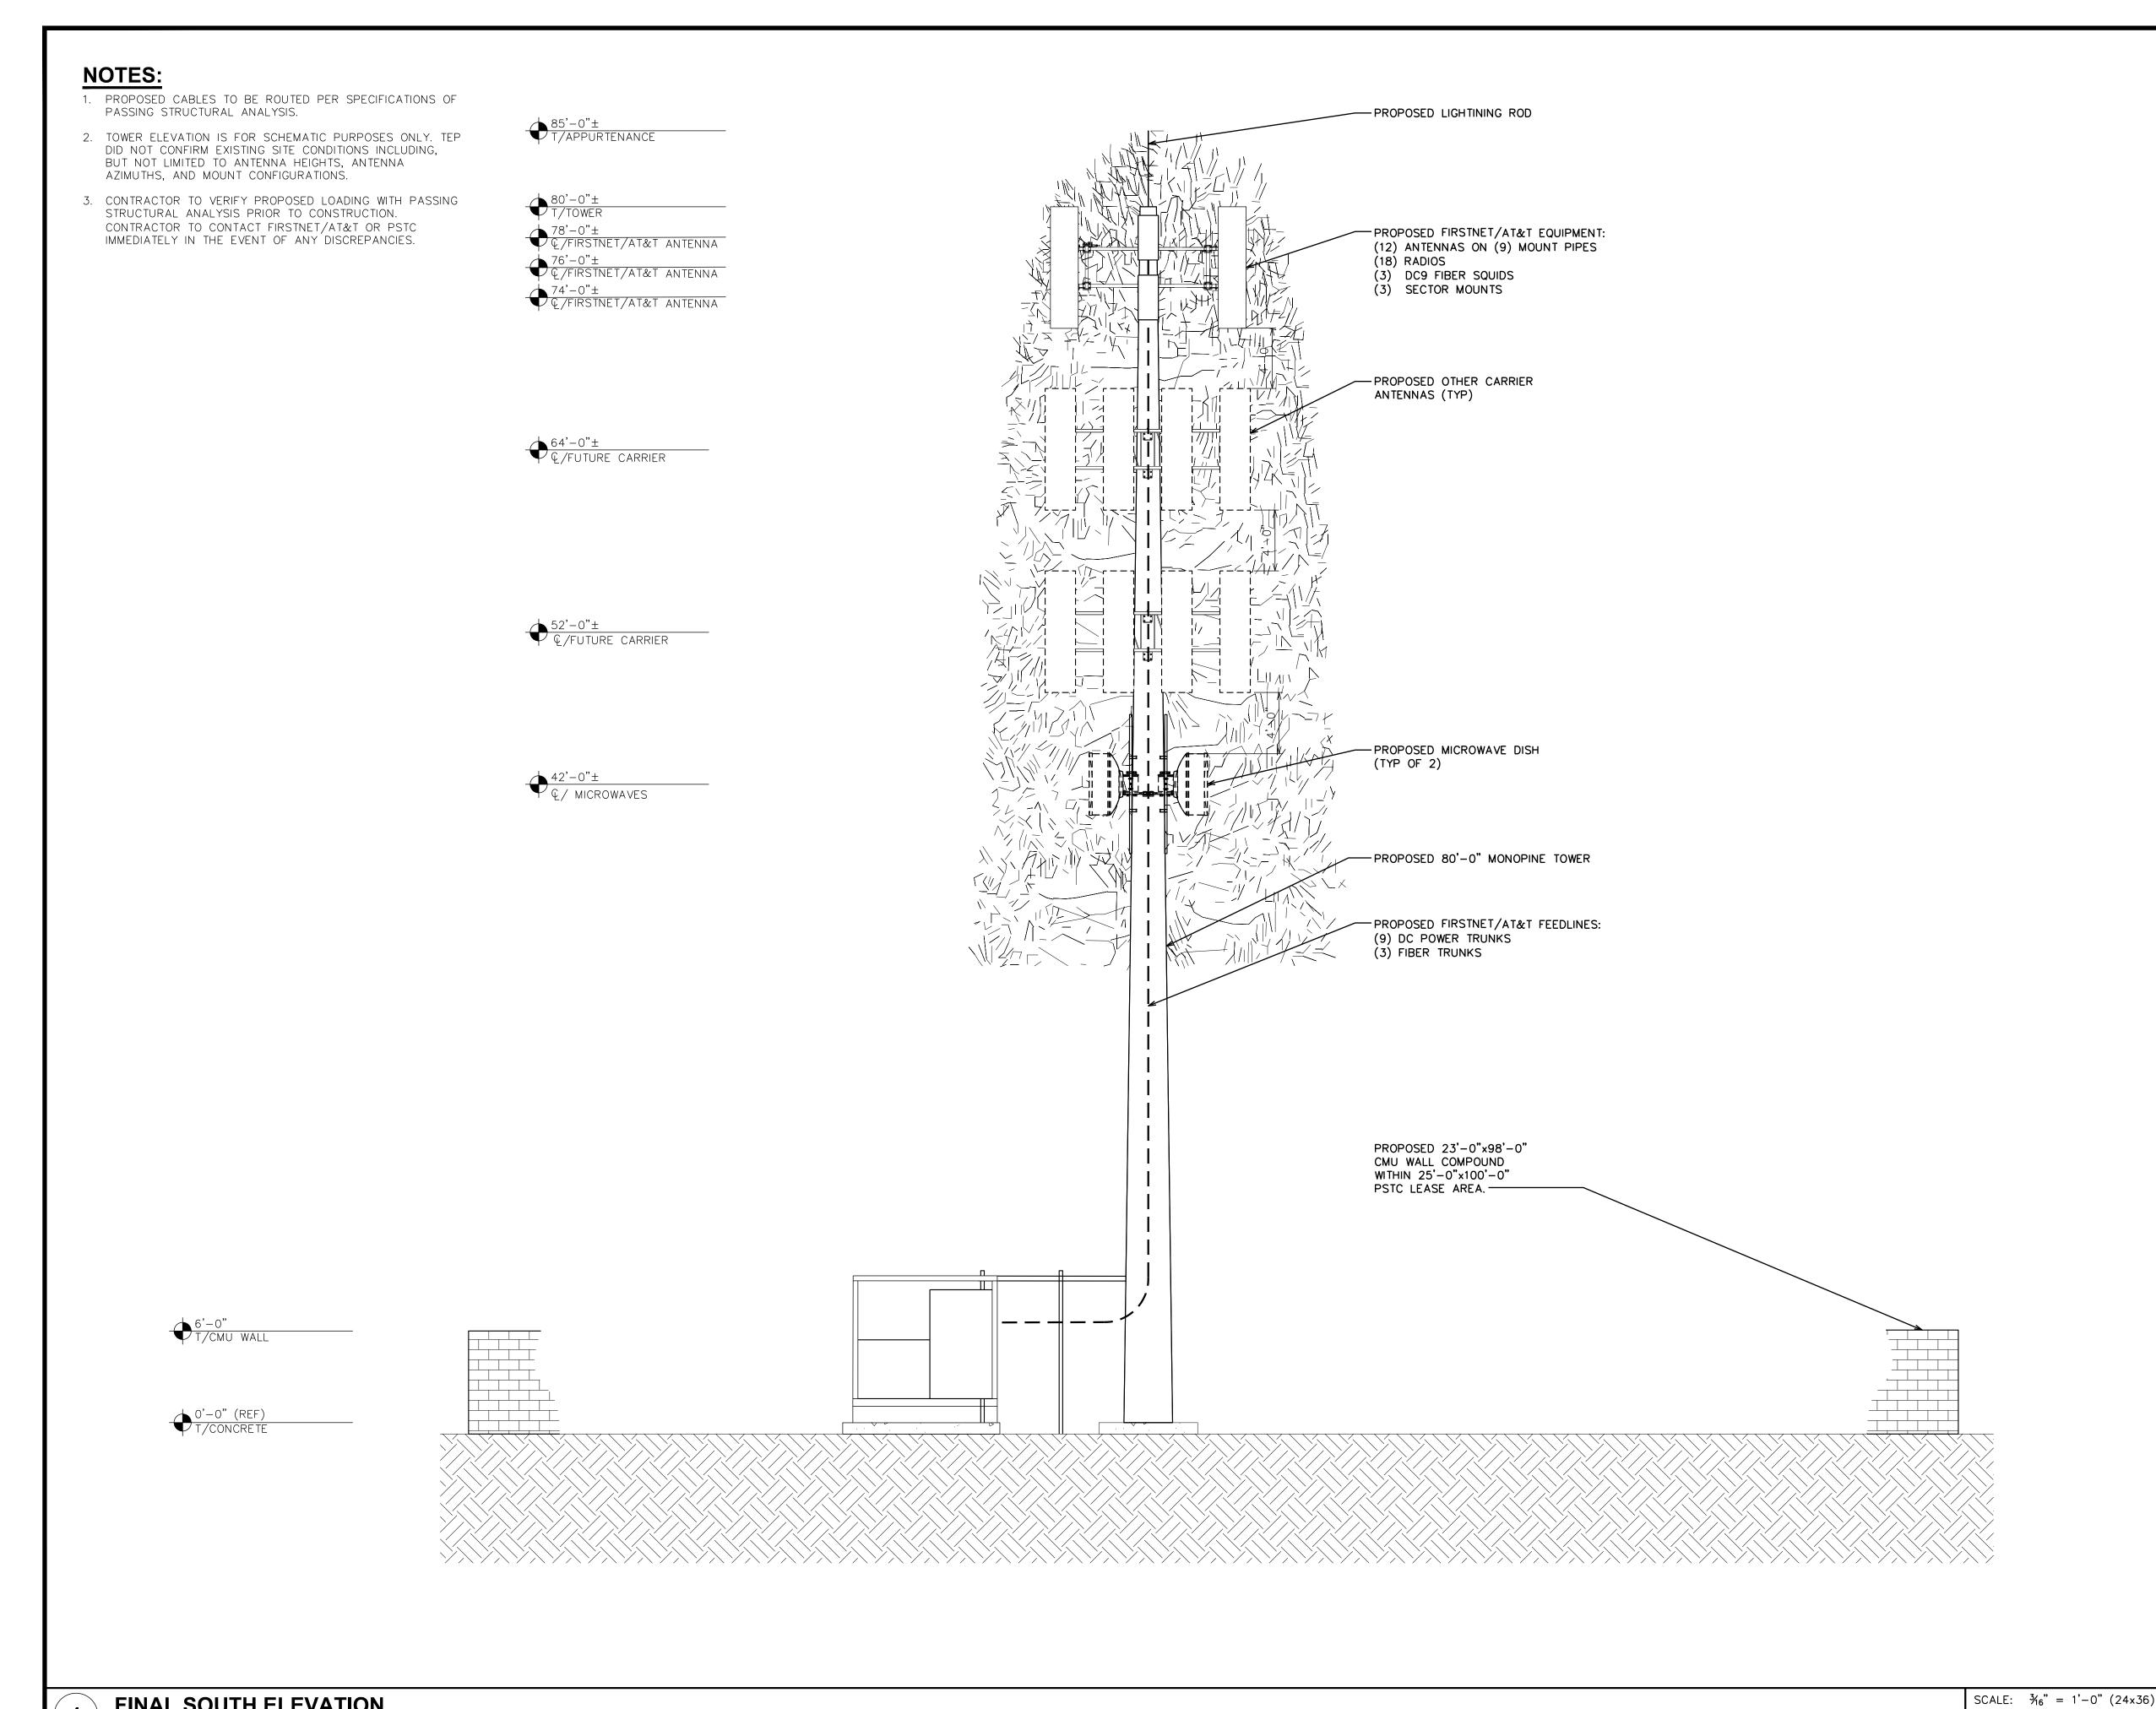
NOTES

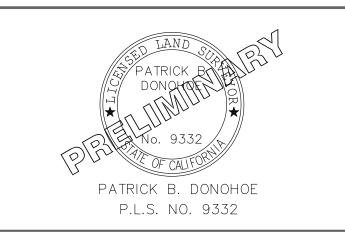SHEET NUMBER:

LS-4





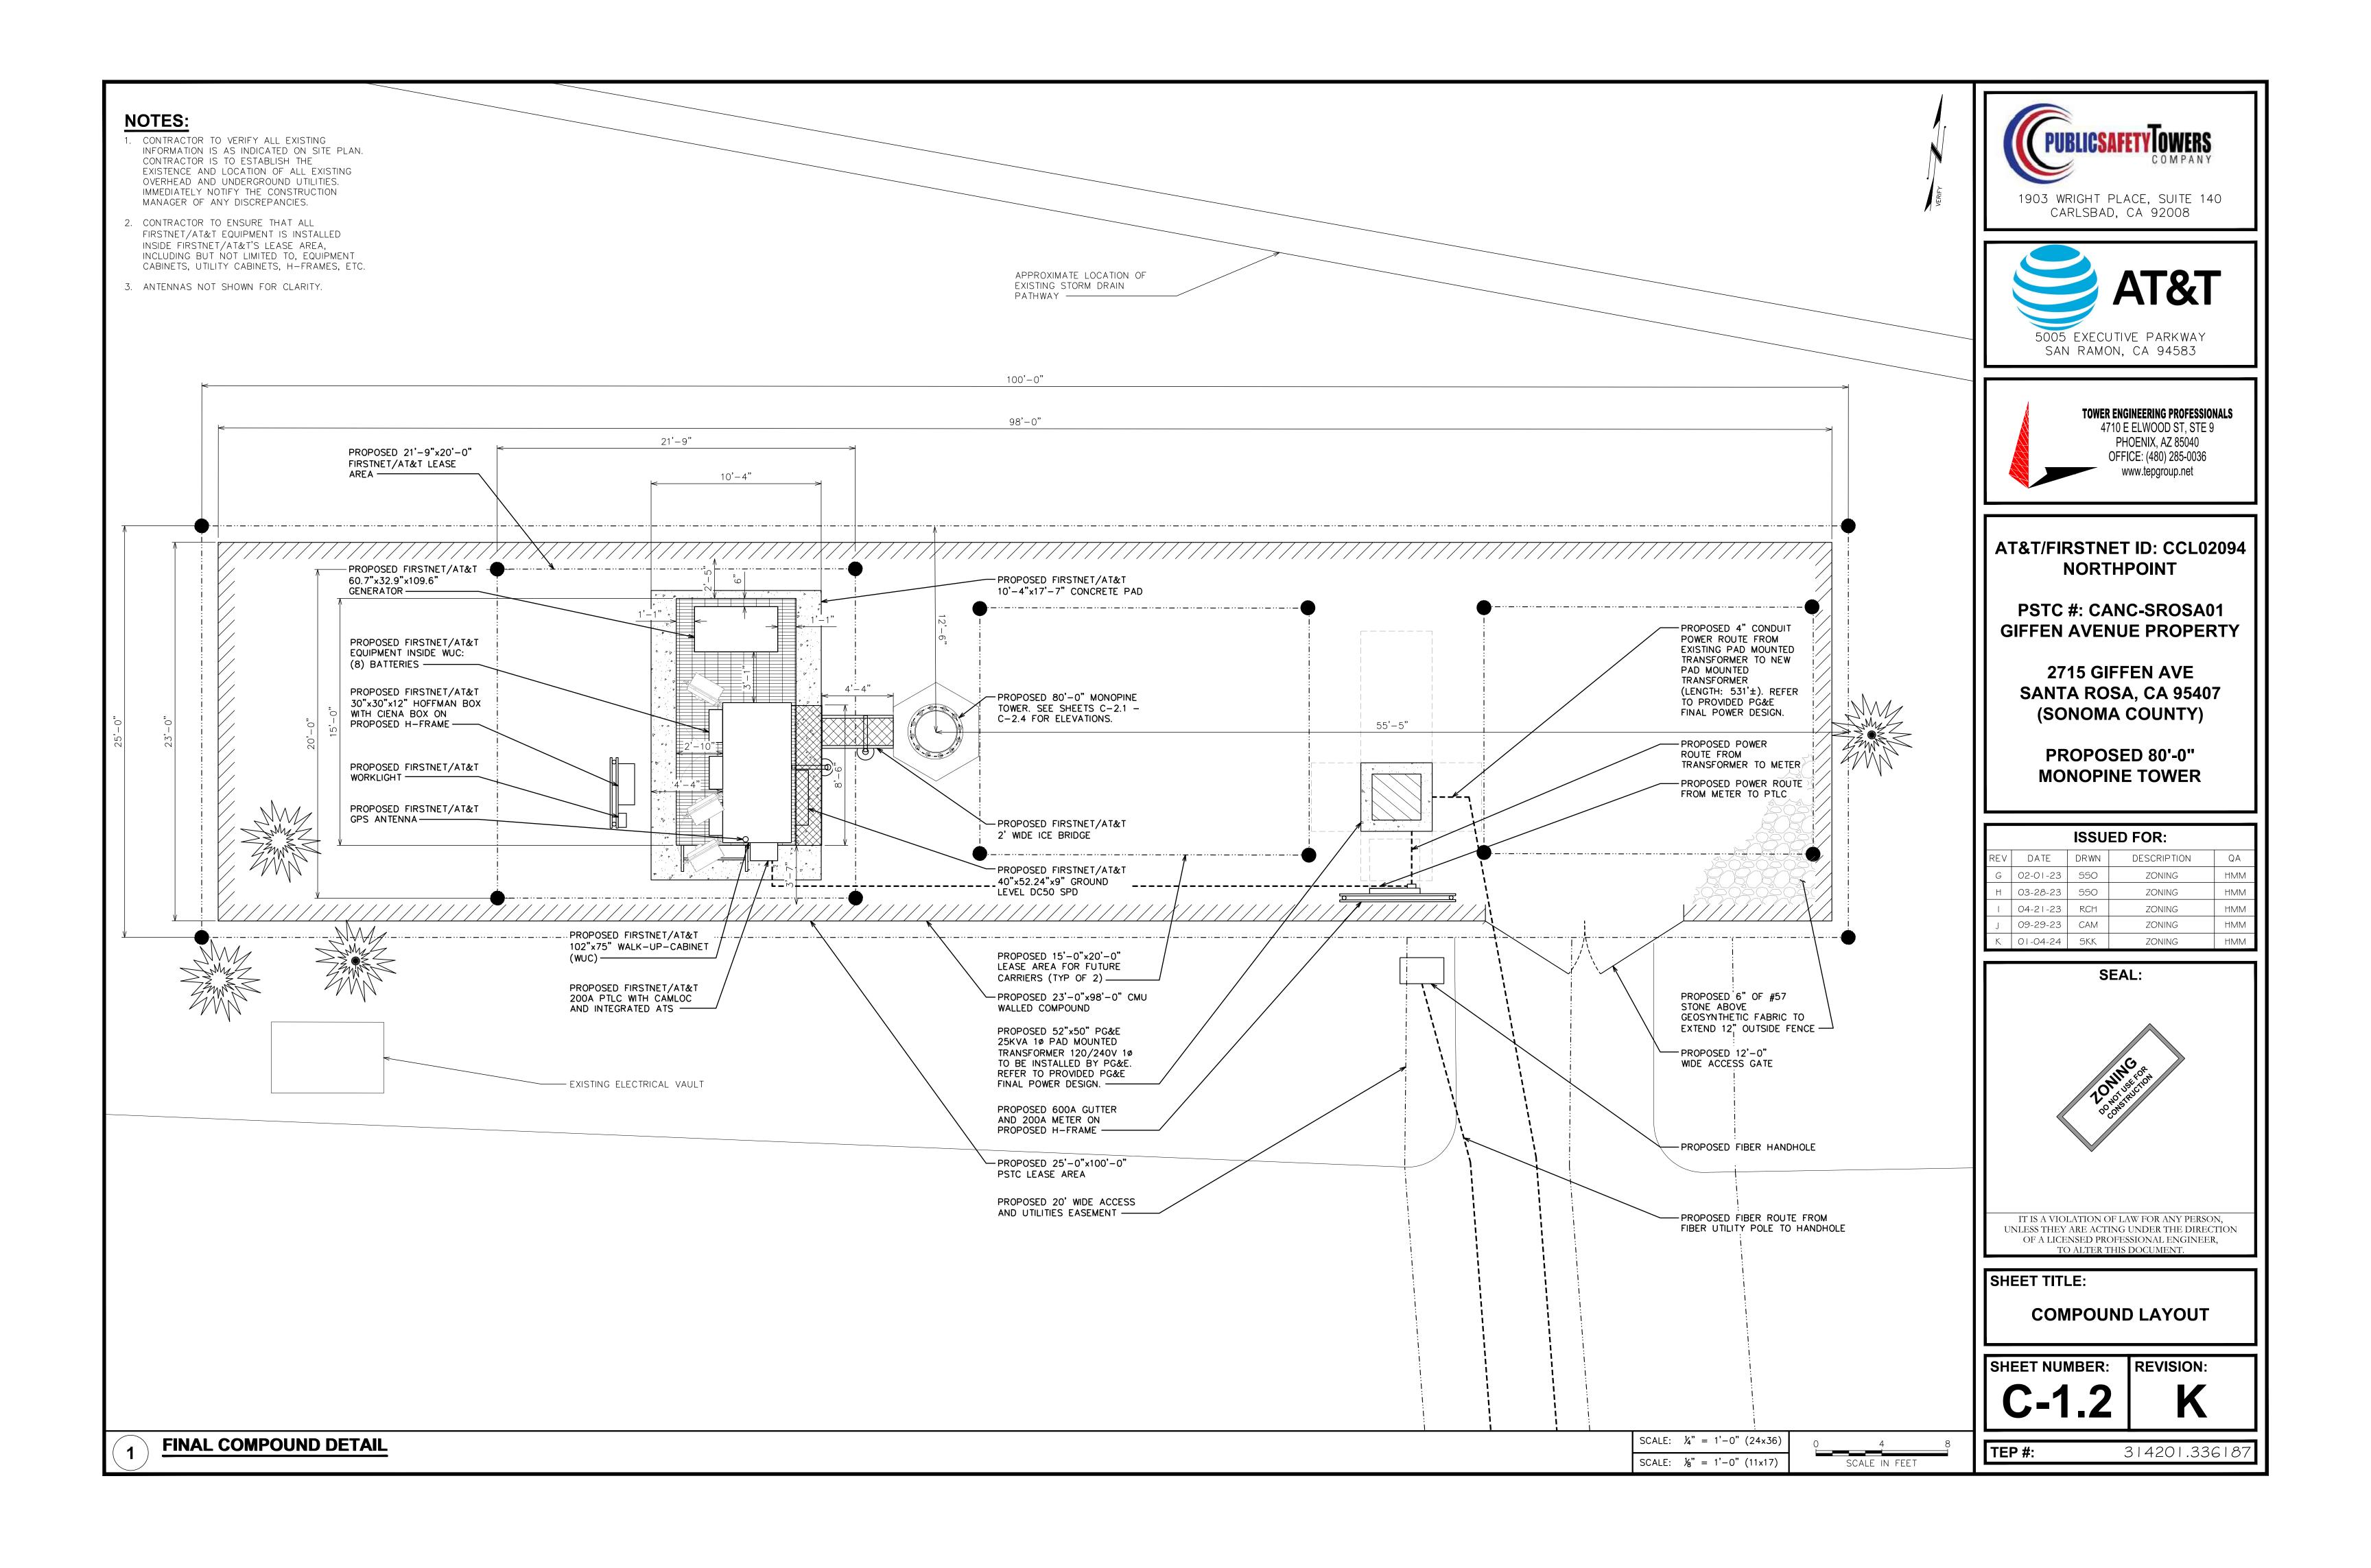







PSTC #: CANC-SROSA01 **GIFFEN AVENUE PROPERTY** 

**2715 GIFFEN AVE** SANTA ROSA, CA 95407 (SONOMA COUNTY)

> PROPOSED 80'-0" MONOPINE TOWER

ISSUED FOR:						
REV	DATE	DRWN	DESCRIPTION	QA		
G	02-01-23	550	ZONING	НММ		
Н	03-28-23	550	ZONING	НММ		
1	04-21-23	RCH	ZONING	НММ		
J	09-29-23	CAM	ZONING	НММ		
K	01-04-24	SKK	ZONING	НММ		

SEAL:




IT IS A VIOLATION OF LAW FOR ANY PERSON, UNLESS THEY ARE ACTING UNDER THE DIRECTION OF A LICENSED PROFESSIONAL ENGINEER, TO ALTER THIS DOCUMENT.

SHEET TITLE:

FINAL SOUTH ELEVATION

SHEET NUMBER: REVISION:

TEP #: 314201.336187

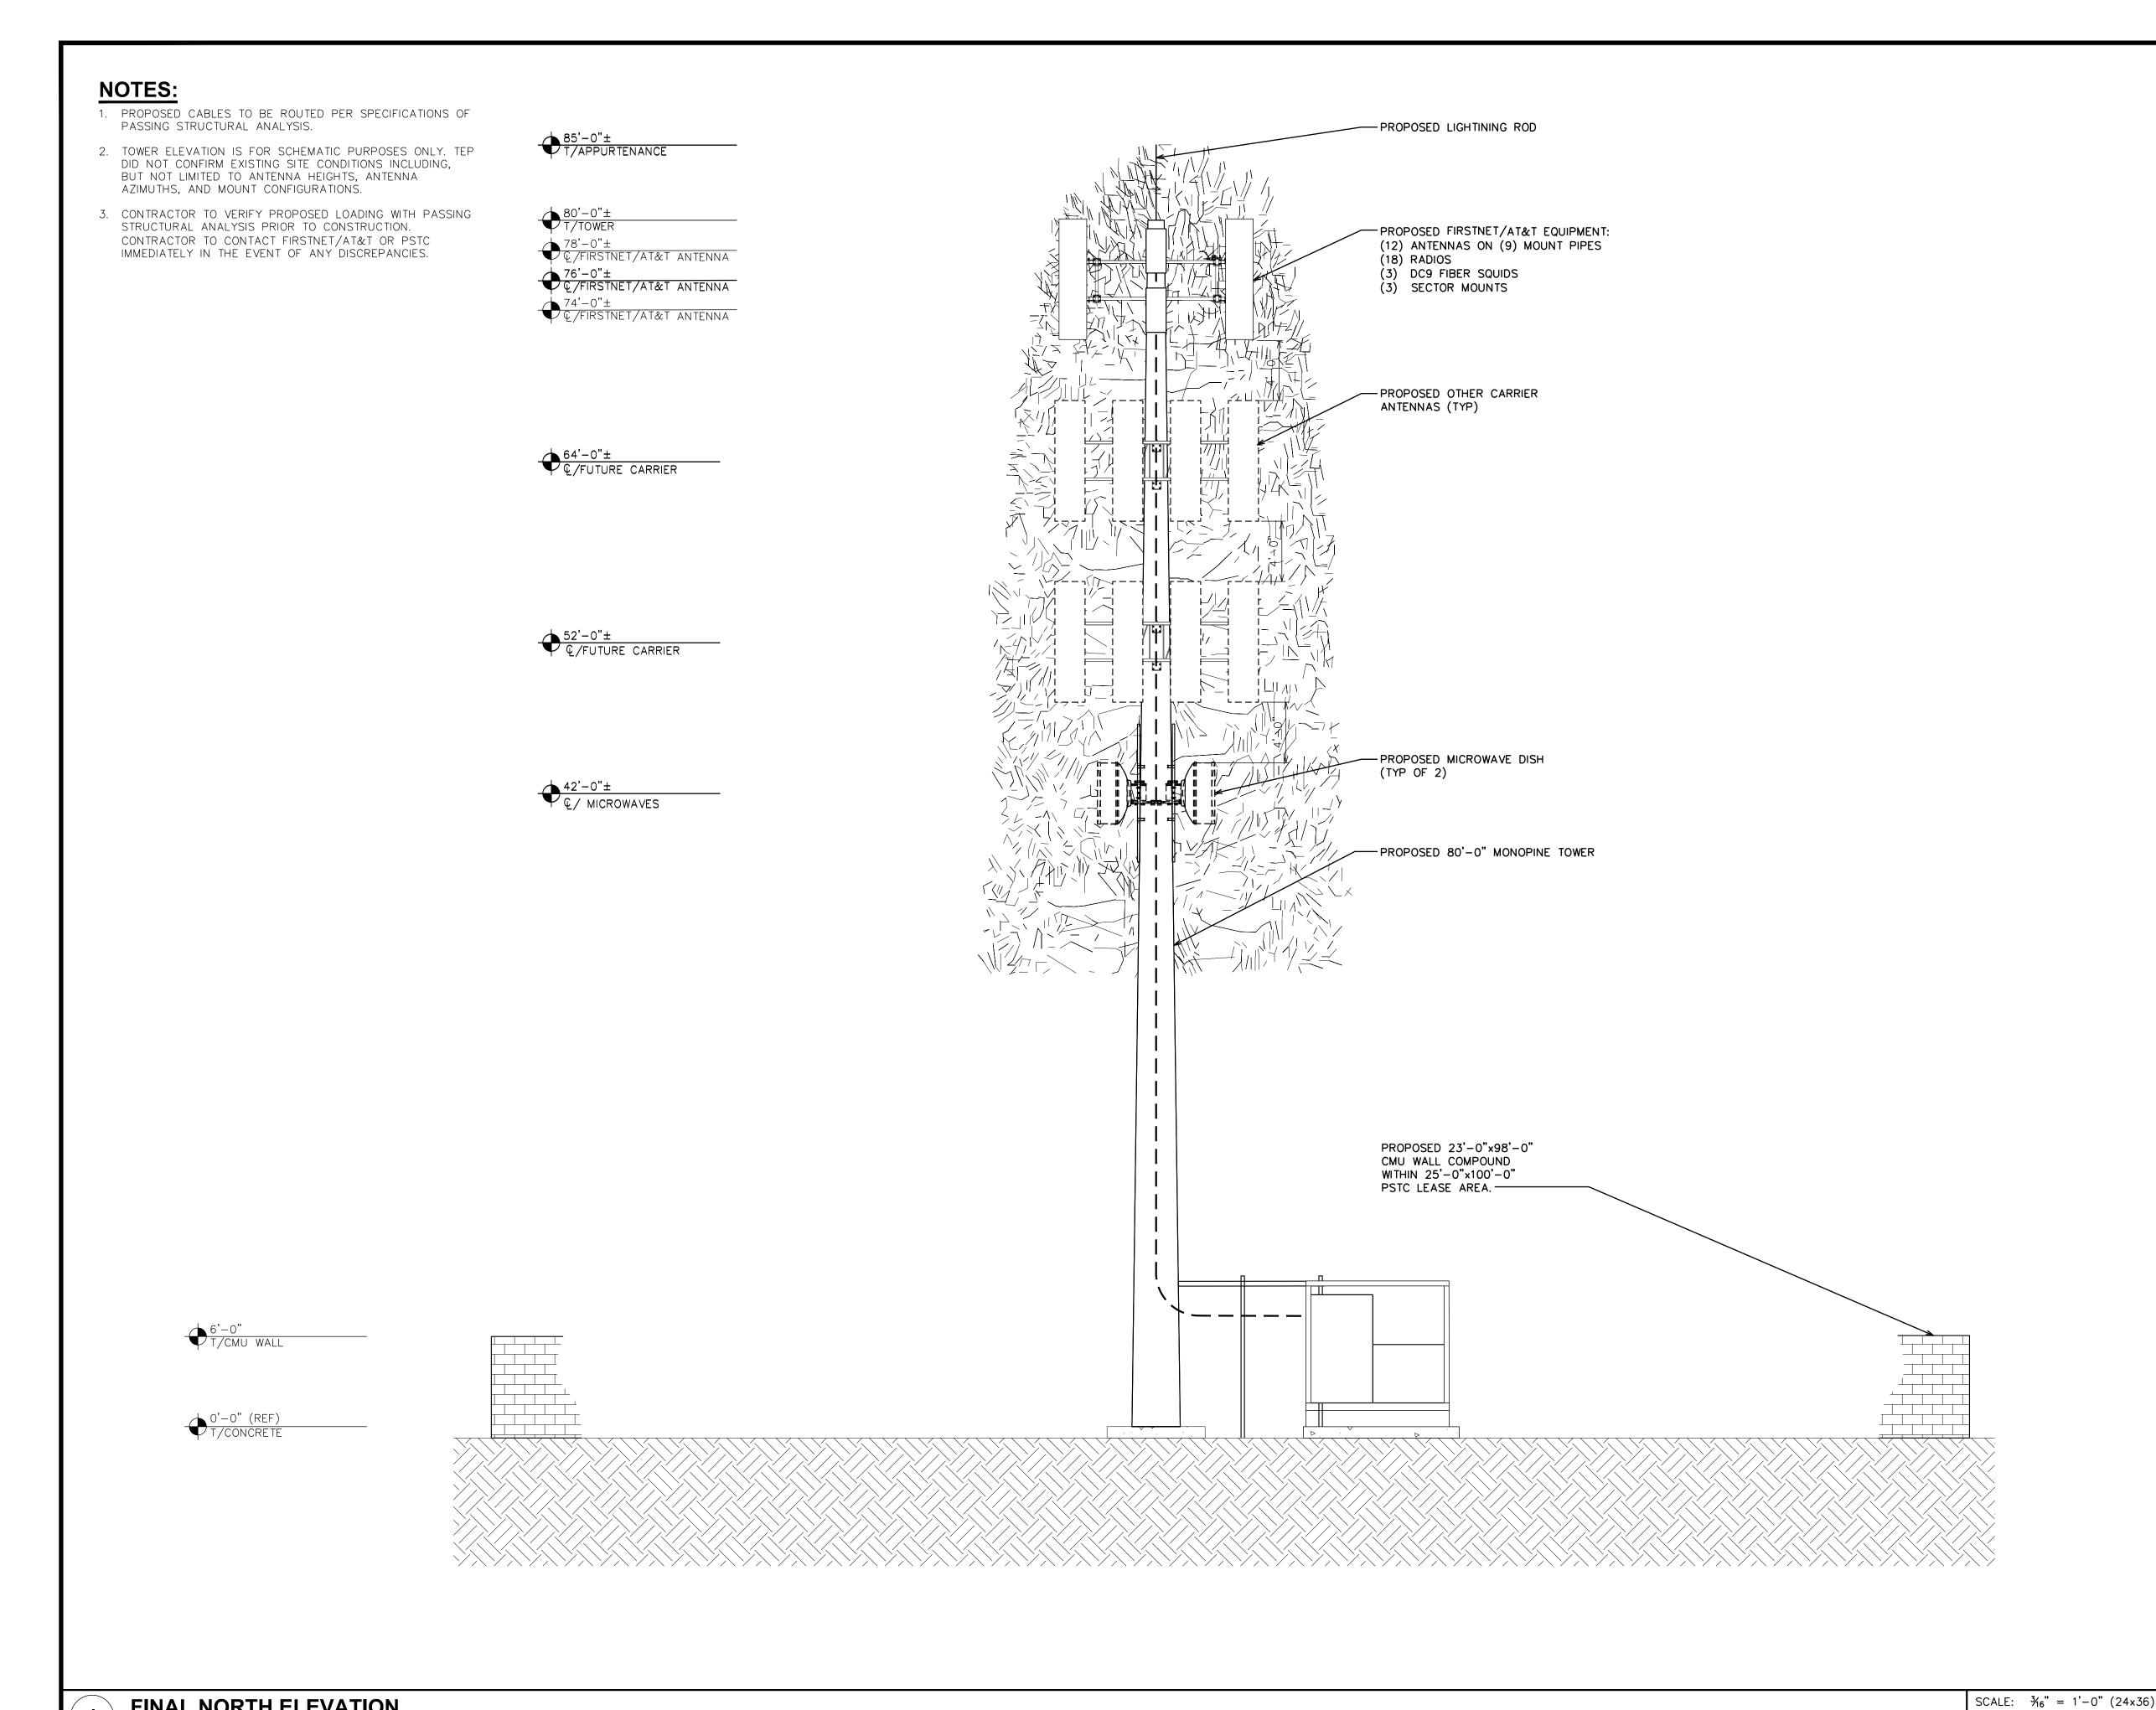







PSTC #: CANC-SROSA01 **GIFFEN AVENUE PROPERTY** 

**2715 GIFFEN AVE** SANTA ROSA, CA 95407 (SONOMA COUNTY)

> PROPOSED 80'-0" **MONOPINE TOWER**

	ISSUED FOR:						
F	REV	DATE	DRWN	DESCRIPTION	QA		
	G	02-01-23	550	ZONING	НММ		
	Н	03-28-23	550	ZONING	НММ		
	1	04-21-23	RCH	ZONING	НММ		
	J	09-29-23	CAM	ZONING	НММ		
	K	01-04-24	SKK	ZONING	НММ		

SEAL:



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SHEET TITLE:

FINAL NORTH ELEVATION

SHEET NUMBER: REVISION:


TEP #:

**FINAL NORTH ELEVATION** 

SCALE:  $\frac{3}{32}$ " = 1'-0" (11x17)

SCALE IN FEET

314201.336187

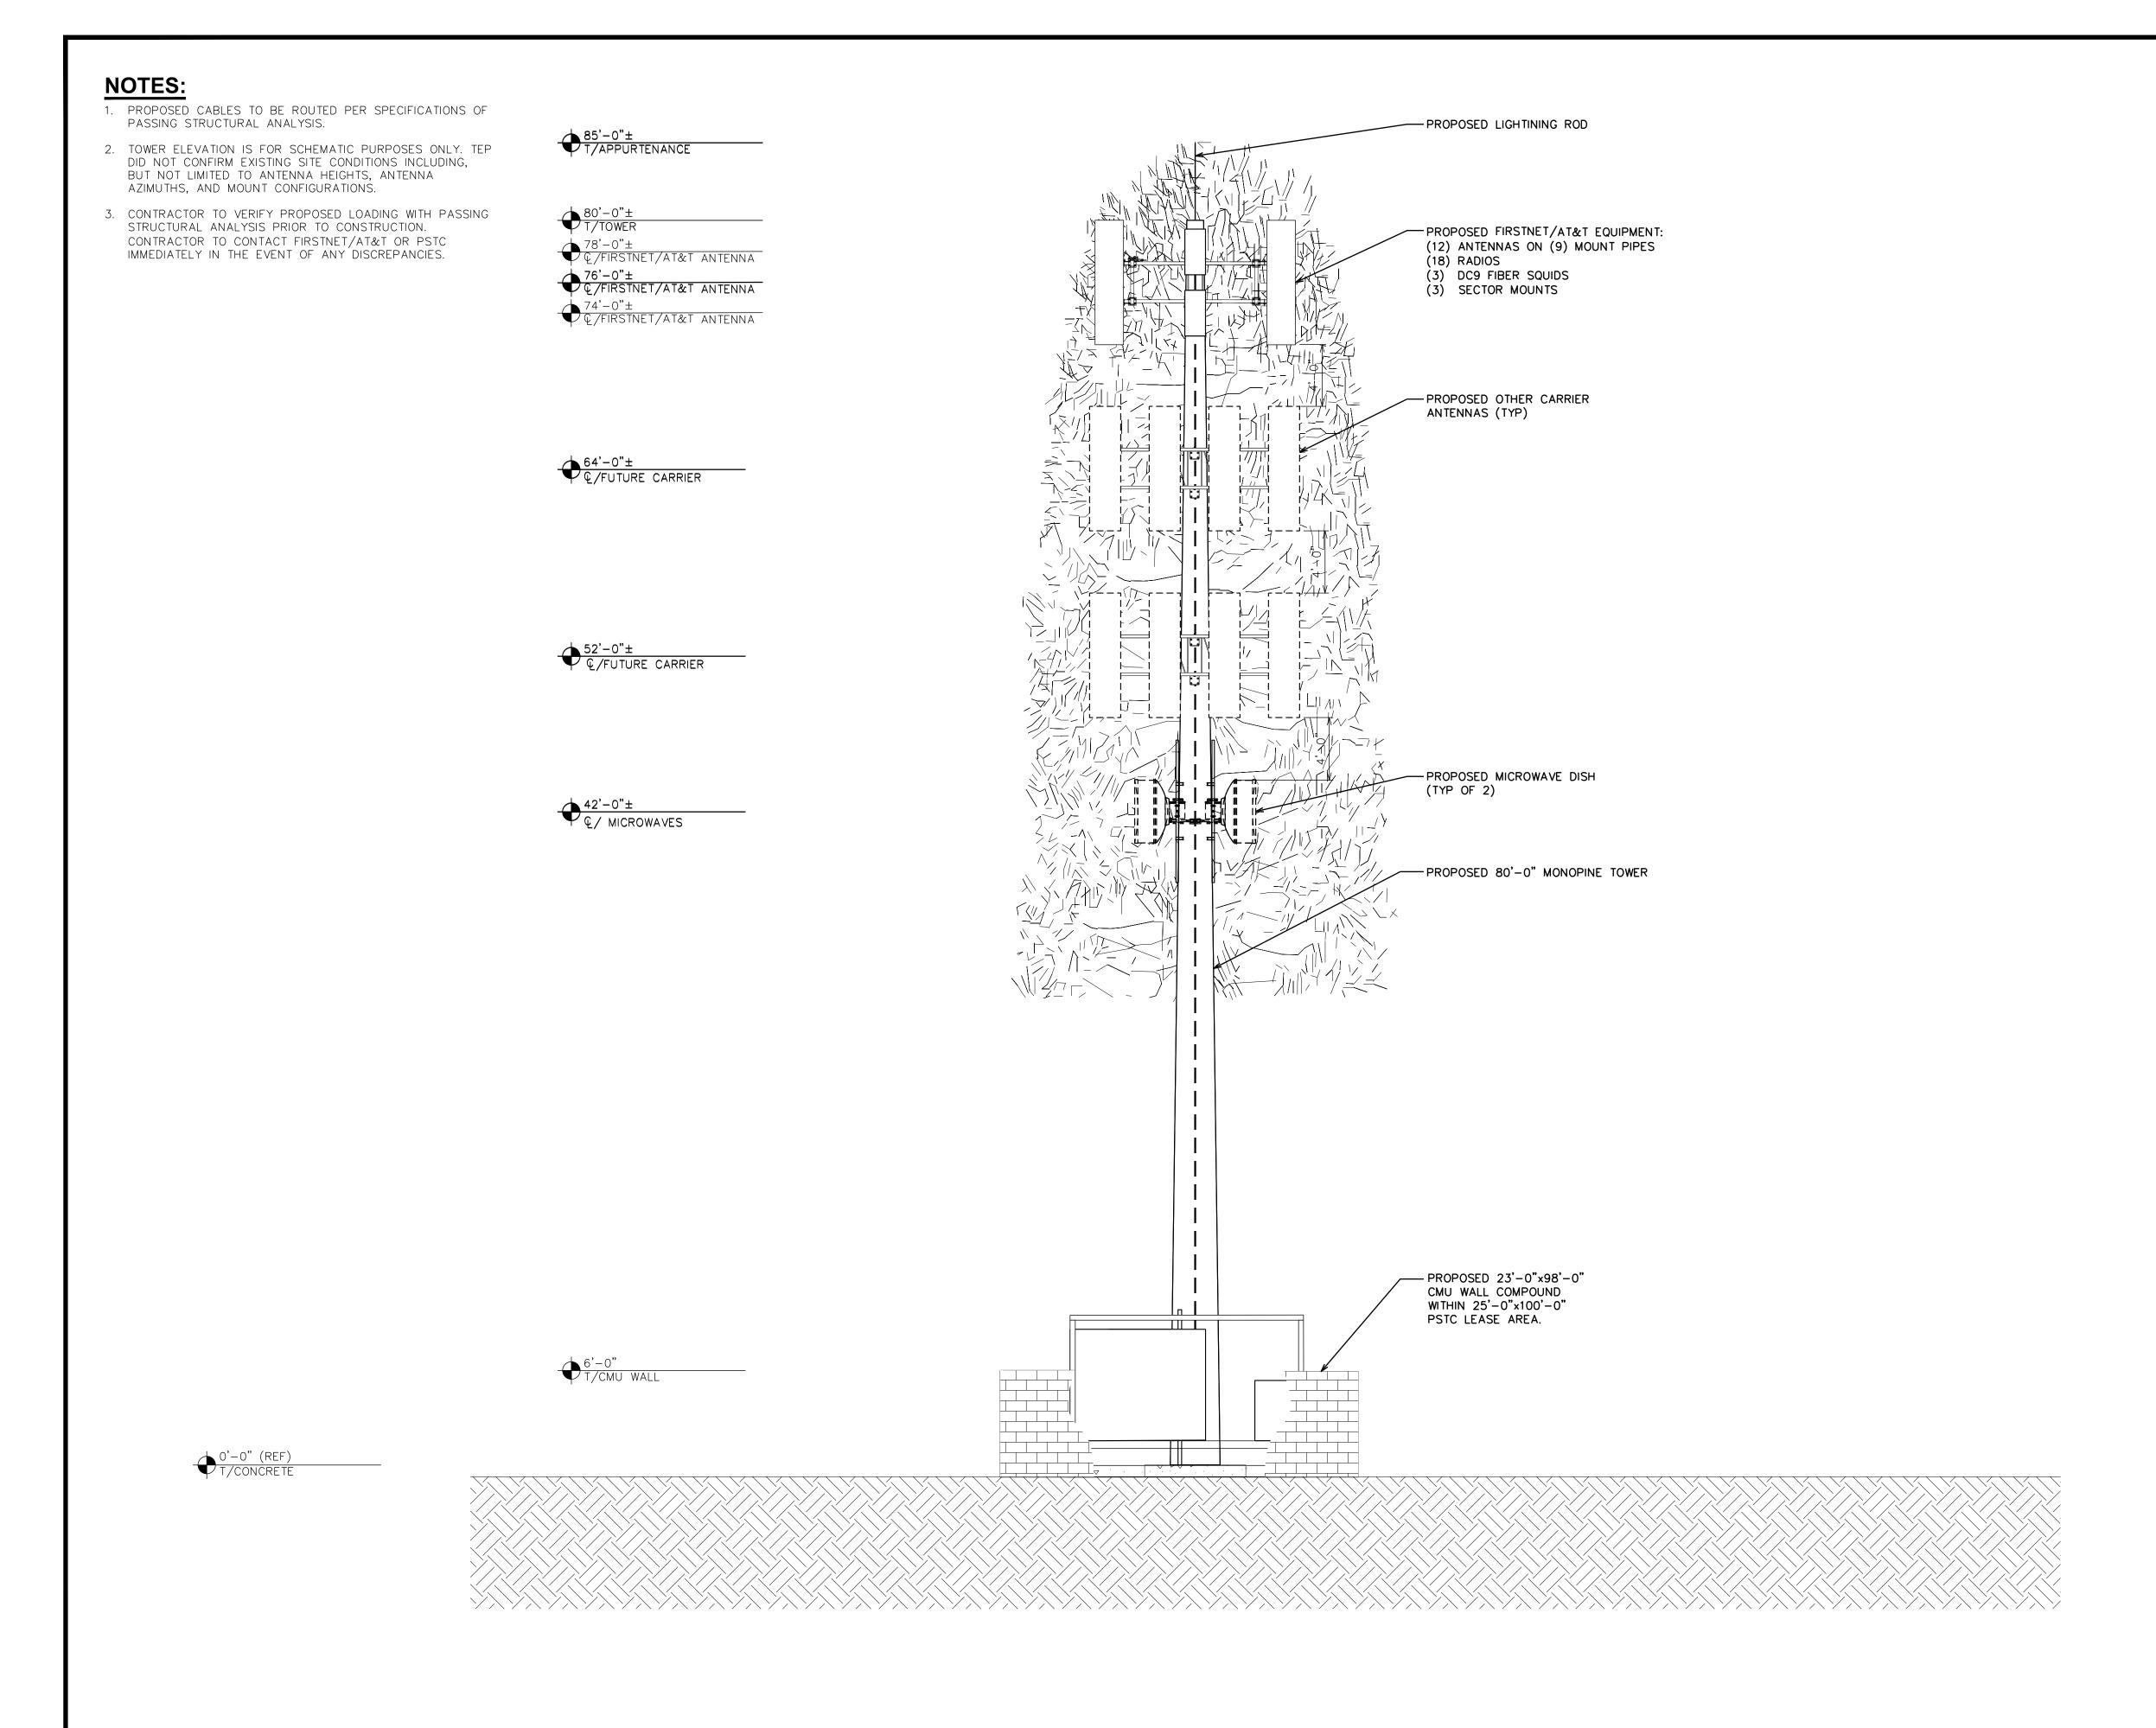







PSTC #: CANC-SROSA01 **GIFFEN AVENUE PROPERTY** 

**2715 GIFFEN AVE** SANTA ROSA, CA 95407 (SONOMA COUNTY)

PROPOSED 80'-0" **MONOPINE TOWER** 

	ISSUED FOR:								
REV	DATE	DRWN	DESCRIPTION	QA					
G	02-01-23	550	ZONING	НММ					
Н	03-28-23	550	ZONING	НММ					
1	04-21-23	RCH	ZONING	НММ					
J	09-29-23	CAM	ZONING	НММ					
K	01-04-24	SKK	ZONING	НММ					

SEAL:



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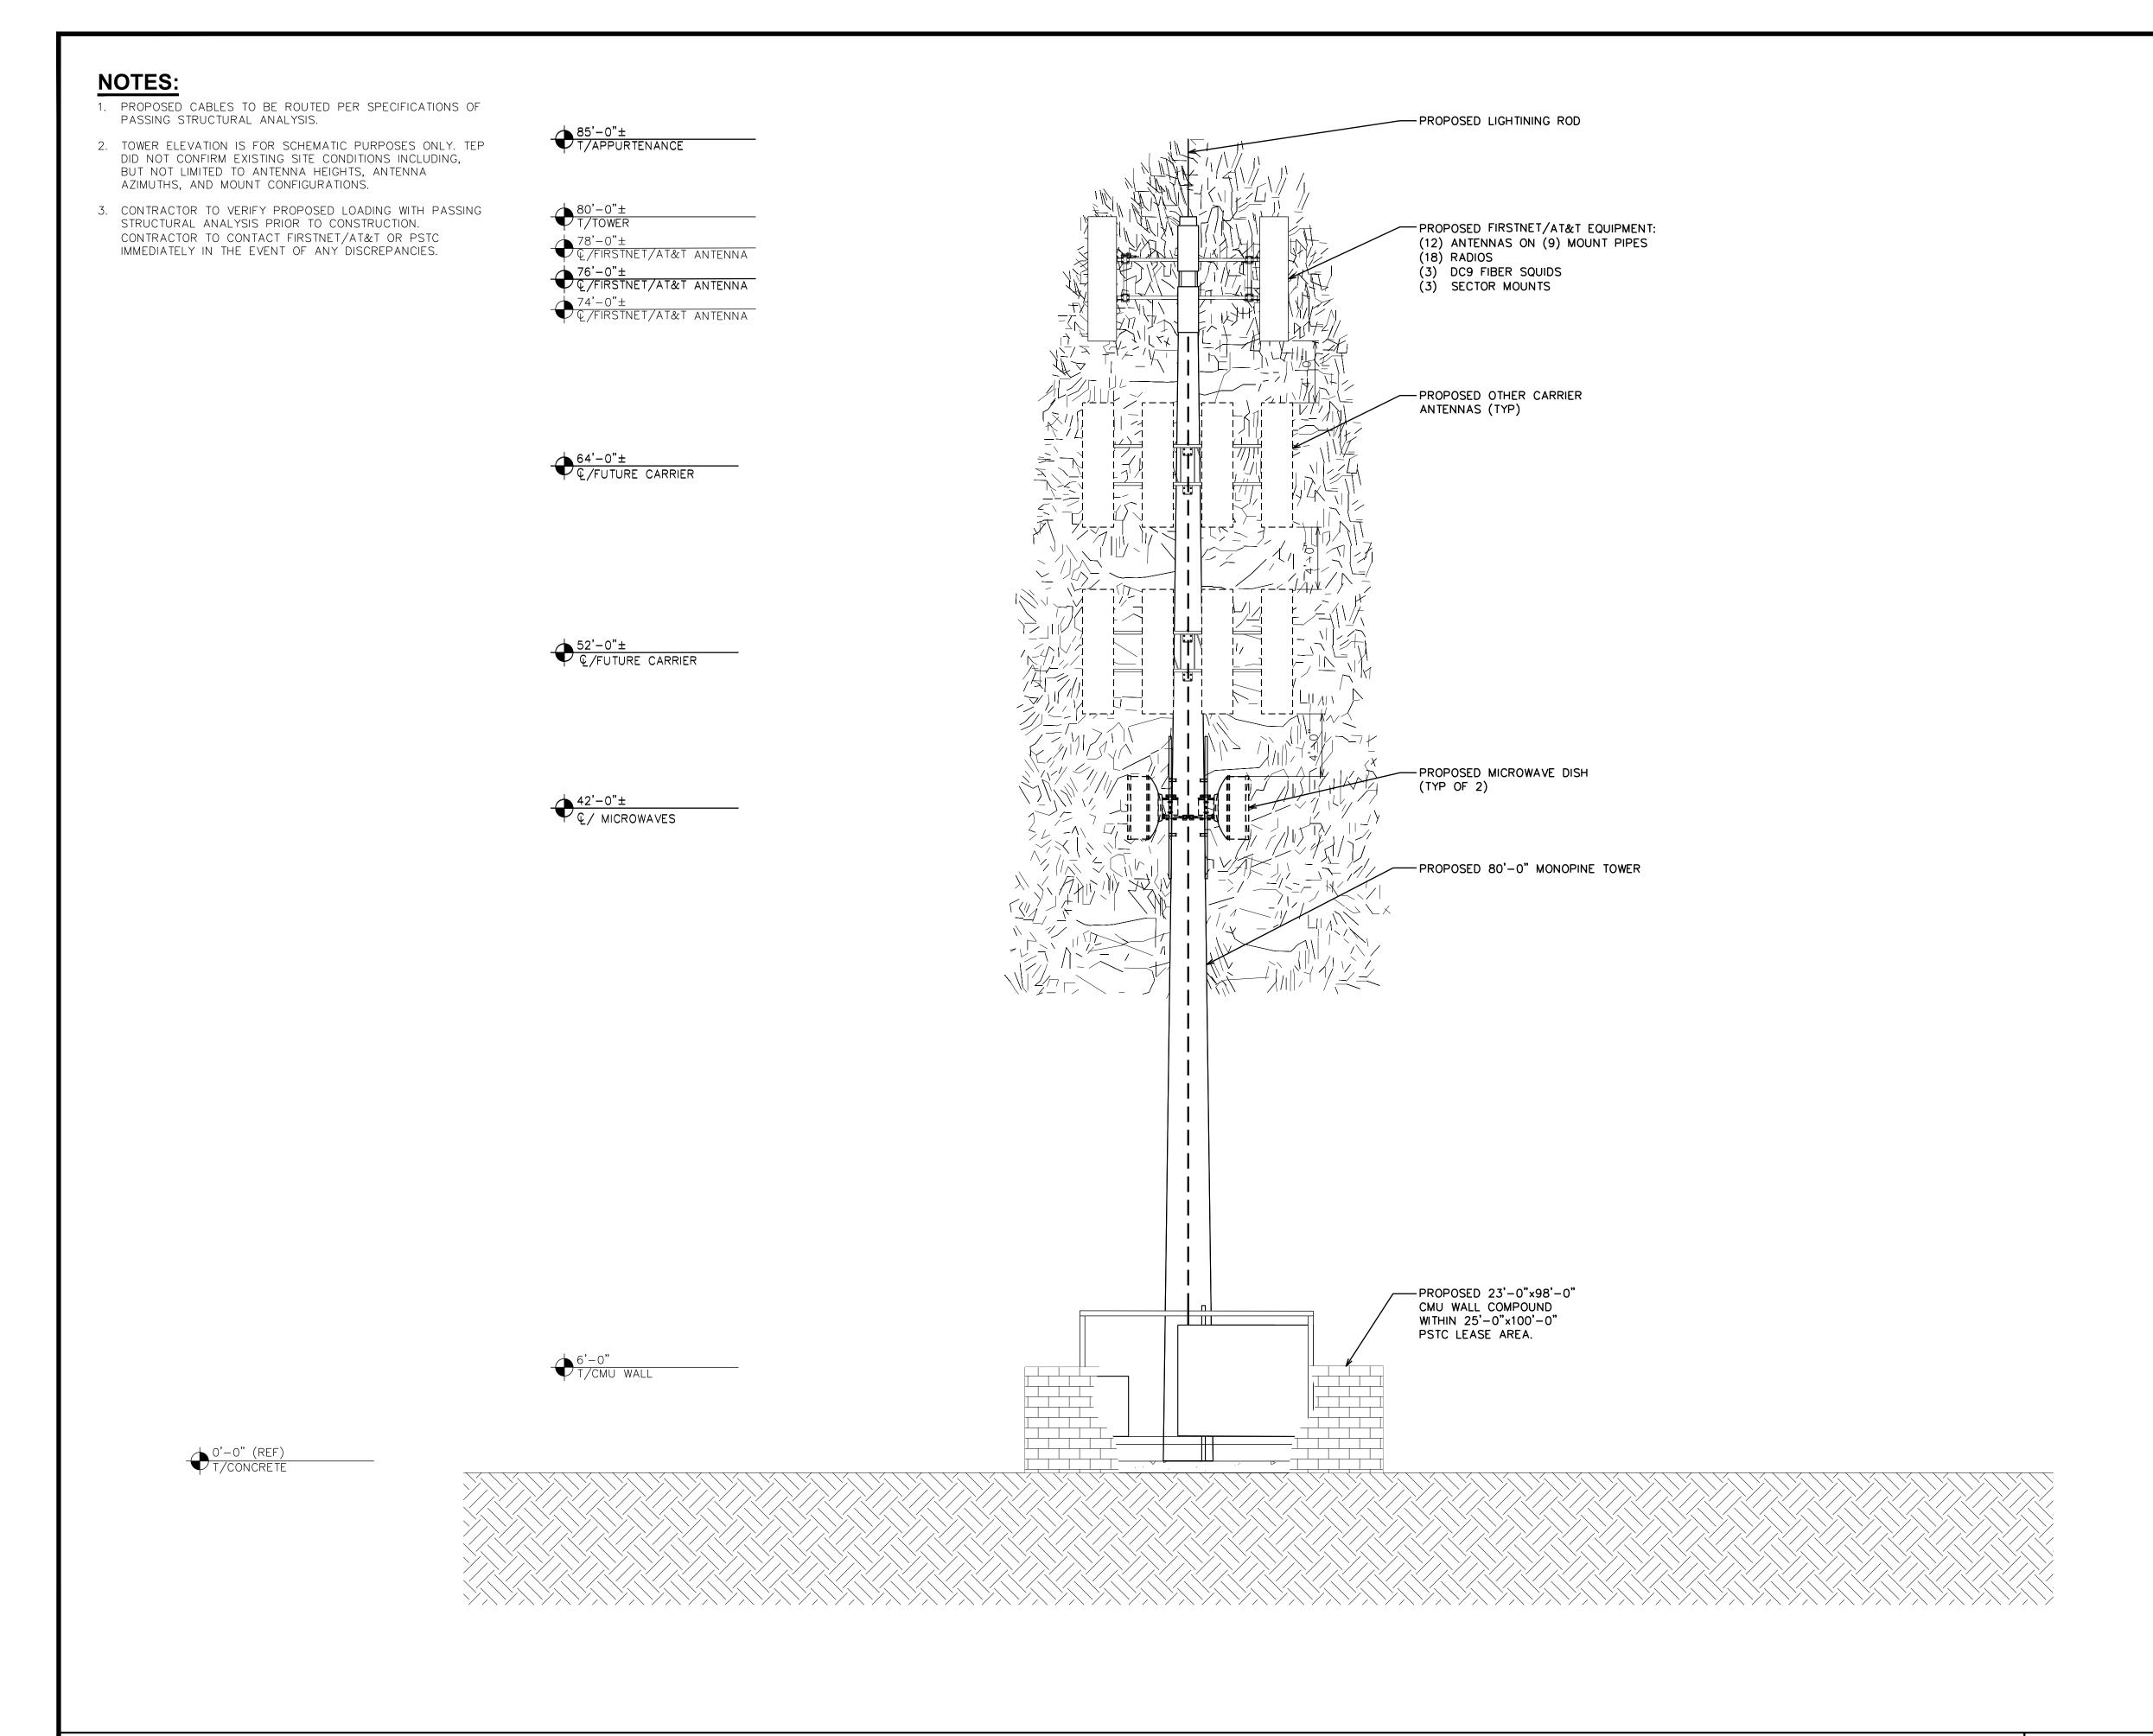
SHEET TITLE:

FINAL EAST ELEVATION

SHEET NUMBER: REVISION:

TEP #:

314201.336187









PSTC #: CANC-SROSA01 **GIFFEN AVENUE PROPERTY** 

**2715 GIFFEN AVE** SANTA ROSA, CA 95407 (SONOMA COUNTY)

> PROPOSED 80'-0" **MONOPINE TOWER**

ISSUED FOR:							
REV	DATE	DRWN	DESCRIPTION	QA			
G	02-01-23	550	ZONING	НММ			
Н	03-28-23	550	ZONING	НММ			
1	04-21-23	RCH	ZONING	НММ			
J	09-29-23	CAM	ZONING	НММ			
K	01-04-24	SKK	ZONING	НММ			





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SHEET TITLE:

FINAL WEST ELEVATION

SHEET NUMBER: REVISION:

FINAL WEST ELEVATION

SCALE:  $\frac{3}{32}$ " = 1'-0" (11x17)


SCALE:  $\frac{3}{16}$ " = 1'-0" (24×36)

SCALE IN FEET

TEP #:

314201.336187

NOTE: TEP DID NOT ANALYZE THE PROPOSED MOUNT SHOWN.

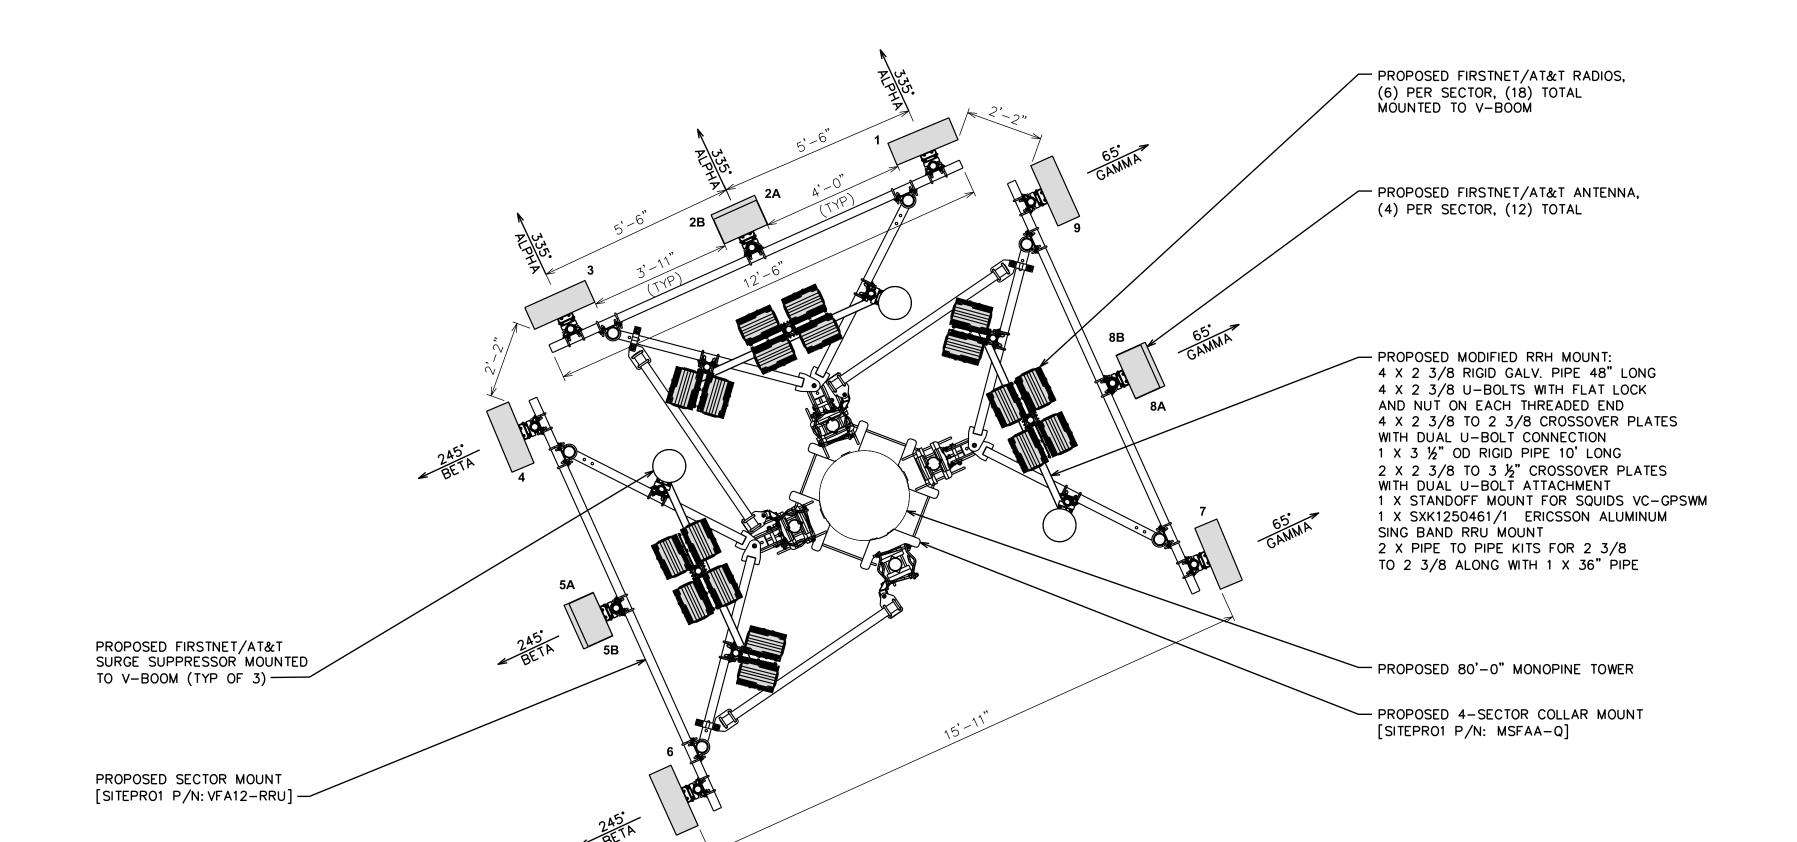

SCALE:  $\frac{3}{8}$ " = 1'-0" (24×36) SCALE:  $\frac{3}{16}$ " = 1'-0" (11x17) SCALE IN FEET

FINAL ANTENNA/FEEDLINE SCHEDULE										
SECTOR	POS.	MANUFACTURER (MODEL #)	MOUNTING HEIGHT	AZIMUTH (TN)	CABLE SIZE	CABLE LENGTH	OVP/RRH/TMA/DIPLEXER [MODEL #]			
ALPHA	1	QUINTEL (QD8612-3D)	© 0 76'−0"±	335°						
ALPHA	2A	ERICSSON (AIR6449-B77D)	Ç ⊚ 74'-0"±	335°			(1) RADIO 4449 B5/B12 (1) RADIO 8843 B2/B66A (1) RADIO 2012 B29 (1) RADIO 4426 B66			
ALPHA	2B	ERICSSON (AIR6419-B77G)	Ç ⊚ 78'-0"±	335°			(1) RADIO 4415 B30 (1) RADIO 4478 B14 (1) DC9-48-60-24-8C-EV			
ALPHA	3	QUINTEL (QD8616-7)	€ @ 76'-0"±	335°						
ВЕТА	4	QUINTEL (QD8612-3D)	€ @ 76'-0"±	245°			(4) DADIO 4440 DE (D40			
ВЕТА	5A	ERICSSON (AIR6449-B77D)	Ç ⊚ 74'-0"±	245°	(9) DC POWER TRUNKS (3) FIBER TRUNKS	126'±	(1) RADIO 4449 B5/B12 (1) RADIO 8843 B2/B66A (1) RADIO 2012 B29 (1) RADIO 4426 B66			
ВЕТА	5B	ERICSSON (AIR6419-B77G)	€ @ 78'-0"±	245°			(1) RADIO 4415 B30 (1) RADIO 4478 B14 (1) DC9-48-60-24-8C-EV			
ВЕТА	6	QUINTEL (QD8616-7)	€ @ 76'-0"±	245°			(1) DC9-40-00-24-0C-EV			
GAMMA	7	QUINTEL (QD8612-3D)	€ @ 76'-0"±	65°						
GAMMA	84	ERICSSON (AIR6449-B77D)	€ @ 74'-0"±	65°			(1) RADIO 4449 B5/B12 (1) RADIO 8843 B2/B66A (1) RADIO 2012 B29			
GAMMA	8B	ERICSSON (AIR6419-B77G)	€ @ 78'-0"±	65°			(1) RADIO 4426 B66 (1) RADIO 4415 B30 (1) RADIO 4478 B14			
GAMMA	9	QUINTEL (QD8616-7)	€ @ 76'-0"±	65°			(1) DC9-48-60-24-8C-EV			

\*NOTE: EQUIPMENT IS PRELIMINARY AND SUBJECT TO CHANGE







#### AT&T/FIRSTNET ID: CCL02094 NORTHPOINT

PSTC #: CANC-SROSA01 **GIFFEN AVENUE PROPERTY** 

**2715 GIFFEN AVE** SANTA ROSA, CA 95407 (SONOMA COUNTY)

> PROPOSED 80'-0" MONOPINE TOWER

	ISSUED FOR:							
REV	DATE	DRWN	DESCRIPTION	QA				
G	02-01-23	550	ZONING	НММ				
Н	03-28-23	550	ZONING	НММ				
-	04-21-23	RCH	ZONING	НММ				
J	09-29-23	CAM	ZONING	НММ				
K	01-04-24	SKK	ZONING	НММ				





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#### SHEET TITLE:

**FINAL ANTENNA** LAYOUT & SCHEDULE

SHEET NUMBER: REVISION:

314201.336187

FINAL ANTENNA SCHEDULE
SCALE: N.T.S.


FINAL ANTENNA LAYOUT


### A DELTA

# A NELTA

# **A** NELTA

#### 2.2 System Configuration

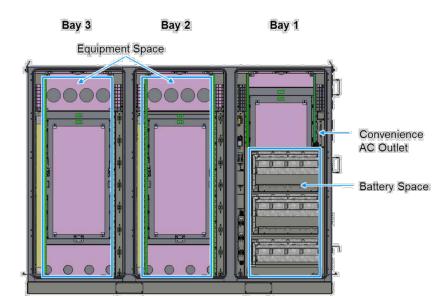

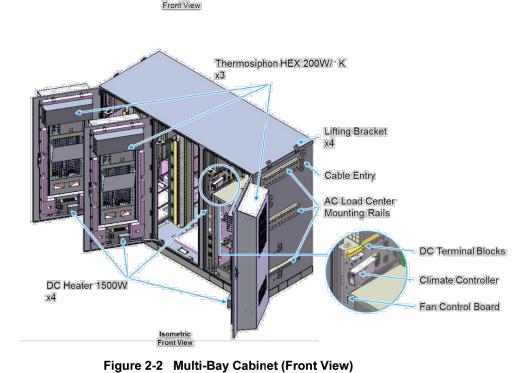

#### 2.3 Cabinet Specifications

The cabinet is arranged for installation of a Delta or third-party AC Load Center and front access DC Power System. Table 2-1 below contains the input power specifications.

ltem	Specification/Function
AC Input Range	
AC Input Voltage	1W+N+FG 100~120V <sub>AC</sub>
AC Input Current (maximum)	12A (Max.)
AC Input Frequency	50/60Hz
DC Input Range	
DC Input Voltage	40 - 60V <sub>DC</sub> (54V typical)
DC Input Current Rating	224A (max)
Battery Section	
	(3) Trays arranged for -48V battery strings, designe for:
Battery Trays	GNB Marathon M12V180FT
	Enersys SBS190F
	Enersys SBS170F
Climate Control	
Control & Supervisor Unit	Delta controller
	(3) 200W/°K Thermosiphon HEX
Cooling	Cooling Capacity 9.1kW
Cooling	Maintains equipment inlet <65°C
	with exterior ambient <46°C
Heating	(4) 1500W DC Heaters
Environmental	
Operating Temperature	-40°C to +46°C (-40°F to +115°F)
Storage Temperature	-40°C to +75°C (-40°F to +167°F)
Relative Humidity	0~95% Relative Humidity, Non-Condensing
Altitude	-100 feet to +10,000 feet
Acoustic noise	≤ 65dBA @ +40°C equipment inlet
Destantion Olses	IP55 (EN 60529)
Protection Class	NEBS III (GR-487)

#### Dimensions and Weight

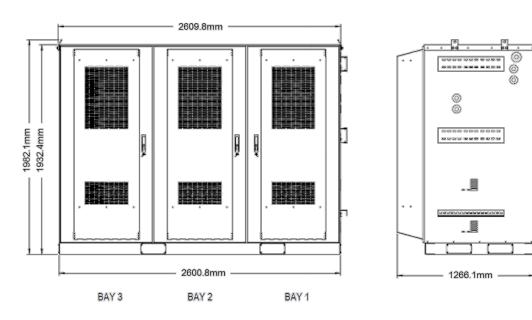


Figure 2-3 Cabinet Dimensions

Item	Specification/Function
Dimensions	2600.8W x 1932.4H x 1266.1D mm (102"W x 72"H x 49.5"D + 4" plinth)
Weight	2270* lbs. (* Batteries, Power System and Load Equipment excluded)

Installation and Operation Manual 13 14 Installation and Operation Manual

Installation and Operation Manual

#### AT&T/FIRSTNET ID: CCL02094 NORTHPOINT

1903 WRIGHT PLACE, SUITE 140 CARLSBAD, CA 92008

5005 EXECUTIVE PARKWAY SAN RAMON, CA 94583

TOWER ENGINEERING PROFESSIONALS
4710 E ELWOOD ST, STE 9
PHOENIX, AZ 85040
OFFICE: (480) 285-0036
www.tepgroup.net

PSTC #: CANC-SROSA01
GIFFEN AVENUE PROPERTY

2715 GIFFEN AVE SANTA ROSA, CA 95407 (SONOMA COUNTY)

PROPOSED 80'-0"
MONOPINE TOWER

#### **ISSUED FOR:** rev date drwn | DESCRIPTION QΑ HMM G 02-01-23 550 ZONING H 03-28-23 SSO HMM ZONING HMM 04-21-23 RCH ZONING 09-29-23 CAM ZONING HMM HMM K 01-04-24 SKK ZONING





IT IS A VIOLATION OF LAW FOR ANY PERSON, UNLESS THEY ARE ACTING UNDER THE DIRECTION OF A LICENSED PROFESSIONAL ENGINEER, TO ALTER THIS DOCUMENT.

#### SHEET TITLE:

WALK-UP-CABINET DETAILS

**C**-/

SHEET NUMBER:

REVISION:

**TEP #:** 314201.336187

A DELTA

#### Cabinet Installation

Use the following steps to install the cabinet.

Step 1 Use the provided Template to mark anchor hole locations.

Figure 3-11 Mounting Template

Step 2 Drill anchor holes per specifications from the anchor manufacturer.Step 3 Install anchors per instructions from the anchor manufacturer.

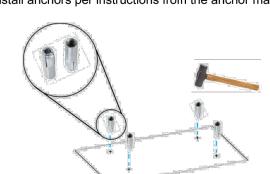


Figure 3-12 Insert anchors

Step 4 Place the pad separator (not provided) on the concrete pad aligned with the mounting holes. (A pad separator provides separation between the concrete pad and the base of the cabinet to prevent corrosion of the cabinet metal.)

Step 5 Mount the cabinet to the concrete pad with anchor bolts, lock washers and flat washers (not provided) per instructions from the anchor manufacturer.

Installation and Operation Manual

Step 6 Close and secure hinged anchor access covers.

A NELTA

#### AC Load Center Installation

The cabinet provides mounting rails for AC Load Center mounting and corresponding cable entry ports for wiring from the AC Load Center into the cabinet. Follow Load Center requirements for installation.

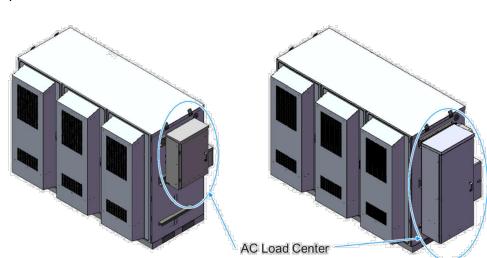


Figure 3-16 Cabinet with AC Load Center

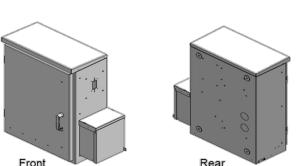


Figure 3-17 AC Load Center - MTS

**A** DELTA

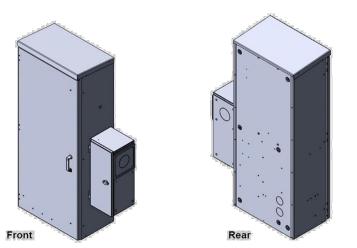


Figure 3-18 AC Load Center - ATS

**Note!** The cabinet provides mounting rails and AC cable entry ports arranged for mounting of Intersect PTLC-MTS-12200-CL or equivalent AC Load Center. An AC Load Center and related fittings are not provided with the cabinet and must be provided as integration or site materials.

#### Use the following steps to install the Load Center on the cabinet:

- Step 1 Provide suitable sealed fittings from the AC Load Center for entry into the Cabinet. Install on the Load Center before installing the Load Center onto the Cabinet. Delta recommends using Size 2" x 4" long outdoor rated pipe nipples and sealing conduit nuts (not provided)
- Step 2 Provide Intersect PTLC-MTS-12200-CL or equivalent AC Load Center. Secure the Load Center to mounting rails per Load Center vendor instructions.
- Step 3 Secure and seal fittings from the AC Load Center into entry ports on the
- Step 4 Confirm the Site Utility and Load Center Main AC input breakers are in the
- Step 5 Connect Site Utility 2W+N+G to the Load Center per Load Center vendor instructions, NEC, and local codes.

Note! Detailed AC Load Center position planning should include future equipment additions and changes

Installation and Operation Manual 29 30 Installation and Operation Manual

#### NOTES:

- DETAILS SHOWN WERE PROVIDED BY OTHERS AND ARE NOT CARRIED UNDER SIGNATURE AND SEAL OF TOWER ENGINEERING PROFESSIONALS ENGINEERING SERVICES AND/OR ITS ENGINEERS
- REFER TO MANUFACTURER'S INSTALLATION SPECIFICATIONS FOR FURTHER DETAILS ON INSTALLATION OF EXTENSION KIT.
- INSTALL EXHAUST VENT EXTENSION ASREQUIRED TO PROVIDE 12' CLEARANCE FROM GROUND LEVEL IN ACCORDANCE WITH CALIFORNIA STATE CODE.

#### SD030 | 2.2L | 30 kW INDUSTRIAL DIESEL GENERATOR SET

EPA Certified Stationary Emergency

GENERAC INDUSTRIAL

#### Standby Power Rating 30 kW, 38 kVA, 60 Hz

Prime Power Rating\* 27 kW, 34 kVA, 60 Hz


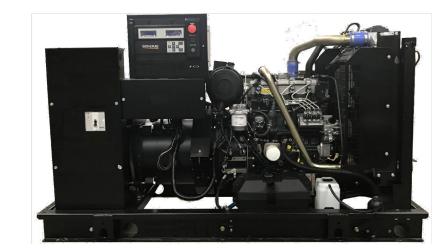


Image used for illustration purposes only

#### **Codes and Standards**


factory for details.



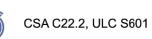


UL2200, UL6200, UL1236, UL489,



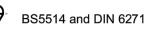



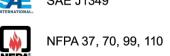

SD030 | 2.2L | 30 kW

**APPLICATION AND ENGINEERING DATA** 

EPA Certified Stationary Emergency

**ENGINE SPECIFICATIONS** 

EPA Emissions Compliance

Displacement - in3 (I

Bore - in (mm)

Stroke - in (mm)

Compression Ratio

Intake Air Method

Cylinder Head

Crankshaft Type

Engine Governing

Lubrication System

Crankcase Capacity - qt (L)

**ALTERNATOR SPECIFICATIONS** 

Oil Pump Type

Field Type

Insulation Class - Rotor

Insulation Class - Stator

Total Harmonic Distortion

Telephone Interference Factor (TIF)

Frequency Regulation (Steady State) ±0.5%

General

INDUSTRIAL DIESEL GENERATOR SET



ISO 3046, 7637, 8528, 9001

Stationary Emergency

3.3 (84)

Turbocharged

Cast Iron

Aluminum

Full-Flow

11.2 (10.6)

<5% (3-Phase Only)

Forged Steel



(ANSI

NEMA ICS10, MG1, 250, ICS6, AB1

## **Powering Ahead**

For over 60 years, Generac has provided innovative design and superior manufacturing.

Generac ensures superior quality by designing and manufacturing most of its generator components, including alternators, enclosures and base tanks, control systems and communications software.

Generac gensets utilize a wide variety of options, configurations and arrangements, allowing us to meet the standby power needs of practically every application.

our generators. We choose only engines that have already been proven in heavy-duty industrial applications under adverse

Generac is committed to ensuring our customers' service support continues after their generator purchase.

GENERAC INDUSTRIAL

Closed Recovery

18 (457)

ASTM

Pre-Lubed, Self Sealing

Ultra Low Sulfur Diesel Fuel #2

Distribution Injection Pump

See Battery Index 0161970SBY

Synchronous Brushless Single Sealed

Direct via Flexible Disc

Engine Drîven Gear

Mechanical

0.31 (7.9) ID

0.2 (4.8) ID

12 VDC

Standard

12 VDC

Negative

# SD030 | 2.2L | 30 kW

INDUSTRIAL DIESEL GENERATOR SET EPA Certified Stationary Emergency

#### GENERAC INDUSTRIAL

Rust-Proof Fasteners with Nylon Washers to

High Performance Sound-Absorbing Material

RhinoCoat<sup>™</sup> - Textured Polyester Powder Coat Paint

(Sound Attenuation Enclosures)

Upward Facing Discharge Hoods

Stainless Steel Lift Off Door Hinges

Stainless Steel Lockable Handles

**FUEL TANKS (If Selected)** 

Normal and Emergency Vents

· Check Valve In Supply and Return Lines

RhinoCoat<sup>™</sup> - Textured Polyester Powder Coat Paint

Factory Pressure Tested

Stainless Steel Hardware

Rupture Basin Alarm

(Radiator and Exhaust)

Gasketed Doors

UL 142/ULC S601

Double Wall

Sloped Top

Fuel Level

Sloped Bottom

**ENCLOSURE (If Selected)** 

#### **STANDARD FEATURES**

**ALTERNATOR SYSTEM** 

Class H Insulation Material

Rotor Dynamically Spin Balanced

Internal Genset Vibration Isolation

Separation of Circuits - High/Low Voltage

2 Year Limited Warranty (Standby Rated Units)

1 Year Limited Warranty (Prime Rated Units)

Silencer Mounted in the Discharge Hood

Full Load Capacity Alternator

Protective Thermal Switch

Standard Factory Testing

(Enclosed Unit Only)

Auto/Off/Manual Switch

Modbus<sup>®</sup> Protocol

Single Point Ground

All Phase AC Voltage

Engine Speed

Frequency

Battery Voltage

 16 Channel Remote Trending 0.2 msec High Speed Remote Trending

Sealed Boards

E-Stop (Red Mushroom-Type)

Predictive Maintenance Algorithm

Customizable Alarms, Warnings, and Events

· Password Parameter Adjustment Protection

**GENERATOR SET** 

Amortisseur Winding (3-Phase Only)

UL2200 GENprotect<sup>™</sup>

2/3 Pitch

Skewed Stator

Sealed Bearing

Brushless Excitation

#### **ENGINE SYSTEM**

- Oil Drain Extension
- Air Cleaner Level 1 Fan and Belt Guards (Open Set Only) Stainless Steel Flexible Exhaust Connection
- Factory Filled Oil and Coolant
- Radiator Duct Adapter (Open Set Only) Critical Silencer (Enclosed Unit Only) Engine Coolant Heater

#### FUEL SYSTEM

- Fuel Lockoff Solenoid Primary Fuel Filter
- COOLING SYSTEM
- Separation of Circuits Multiple Breakers · Closed Coolant Recovery System Wrapped Exhaust Piping UV/Ozone Resistant Hoses
- Factory-Installed Radiator Radiator Drain Extension 50/50 Ethylene Glycol Antifreeze

#### **ELECTRICAL SYSTEM**

- Battery Charging Alternator Battery Cables Battery Tray
- Rubber-Booted Engine Electrical Connections Solenoid Activated Starter Motor

- **Alarms and Warnings**  NFPA110 Level I and II (Programmable)
  - Coolant Temperature Coolant Level • Engine Overspeed
  - Alarms and Warnings Time and Date Stamped Snap Shots of Key Operation Parameters During

#### Oil Pressure

- Battery Voltage
- Alarms and Warnings Alarms and Warnings Spelled Out (No Alarm Codes)

# **ENGINE SYSTEM**

Fluid Containment Pan

CONTROL SYSTEM O Spare Inputs (x4) / Outputs (x4)

SD030 | 2.2L | 30 kW

EPA Certified Stationary Emergency

**CONFIGURABLE OPTIONS** 

O Critical Silencer (Open Set Only)

O Level 1 Fan and Belt Guards (Enclosed Units Only)

**ENGINE SYSTEM** 

Radiator Stone Guard

NPT Flexible Fuel Line

**ELECTRICAL SYSTEM** 

O 10A UL Listed Battery Charger

ALTERNATOR SYSTEM

Anti-Condensation Heater

O Permanent Magnet Excitation

FUEL SYSTEM

Battery Warmer

Alternator Upsizing

Tropical Coating

**GENERATOR SET** 

Extended Factory Testing

8 Position Load Center

O Pad Vibration Isolation

Oil Heater

INDUSTRIAL DIESEL GENERATOR SET

Coolant Heater Isolation Ball Valves

**ENGINEERED OPTIONS** 

Battery Disconnect Switch

**CIRCUIT BREAKER OPTIONS** 

O Main Line Circuit Breaker

Electronic Trip Breakers

**ENCLOSURE** 

2nd Main Line Circuit Breaker

O Weather Protected Enclosure

Level 2 Sound Attenuation with Motorized Dampers

Level 1 Sound Attenuation

Level 2 Sound Attenuation

Steel Enclosure

Aluminum Enclosure

for Availability)

Enclosure Heater

AC/DC Enclosure Lighting Kit

2 Year Extended Limited Warranty

5 Year Extended Limited Warranty

7 Year Extended Limited Warranty

10 Year Extended Limited Warranty

WARRANTY (Standby Gensets Only)

O Door Open Alarm Switch

Damper Alarm Contacts

5 Year Limited Warranty

**ALTERNATOR SYSTEM** 

3rd Breaker System

**GENERATOR SET** 

Special Testing

O Shunt Trip and Auxiliary Contact

- CONTROL SYSTEM O NFPA 110 Compliant 21-Light Remote Annunciator
- O Remote Relay Assembly (8 or 16) Oil Temperature Indication and Alarm
- Remote E-Stop (Break Glass-Type, Surface Mount) O Remote E-Stop (Red Mushroom-Type,

GENERAC | INDUSTRIAL

- Surface Mount) O Remote E-Stop (Red Mushroom-Type, Flush Mount)
- 100 dB Alarm Horn
- O Ground Fault Annunciation
- O 120V GFCI and 240V Outlets Remote Communication - Modem

#### 10A Engine Run Relay O Up to 200 MPH Wind Load Rating (Contact Factory

- FUEL TANKS (Size On Last Page) O 8 in (203.2 mm) Fill Extension O 13 in (330.2 mm) Fill Extension
- Overfill Protection Valve 5 Gallon Spill Box Return Hose
- 5 Gallon Spill Box Tank Risers

**FUEL TANKS** 

Special Fuel Tanks

Vent Extensions

GENERAC INDUSTRIAL

- lbs (kg)

Enclosure Only

Weight - Ibs (kg)

Enclosure Only

Steel Aluminum

- Fuel Level Switch and Alarm
- Fire Rated Stainless Steel Fuel Hose



1903 WRIGHT PLACE, SUITE 140

CARLSBAD, CA 92008

5005 EXECUTIVE PARKWAY

SAN RAMON, CA 94583

# AT&T/FIRSTNET ID: CCL02094

PSTC #: CANC-SROSA01 **GIFFEN AVENUE PROPERTY** 

**2715 GIFFEN AVE** SANTA ROSA, CA 95407 (SONOMA COUNTY)

> PROPOSED 80'-0" **MONOPINE TOWER**

# **SEAL:**

IT IS A VIOLATION OF LAW FOR ANY PERSON, UNLESS THEY ARE ACTING UNDER THE DIRECTION

#### SHEET TITLE:

314201.336187

\*EPA Certified Prime ratings are not available in the US or its Territories

Not all codes and standards apply to all configurations. Contact





SAE J1349



NEC700, 701, 702, 708

Cooling System

Water Pump Type

Fan Speed - RPM

Fuel System

Fuel Specifications

uel Inject Pump

uel Pump Type

Injector Type

Battery Size

Battery Voltage

Ground Polarity

Standard Excitation

oad Capacity - Standby.

Voltage Regulator Type

Number of Sensed Phases

Regulation Accuracy (Steady State)

Prototype Short Circuit Test

uel Filtering (Microns)

Fuel Supply Line - in (mm

Fuel Return Line - in (mm)

Engine Electrical System

Battery Charger Alternator

Fan Diameter - in (mm)

Cooling System Type

Generac searched globally to ensure the most reliable engines power

## CONTROL SYSTEM



Digital H Control Panel- Dual 4x20 Display

- **Program Functions** · Programmable Crank Limiter
- · 7-Day Programmable Exerciser Special Applications Programmable Logic Controller
- · Date/Time Fault History (Event Log) Isochronous Governor Control · Waterproof/Sealed Connectors

Audible Alarms and Shutdowns

Not in Auto (Flashing Light)

#### Alarm Information Automatically Annunciated **Full System Status Display**

- Power Output (kW) Power Factor · kW Hours, Total, and Last Run Real/Reactive/Apparent Power
- RS-232/485 Communications All Phase Sensing Digital Voltage Regulator 2-Wire Start Capability

SD030 | 2.2L | 30 kW

EPA Certified Stationary Emergency

INDUSTRIAL DIESEL GENERATOR SET

 All Phase Currents Oil Pressure Coolant Temperature Coolant Level

GENERAC | INDUSTRIAL

\* Fuel supply installation must accommodate fuel

0.5 (0.12)

consumption rates at 100% load.

#### **OPERATING DATA**

#### POWER RATINGS

		Standby
Single-Phase 120/240 VAC @1.0pf	30 kW	Amps: 125
Three-Phase 120/208 VAC @0.8pf	30 kW	Amps: 104
Three-Phase 120/240 VAC @0.8pf	30 kW	Amps: 90
Three-Phase 277/480 VAC @0.8pf	30 kW	Amps: 45
Three-Phase 346/600 VAC @0.8pf	30 kW	Amps: 36

Total Fuel Pump Flow (Combustion + Return) - gph (Lph)

16.6 (63)

Maximum Additional Radiator Backpressure

#### 120/240 VAC 1Ø 30% 277/480 VAC 3Ø 30% 208/240 VAC 3Ø 30% A0035044N21 20 K0035124Y21 61 K0035124Y21 46

	m (11)					
	Fuel Pump Lift- ft (m)				Percent Load	Standby
FUEL CONSUMPTION RATES*					Die	esel - gph (Lph)
FUEL CONCUMPTION DATES*						
	A0050044N21	31	K0050124Y21	98	K0050124Y21	75
	A0040044N21	24	K0040124Y21	76	K0040124Y21	58

## COOLING

		Standby
Coolant Flow	gpm (Lpm)	14.9 (56.2)
Coolant System Capacity	gal (L)	2.5 (9.5)
Heat Rejection to Coolant	BTU/hr (kW)	128,638 (136)
Inlet Air	cfm (m <sup>3</sup> /hr)	2,800 (4,757)
Maximum Operating Ambient Temperature	°F (°C)	122 (50)
Maximum Operating Ambient Temperature (Before Derate)	See Bulletin	No. 0199280SSD

in H<sub>2</sub>O (kPa)

Standby

#### COMBUSTION AIR REQUIREMENTS

Prime - See Bulletin 0187510SSB

		Flow at Rate	Power - cfm (m³/min) 88 (2.5)	
ENGINE			EXHAUST	
		Standby		Standby
Rated Engine Speed	RPM	1,800	Exhaust Flow (Rated Output) cfm (m³/min)	296.6 (8.4)
Horsepower at Rated kW**	hp	49	Max. Allowable Backpressure (Post Turbocharger) inHg (kPa)	1.5 (5.1)
Piston Speed	ft/min (m/min)	1,181 (360)	Exhaust Temperature (Rated Output) °F (°C)	892 (478)


#### \*\* Refer to "Emissions Data Sheet" for maximum bHP for EPA and SCAQMD permitting purposes.


psi (kPa) 159 (1,096)


Deration - Operational characteristics consider maximum ambient conditions. Derate factors may apply under atypical site conditions. Please contact a Generac Power Systems Industrial Dealer for additional details. All performance ratings in accordance with ISO3046, BS5514, ISO8528, and DIN6271 standards. Standby - See Bulletin 0187500SSB

SD030 | 2.2L | 30 kW INDUSTRIAL DIESEL GENERATOR SET EPA Certified Stationary Emergency

#### **DIMENSIONS AND WEIGHTS\***

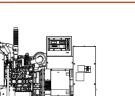


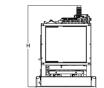


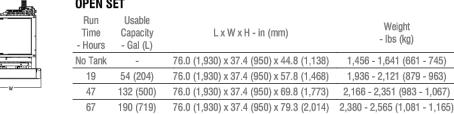

**WEATHER PROTECTED ENCLOSURE** 



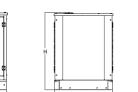

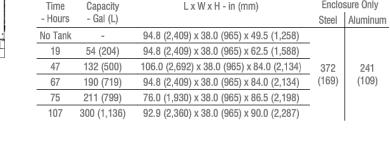

19 54 (204) 112.5 (2,857) x 38.0 (965) x 62.5 (1,588)

75 211 (799) 112.5 (2,857) x 38.0 (965) x 86.5 (2,198)

107 300 (1,136) 112.5 (2,857) x 38.0 (965) x 90.0 (2,287)

LEVEL 1 SOUND ATTENUATED ENCLOSURE

Capacity

- Gal (L)

Hours

75 211 (799) 76.0 (1,930) x 37.4 (950) x 81.8 (2,078) 2,375 - 2,560 (1,078 - 1,162)


107 300 (1,136) 92.9 (2,360) x 37.4 (950) x 85.3 (2,167) 2,438 - 2,623 (1,106 - 1,190)

L x W x H - in (mm)


LxWxH-in (mm)


112.5 (2,857) x 38.0 (965) x 49.5 (1,258)

47 132 (500) 112.5 (2,857) x 38.0 (965) x 74.5 (1,893) 505 338 67 190 (719) 112.5 (2,857) x 38.0 (965) x 84.0 (2,134) (229) (153)

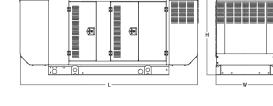

Generac Power Systems, Inc. | P.O. Box 8 | Waukesha, WI 53189

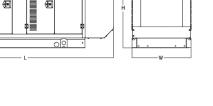

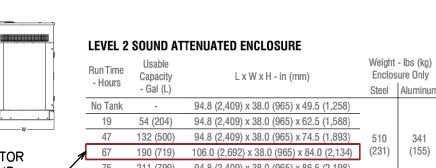


LEVEL 2 ACOUSTIC ENCLOSURE — \* All measurements are approximate and for estimation purposes only. Specification characteristics may change without notice. Please contact a Generac Power Systems Industrial Dealer for detailed installation drawings.

P: (262) 544-4811 ©2020 Generac Power Systems, Inc. All rights reserved. All specifications are subject to change without notice.

PROPOSED 30 KW GENERATOR 211 (799) 94.8 (2,409) x 38.0 (965) x 86.5 (2,198) WITH 190 GALLON TANK AND 107 300 (1,136) 94.8 (2,409) x 38.0 (965) x 90.0 (2,287)

PROPOSED GENERATOR DETAILS SCALE: N.T.S.

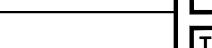

Part No. 10000024842


 19 in (482.6 mm) Fill Extension 12' Vent System

www.tepgroup.net O UL2085 Tank Stainless Steel Tanks

**NORTHPOINT** 

			ISSU	ED FOR:	
ı	REV	DATE	DRWN	DESCRIPTION	Q,
	G	02-01-23	550	ZONING	HM
	Н	03-28-23	550	ZONING	H№
	1	04-21-23	RCH	ZONING	H№
	J	09-29-23	CAM	ZONING	HM
	K	01-04-24	SKK	ZONING	HM



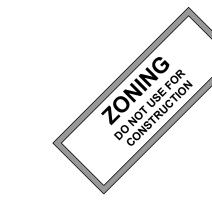

OF A LICENSED PROFESSIONAL ENGINEER, TO ALTER THIS DOCUMENT.

**GENERATOR DETAILS** 

SHEET NUMBER: REVISION:

TEP #:





Clientowiew product webspace



# **Battery** Range Summary

The PowerSafe® SBS® Front Terminal battery further extends the technical leadership of PowerSafe SBS battery product line: not only do PowerSafe SBS Front Terminal monoblocs retain the benefits typically associated with Thin Plate Pure Lead (TPPL) Technology such as long life, high energy density, superior shelf life, etc., they also deliver exceptional cyclic performance in both float and fast charge applications, even in the hottest and harshest operating environments.

Where conventional Valve Regulated Lead Acid (VRLA)/Absorbed Glass Mat (AGM) batteries struggle to cope with harsh conditions and frequent power outages, cutting edge (TPPL) technology makes PowerSafe 12V batteries the perfect solution for the challenging operating conditions of today's telecommunication networks.

PowerSafe SBS batteries are designed to high quality standards and a unique manufacturing methods means superior energy and power, high performance and proven reliability, there is no substitute to PowerSafe SBS Front Terminal batteries.

#### **Features and Benefits**

- Capacity range 31-190Ah
- 12V monobloc configurations
- Multiple string configurations available
- Two year shelf life
- SR4228 compliant
- Proven long service life
- High energy density and cycling capability

#### Construction

- Robust positive plates are designed to prolong service life and enhance corrosion resistance
- Separators are low resistance microporous (AGM). The electrolyte is absorbed within the AGM, preventing acid spills in case of accidental damage
- Container and cover in flame retardant UL94-V0 material, highly resistant to shock and vibration
- Terminals are stainless steel front access with top access copper alloy insert. Top and front access terminations provide maximum conductivity
- Self-regulating one way pressure relief valves prevents ingress of atmospheric oxygen

#### **Installation and Operation**

- Space efficient footprint
- VRLA design, reduces maintenance requirements
- Lifting handles for easy handling • Greater than 10 year life expectancy in float service at
- 77°F (25°C) • Increased active material surface area yields great
- cycling capability • Operating temperature: -40°F (-40°C) to 122°F (50°C) Recommended temperature: 68°F (20°C) to 86°F (30°C)

#### **Standards**

- Meets criteria for "non-spillable" batteries
- Complies with Telcordia® SR-4228, Network Equipment Building System (NEBS™) Criteria Levels
- The management systems governing the manufacture of this product are ISO 9001:2008 and ISO 14001:2004





1903 WRIGHT PLACE, SUITE 140

CARLSBAD, CA 92008

5005 EXECUTIVE PARKWAY

SAN RAMON, CA 94583

AT&T

PSTC #: CANC-SROSA01 **GIFFEN AVENUE PROPERTY** 

**2715 GIFFEN AVE** SANTA ROSA, CA 95407 (SONOMA COUNTY)

> PROPOSED 80'-0" MONOPINE TOWER

ı								
l		ISSUED FOR:						
	REV	DATE	DRWN	DESCRIPTION	QA			
	G	02-01-23	550	ZONING	НММ			
	Н	03-28-23	550	ZONING	НММ			
	1	04-21-23	RCH	ZONING	НММ			
	J	09-29-23	CAM	ZONING	НММ			
ı	K	01-04-24	SKK	ZONING	НММ			

SEAL:



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SHEET TITLE:

**BATTERY DETAILS** 

SHEET NUMBER: **C-6** 


TEP #:

**REVISION:** 


314201.336187


# **General Specifications**


	Nominal Capacity (Ah)		Nominal Dimensions						Weight - Volumes		
Cell Type	10 hr rate to 1.80Vpc @20°C	8 hr rate to 1.75Vpc @77°F	Ler in	ngth mm	Wi in	dth mm	He in	ight mm	Unpa lbs	cked kg	
SBS B8F	31	31	11.9	303	3.8	97	6.3	159	22.7	10.3	
SBS B10F	38	38	11.9	303	3.8	97	7.2	184	28.2	12.8	
SBS B14F	62	62	11.9	303	3.8	97	10.4	264	42.0	19.1	
SBS C11F	92	91	16.4	417	4.1	105	10.1	256	61.6	28.0	
SBS 100F	100	100	15.6	395	4.3	108	11.3	287	71.9	32.6	
SBS 112F	112	112	22.1	561	4.9	125	9.0	228	90.4	41.1	
SBS 145F	145	145	17.9	455	6.8	173	9.4	238	105.0	47.7	
SBS 165F	165	165	17.9	455	6.8	173	10.8	273	117.4	53.3	
SBS 170F	170	170	22.1	561	4.9	125	11.1	283	115.7	52.5	
SBS 190F	190	190	22.1	561	4.9	125	12.4	316	132.3	60.0	

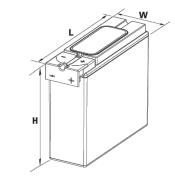

SBS B8F-B14F

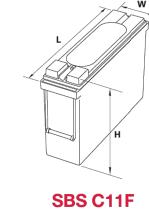

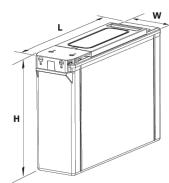

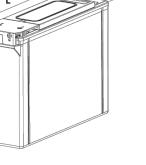



SBS 100F-112F

SBS 145F - 190F

MANUFACTURER:	ALPINE POWER SYSTEMS
MODEL:	POWERSAFE SBS 190F
BATTERY QTY:	8 UNITS
TOTAL BATTERY KWH:	18.24
TOTAL BATTERY WEIGHT (KG/LBS):	480 / 1058.4
TOTAL ELECTROLYTE VOLUME (GAL):	18.72
TOTAL ELECTROLYTE WEIGHT (KG/LBS):	129.5 / 285.4





Publication No: US-SBSF-RS-004 - January 2014

				AC POV	VER PANE	EL A (PRO	POSED)				
			13	20/240 VC	LTS, 1-PF	HASE, 3-W	IRE, 200	Α			
	MAIN BREAKER RATING (A) :							SYSTEM VOLTAGE (V):		E (V) :	240
DESCRIPTION	VA	c/nc	BKR	POSN	L1	L2	POSN	BKR	c/nc	VA	DESCRIPTION
RECTIFIERS #1 & 2	1410	С	30/2	1	2820		2	30/2	С	1410	RECTIFIERS #3 & 4
RECTIFIERS #1 & Z	1410	С		3		2820	4		С	1410	RECTIFIERS #3 & 4
RECTIFIERS #5 & 6	1410	С	30/2	5	2820		6	30/2	С	1410	RECTIFIERS #7 & 8
RECTIFIERS #3 & 0	1410	С		7		2820	8		С	1410	
RECTIFIERS #9 & 10	1410	С	30/2	9	2820		10	30/2	С	1410	RECTIFIERS #11 & 12
RECTIFIERS #5 & 10	1410	С	30/2	11		2820	12		С	1410	
SPARE / OFF	0	nc	30/2	13	0		14	30/2	nc	0	SPARE / OFF
SPARL / OFF	0	nc	3012	15		0	16		nc	0	
SPARE / OFF	0	nc	30/2	17	0		18	30/2	nc	0	SPARE / OFF
SPARE / OFF	0	nc		19		0	20		nc	0	
SPARE / OFF	0	nc	30/2	21	0		22	30/2	nc	0	SPARE / OFF
SPARL / OFF	0	nc	30/2	23		0	24		nc	0	
BLANK				25	1000		26	20/1	nc	1000	*GEN BLOCK HEATER
BLANK				27		650	28	20/1	nc	650	*GEN BATT CHARGER
PTLC RECEPTACLES	720	nc	20/1	29	900		30	20/1	nc	180	WUC GFCI
PHASE TOTALS (VA):					10360	9110					
PHASE TOTALS (A):					86	76					
CURRENT PER PHASE W/ 125% Continuous Loads(A):					104	94 Amperes/phase cannot exceed main breaker rating					
PANEL TOTAL (VA):				194	170	Legend: c = continuous, nc = non-continuous					
PANEL TOTAL W/ 125% Continuous Loads (VA):					23700						
TOTAL LOAD FOR GEN OPERATION:					17820 *Generator loads are not in operation while generator is running						

PROPOSED LOADING = 23.7 KVA







#### AT&T/FIRSTNET ID: CCL02094 NORTHPOINT

PSTC #: CANC-SROSA01 **GIFFEN AVENUE PROPERTY** 

**2715 GIFFEN AVE** SANTA ROSA, CA 95407 (SONOMA COUNTY)

PROPOSED 80'-0" **MONOPINE TOWER** 

	ISSUED FOR:									
REV	DATE	DRWN	DESCRIPTION	QA						
G	02-01-23	550	ZONING	НММ						
Н	03-28-23	550	ZONING	НММ						
1	04-21-23	RCH	ZONING	НММ						
J	09-29-23	CAM	ZONING	НММ						
K	01-04-24	SKK	ZONING	НММ						

SEAL:



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SHEET TITLE:

AC PANEL SCHEDULE


SHEET NUMBER: REVISION:

314201.336187

AC PANEL SCHEDULE SCALE: N.T.S.

#### NOTES:

- CONTRACTOR SHALL VERIFY AVAILABLE FAULT CURRENT WITH POWER COMPANY AND ENSURE ALL ELECTRICAL EQUIPMENT IS SUITABLE FOR AVAILABLE FAULT CURRENT.
- 2. CONTRACTOR SHALL COORDINATE UTILITY SERVICES WITH LOCAL UTILITY COMPANIES. VERIFY ALL REQUIREMENTS WITH UTILITY COMPANY STANDARDS.
- ONE-LINE DIAGRAM IS FOR SCHEMATIC PURPOSES ONLY AND IS NOT INDICATIVE OF THE ACTUAL EQUIPMENT LAYOUT.
- 4. CONTRACTOR SHALL LABEL METER SOCKET WITH SERVICE OWNER NAMEPLATE WITH ½" HEIGHT MINIMUM LETTERS.
- 5. CONTRACTOR TO DETERMINE AVAILABLE FAULT CURRENT BEFORE ENERGIZING EQUIPMENT. THE AMOUNT OF AVAILABLE FAULT CURRENT SHALL BE MARKED ON THE SERVICE EQUIPMENT PER NEC 110.24.
- 6. CONTRACTOR WILL NOTIFY UTILITY COMPANY OF CHANGES IN ELECTRICAL LOAD.

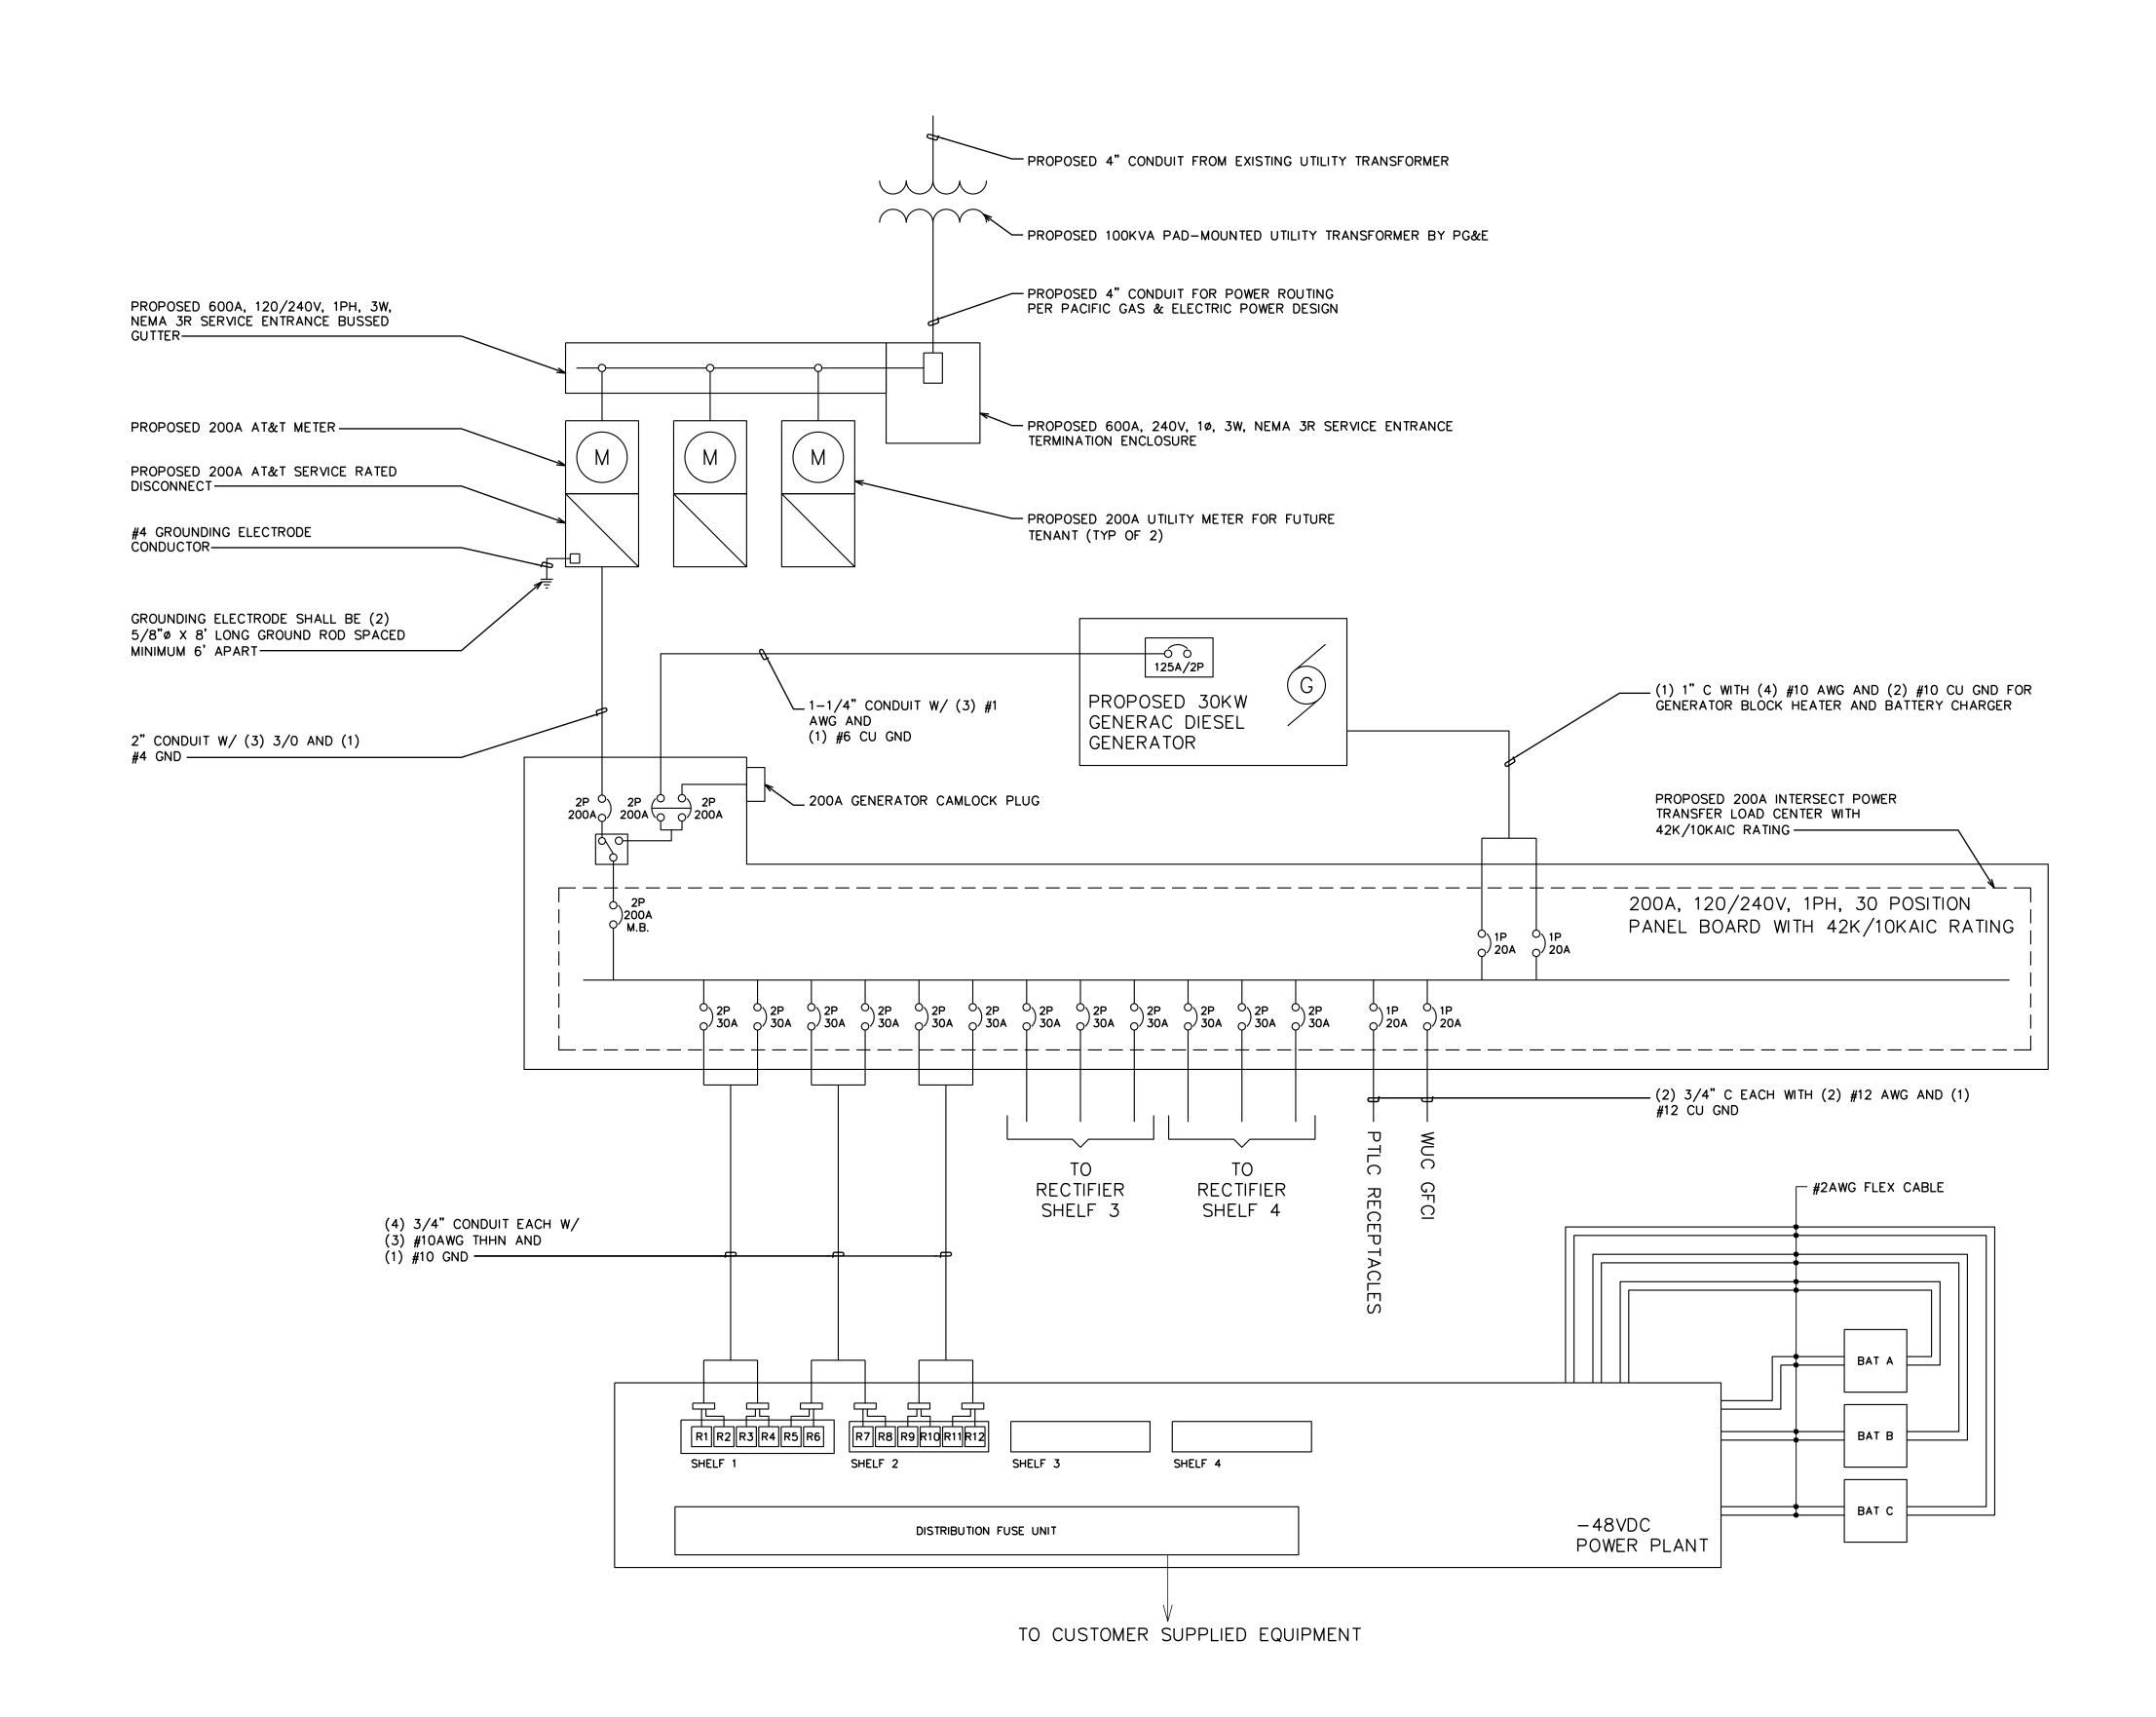







AT&T/FIRSTNET ID: CCL02094 NORTHPOINT

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SHEET TITLE:

ONE-LINE DIAGRAM

SHEET NUMBER:

REVISION:

**TEP #:** 314201.336187

1 ONE-LINE DIAGRAM
SCALE: N.T.S.