wireless...

DISH WIRELESS L.L.C. SITE ID:

SFSFO00115A

DISH WIRELESS L.L.C. SITE ADDRESS:

4900 SONOMA HWY. SANTA ROSA, CA 95409

CALIFORNIA - CODE COMPLIANCE

ALL WORK SHALL BE PERFORMED AND MATERIALS INSTALLED IN ACCORDANCE WITH THE CURRENT EDITIONS OF THE FOLLOWING CODES AS ADOPTED BY THE LOCAL GOVERNING AUTHORITIES. NOTHING IN THESE PLANS IS TO BE CONSTRUED TO PERMIT WORK NOT CONFORMING TO THESE CODES:

CODE TYPE BUILDING MECHANICAL 2022 CALIFORNIA BUILDING CODE (CBC)/2021 IBC 2022 CALIFORNIA MECHANICAL CODE (CMC)/2021 UMC 2022 CALIFORNIA ELECTRICAL CODE (CEC)/2020 NEC 2022 CALIFORNIA FIRE CODE (CFC)/2021 IFC

	SHEET INDEX			
SHEET NO.	SHEET TITLE			
T-1	TITLE SHEET			
LS1	SITE SURVEY			
A-1	OVERALL AND ENLARGED SITE PLAN			
A-2.1	ELEVATION			
A-2.2	ANTENNA LAYOUT AND SCHEDULE			
A-3	EQUIPMENT PAD AND H-FRAME DETAILS			
A-4	EQUIPMENT DETAILS			
A-5	EQUIPMENT DETAILS			
A-6	EQUIPMENT DETAILS			
A-7	EQUIPMENT DETAILS			
E-1	ELECTRICAL/FIBER ROUTE PLAN AND NOTES			
E-2	ELECTRICAL DETAILS			
E-3	ELECTRICAL ONE-LINE, FAULT CALCS, & PANEL SCHEDULE			
G-1	GROUNDING PLANS AND NOTES			
G-2	GROUNDING DETAILS			
G-3	GROUNDING DETAILS			
RF-1	RF CABLE COLOR CODE			
GN-1	LEGEND AND ABBREVIATIONS			
GN-2	RF SIGNAGE			
GN-3	GENERAL NOTES			
GN-4	GENERAL NOTES			
GN-5	GENERAL NOTES			

RECEIVED

By Christian Candelaria at 8:29 am, Aug 17, 2023

SCOPE OF WORK

THIS IS NOT AN ALL INCLUSIVE LIST. CONTRACTOR SHALL UTILIZE SPECIFIED EQUIPMENT PART OR ENGINEER APPROVED EQUIPMENT. CONTRACTOR SHALL VERIFY ALL NEEDED EQUIPMENT TO PROVIDE A FUNCTIONAL SITE. THE PROJECT GENERALLY CONSISTS OF THE FOLLOWING:

- TOWER SCOPE OF WORK:

 INSTALL (3) PROPOSED PANEL ANTENNAS (1 PER SECTOR)

 INSTALL (3) PROPOSED ANTENNA T-ARM MOUNT
- INSTALL PROPOSED JUMPERS
- INSTALL (6) PROPOSED RRHs (2 PER SECTOR)
 INSTALL (1) PROPOSED OVER VOLTAGE PROTECTION DEVICE (OVP)
 INSTALL (1) PROPOSED HYBRID CABLE (LENGTH: 137'-0")

- GROUND SCOPE OF WORK:

 REMOVE EXISTING FENCE SECTION

 INSTALL PROPOSED FENCE AND GATE EXPANSION
- INSTALL PROPOSED ICE BRIDGE
- INSTALL PROPOSED FOLIPMENT CARINET
- PROPOSED POWER CONDUIT INSTALL (1) INSTALL
- PROPOSED TELCO CONDUIT PROPOSED TELCO-FIBER BOX INSTALL
- INSTALL (
-) PROPOSED GFS UNIT) PROPOSED FIBER NID (IF REQUIRED)) PROPOSED METER MAINS (1 DISH, 1 FUTURE SERVICE)
- INSTALL (1) PROPOSED PULL SECTION AND SERVICE GUTTER ON PROPOSED UTILITY FRAME INSTALL (2) POLARIUM SLB49-200-228-1U BATTERIES IN PROPOSED EQUIPMENT CABINET

SITE PHOTO





UNDERGROUND SERVICE ALERT **UTILITY NOTIFICATION CENTER OF CALIFORNIA** (800) 642-2444 WWW.CALIFORNIA811.ORG

CALL 2-14 WORKING DAYS UTILITY NOTIFICATION PRIOR TO CONSTRUCTION



GENERAL NOTES

THE FACILITY IS UNMANNED AND NOT FOR HUMAN HABITATION. A TECHNICIAN WILL VISIT THE SITE AS REQUIRED FOR ROUTINE MAINTENANCE. THE PROJECT WILL NOT RESULT IN ANY SIGNIFICANT DISTURBANCE OR EFFECT ON DRAINAGE. NO SANITARY SEWER SERVICE, POTABLE WATER, OR TRASH DISPOSAL IS REQUIRED AND NO COMMERCIAL SIGNAGE IS PROPOSED.

11"x17" PLOT WILL BE HALF SCALE UNLESS OTHERWISE NOTED

CONTRACTOR SHALL VERIFY ALL PLANS, EXISTING DIMENSIONS, AND CONDITIONS ON THE JOB SITE, AND SHALL IMMEDIATELY NOTIFY THE ENGINEER IN WRITING OF ANY DISCREPANCIES BEFORE PROCEEDING WITH THE WORK.

DISH WIRELESS L.L.C. PROPERTY OWNER: GRANT W. PATRICK, DVM (1) ADDRESS: 4900 SONOMA HWY LITTLETON, CO 80120 SANTA ROSA, CA 95409 (303) 706-5008

TOWER TYPE: MONOPINE

SITE INFORMATION

38° 27° 47.3" N

38.463139° N

TOWER CO SITE ID: 815755

TOWER APP NUMBER: 562062

COUNTY: SONOMA

LATITUDE (NAD 83):

LONGITUDE (NAD 83): 122° 39' 56" W 122.665556° W

CITY OF SANTA ROSA, CA

ZONING DISTRICT: COMMERCIAL

PARCEL NUMBER: 032-300-008

OCCUPANCY GROUP:

CONSTRUCTION TYPE:

TELEPHONE COMPANY: TBD

POWER COMPANY:

5701 SOUTH SANTA FE DRIVE

PROJECT DIRECTORY

TOWER OWNER: CROWN CASTLE USA, INC. 2000 CORPORATE DRIVE

CANONSBURG, PA 15317 (877) 486-9377

SITE DESIGNER: FULLERTON ENGINEERING 1100 E WOODFIELD, STE 500

SCHAUMBURG, IL 60173 (847) 908-8400

SITE ACQUISITION:

JEFF MELVIN JEFF.MELVIN@CROWNCASTLE.COM

CONSTRUCTION MANAGER:

TIMOTHY BROESSEL TIMOTHY.BROESSEL@DISH.COM

RF ENGINEER:

CAROLINA MORALES


CAROLINA.MORALES@DISH.COM

DIRECTIONS

DIRECTIONS FROM CHARLES M. SCHULZ-SONOMA COUNTY AIRPORT:

HEAD SOUTHEAST ON AIRPORT BLVD, TURN RIGHT TO STAY ON AIRPORT BLVD, TURN RIGHT TO MERGE ONTO US-101 S, MERGE ONTO US-101 S, USE THE 2ND FROM THE RIGHT LANE TO TAKE EXIT 490 FOR COLLEGE AVE, USE THE LEFT 2 LANES TO TURN LEFT ONTO COLLEGE AVE, USE ANY LANE TO TURN LEFT ONTO 4TH ST, TURN RIGHT, DESTINATION WILL BE ON THE RIGHT.

VICINITY MAP

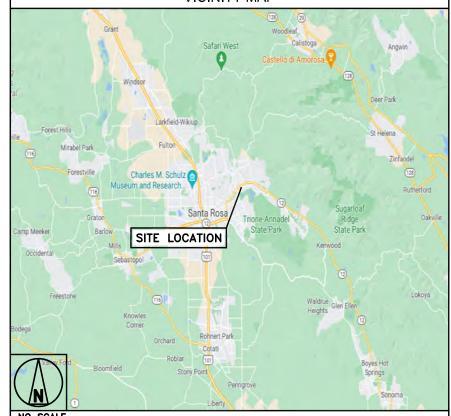

5701 SOUTH SANTA FE DRIVE LITTLETON, CO 80120

JULLERTON

I 100 E. WOODFIELD ROAD, SUITE 500 SCHAUMBURG, ILLINOIS 60173 TEL: 847-908-8400 www.FullertonEngineering.com



IT IS A VIOLATION OF LAW FOR ANY PERSON, UNLESS THEY ARE ACTING UNDER THE DIRECTION OF A LICENSED PROFESSIONAL ENGINEER, TO ALTER THIS DOCUMENT.

DRAWN BY:	CHECKED BY:	APPROVED BY
JES	CJ	CJ

CONSTRUCTION **DOCUMENTS**

RFDS REV #:

ı	SUBMITTALS					
ı	REV DATE		DESCRIPTION			
	3	11/22/2022	LEASE AREA UPDATE			
ı	4	12/12/2022	ELEVATION UPDATE			
ı	5	02/02/2023	JDX REVISION			
П	6	02/10/2023	JDX REVISION			
ı	7	04/19/2023	ADDED SURVEY			
ı	8	05/24/2023	UTILITY REVISION			
	9 07/28/2023		UTILITY REVISION			
		A&E F	PROJECT NUMBER			

2021.0025.815755

DISH WIRELESS L.L.C. PROJECT INFORMATION SFSF000115A CA-CCI-T-815755 4900 SONOMA HWY. SANTA ROSA, CA 95409


> SHEET TITLE TITLE SHEET

SHEET NUMBER

T-1

AS-BUILT SURVEY 815755


LEGEND

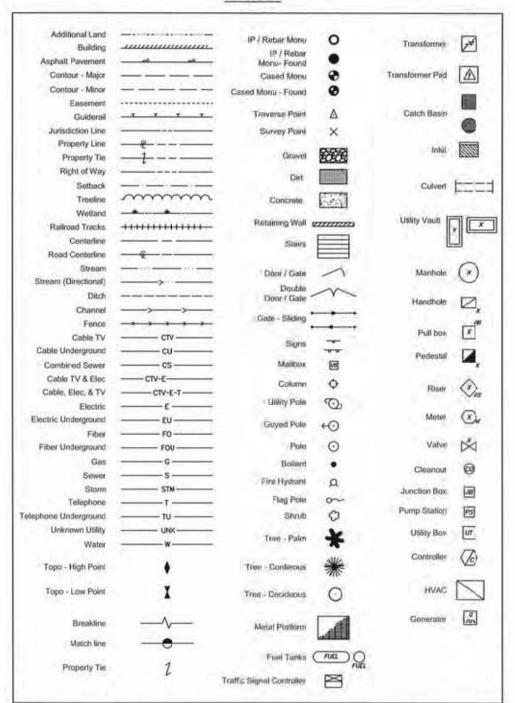

RINCON VALLEY

4900 SONOMA HWY SANTA ROSA, CA 95409 SONOMA COUNTY

VICINITY MAP

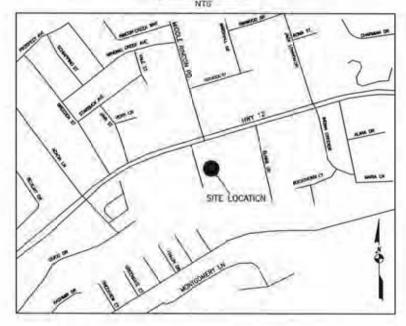

SHEET INDEX		
SHEET NAME	TITLE	
V-01	COVER SHEET	
V-02	PROPERTY OVERVIEW	
V-03	SITE BOUNDARY	
V-04	SITE DETAIL	
V-05	LEGAL DESCRIPTIONS	

SURVEY PROCEDURES & EQUIPMENT

The Accuracy Of This Survey Meets Or Exceeds The Minimum Standards As Required By [CA Requirements For Boundary Surveys]

SPECTRA PRECISION SP80 W SMARTNET VIRTUAL NETWORK TUPCON TOTAL STATION GPT-3005

AREA SUMMARY						
AREA SQ FT ACRE						
PARENT PARCE	#24,067	±0.553				
TOWER LEASE AREA	11,463	±0.033				
ADDITIONAL LEASE AREA	±124	±0.002				
ACCESS & UTILITY EASEMENT	±2,744	±0.063				
UTILITY EASEMENT	±425	±0.009				

COORDINATES			
LABEL	LAT, LONG		
FD. MON.	38" 27" 42.01", 122" 39" 54.79"		
FD. MON.	38° 27" 4 48", 122° 39° 54.03°		

For internal use

SURVEY PERFORMED FOR



Canonsburg, PA 15317

SURVEY COORDINATED BY:

GEOLINE SURVEYING, INC. 13430 NW 10th Terrace, Suite A, Alachua, FL 32615 Tele: (386) 418-0500 | Fax. (386) 462-9986

SURVEY PERFORMED BY:

SMITHCO SURVEYING ENGINEERING 2005 AIRPORT DRIVE BAKERSFIELD, CA 93308 Telo. (661) 393-1217 | Fax: (661) 393-1218

RAWN BY E.I. CIN DY DA

SURVEYOR'S CERTIFICATION:

I hernby certify to Crown Castle GT Company LLC, Crown Carulle USA Inc., including its parents, subsidiaries and affiliate entities, and Westcor Land Title Insurance Company.

SURVIVOR NAME D'ARTAGNAN ALEA



LEASE AREA ZONING:

LEASE AREA FLOOD NOTE:

THE FEDERAL EMERGENCY MANAGEMENT AGENCY FLOOD RATE MAP FOR COMMUNITY NO 06/381, PANEL NO 07/38E DATED DECEMBER 2, 2008 SHOWS THAT THE LOCATION OF THIS SHE FALLS WITHIN ZONE "I", AREAS DETERMINED TO BE OUTSIDE THE U.2% ANNUAL CHANCE FLOODPLAIN

ALI REARINGS SHOWN HEREDN ARE CRID BEARINGS BASED IN THE CALIFORNIA COORDINATE SYSTEM OF 1983 ZONE 2

- SURVEY PERFORMED UN 15/10/21.
 HORIZONITAL DATA PROJECTED IN CALIFORNIA COORDINATE SYSTEM OF 1983 (CCS83) ZONE 2 (INTERNATIONAL ASSOCIATION OF DIL & DAS PRODUCER'S EPSC CODE 1326 ELEVATIONS SHOWN HEREON ARE BASED ON THE NORTH AMERICALI VERITCAL DATUM OF 1988
- INAUGRO,
 THE UNITARISHOUND VITILITIES (IT ANTI THAT APPEAR ON THIS MAR HAVE BEEN LOCATED AND MARKED ON THE SURFACE OF AN INCOPENDON'T PRIVATE UNDERGROUND LOCADING SERVICE THESE MARKINGS HAVE BEEN SURFACED AND ENGINE HEREON,
 ALL WORLD TOWN FOUNDENT AND IMPROVEMENTS ARE OF AREA NOT ALL SYMBOLS ARE DEPOSED AREA.

 NOT ALL SYMBOLS ARE DEPOSED TO SCALE.

 THAT SURFACE ODES NOT REPRESENT & BOUNDARY SURFACE OF THE PRAREIT FRANCE.
- SURVEY OF THE PARENT PARCEL

KEA	DAIL		DESCRIPTION	DRWN	
00	05/T	3/21	PRELIMINARY	EJ	
09	05/0	5/22	REV. A/D	LA	
10	00/15	3/22	HEV: N/U	(CJ	
11	02/0	3/25	REVISIONS	CJ	
SITE	INFO	RMAT	ION:		
Nan	Name		RINCON VALLEY		
BUN 815755					
The second of th			OO SONOMA HWY NTA ROSA, CA 95409		

SITE LOCATED IN:

RANCHO CABEZA DE SANTAROSA


County SONOMA COUNTY


AS-BUILT SURVEY

SHEET TITLE: COVER SHEET

SHT NAME: V-DI SHT NO: 1

OF 5

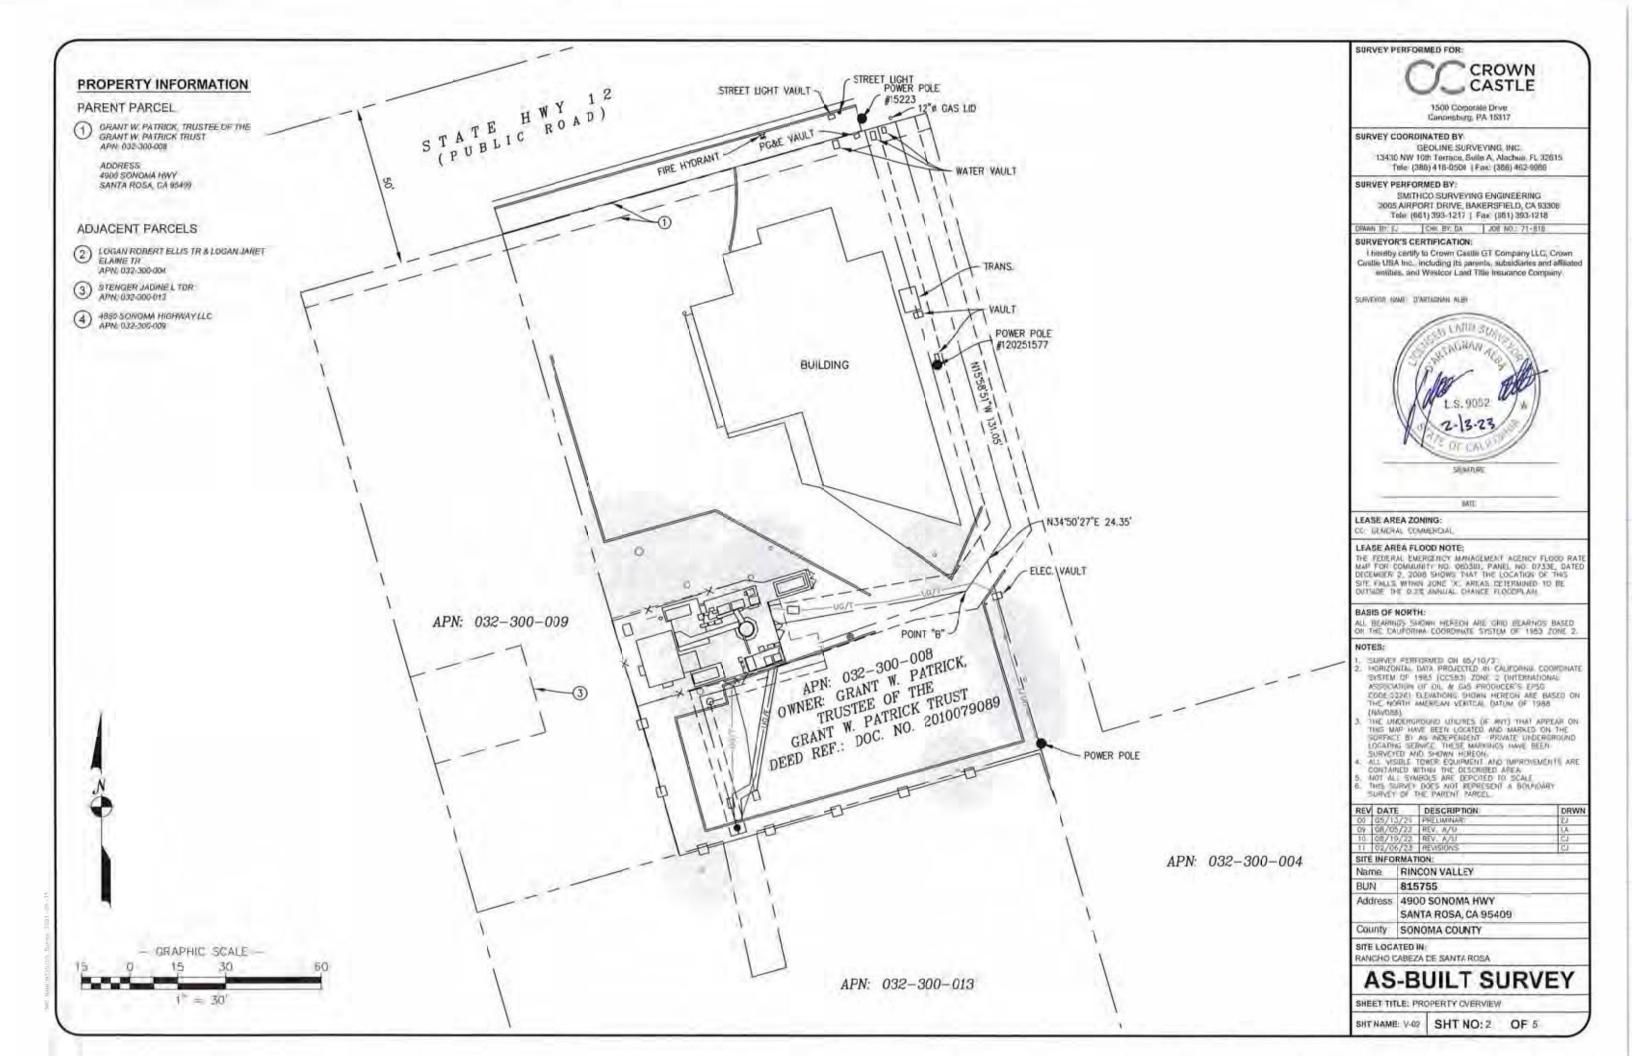

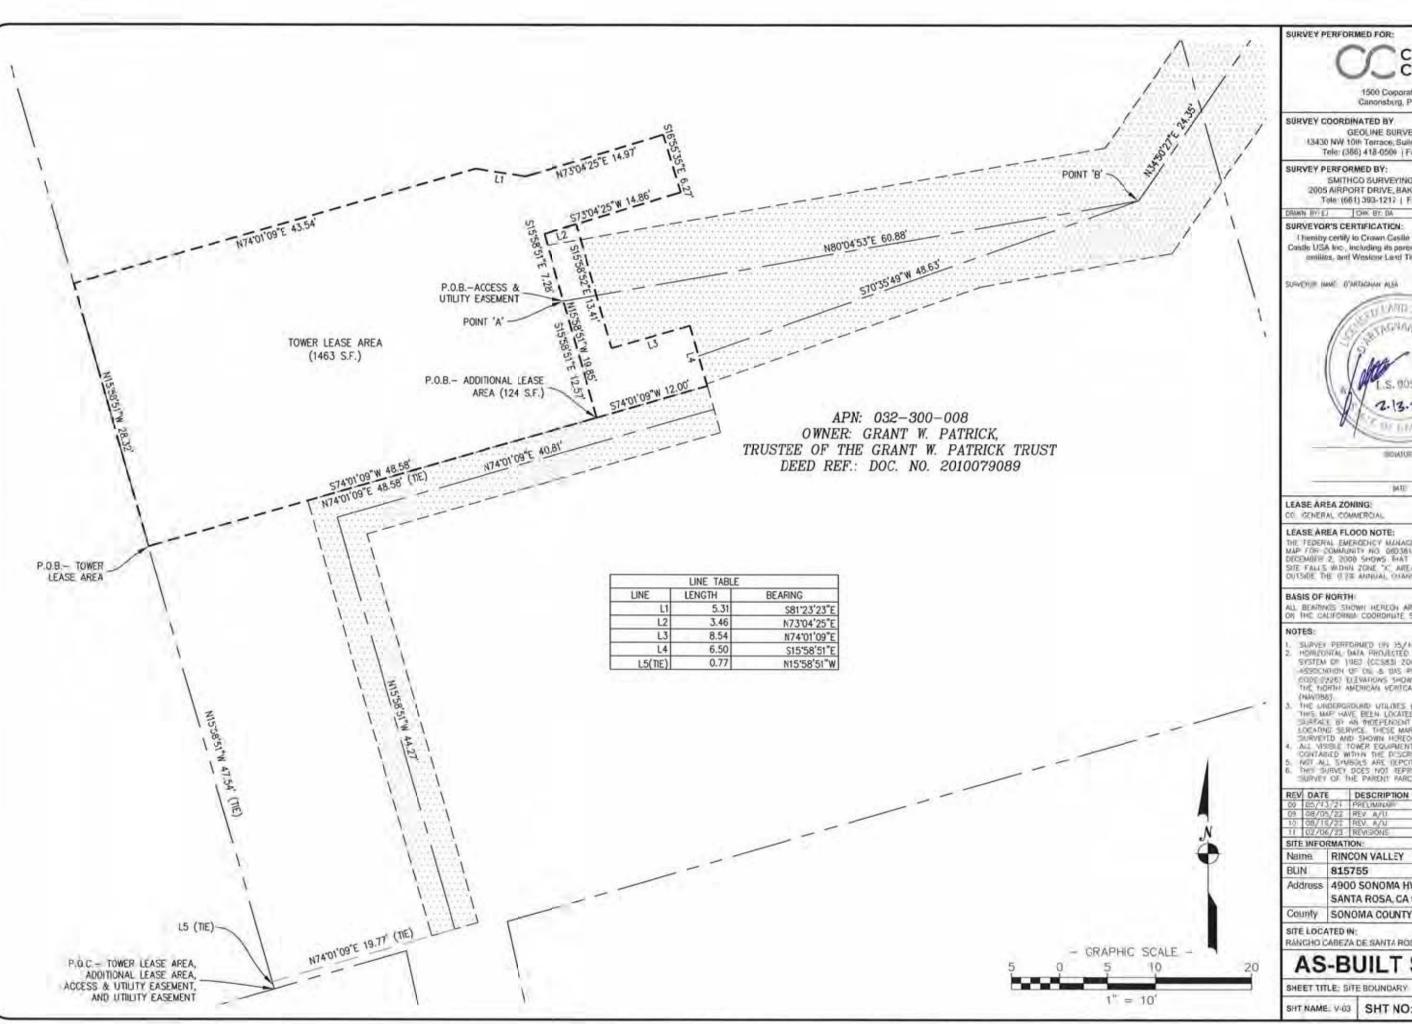

SURVEY PERFORMED FOR:



1500 Corporate Drive Canonsburg, PA 15317

SURVEY COORDINATED BY

GEOLINE SURVEYING, INC. 13430 NW 10th Terrace, Suite A, Alachus, FL 32615. Tele: (306) 418-0500 | Fax: (306) 482-9986

SURVEY PERFORMED BY:

SMITHGO SURVEYING ENGINEERING 2005 AIRPORT DRIVE, BAKERSFIELD, CA 93308 Tole (661) 393-1217 | Fax: (561) 393-1218

SAWN BY E. DA SS NO. 71-610

SURVEYOR'S CERTIFICATION:

I heniby certify to Crown Castle GT Company LLC. Crown Coade USA Inc., including its parents, subsidiaries and affiliate amilies, and Westerr Land Title Insurance Company.

SURVEYOR HAM! D'ARTAGALAY ALEA



LEASE AREA ZONING:

CO GENERAL COMMERCIAL

LEASE AREA FLOOD NOTE:

THE FEDERAL EMERGENCY MANAGEMENT AGENCY FLOOD RATE MAP FOR COMMUNITY NO 000381, PANEL NO 0733E, DATED DECEMBER 2, 2000 SHOWS THAT THE LOCATION OF THIS SITE FALLS WOUND ZONE X'S ATTERAS DETERMINED TO THE OUTSIDE THE 072E ANNUAL CHANCE 1,000P, AN

ALL BEATHNOS SHOWN HEREON ARE DRID BEARINGS BASED ON THE CALIFORNIA COORDINATE SYSTEM OF 1983 ZONE 2.

NOTES:

- SURVEY PERFORMED LTV 35/40/21
 HOMZONTAL DATA PROJECTED IN CALIFORNIA COORDINATE
 SYSTEM OF THE I (C.S.E.S) ZONE 2 DITERNATIONAL
 ASSOCIATION OF CIT. S. DIS PRODUCER'S EPSG
 GOOF 17/6, DEZVAROAS SHOWN HEREON APE BASED ON
 THE RIGHTH AMERICAN MERICAL DATUM OF 1986 CHANDBET
- (MAVIDE).

 THE UNDERGROUND UTILITIES (IF ANY) THAT APPEAR ON THE DARKET BY AN INDEPENDENT PRIVATE UNDERGROUND LOCATION SERVICE DIESE MARKINGS MAYE BEEN DURNING SERVICE DIESE MARKINGS MAYE BEEN ALL VISIGE TOWER EQUIPMENT AND IMPROVEMENTS ARE CONTAINED WITH THE DISCRIBED AND AND ALL SYMBOLS ARE (EPOTED TO SCALL THO SYMBOLD DES MOS REPRESENT A BOUNDARY SURVEY OF THE PARENT PARCEL

1100					
00	00 05/13/21		PRILIMITANI	EJ	
09	08/08	5/22	REV A/U	LA.	
10	08/11	1/2:	REV. A/M	CJ	
11	02/0	6/23	REVISIONS	CJ CJ	
SITE	INFO	RMAT	ION:		
Name		RIN	ICON VALLEY		
BUN 815755					
Address		1.00	00 SONOMA HWY NTA ROSA, CA 95409		
Col	county SONON		NOMA COUNTY		
	100	200			


SITE LOCATED IN:

RANCHO CABEZA DE SANTA ROSA

AS-BUILT SURVEY

SHEET TITLE: SITE BOUNDARY

SHT NAME V43 SHT NO:3 OF 5

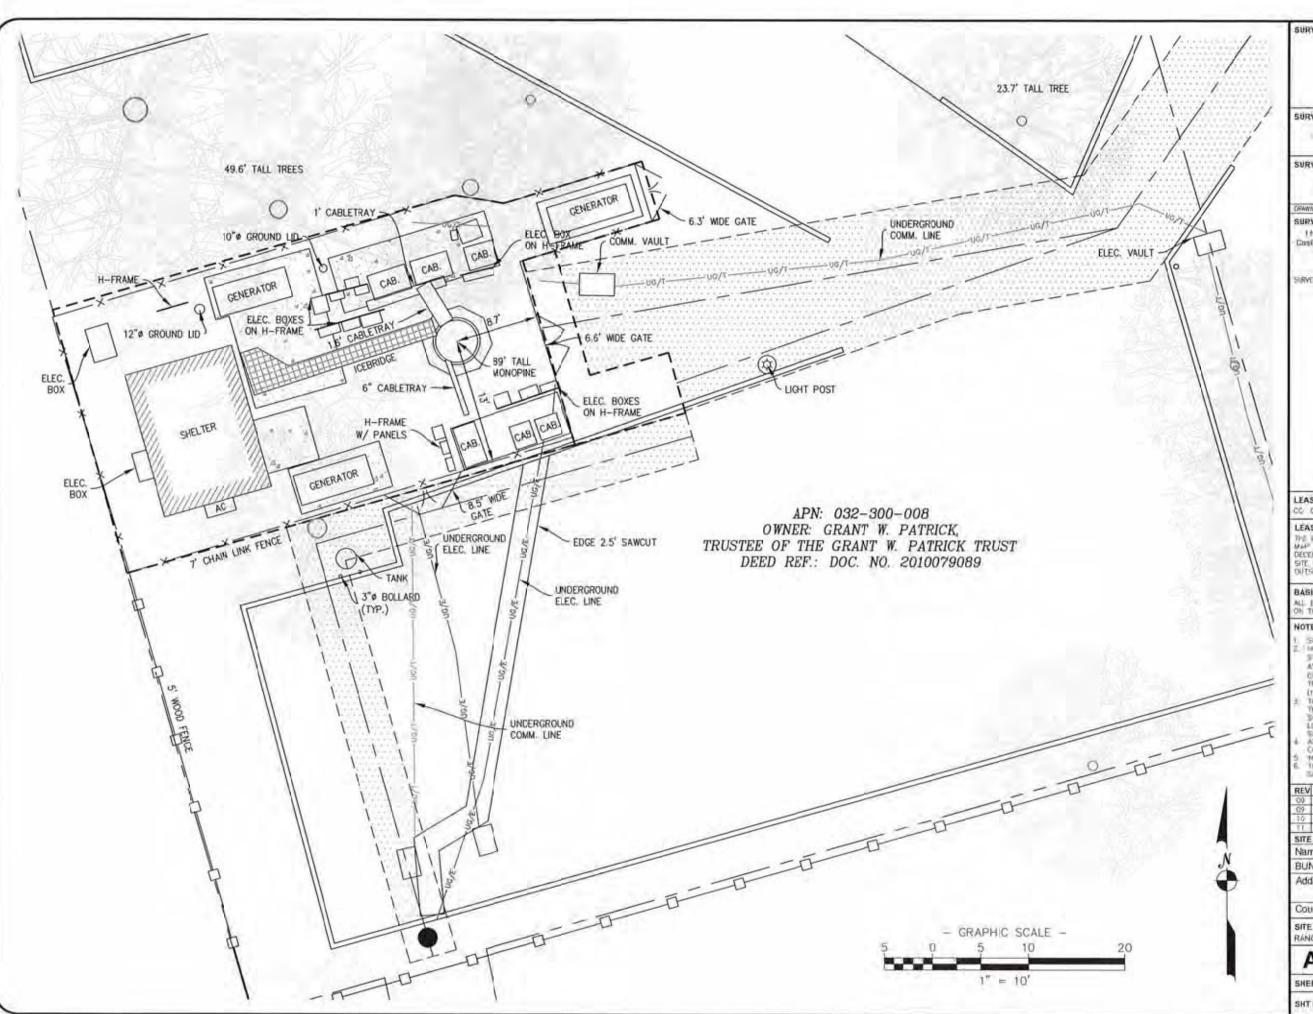

SURVEY PERFORMED FOR:



1500 Corporate Drive Cononsburg, PA 15317

SURVEY COORDINATED BY:

GEOLINE SURVEYING, INC. 13430 NW 10th Torrace, Suite A. Alachua, FL 32615 Tein: (386) 418-0500 | Fax: (386) 462-9986

SURVEY PERFORMED BY:

SMITHCO SURVEYING ENGINEERING 2005 AIRPORT DRIVE, BAKERSFIELD, CA 93308 Tole; (661) 393-1217 | Fax: (661) 393-1218

RAWN BY EV CIN BY DA LOB NO. 71-515

SURVEYOR'S CERTIFICATION:

I hareby carrify to Crown Castle GT Company LLC, Crown Gasille USA Inc., including its perents, subsidiaries and affiliat entains, and Westcor Land Title insurance Company.

SURVEYOR NAME D'ARTACHAN ALBA



LEASE AREA ZONING:

C GENERAL COMMERCIAL

LEASE AREA FLOOD NOTE:

THE PROCERAL EMERGENCY MANAGEMENT AGENCY FLOOD RATE MAP FOR COMMUNITY NO. 060381, PANEL NO. 0733E, DATED DECEMBER 2: 2008 SHOWS THAT THE LOCATION OF THIS STIE. FALLS WITHIN 20NE 16. ARAS DECEMBED TO BE OVER A ANNUAL CHANGE FLOODPLAIN

ALL BEARNES SHOWN HEREOV ARE CRID BEARNES BASED ON THE CALIFORNIA COONDINATE SYSTEM OF 1983 ZONE 2.

SURVEY FERFURNED ON 85/10/21.

MERIZORTAL DATA PROJECTED IN CALIFORNIA COORDINATE
BYSTOM OF 1993 (CCSS) FORW 3 (INTERNATIONAL
ASSOCIATION OF DIL A GAS PRODUCER'S EASO
CODE 2230 ELEVATIONS SHOWN HERICAN ARE BASED ON
THE NORTH AMERICAN VERTICAL DATUM OF 1988

THE NORTH AMERICAN VERTICAL DATUM OF 1988
INAVIORS).
THE IMPERICIONAL UTILITIES (IF ANT) THAT APPEAR ON
THE IMPERICIONAL UTILITIES (IF ANT) THAT APPEAR ON
THES MAP HAM BEEN LOCATED AND MARKED ON THE
SURFACE OF AN INDEPENDENT PROVIDE UNDERSCROUND
LOCATING SERVICE. THESE MARKINGS HAVE BEEN
SURFACE OF AND SHOWN HEREON
ALL VISIBLE TOWER COMPARITY AND IMPROVEMENTS ARE
CONTAINED WITHIN THE DISCRIBED AREA
HOLLAU SYMBOLS ARE OPPORTED TO SOALE
THIS SURFYEY DOES NOT REPRESENT A BOUNDARY
SURVEY OF THE PARENT MARCEL

REV	DATE	E .	DESCRIPTION	DRWN	
-00	05/20	1/21	PRELIMINARY	EJ	
C9-	08/0	/22	REV. A/U	LA	
10	05/1	1/22	REV. A/U	CJ	
TL	02/0	6/21	REVISIONS	CJ	
SITE	INFO	RMAT	ION:		
Name		RINCON VALLEY			
BUN 815		815	5755		
Address		490	4900 SONOMA HWY		
		SAN	SANTA ROSA, CA 95409		
Cot	intv	SONOMA COUNTY			

SITE LOCATED IN

RANCHO CABEZA DE SANTA ROSA.

AS-BUILT SURVEY

SHEET TITLE: SITE DETAIL

SHT NAME V.GI SHT NO:4 OF 5

PARENT PARCEL LEGAL DESCRIPTION

PER QUITCLAIM DEED, DOCUMENT NO. 2010079089:

THE LAND HEREIN REFERRED TO IS SITUATED IN THE STATE OF CALIFORNIA, COUNTY OF SOMOMA. CITY OF SANTA ROSA AND IS DESCRIBED AS FOLLOWS:

PARCEL ONE

LYING WITHIN RANCHO CABEZA DE SANTA ROSA AND BEING A PORTION OF THE LANDS CONVEYED TO HAROLO T, GUSTAFSON AND WIFE, BY DEED RECORDED JULY 30, 1952 UNDER RECORDER'S SERIAL NO 0.73126. SONOMA COUNTY RECORDS, SAID PORTION BEING DESCRIBED AS FOLLOWS

BEGINNING AT A POINT IN THE CENTER OF THE STATE HIGHWAY LEADING FROM SANTA ROBA TO 50NGMA, SAID POINT BEING NORTH 16°36-1/2' WEST 30 FEET FROM THE NORTHWESTERLY CORNER OF THE 2 ACRE PARCEL OF LAND CONVEYED TO JAMES W. WHITEFORD AND WIFE BY DEED REGORDED JUNE 28, 1944 IN BOOK 513 OF OFFICIAL RECORDS, PAGE 7, SONOMA COUNTY RECORDS AND THE NORTHEASTERLY CORNER OF SAID LANDS DONVEYED TO HAROLD T. GUSTAFSON AND WIFE. SAID POINT BEING KNOWN AS STATION "P" 131+08.0 POINT ON TANGENT OF THE SURVEY OF SAID HIGHWAY: THENCE SOUTH 16" 36" 30" FAST A DISTANCE OF 30 FEET TO AN IRON PIPE SET IN THE SOUTHERN LINE OF SAID HIGHWAY: THENCE SOUTH 70" 20" 30" WEST AND ALONG THE SOUTHERN LINE OF SAID HIGHWAY, A DISTANCE OF 100 FEET TO AN IRON PIPE AND THE TRUE POINT OF BEGINNING: THENCE SOUTH 16" 36" 30" EAST AND ALONG THE WESTERN BOUNDARY LINE OF THE LAND CONVEYED. BY HAROLD T. GUSTAFSON AND WIFE TO WALTER CEDARBERG. A SINGLE MAN, BY DEED DATED MARCH 9, 1953 AND RECORDED MARCH 18, 1953 IN THE OFFICE OF THE COUNTY RECORDER OF SONOMA COUNTY UNDER RECORDER'S SERIAL NO. 3-90508, A DISTANCE OF 200 FEET TO AN IRON PIPE THENCE SOUTH 73° 20° 30° WEST A DISTANCE OF 92.70 FEET TO AN IRON PIPE. THENCE SOUTH 12° 56 EAST A DISTANCE OF 43 FEET TO AN IRON PIPE: THENCE SOUTH 73 * 20' 30' WEST A DISTANCE OF 11 FEET TO AN IRON PIPE: THENCE NORTH 12" 56' WEST A DISTANCE OF 43 FEET TO AN IRON PIPE THENCE SOUTH 73" 20" 30" WEST A DISTANCE OF 14.3 FEET TO AN IRON PIPE: THENCE NORTH 15" 36 30" WEST A DISTANCE OF 200 FEET TO THE SOUTHERN LINE OF SAID HIGHWAY: THENCE NORTH 73" 20" 30" EAST, 118.0 FEET TO THE TRUE POINT OF BEGINNING. A.P. NO. 32-300-08

PARCEL TWO

AN EASEMENT FOR UNDERGROUND SEWER DRAINAGE AND SURFACE WATER RUN OFF OVER THE WESTERLY 10 FEET OF PARCELS 2 AND 3 AS SHOWN ON CITY OF SANTA ROSA PARCEL MAP NO 43. FILED AUGUST 17, 1972 IN BOOK 177 OF MAPS, PAGE IB.

EXCEPTING 'DIEREFROM THAT PORTION LYING WITHIN THE LANDS DESCRIBED IN DEED RECORDED JANUARY 25, 1978 IN BOOK 3345 OF OFFICIAL RECORDS, PAGE 985, SONOMA COUNTY RECORDS

PARCEL THREE

AN EASIEMENT FOR UNDERGROUND SEWER, WATER HUN OFF AND DRAINAGE OVER THE SOUTHERLY 10 FEET OF PARCEL 1, AS SHOWN ON CITY OF SANTA ROSA PARCEL MAP NO. 43, FILED AUGUST 17. BOOK 177 OF MAPS, PAGE 18.

PARCEL FOUR

A NON-EXCLUSIVE EASEMENT AND RIGHT OF WAY FOR INGRESS AND EGRESS OF VEHICLES OVER THE WESTERLY 20 FEET OF THE LANDS OF ALBERTINE S. HARVEY, AS SAID EASEMENT AND LANDS ARE DESCRIBED IN DOCUMENT RECORDED DECEMBER 5 1985 AS DOCUMENT NO. 85081688 AND RERECORDED JANUARY 28, 1986 AS DOCUMENT NO. 85005783, SONOMA COUNTY RECORDS

ITEMS OF RECORD

PER TOWER TITLE INSURANCE COMPANY, TITLE FILE NO. CCI-130702-FR, DATED APRIL 8, 2022:

- 1. EASEMENT DEED BETWEEN GRANT W. PATRICK: AND THE CITY OF SANTA ROSA A MUNICIPAL CORPORATION, DAYED APRIL 21, 1988 AND RECORDED APRIL 27, 1981 W. (INSTRUMENT) 80032901. IN SONOMA COUNTY, CALIFORNIA. >> PLOTTED AS SHOWN HEREON <<
- MEMORANDUM OF LEASE BETWEEN GRANT W. PATRICK; AND GTE MOBILNET OF CALIFORNIA LIMITED PARTNERSHIP, A CALIFORNIA LIMITED PARTNERSHIP BY GTE MO3ILNET INCORPORATED ITS GENERAL PARTNER, DATED JANUARY 2, 1997 AND RECORDED MARCH 18, 1897 IN (INSTRUMENT) 1997 0021841, IN SONOMA COUNTY

AFFECTED BY A(N) ASSIGNMENT AND ASSUMPTION AGREEMENT BETWEEN GTE MOBIL NET OF CALIFORNIA LIMITED PARTNERSHIP, A GALIFORNIA LIMITED PARTNERSHIP DIBYA VERIZON WIRELESS, AND CROWN CASTLE GT COMPANY LLC, A DELAWARE LIMITED LIABILITY COMPANY DATED JUNE 13, 2001 AND RECORDED OCTOBER 8, 2001 IN (INSTRUMENT) 200 H 36992, IN SONOMA COUNTY, CALIFORNIA

AFFECTED BY A(N) MEMORANDUM OF BECOND AMENDMENT TO LAND LEASE AGREEMENT BETWEEN GRANT W. PATRICK, AND CROWN CASTLE GT COMPANY LLC, A DELAWARE LIMITED LIABILITY COMPANY, DATED JULY 16, 2001 AND RECORDED MARCH 6, 2002 IN (INSTRUMENT) 2002033380. IN SONOMA COUNTY, CALIFORNIA

AFFECTED BY A(N) MEMORANDUM OF FOURTH AMENDMENT TO LAND LEASE AGREEMENT BETWEEN GRANT W. PATRICK, AN INCIVIDUAL DEALING WITH HIS SOLE AND SEPARATE PROPERTY; AND CROWN CASTLE GT COMPANY LLC, A DELAWARE LIMITED LIABILITY COMPANY, DATED SEPTEMBER 6, 2008 AND RECORDED SEPTEMBER 15, 2011 IN (INSTRUMENT) 2011078708. IN SONOMA COUNTY, CALIFORNIA

AFFECTED BY A(N) MEMORANDUM OF FIFTH AMENDMENT TO LAND LEASE AGREEMENT BETWEEN GRANT W. PATRICK, TRUSTEE OF THE GRANT W. PATRICK TRUST AGREEMENT DATED SEPTEMBER 9, 2010; AND CROWN CASTLE GT COMPANY LLC. A DELAWARE LIMITED LIABILITY COMPANY, DATED NOVEMBER 18, 2016 AND RECORDED FEBRUARY 7, 2017 IN (INSTRUMENT) 2017/10036, IN SONOMA COUNTY, CALIFORNIA >>> LEASE IS ASSOCIATED WITH TOWER LEASE AREA <<<

- EASEMENT AGREEMENT BETWEEN AMELIO FABBRI AND SILVIJA LEONAVICIUS-FABBRII AND GTE MOBILNET OF CALIFORNIA LIMITED PARTNERSHIP, BY GTE MOBILNET INCORPORATED, ITS GENERAL PARTNER, DATED APRIL 16, 1997 AND RECORDED JUNE 26, 1997 IN (INSTRUMENT) 1997 (654354) IN SONOMA COUNTY, CALIFORNIA >>> PLOTTED AS SHOWN HEREDNESS
- GRANT OF EASEMENT BETWEEN GRANT W. PATRICK; AND CABLE ONE, DATED FEBRUARY 19, 1998 AND RECORDED FEBRUARY (II. 1998 IN (INSTRUMENT) 1998 0016185, IN SONOMA >>> NOT PLOTTABLE EXAUTILOGATION GANNOT BE DETERMINED FROM THE REFERENCE DOCUMENT <<

TOWER LEASE AREA

PREPARED BY THIS OFFICE

BEING A PORTION OF THE LAND AS DESCRIBED IN THE QUITCLAIM DEED, RECORDED SEPTEMBER 17, 2010 AS DOCUMENT NO. 20100790Mb. MORE PARTICULARLY DESCRIBED AS FOLLOWS

COMMENCING AT THE SOUTHEASTERLY MOST CORNER OF PARCEL 1 OF PARCEL MAP NO. 43. RECORDED IN BOOK 177 OF PARICEL MAPS, AT PAGE 18, SONOMA COUNTY RECORDS, THENCE ALONG THE EAST LINE OF SAID PARCEL 1. N. 15"50"51" W (SHOWN ON SAID MAP AS S 16"00"00" E). A DISTANCE OF 47.54 FEET TO THE POINT DE REGINNING

COURSE 1) THENCE CONTINUING ALONG BAID EAST LINE N 15°58'51" W, A DISTANCE OF 78 32 FEET:

COURSE 2) THENCE LEAVING BAID EAST LINE, N. 74"01"09" E. A DISTANCE OF 43.54 FEET.

COURSE 3) THENCE S 81'23'23' E. A DISTANCE OF 5.31 FEET; COURSE 4) THENCE N 73"04"25" E. A DISTANCE OF 14.97 FEET:

COURSE 5) THENCE B 18'55'35' E. A DISTANCE OF 6.27 FEET:

COURSE 6) THENCE S 73/04/25" W, A DISTANCE OF 14.86 FEET:

COURSE 7) THENGE S 15'56'S1" E. A DISTANCE OF 7.28 FEET TO THE HEREINAFTER DESCRIBED POINT "A"

COURSE 8) THENCE S 16'56'51" E. A DISTANCE OF 12.57 FEET; COURSE 9) THENCE 8:74"(H) 00" W. A DISTANCE OF 48.58 FEET TO THE POINT OF BEGINNING

CONTAINING 1.455 SQUARE FEET (0.003 ACRES). MORE OR LESS.

APN: 032-300-00E OWNER'S): GRANT W. PATRICK TRUSTER OF THE GRANT W. PATRICK TRUST DEED REFERENCE, DOCUMENT NO. 20100790388

ADDITIONAL LEASE AREA

PREPARED BY THIS OFFICE

BEING A PORTION OF THE LAND AS DESCRIBED IN THE QUITCLAIM DEED. RECORDED SEPTEMBER 17, 2010 AS DOCUMENT NO. 2010079089, MORE PARTICULARLY DESCRIBED AS FOLLOWS

COMMENCING AT THE SOUTHEASTERLY MOST CORNER OF PARCEL 1 OF PARCEL MAP NO. 43. RECORDED IN BOOK 177 OF PARCEL MAPS, AT PAGE 18, SONOMA COUNTY RECORDS, THENCE ALONG THE EAST LINE OF SAID PARCEL 1. N 15"58"51" W (SHOWN ON SAID MAP AS S 16"36"30" ELA DISTANCE OF 47.54 FEET, THENCE LEAVING SAID EAST LINE, N 74"01"09" E, A DISTANCE OF 48.58

COURSE 1) THENCE CONTINUING N 15"58"51" W, A DISTANCE OF 19.85 FEET:

COURSE 2) THENCE N 73"04"25" E. A DISTANCE OF 3.46 FEET.

COURSE 3) THENCE S 15'58'52" E, A DISTANCE OF 13.91 FEET. COURSE 4) THENCE N 74"01"01" E. A DISTANCE OF 8.54 FEET.

COURSE 5) THENCE S 15"MIST F. A DISTANCE OF 6.50 FEET.

COURSE 6) THENCE S 74'01'00' W. A DISTANCE OF 12:00 FEET TO THE POINT OF REGINNING

CONTAINING 124 SQUARE FEET (0.002 ACRES), MORE OR LESS.

APN: 032-300-008

OWNER(S): GRANT W. PATRICK, TRUSTEE OF THE GRANT W. PATRICK TRUST DEED REFERENCE: DOCUMENT NO. 2010079089

ACCESS & UTILITY EASEMENT

PREPARED BY THIS OFFICE

A 12.00 FOOT WIDE STRIP OF LAND OVER, ACROSS AND THROUGH A PORTION OF THE LAND AS DESCRIBED IN THE QUITCLAIM DEED, RECORDED SEPTEMBER 17, 2010 AS DOCUMENT NO. 2010079089, LYING 6:00 FEET ON EACH SIDE OF THE FOLLOWING DESCRIBED CENTERLINE:

COMMENCING AT THE SOUTHEASTERLY MOST CORNER OF PARCEL 1 OF PARCEL MAP NO. 43. RECORDED IN BOOK 177 OF PARCEL MAPS, AT PAGE 18, SONOMA COUNTY REGORDS, THENCE ALONG THE EAST LINE OF SAID PARCEL 1, N 15"58"51" W (SHOWN ON SAID MAP AS S 16"36"30" E), A DISTANCE OF 47.54 FEET: THENCE LEAVING SAID EAST LINE, N 74°01'00° F, A DISTANCE OF 48.58 FEET: THENCE S 15"58"61" E. A DISTANCE OF 12.57 FEET TO POINT "A" AND TO THE POINT OF

COURSE 1) THENCE N 80'04'53" E. A DISTANCE OF 60 88 FEET TO POINT "B" COURSE 2) THENCE N 34°50'27" E. A DISTANCE OF 24.35 FEET COURSE 3) THENCE N 16"51" W. A DISTANCE OF 131.05 FEET TO THE SOUTH LINE OF STATE HIGHWAY NO. 12 AND THE TERMINUS OF THIS DESCRIPTION

A 500 FOOT WIDE STRIP OF LAND OVER ACROSS AND THROUGH A PORTION OF THE LAND AS DESCRIBED IN THE QUITCLAM DEED, RECORDED SEPTEMBER 17, 2010 AS DIOCUMENT NO. 2010079089, LYING 3:00 FEET ON EACH SIDE OF THE FOLLOWING DESCRIBED CENTERLINE

BEGINNING AT THE ABOVE MENTIONED POINT BY

COURSE 1) THENCE 5 70 35 49" W, A DISTANCE OF 48.63 FEET TO THE TERMINUS OF THIS

CONTAINING 2,744 SQUARE FEET (0.063 ACRES), MORE OR LESS.

APN: 032-300-008 OWNER(S): GRANT W. PATRICK. TRUSTEE OF THE GRANT W. PATRICK TRUST DEED REFERENCE: DOCUMENT NO. 7010079089

OWNER(S): ROBERT ELLIS LOGAN & JANET ELAINE LOGAN DEED REFERENCE

UTILITY EASEMENT

PREPARED BY THIS OFFICE

A 5.00 FOOT WIDE STRIP OF LAND OVER, ACROSS AND THROUGH A PORTION OF THE LAND AS DESCRIBED IN THE QUITCLAIM DEED, RECORDED SEPTEMBER 17, 2010 AS DOCUMENT NO. 2010079089 LYING 2.50 FEET ON EACH SIDE OF THE FOLLOWING DESCRIBED CENTERS INC.

COMMENCING AT THE SOUTHEASTERLY MOST CORNER OF PARCEL 1 OF PARICEL MAP NO. 43. RECORDED IN BOOK 177 OF PARCEL MAPS, AT PAGE 18. SONOMA COUNTY RECORDS, THENCE ALONG THE EAST LINE OF SAID PARCEL 1. N 15'58'51" W ISHOWN ON SAID MAP AS S 16'36'30" ELA DISTANCE OF 0.77 FEET: THENCE LEAVING SAID EAST LINE, N 74'01'09" E. A DISTANCE OF 19.77

COURSE 1) THENCE N 15/56/01 E. A DISTANCE OF 44.27 FEET. COURSE 2) THENCE N 74 01/00 E. A DISTANCE OF 40.81 FEET: COURSE 3) THENCE N 15"56"51" W. A DISTANCE OF 131.05 FEET TO THE TERMINUS OF THIS

CONTAINING 425 SQUARE FEET (0.109 ACRES) MORE OR LESS.

OWNER(S): GRANT W. PATRICK, TRUSTEE OF THE GRANT W. PATRICK TRUST DEED REFERENCE: DOCUMENT NO. 2010079089

OWNER(S): ROBERT ELLIS LOGAN & JANET ELAINE LOGAN DEED REFERENCE

SURVEY PERFORMED FOR:



1500 Corporate Drive Canonisburg, PA 15317

SURVEY COORDINATED BY

GEOLINE SURVEYING, INC. 13430 NW 10th Terrace, Suite A, Alachue, FL 32615 Tele (386) 415-0500 | Fax (386) 462-9985

SURVEY PERFORMED BY:

SMITHCO SURVEYING ENGINEERING 2005 AIRPORT DRIVE BAKERSFIELD, CA 93308 Tele: (661) 393-1217 | Fax: (661) 393-1218

RAMIN BY: E. CHIII BY: DA SURVEYOR'S CERTIFICATION:

Liturally certify to Crown Gasile GT Company LLC, Grown Castle USA Inc., including its parents, subsidiaries and affiliate entities, and Wasicar Land Title Insurance Company

SURVEYOR NAME D'ANTAGNAN ALEA



LEASE AREA ZONING:

G. CENERAL COMMERCIAL

LEASE AREA FLOOD NOTE:

THE FEDERAL ENERGENCY MANAGEMENT AGENCY FLOOD RATE MAP FOR COMMUNITY MO. 000351, PANEL NO. 0733F DATED DELEMBER 2, 2005 SHOWS THAT THE LOCATION OF THIS SITE FALLS WITHIN ZONE "X" AREAS DETERMINED OUTSIDE THE DES ANNUAL GRANCE FLOODINGAN

TMIF

ALL BEARMICS SHOWN MEREON ARE GRID BEARMOS BASED ON THE CALIFORNIA COORDINATE SYSTEM OF 1883 ZONE I

NOTES:

MARKE PERFORMED ON 65/10/3 1 9/2001AL DATA PRINCIPED IN SAUTORNIA COORDINATE SYSTEM OF 1983 (CCSS) ZONE 2 (INTERNATIONAL MISOCIATION OF OIL & ILIS PRODUCER'S EPSG CODE 1276) D.EMATIONS SHOWN HERCON ARE BASED ON THE NORTH AMERICAN VERTICAL DATUM OF 1988 VEHAVORS)

(MAYORA)
THE UNCERGROUND UTILITIES (IF ANY) THAT APPEAR ON
THE MAP HAY BEEN LOCATED AND MARKED ON THE
SURFACE OF AN INCIDENCE OF PRIVATE UNDERGROUND
LOCATING SERVICE THESE MARKINGS HAVE BEEN
SURVEYED AND SHOWN HEREON
ALL VILLEL TOWER COMPRENET AND IMPROVEMENTS ARE

TOWN EQUIPMENT AND MANAGED ANY A NOT ALL SYMBOLS ARE (EPCITED TO SCALL THIS SURVEY DOES NOT REPRESENT A BOUNDARY SURVEY OF THE PARENT PARCEL

REV DATE DESCRIPTION

113/21	PRELIMINARY	EJ	
/05/22	REV. A/U	A.E	
/19/22	REV. A/U	(3)	
/06/21	REVISIONS	101	
FORMAT	TON:		
RIN	RINCON VALLEY 815755 4900 SONOMA HWY		
815			
ss 490			
SANTA ROSA, CA 95409			
SOI	NOMA COUNTY		
	718/72 706/23 FORMAT RIN 815 8490 SAI	/(15/22 NEV A/U /(15/22 REV A/U /(06/22 REVISIONS FORMATION: RINCON VALLEY 815755 88 4900 SONOMA HWY SANTA ROSA, CA 95409	

SITE LOCATED IN:

RANCHO CABEZA DE SANTA ROSA

AS-BUILT SURVEY

SHEET TITLE: LEGAL DESCRIPTION

SHT NAME V-05 SHT NO:5 OF 5

DRWN

815755 Rincon Valley

TOWER LEASE AREA (PREPARED BY THIS OFFICE):

BEING A PORTION OF THE LAND AS DESCRIBED IN THE QUITCLAIM DEED, RECORDED SEPTEMBER 17, 2010 AS DOCUMENT NO. 2010079089, MORE PARTICULARLY DESCRIBED AS FOLLOWS:

COMMENCING AT THE SOUTHEASTERLY MOST CORNER OF PARCEL 1 OF PARCEL MAP NO. 43, RECORDED IN BOOK 177 OF PARCEL MAPS, AT PAGE 18, SONOMA COUNTY RECORDS, THENCE ALONG THE EAST LINE OF SAID PARCEL 1, N 15°58'51" W (SHOWN ON SAID MAP AS S 16°36'30" E), A DISTANCE OF 47.54 FEET TO THE POINT OF BEGINNING:

COURSE 1) THENCE CONTINUING ALONG SAID EAST LINE N 15°58'51" W, A DISTANCE OF 28.32 FEET;

COURSE 2) THENCE LEAVING SAID EAST LINE, N 74°01'09" E, A DISTANCE OF 43.54 FEET;

COURSE 3) THENCE S 81°23'23" E, A DISTANCE OF 5.31 FEET;

COURSE 4) THENCE N 73°04'25" E, A DISTANCE OF 14.97 FEET;

COURSE 5) THENCE S 16°55'35" E, A DISTANCE OF 6.27 FEET;

COURSE 6) THENCE S 73°04'25" W, A DISTANCE OF 14.86 FEET;

COURSE 7) THENCE S 15°58'51" E, A DISTANCE OF 7.28 FEET TO THE HEREINAFTER DESCRIBED POINT "A":

COURSE 8) THENCE S 15°58'51" E, A DISTANCE OF 12.57 FEET:

COURSE 9) THENCE S 74°01'09" W, A DISTANCE OF 48.58 FEET TO THE POINT OF BEGINNING.

CONTAINING 1,463 SQUARE FEET (0.033 ACRES), MORE OR LESS.

APN: 032-300-008

OWNER(S): GRANT W. PATRICK, TRUSTEE OF THE GRANT W. PATRICK TRUST DEED REFERENCE: DOCUMENT NO. 2010079089



815755 Rincon Valley

ADDITIONAL LEASE AREA (PREPARED BY THIS OFFICE):

BEING A PORTION OF THE LAND AS DESCRIBED IN THE QUITCLAIM DEED, RECORDED SEPTEMBER 17, 2010 AS DOCUMENT NO. 2010079089, MORE PARTICULARLY DESCRIBED AS FOLLOWS:

COMMENCING AT THE SOUTHEASTERLY MOST CORNER OF PARCEL 1 OF PARCEL MAP NO. 43, RECORDED IN BOOK 177 OF PARCEL MAPS, AT PAGE 18, SONOMA COUNTY RECORDS, THENCE ALONG THE EAST LINE OF SAID PARCEL 1, N 15°58'51" W (SHOWN ON SAID MAP AS S 16°36'30" E), A DISTANCE OF 47.54 FEET; THENCE LEAVING SAID EAST LINE, N 74°01'09" E, A DISTANCE OF 48.58 TO THE POINT OF BEGINNING:

COURSE 1) THENCE CONTINUING N 15°58'51" W. A DISTANCE OF 19.85 FEET:

COURSE 2) THENCE N 73°04'25" E, A DISTANCE OF 3.46 FEET;

COURSE 3) THENCE S 15°58'52" E, A DISTANCE OF 13.91 FEET;

COURSE 4) THENCE N 74°01'09" E, A DISTANCE OF 8.54 FEET;

COURSE 5) THENCE S 15°58'51" E, A DISTANCE OF 6.50 FEET;

COURSE 6) THENCE S 74°01'09" W, A DISTANCE OF 12.00 FEET TO THE POINT OF BEGINNING.

CONTAINING 124 SQUARE FEET (0.002 ACRES), MORE OR LESS.

APN: 032-300-008

OWNER(S): GRANT W. PATRICK, TRUSTEE OF THE GRANT W. PATRICK TRUST

DEED REFERENCE: DOCUMENT NO. 2010079089



815755 Rincon Valley

ACCESS & UTILITY EASEMENT DESCRIPTION (PREPARED BY THIS OFFICE):

A 12.00 FOOT WIDE STRIP OF LAND OVER, ACROSS AND THROUGH A PORTION OF THE LAND AS DESCRIBED IN THE QUITCLAIM DEED, RECORDED SEPTEMBER 17, 2010 AS DOCUMENT NO. 2010079089, LYING 6.00 FEET ON EACH SIDE OF THE FOLLOWING DESCRIBED CENTERLINE:

COMMENCING AT THE SOUTHEASTERLY MOST CORNER OF PARCEL 1 OF PARCEL MAP NO. 43, RECORDED IN BOOK 177 OF PARCEL MAPS, AT PAGE 18, SONOMA COUNTY RECORDS, THENCE ALONG THE EAST LINE OF SAID PARCEL 1, N 15°58'51" W (SHOWN ON SAID MAP AS S 16°36'30" E), A DISTANCE OF 47.54 FEET; THENCE LEAVING SAID EAST LINE, N 74°01'09" E, A DISTANCE OF 48.58 FEET; THENCE S 15°58'51" E, A DISTANCE OF 12.57 FEET TO POINT "A" AND TO THE POINT OF BEGINNING:

COURSE 1) THENCE N 80°04'53" E, A DISTANCE OF 60.88 FEET TO POINT "B"; COURSE 2) THENCE N 34°50'27" E, A DISTANCE OF 24.35 FEET; COURSE 3) THENCE N 15°58'51" W, A DISTANCE OF 131.05 FEET TO THE SOUTH LINE OF STATE HIGHWAY NO. 12 AND THE TERMINUS OF THIS DESCRIPTION.

A 6.00 FOOT WIDE STRIP OF LAND OVER, ACROSS AND THROUGH A PORTION OF THE LAND AS DESCRIBED IN THE QUITCLAIM DEED, RECORDED SEPTEMBER 17, 2010 AS DOCUMENT NO. 2010079089, LYING 3.00 FEET ON EACH SIDE OF THE FOLLOWING DESCRIBED CENTERLINE:

BEGINNING AT THE ABOVE MENTIONED POINT "B":

COURSE 1) THENCE S 70°35'49" W, A DISTANCE OF 48.63 FEET TO THE TERMINUS OF THIS DESCRIPTION.

CONTAINING 2,744 SQUARE FEET (0.063 ACRES), MORE OR LESS.

APN: 032-300-008 OWNER(S): GRANT W. PATRICK, TRUSTEE OF THE GRANT W. PATRICK TRUST DEED REFERENCE: DOCUMENT NO. 2010079089

APN: 032-300-004 OWNER(S): ROBERT ELLIS LOGAN & JANET ELAINE LOGAN DEED REFERENCE:



815755 Rincon Valley

UTILITY EASEMENT DESCRIPTION (PREPARED BY THIS OFFICE):

A 5.00 FOOT WIDE STRIP OF LAND OVER, ACROSS AND THROUGH A PORTION OF THE LAND AS DESCRIBED IN THE QUITCLAIM DEED, RECORDED SEPTEMBER 17, 2010 AS DOCUMENT NO. 2010079089, LYING 2.50 FEET ON EACH SIDE OF THE FOLLOWING DESCRIBED CENTERLINE:

COMMENCING AT THE SOUTHEASTERLY MOST CORNER OF PARCEL 1 OF PARCEL MAP NO. 43, RECORDED IN BOOK 177 OF PARCEL MAPS, AT PAGE 18, SONOMA COUNTY RECORDS, THENCE ALONG THE EAST LINE OF SAID PARCEL 1, N 15°58'51" W (SHOWN ON SAID MAP AS S 16°36'30" E), A DISTANCE OF 0.77 FEET; THENCE LEAVING SAID EAST LINE, N 74°01'09" E, A DISTANCE OF 19.77 FEET TO THE POINT OF BEGINNING:


COURSE 1) THENCE N 15°58'51" E, A DISTANCE OF 44.27 FEET; COURSE 2) THENCE N 74°01'09" E, A DISTANCE OF 40.81 FEET; COURSE 3) THENCE N 15°58'51" W, A DISTANCE OF 131.05 FEET TO THE TERMINUS OF THIS DESCRIPTION.


CONTAINING 425 SQUARE FEET (0.063 ACRES), MORE OR LESS.

APN: 032-300-008 OWNER(S): GRANT W. PATRICK, TRUSTEE OF THE GRANT W. PATRICK TRUST DEED REFERENCE: DOCUMENT NO. 2010079089

APN: 032-300-004 OWNER(S): ROBERT ELLIS LOGAN & JANET ELAINE LOGAN DEED REFERENCE:



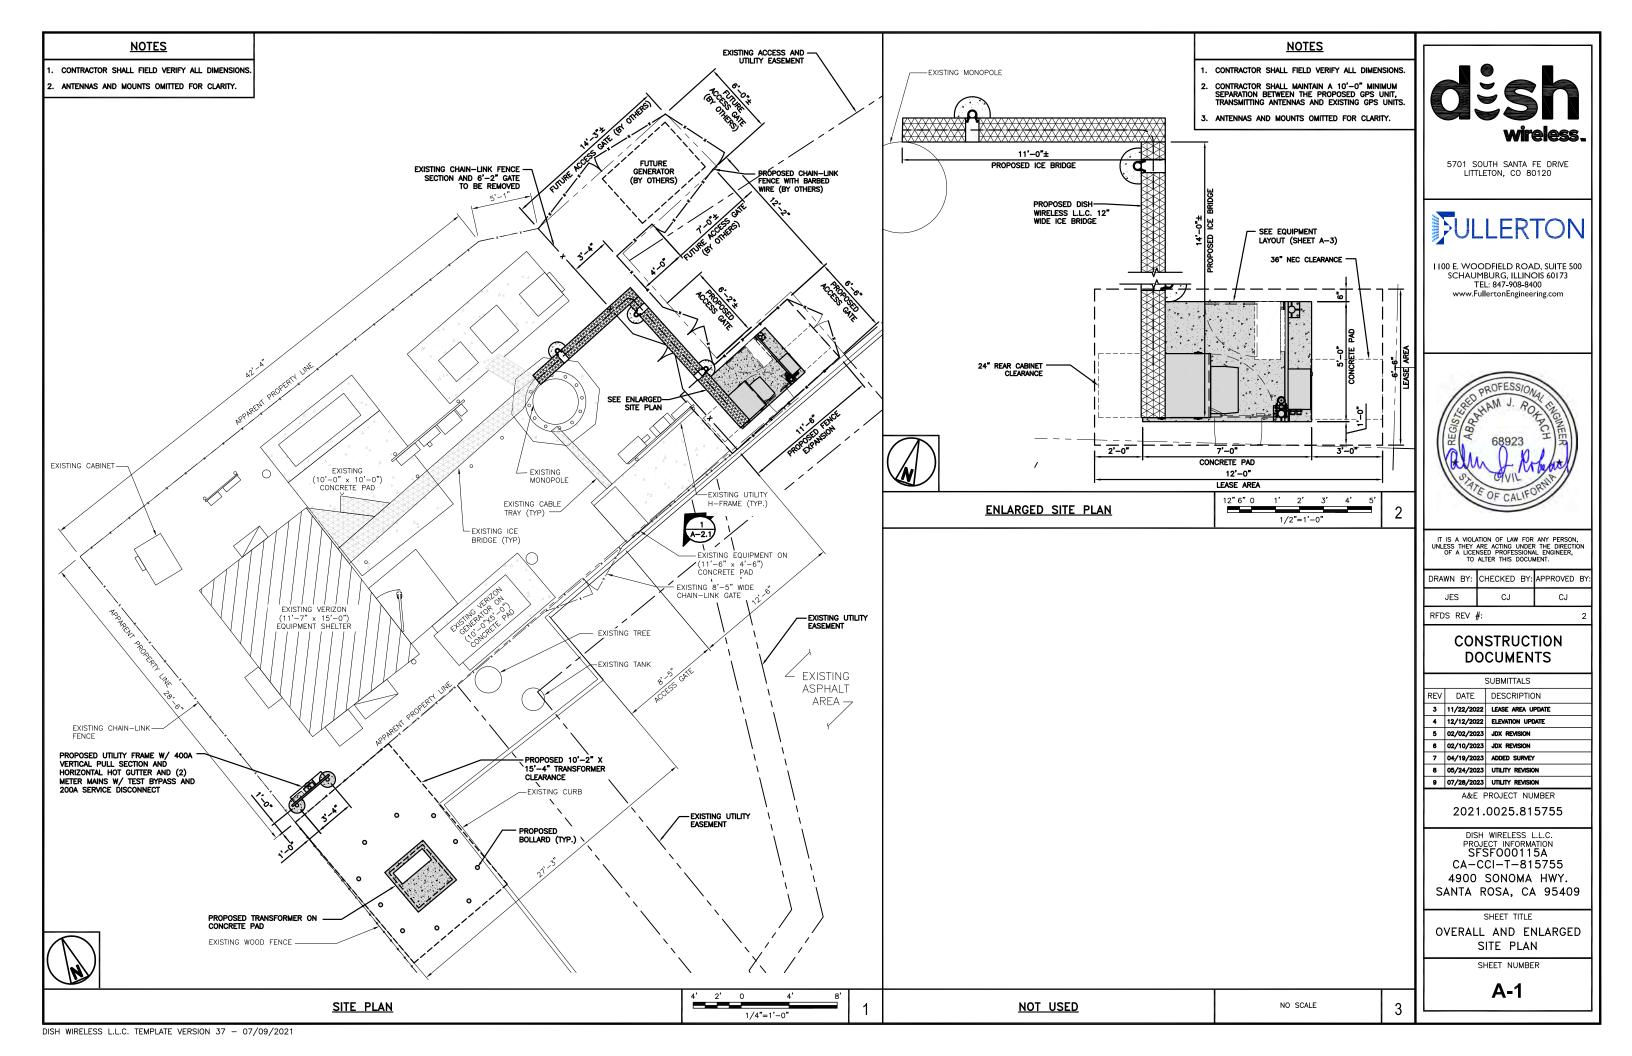

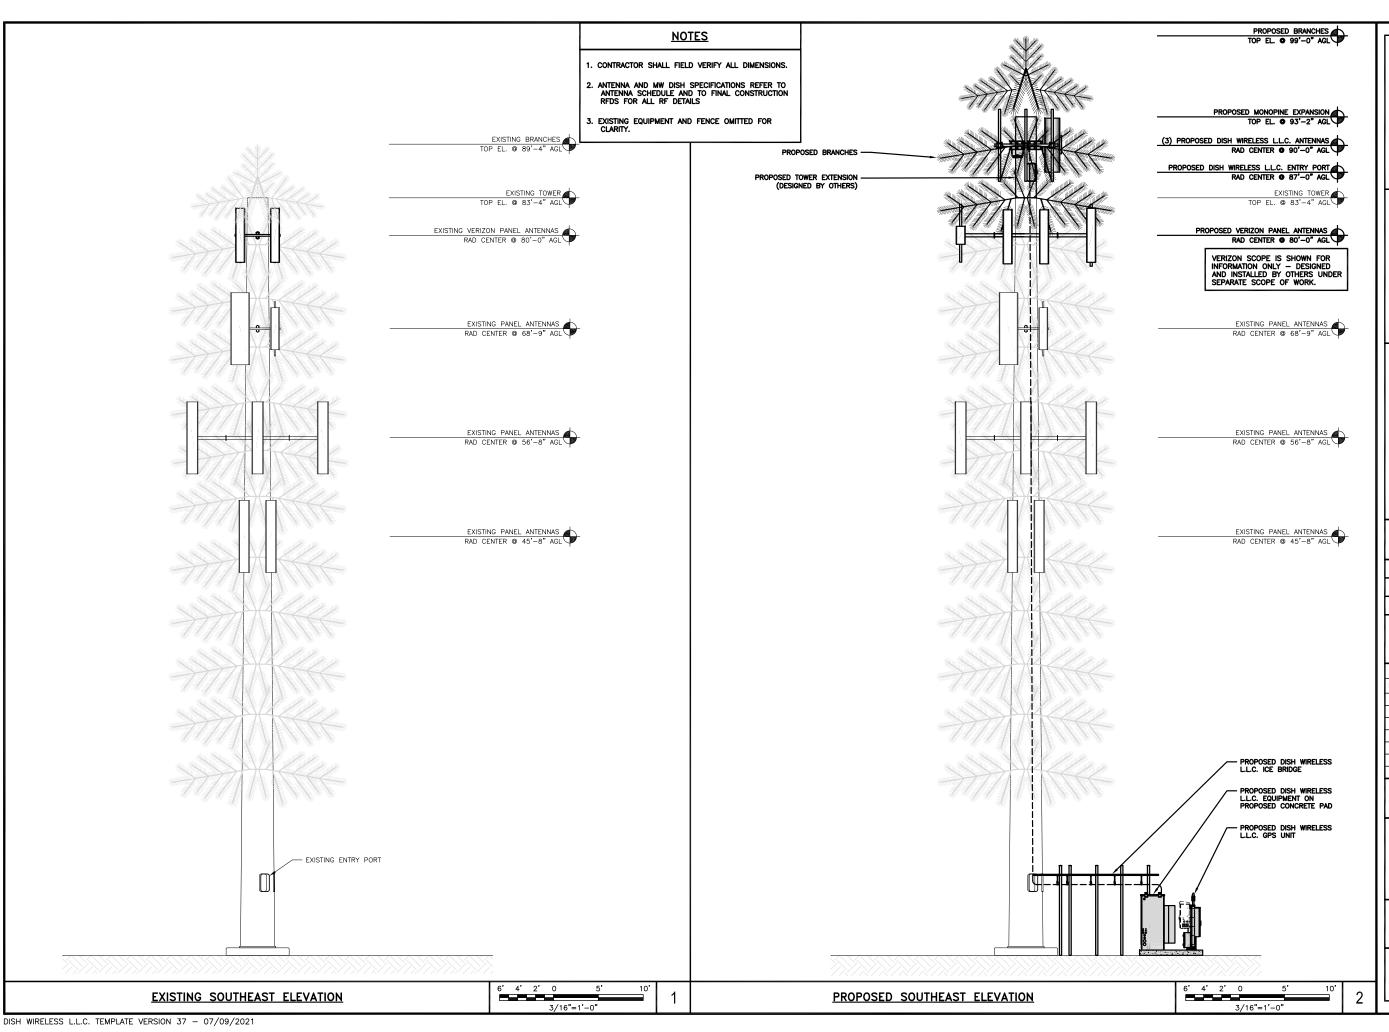



5701 SOUTH SANTA FE DRIVE LITTLETON, CO 80120

ULLERTON

I 100 E. WOODFIELD ROAD, SUITE 500 SCHAUMBURG, ILLINOIS 60173 TEL: 847-908-8400 www.FullertonEngineering.com



IT IS A VIOLATION OF LAW FOR ANY PERSON, UNLESS THEY ARE ACTING UNDER THE DIRECTION OF A LICENSED PROFESSIONAL ENGINEER, TO ALTER THIS DOCUMENT.

DRAWN	BY:	CHECKED	BY:	APPROVED	BY:
JES	5	CJ		CJ	

RFDS REV #:

CONSTRUCTION **DOCUMENTS**

	SUBMITTALS							
REV	DATE	DESCRIPTION						
3	11/22/2022	LEASE AREA UPDATE						
4	12/12/2022	ELEVATION UPDATE						
5	02/02/2023	JDX REVISION						
6	02/10/2023	JDX REVISION						
7	04/19/2023	ADDED SURVEY						
8	05/24/2023	UTILITY REVISION						
9	07/28/2023	UTILITY REVISION						

A&E PROJECT NUMBER 2021.0025.815755

DISH WIRELESS L.L.C. PROJECT INFORMATION SFSF000115A CA-CCI-T-815755 4900 SONOMA HWY. SANTA ROSA, CA 95409


SHEET TITLE EXISTING AND PROPOSED ELEVATIONS

SHEET NUMBER

A-2.1

<u>NOTES</u>

- 1. CONTRACTOR SHALL FIELD VERIFY ALL DIMENSIONS.
- 2. ANTENNA AND MW DISH SPECIFICATIONS REFER TO ANTENNA SCHEDULE AND TO FINAL CONSTRUCTION RFDS FOR ALL RF DETAILS
- 3. EXISTING EQUIPMENT AND FENCE OMITTED FOR CLARITY.

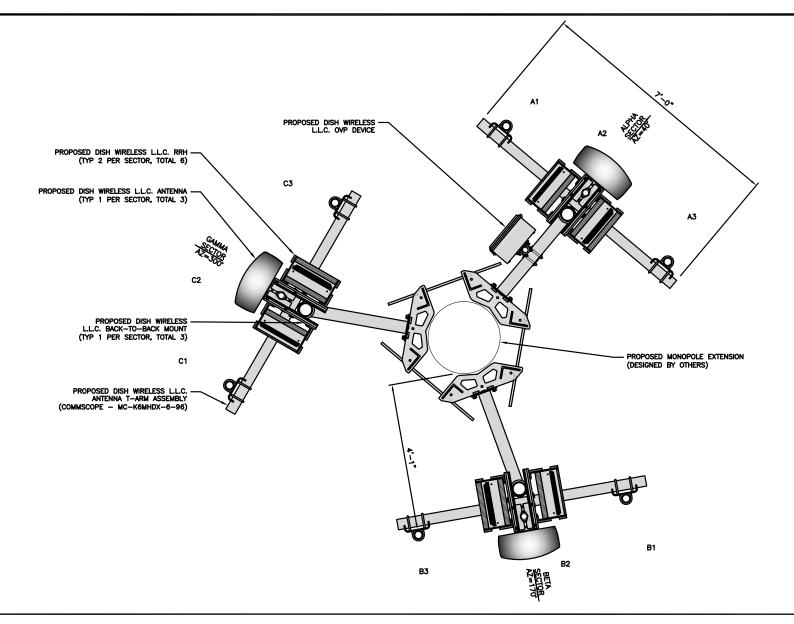



ANTENNA LAYOUT

SECTOR		ANTENNA			TRANSMISSION CABLE	RRH			OVP	
POS.	EXISTING OR PROPOSED	MANUFACTURER — MODEL NUMBER	TECH	AZIMUTH	RAD CENTER	FEED LINE TYPE AND LENGTH	MANUFACTURER — MODEL NUMBER	TECH	POS.	MANUFACTURER MODEL
A1					-	(1) HIGH-CAPACITY	FUJITSU - TA08025-B604	MULTI	A2	DAVOAD
A2	PROPOSED	JMA - MX08FR0665-20	NR	40°	90'-0" (1) HIGH-CAPACHT HYBRID CABLE FUJITSU - TA08025-B605 (137' LONG)		MULTI	A2	RAYCAP — RDIDC-9181 -PF-48	
A3		-	-		-	(107 EONO)	-			11 40
B1							FUJITSU - TA08025-B604	MULTI	B2	
B2	PROPOSED	JMA - MX08FR0665-20	NR	170°	90'-0"	SHARED W/ALPHA	FUJITSU - TA08025-B605	MULTI	B2	SHARED W/ALPHA
B3		-	-		1		-			
C1							FUJITSU - TA08025-B604	MULTI	C2	
C2	PROPOSED	JMA - MX08FR0665-20	NR	300°	90'-0"	SHARED W/ALPHA	FUJITSU - TA08025-B605	MULTI	C2	SHARED W/ALPHA
С3]				

<u>NOTES</u>

- 1. CONTRACTOR TO REFER TO FINAL CONSTRUCTION RFDS FOR ALL RF DETAILS.
- ANTENNA AND RRH MODELS MAY CHANGE DUE TO EQUIPMENT AVAILABILITY. ALL EQUIPMENT CHANGES MUST BE APPROVED AND REMAIN IN COMPLIANCE WITH THE PROPOSED DESIGN AND STRUCTURAL ANALYSES.
- 3. VERIFY AZIMUTHS WITH LATEST DISH RFDS PRIOR TO INSTALLATION.

ANTENNA SCHEDULE

NO SCALE

3/4"=1'-0"

dësh wireless.

5701 SOUTH SANTA FE DRIVE LITTLETON, CO 80120

ULLERTON

I 100 E. WOODFIELD ROAD, SUITE 500 SCHAUMBURG, ILLINOIS 60173 TEL: 847-908-8400 www.FullertonEngineering.com



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DRAWN BY:	CHECKED BY:	APPROVED BY:		
JES	CJ	CJ		
PEDS PEV	# .	2		

CONSTRUCTION DOCUMENTS

SUBMITTALS						
REV	DATE	DESCRIPTION				
3	11/22/2022	LEASE AREA UPDATE				
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5	02/02/2023	JDX REVISION				
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7	04/19/2023	ADDED SURVEY				
8	05/24/2023	UTILITY REVISION				
9	07/28/2023	UTILITY REVISION				
	405.5	DO IEST NUMBER				

A&E PROJECT NUMBER 2021.0025.815755


DISH WIRELESS L.L.C.
PROJECT INFORMATION
SFSFO00115A
CA-CCI-T-815755
4900 SONOMA HWY.
SANTA ROSA, CA 95409


SHEET TITLE
ANTENNA LAYOUT
AND SCHEDULE


SHEET NUMBER

A-2.2

DISH WIRELESS L.L.C. TEMPLATE VERSION 37 - 07/09/2021

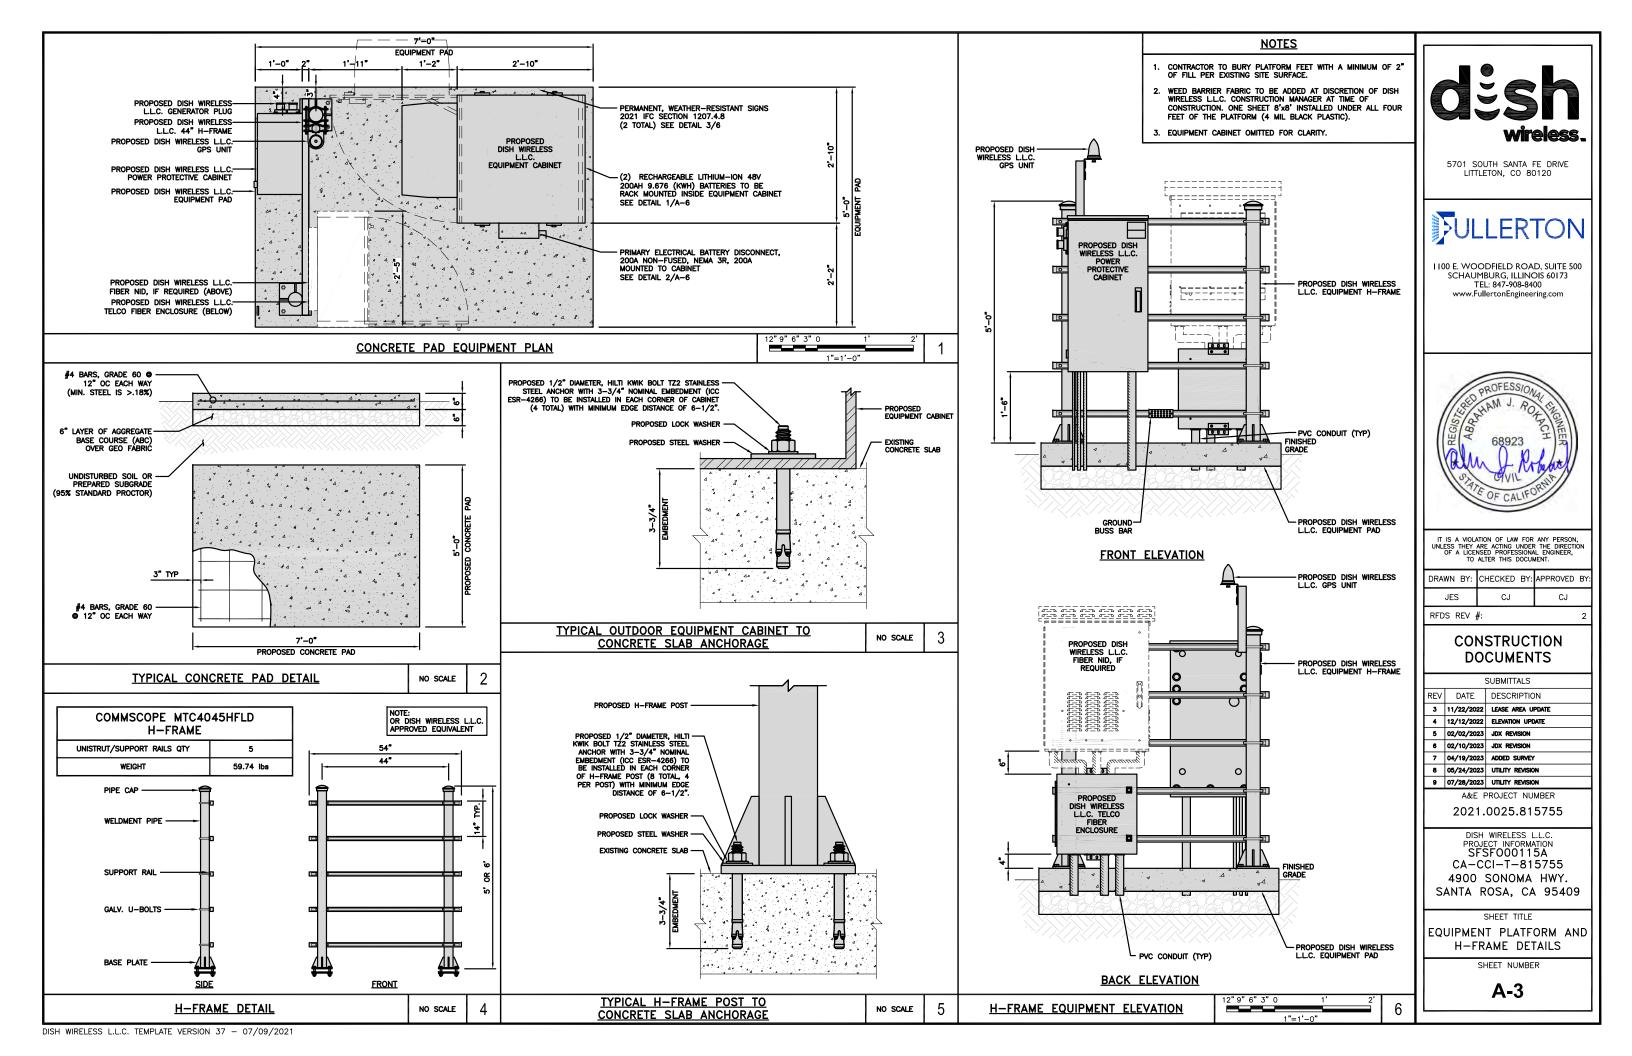

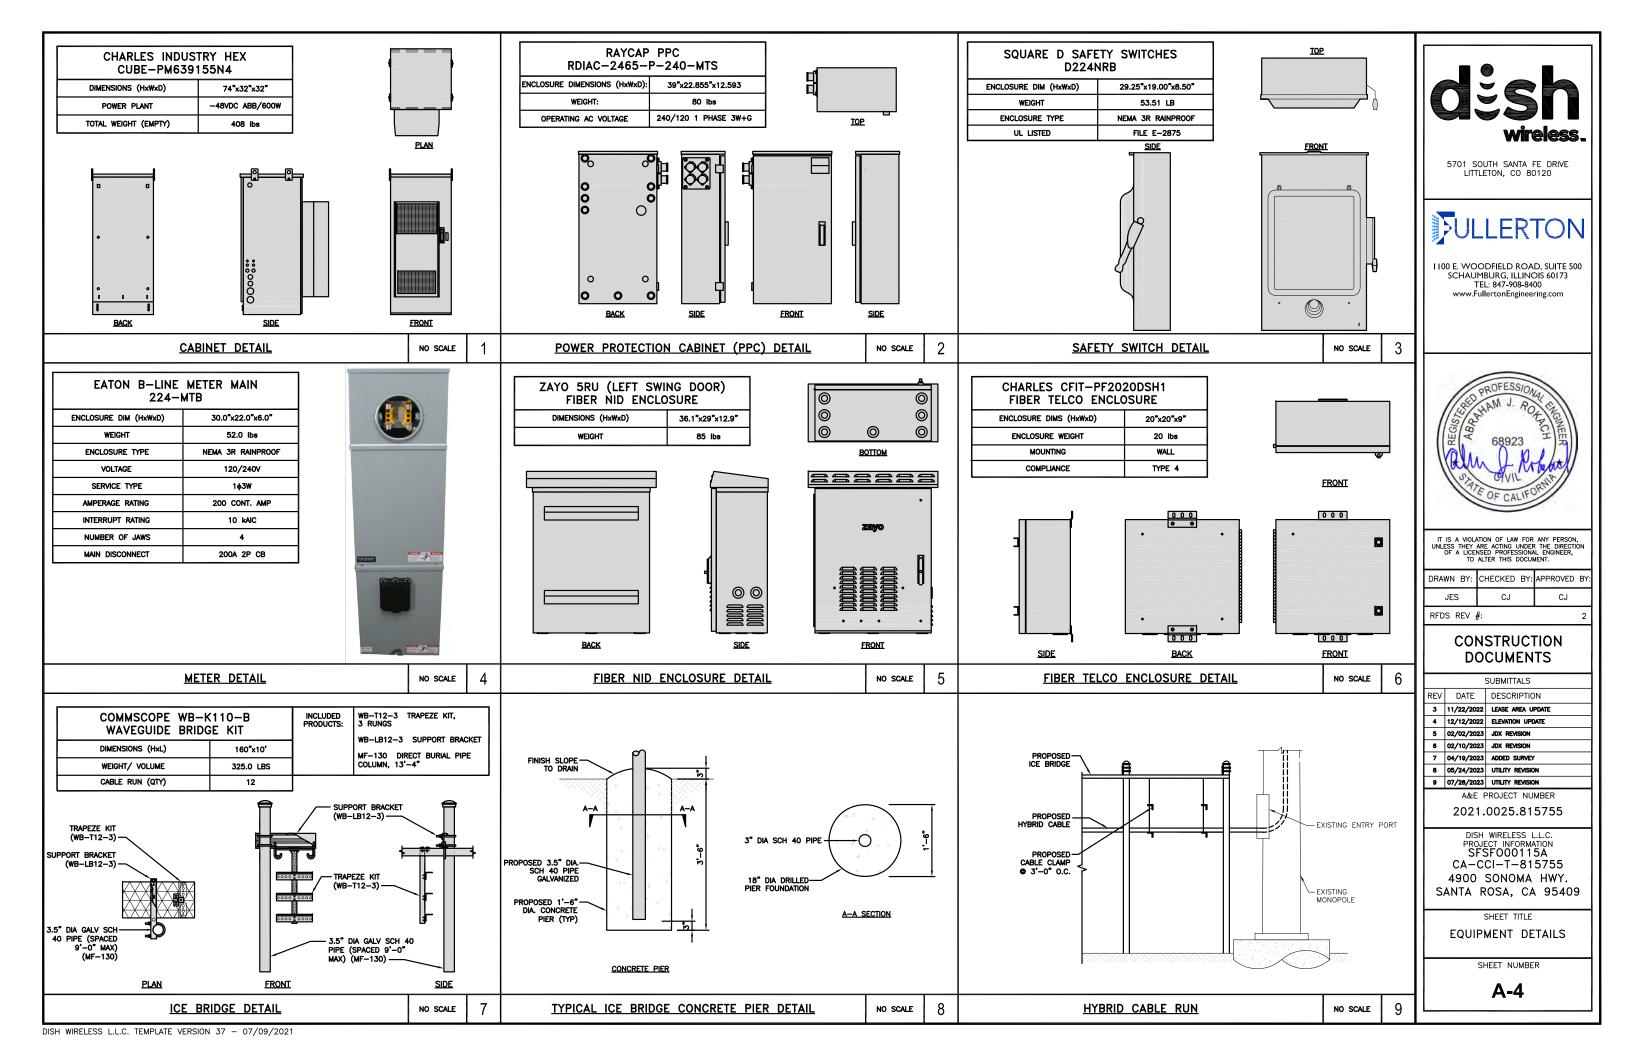

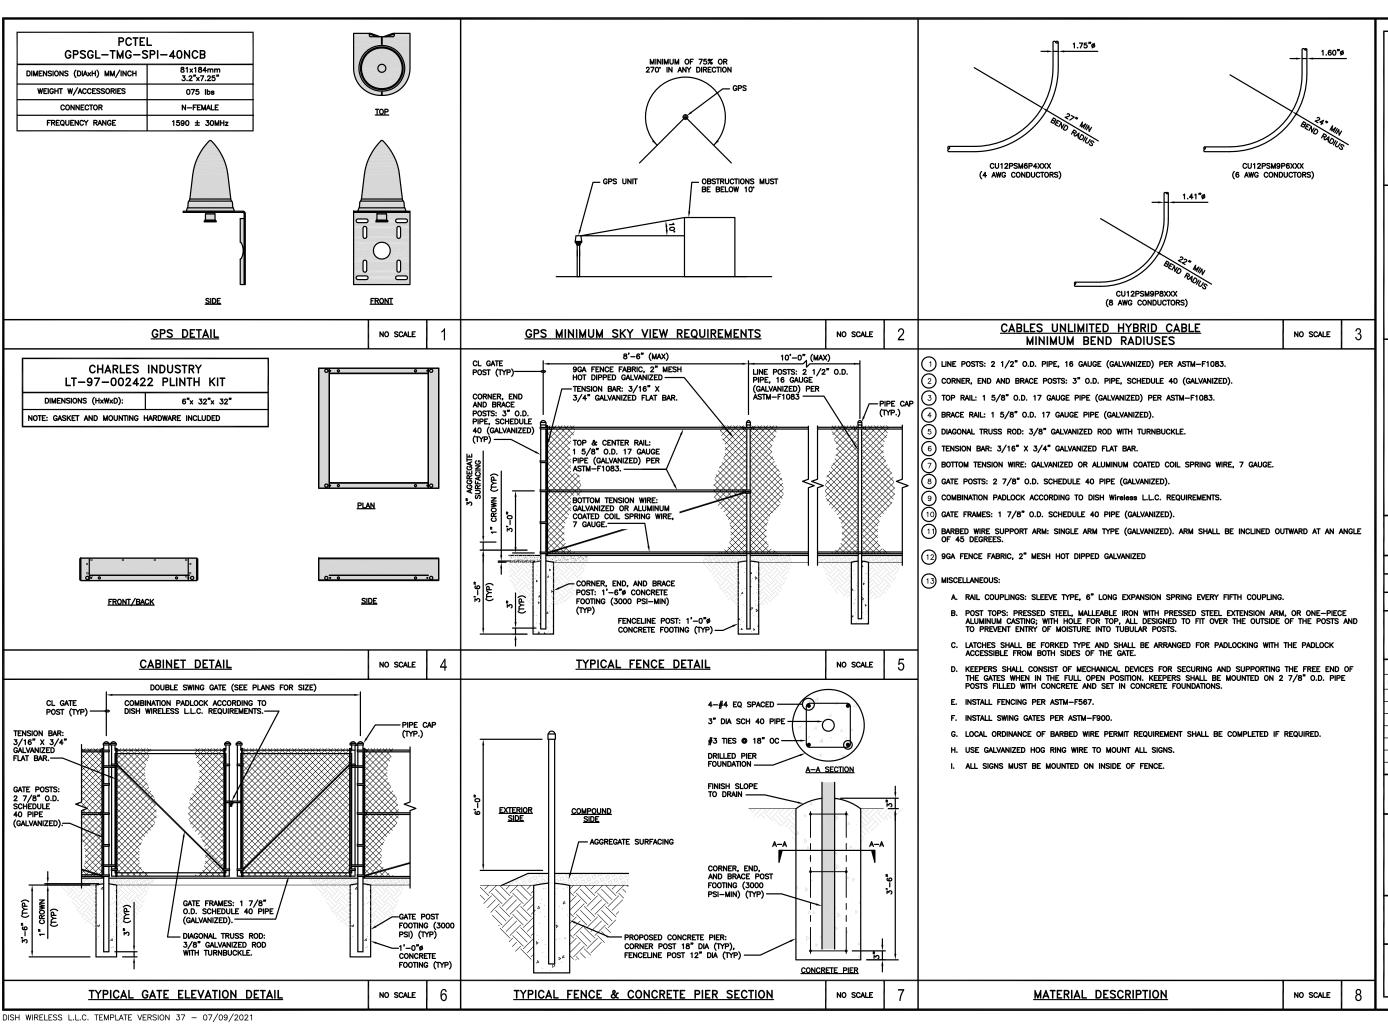

5701 SOUTH SANTA FE DRIVE LITTLETON, CO 80120

JULLERTON

1100 E. WOODFIELD ROAD, SUITE 500 SCHAUMBURG, ILLINOIS 60173 TEL: 847-908-8400 www.FullertonEngineering.com



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DRAWN BY:	CHECKED BY:	APPROVED BY:		
JES	CJ	Cl		
DEDG DEV	"			

CONSTRUCTION **DOCUMENTS**

	SUBMITTALS					
REV	DATE	DESCRIPTION				
3	11/22/2022	LEASE AREA UPDATE				
4	12/12/2022	ELEVATION UPDATE				
5	02/02/2023	JDX REVISION				
8	02/10/2023	JDX REVISION				
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8	05/24/2023	UTILITY REVISION				
9	07/28/2023	UTILITY REVISION				
	A&E F	PROJECT NUMBER				


2021.0025.815755

DISH WIRELESS L.L.C. PROJECT INFORMATION SFSF000115A CA-CCI-T-815755 4900 SONOMA HWY. SANTA ROSA, CA 95409

SHEET TITLE **EQUIPMENT DETAILS**

SHEET NUMBER

A-5

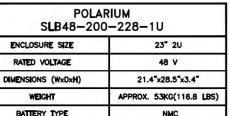


PATED ENERGY (kwh) PER BATTERY

BATTERY INFORMATION

- NUMBER OF BATTERIES = 2
- (2) BATT IN ECAB
- VOL ELECTROLYTE = 4.04 GALLON
- CLASSIFICATION = VRIA VALUE
REGULATED LEAD ACIO, HEALTH RATING
3, FIRE RATING 0. REACTIVE RATING 2
- MODEL# POLARIUM SLB48-200-228-1U



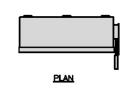




This area contains energized battery systems This area contains energized electrical circuits The battery electrolyte solutions are corrosive liquids No smoking, spark producing devices or flames



BATTERY STORAGE SYSTEM SIGN

I 100 E. WOODFIELD ROAD, SUITE 500 SCHAUMBURG, ILLINOIS 60173

9.676 KWH

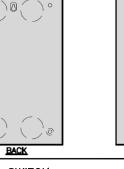

FRONT

COMPLIANCE SIGNAGE NO SCALE NO SCALE

5701 SOUTH SANTA FE DRIVE

LITTLETON, CO 80120

TEL: 847-908-8400 www.FullertonEngineering.com

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DRAWN BY:	CHECKED BY:	APPROVED BY:		
JES	CJ	CJ		
REDS REV	2			

CONSTRUCTION **DOCUMENTS**

ш	SUBMITTALS					
ı	REV	DATE	DESCRIPTION			
ı	3	11/22/2022	LEASE AREA UPDATE			
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2021.0025.815755


DISH WIRELESS L.L.C. PROJECT INFORMATION SFSF000115A CA-CCI-T-815755 4900 SONOMA HWY. SANTA ROSA, CA 95409


SHEET TITLE

EQUIPMENT DETAILS

SHEET NUMBER

A-6

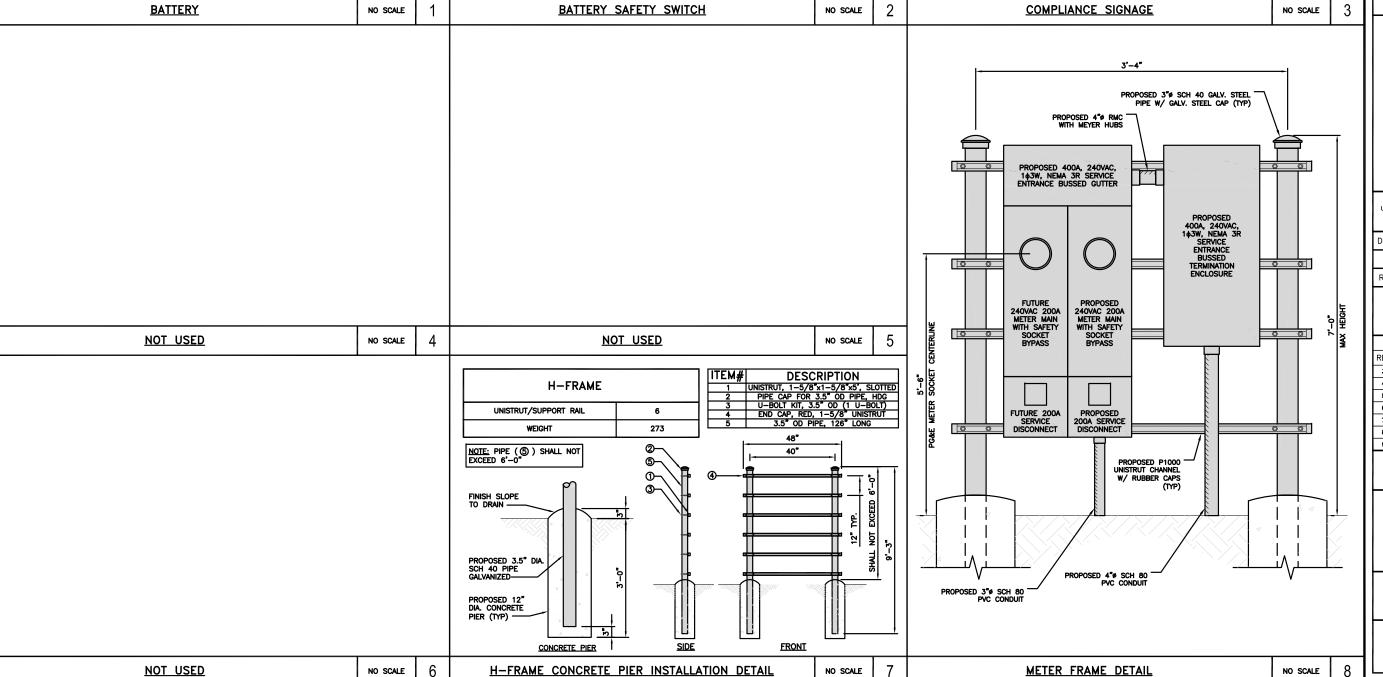

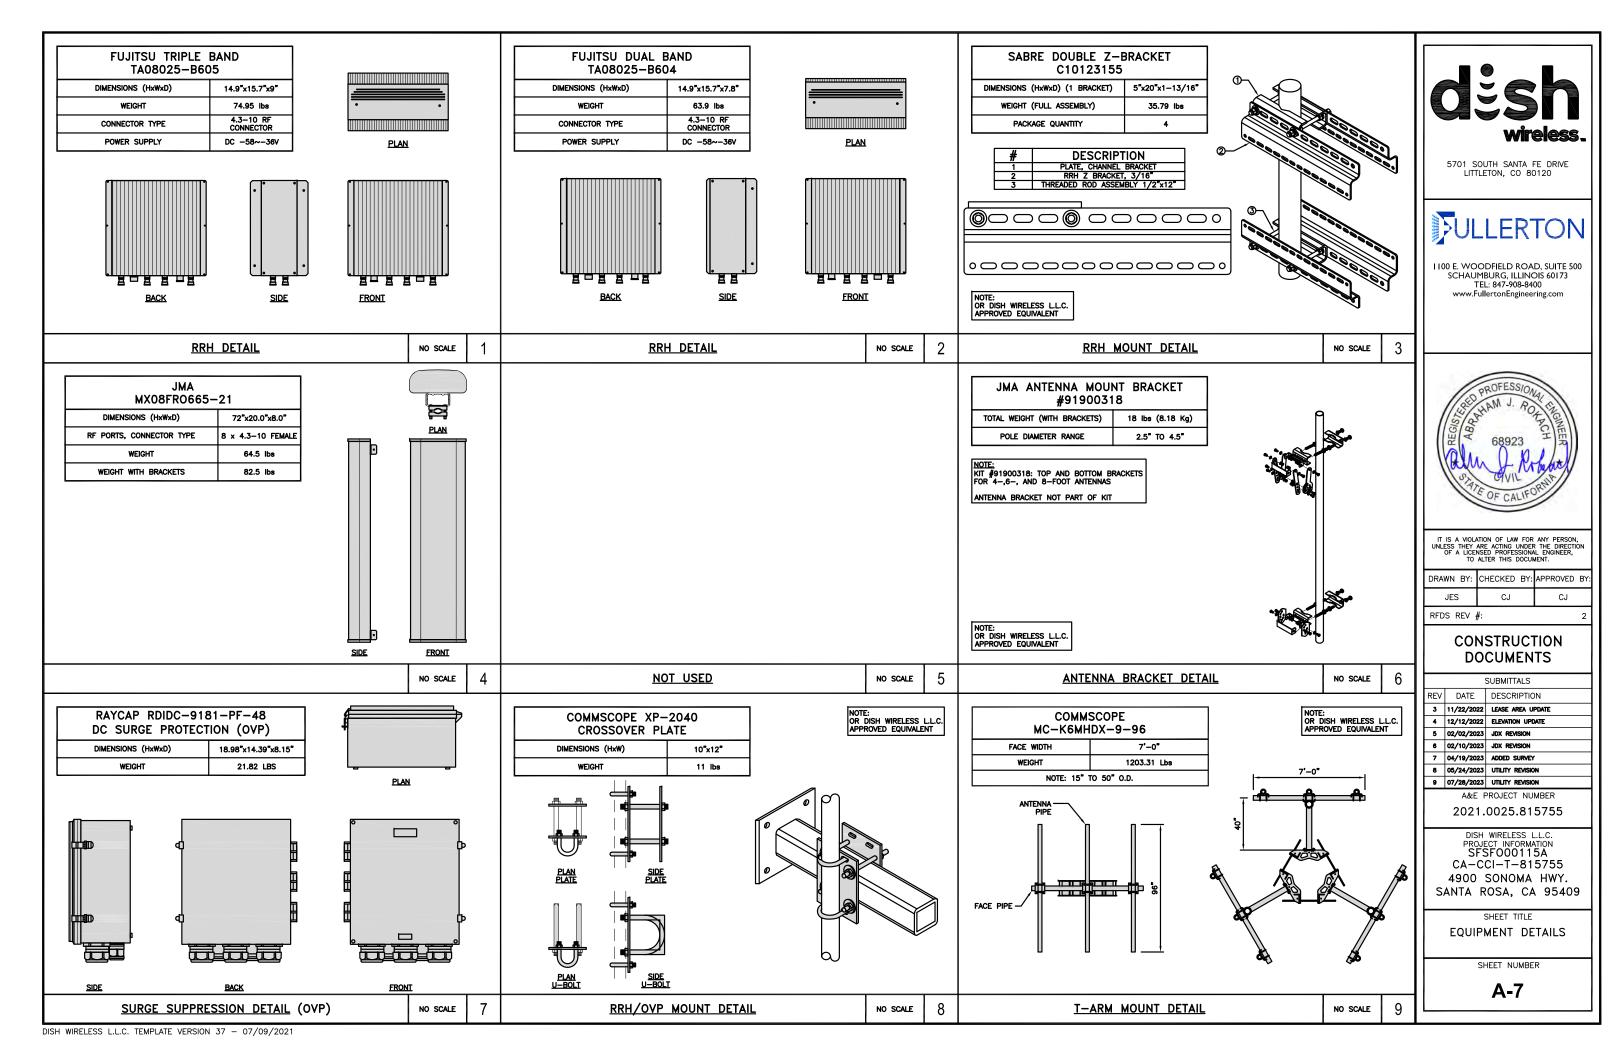

NOTES

CONTRACTOR SHALL FIELD VERIFY ALL PROPOSED UNDERGROUND UTILITY CONDUIT ROUTE.

ANTENNAS AND MOUNTS OMITTED FOR CLARITY.

DUE TO UTILITY EASEMENT RIGHTS SPECIFIED IN THE GROUND LEASE, CUSTOMER MAY INSTALL.

EQUIPMENT WITHIN SPECIFIED UTILITY EASEMENT AREA. "PWR" AND "FBR" PATHS DEPICTED ON

A-1 AND E-1 ARE BASED ON BEST AVAILABLE INFORMATION INCLUDING BUT NOT LIMITED TO

A SURVEY, EXHIBITS, MEETS AND BOUNDS OF THE UTILITY EASEMENT, FIELD VERIFICATION,
PRIOR PROJECT DOCUMENTATION, AND OTHER REAL PROPERTY RIGHTS DOCUMENTS. WHEN

INSTALLING THE UTILITIES, PLEASE LOCATE AND FOLLOW EXISTING PATH. IF EXISTING PATH IS

MATERIALLY INCONSISTENT WITH THE "PWR" AND "FBR" PATH DEPICTED ON A-1 AND E-1

AND SAID VARIANCE IS NOT NOTED ON COS. PLEASE NOTIFY CORE AS FURTHER AND SAID VARIANCE IS NOT NOTED ON CDs, PLEASE NOTIFY CCRE AS FURTHER COORDINATION MAY BE NEEDED.

EXISTING UTILITY POLE W/ TRANSFÓRMER EXISTING ACCESS AND UTILITY EASEMENT EXISTING CURB FUTURE-GENERATOR

(BY OTHERS)

PROPOSED OVERHEAD POWER TO SUPPORTING POLE BY UTILITY PROPOSED DISH WIRELESS L.L.C. COMPANY (LENGTH: 100'-0"±)

PROPOSED CHAIN-LINK FENCE WITH BARBED WIRE (BY OTHERS) MONOPOLE - EXISTING **ASPHALT**

> EXISTING UTILITY -EXISTING CABLE TRAY (TYP) EXISTING TREE

BRIDGE (TYP) -EXISTING TANK PROPOSED UNDERGROUND POWE CONDUIT FROM PROPOSED UTILITY
FRAME TO PROPOSED DISH EQUIRMENT (LENGTH: 80'-0"±) -proposed underground power conduit _erom_drop_pole_to_proposed transformer (LENGTH: 65'-0"±)

FIBER MMP: EXISTING POST WITH COMCAST PROPOSED UNDERGROUND FIBER CONDUIT FROM EXISTING POLE WITH WEATHERHEAD TO PROPOSED DISH EQUIPMENT (LENGTH: 70'-0"±)

PROPOSED BOLLARD (TYP.) PROPOSED TRANSFORMER ON CONCRETE PAD

- EXISTING WOOD FENCE EXISTING CHAIN-LINK

- EXISTING ICE

PROPOSED UNDERGROUND POWER CONDUIT FROM PROPOSED TRANSFORMER TO PROPOSED UTILITY FRAME FENCE PROPOSED UTILITY FRAME W/ 400A VERTICAL PULL SECTION AND HORIZONTAL HOT GUTTER AND (2) METER MAINS W/ TEST BYPASS AND 200A SERVICE DISCONNECT PROPOSED 10'-2" X 15'-4"

UTILITY ROUTE PLAN

TRANSFORMER CLEARANCE

3/16"=1'-0

EXISTING DROP

-EXISTING UTILITY EASEMENT

DC POWER WIRING SHALL BE COLOR CODED AT EACH END FOR IDENTIFYING $\pm 24V$ and $\pm 48V$ conductors. RED MARKINGS SHALL IDENTIFY $\pm 24V$ and blue markings shall identify $\pm 48V$.

- CONTRACTOR SHALL INSPECT THE EXISTING CONDITIONS PRIOR TO SUBMITTING A BID. ANY QUESTIONS ARISING DURING THE BID PERIOD IN REGARDS TO THE CONTRACTOR'S FUNCTIONS, THE SCOPE OF WORK, OR ANY OTHER ISSUE RELATED TO THIS PROJECT SHALL BE BROUGHT UP DURING THE BID PERIOD WITH THE PROJECT MANAGER FOR CLARIFICATION, NOT AFTER THE CONTRACT HAS BEEN AWARDED.
- ALL ELECTRICAL WORK SHALL BE DONE IN ACCORDANCE WITH CURRENT NATIONAL ELECTRICAL CODES AND ALL STATE AND LOCAL CODES, LAWS, AND ORDINANCES. PROVIDE ALL COMPONENTS AND WIRING SIZES AS REQUIRED TO MEET NEC STANDARDS.
- 3. LOCATION OF EQUIPMENT, CONDUIT AND DEVICES SHOWN ON THE DRAWINGS ARE APPROXIMATE AND SHALL BE COORDINATED WITH FIELD CONDITIONS PRIOR TO CONSTRUCTION.
- 4. CONDUIT ROUGH-IN SHALL BE COORDINATED WITH THE MECHANICAL EQUIPMENT TO AVOID LOCATION CONFLICTS. VERIFY WITH THE MECHANICAL EQUIPMENT CONTRACTOR AND COMPLY AS REQUIRED.
- 5. CONTRACTOR SHALL PROVIDE ALL BREAKERS, CONDUITS AND CIRCUITS AS REQUIRED FOR A COMPLETE SYSTEM.
- 6. CONTRACTOR SHALL PROVIDE PULL BOXES AND JUNCTION BOXES AS REQUIRED BY THE NEC ARTICLE 314.
- 7. CONTRACTOR SHALL PROVIDE ALL STRAIN RELIEF AND CABLE SUPPORTS FOR ALL CABLE ASSEMBLIES. INSTALLATION SHALL BE IN ACCORDANCE WITH MANUFACTURER'S SPECIFICATIONS AND RECOMMENDATIONS.
- 8. ALL DISCONNECTS AND CONTROLLING DEVICES SHALL BE PROVIDED WITH ENGRAVED PHENOLIC NAMEPLATES INDICATING EQUIPMENT CONTROLLED, BRANCH CIRCUITS INSTALLED ON, AND PANEL FIELD LOCATIONS FED FROM.
- INSTALL AN EQUIPMENT GROUNDING CONDUCTOR IN ALL CONDUITS PER THE SPECIFICATIONS AND NEC 250.
 THE EQUIPMENT GROUNDING CONDUCTORS SHALL BE BONDED AT ALL JUNCTION BOXES, PULL BOXES, AND ALL
 DISCONNECT SWITCHES, AND EQUIPMENT CABINETS.
- 10. ALL NEW MATERIAL SHALL HAVE A U.L. LABEL.
- 11. PANEL SCHEDULE LOADING AND CIRCUIT ARRANGEMENTS REFLECT POST-CONSTRUCTION EQUIPMENT.
- 12. CONTRACTOR SHALL BE RESPONSIBLE FOR AS-BUILT PANEL SCHEDULE AND SITE DRAWINGS.
- 13. ALL TRENCHES IN COMPOUND TO BE HAND DUG.

ELECTRICAL NOTES

NO SCALE

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DRAWN BY: CHECKED BY: APPROVED BY JES CJ CJ

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RFDS REV #

CONSTRUCTION **DOCUMENTS**

	SUBMITTALS								
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ı	6	02/10/2023	JDX REVISION						
П	7	04/19/2023	ADDED SURVEY						
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	9	07/28/2023	UTILITY REVISION						

A&E PROJECT NUMBER

2021.0025.815755

DISH WIRELESS L.L.C. PROJECT INFORMATION SFSF000115A CA-CCI-T-815755 4900 SONOMA HWY. SANTA ROSA, CA 95409

SHEET TITLE


ELECTRICAL/FIBER ROUTE PLAN AND NOTES


SHEET NUMBER

E-1

UTILITY ROUTE PLAN (OVERALL)

NO SCALE

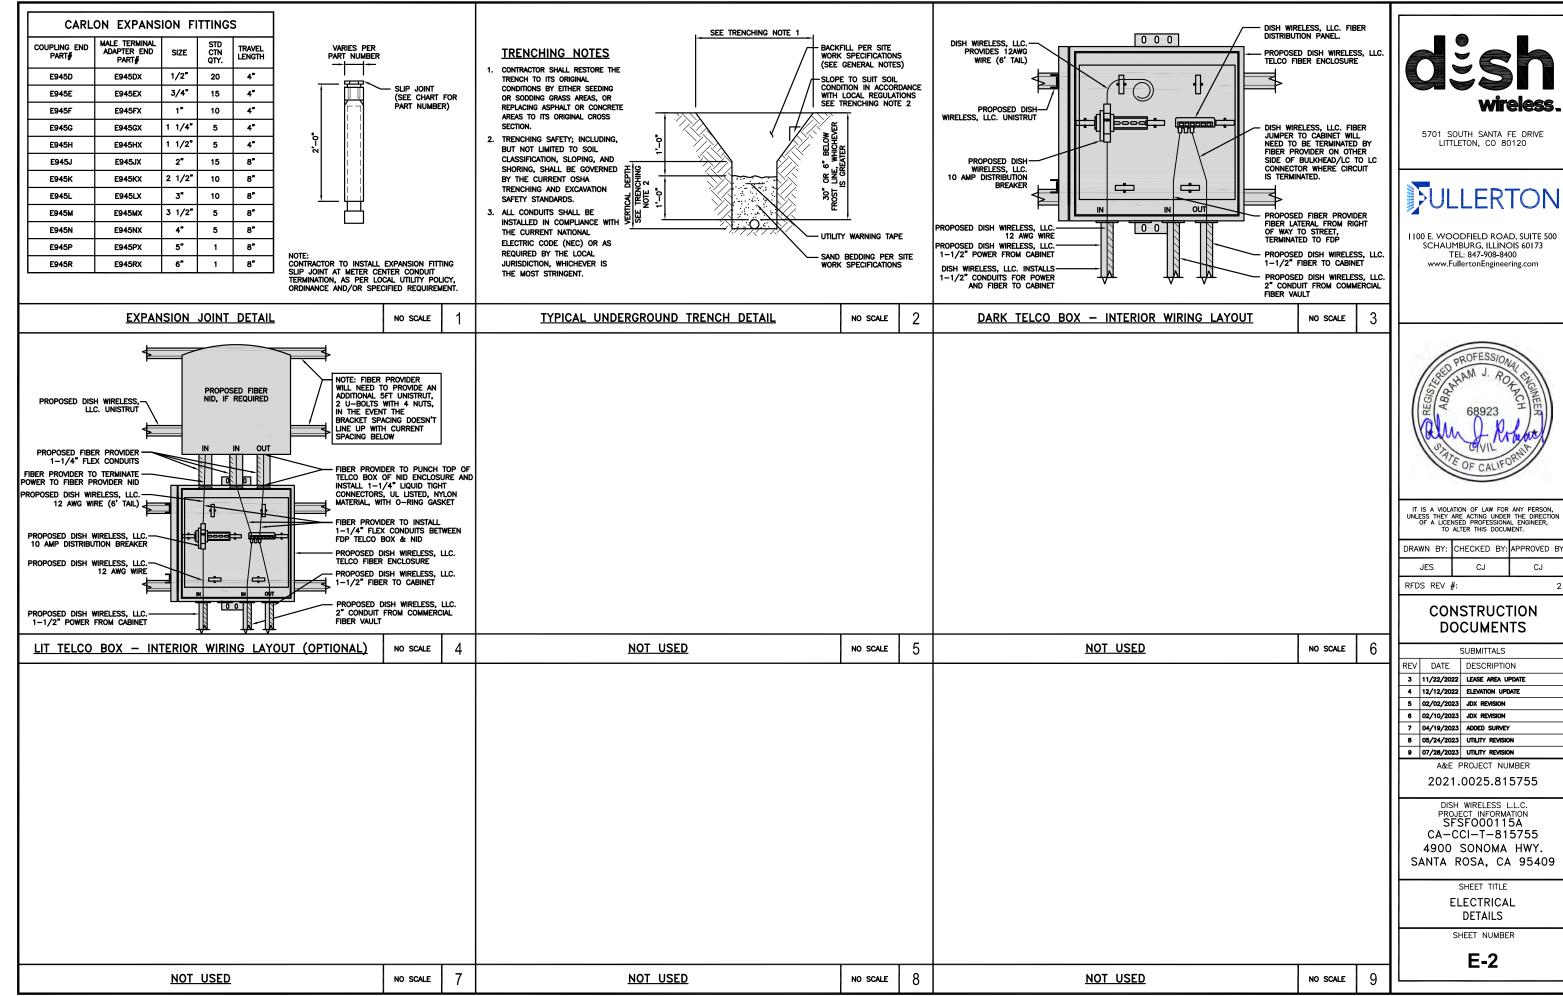

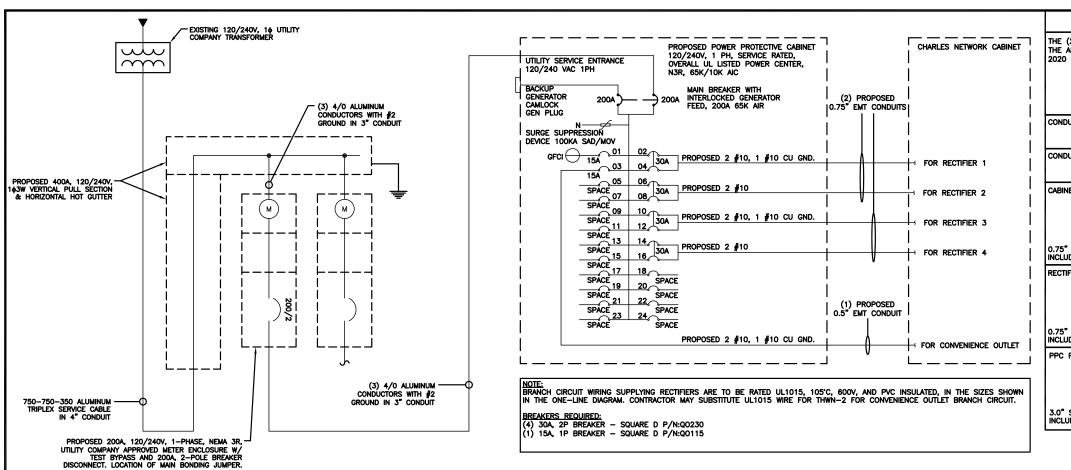

NOTES

THE (2) CONDUITS WITH (4) CURRENT CARRYING CONDUCTORS EACH, SHALL APPLY THE ADJUSTMENT FACTOR OF 80% PER 2014/17 NEC TABLE 310.15(B)(3)(α) OR 2020 NEC TABLE 310.15(C)(1) FOR UL1015 WIRE.

#12 FOR 15A-20A/1P BREAKER: 0.8 x 30A = 24.0A #10 FOR 25A-30A/2P BREAKER: 0.8 x 40A = 32.0A #8 FOR 35A-40A/2P BREAKER: 0.8 x 55A = 44.0A #6 FOR 45A-60A/2P BREAKER: 0.8 x 75A = 60.0A

CONDUIT SIZING: AT 40% FILL PER NEC CHAPTER 9, TABLE 4, ARTICLE 358. 0.5" CONDUIT - 0.122 SQ. IN AREA 0.75" CONDUIT - 0.213 SQ. IN AREA

CONDUIT SIZING: AT 40% FILL PER NEC CHAPTER 9, TABLE 4, ARTICLE 353. 2.0" CONDUIT - 1.316 SQ. IN AREA 3.0" CONDUIT - 2.907 SQ. IN AREA

CABINET CONVENIENCE OUTLET CONDUCTORS (1 CONDUIT): USING THWN-2, CU.

#10 - 0.0211 SQ. IN X 2 = 0.0422 SQ. IN #10 - 0.0211 SQ. IN X 1 = 0.0211 SQ. IN <GROUND = 0.0633 SQ. IN

0.75" EMT CONDUIT IS ADEQUATE TO HANDLE THE TOTAL OF (3) WIRES, INCLUDING GROUND WIRE, AS INDICATED ABOVE.

RECTIFIER CONDUCTORS (2 CONDUITS): USING UL1015, CU.

#10 - 0.0266 SQ. IN X 4 = 0.1064 SQ. IN #10 - 0.0082 SQ. IN X 1 = 0.0082 SQ. IN <BARE GROUND = 0.1146 SQ. IN


0.75" EMT CONDUIT IS ADEQUATE TO HANDLE THE TOTAL OF (5) WIRES, INCLUDING GROUND WIRE, AS INDICATED ABOVE.

PPC FEED CONDUCTORS (1 CONDUIT): USING THWN-2, AL.

#4/0 - 0.3237 SQ. IN X 3 = 0.9711 SQ. IN #2 - 0.1158 SQ. IN X 1 = 0.1158 SQ. IN <GROUND = 1.0869 SQ. IN

3.0" SCH 40 PVC CONDUIT IS ADEQUATE TO HANDLE THE TOTAL OF (4) WIRES, INCLUDING GROUND WIRE, AS INDICATED ABOVE.

PPC ONE-LINE DIAGRAM NO SCALE

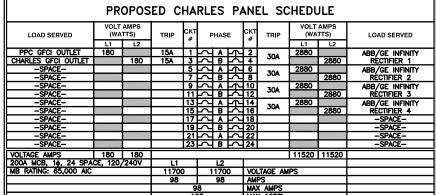

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	JES	CJ	CJ		
П	RFDS REV	#:	2		

CONSTRUCTION **DOCUMENTS**

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DISH WIRELESS L.L.C. PROJECT INFORMATION SFSF000115A CA-CCI-T-815755 4900 SONOMA HWY. SANTA ROSA, CA 95409

SHEET TITLE

ELECTRICAL ONE-LINE, FAULT CALCS & PANEL SCHEDULE

SHEET NUMBER

E-3

LOAD SERVED		AMPS TTS)	TRIP	скт #	١,	HAS	E	СКТ	TRIP		AMPS TTS)	LOAD SERVED
	L1	L2	1	#				#		L1	L2	
PPC GFCI OUTLET	180		15A	1	7	Α	1	2	30A	2880		ABB/GE INFINITY
CHARLES GFCI OUTLET		180	15A	3	չ	В	\sim	4	JUA		2880	RÉCTIFIER 1
-SPACE-				5	ζ	A	ł	6	30A	2880		ABB/GE INFINITY
-SPACE-				7	ζ	ø	$^{\sim}$	8	JUA		2880	RÉCTIFIER 2
-SPACE-				9	ረ	4	4	10	30A	2880		ABB/GE INFINITY
-SPACE-				11	ζ	۵	Σ	12	JUA		2880	RÉCTIFIER 3
-SPACE-				13	ζ	۲	4	14	30A	2880		ABB/GE INFINITY
-SPACE-					ζ				JUA		2880	RÉCTIFIER 4
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VOLTAGE AMPS	180	180								11520	11520	
200A MCB, 1¢, 24 SP/	ACE, 120,	/240V	L1			L2						
MB RATING: 65,000 AIC			1170	0	1	170	0	VOI	TAGE AM	IPS		
			98			98		AMI	PS .			
				٤	98			MAX	AMPS			
				1:	23			MAX	125%			


PANEL SCHEDULE

NO SCALE

2

NOT USED

NO SCALE

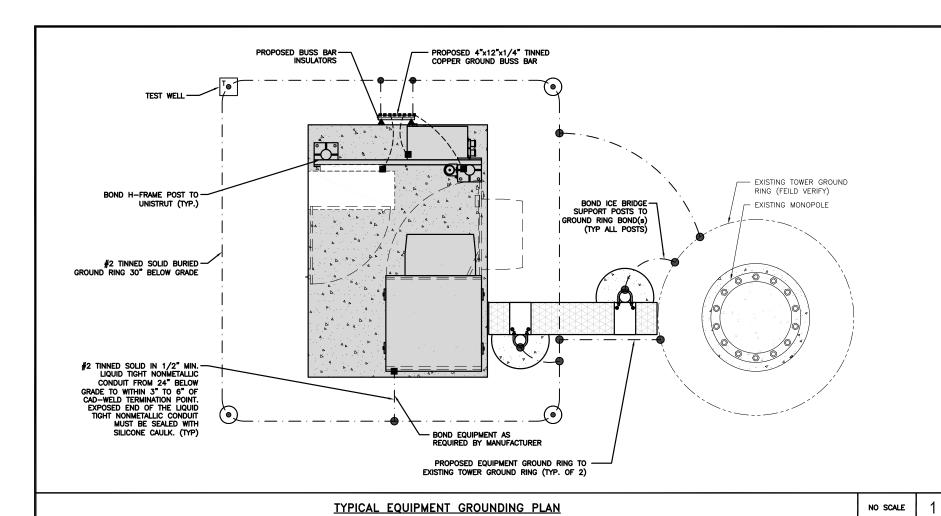

<u>NOTES</u>

NOTES

ANTENNAS AND OVP SHOWN ARE GENERIC AND NOT REFERENCING TO A SPECIFIC MANUFACTURER. THIS LAYOUT IS FOR REFERENCE PURPOSES ONLY EXOTHERMIC CONNECTION
 MECHANICAL CONNECTION

GROUND BUS BAR

GROUND ROD


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•1

TEST GROUND ROD WITH INSPECTION SLEEVE



---- #6 AWG STRANDED & INSULATED

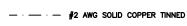

BUSS BAR INSULATOR

GROUNDING LEGEND

- 1. GROUNDING IS SHOWN DIAGRAMMATICALLY ONLY.
- CONTRACTOR SHALL GROUND ALL EQUIPMENT AS A COMPLETE SYSTEM, GROUNDING SHALL BE IN COMPLIANCE WITH NEC SECTION 250 AND DISH WIRELESS, LLC. GROUNDING AND BONDING REQUIREMENTS AND MANUFACTURER'S SPECIFICATIONS.
- 3. ALL GROUND CONDUCTORS SHALL BE COPPER; NO ALUMINUM CONDUCTORS SHALL BE USED.

GROUNDING KEY NOTES

- (A) EXTERIOR GROUND RING: #2 AWG SOLID COPPER, BURIED AT A DEPTH OF AT LEAST 30 INCHES BELOW GRADE, OR 6 INCHES BELOW THE FROST LINE AND APPROXIMATELY 24 INCHES FROM THE EXTERIOR WALL OR FOOTING.
- B TOWER GROUND RING: THE GROUND RING SYSTEM SHALL BE INSTALLED AROUND AN ANTENNA TOWER'S LEGS, AND/OR GUY ANCHORS. WHERE SEPARATE SYSTEMS HAVE BEEN PROVIDED FOR THE TOWER AND THE BUILDING, AT LEAST TWO BONDS SHALL BE MADE BETWEEN THE TOWER RING GROUND SYSTEM AND THE BUILDING RING GROUND SYSTEM USING MINIMUM #2 AWG SOLID COPPER CONDUCTORS.
- © INTERIOR GROUND RING: #2 AWG STRANDED GREEN INSULATED COPPER CONDUCTOR EXTENDED AROUND THE PERIMETER OF THE EQUIPMENT AREA. ALL NON—TELECOMMUNICATIONS RELATED METALLIC OBJECTS FOUND WITHIN A SITE SHALL BE GROUNDED TO THE INTERIOR GROUND RING WITH #6 AWG STRANDED GREEN INSULATED CONDUCTOR.
- D BOND TO INTERIOR GROUND RING: #2 AWG SOLID TINNED COPPER WIRE PRIMARY BONDS SHALL BE PROVIDED AT LEAST AT FOUR POINTS ON THE INTERIOR GROUND RING, LOCATED AT THE CORNERS OF THE RIUI DING.
- (E) GROUND ROD: UL LISTED COPPER CLAD STEEL. MINIMUM 1/2" DIAMETER BY EIGHT FEET LONG. GROUND RODS SHALL BE INSTALLED WITH INSPECTION SLEEVES. GROUND RODS SHALL BE DRIVEN TO THE DEPTH OF GROUND RING CONDUCTOR.
- F CELL REFERENCE GROUND BAR: POINT OF GROUND REFERENCE FOR ALL COMMUNICATIONS EQUIPMENT FRAMES. ALL BONDS ARE MADE WITH #2 AWG UNLESS NOTED OTHERWISE STRANDED GREEN INSULATED COPPER CONDUCTORS. BOND TO GROUND RING WITH (2) #2 SOLID TINNED COPPER CONDUCTORS.
- (3) HATCH PLATE GROUND BAR: BOND TO THE INTERIOR GROUND RING WITH TWO #2 AWG STRANDED GREEN INSULATED COPPER CONDUCTORS. WHEN A HATCH-PLATE AND A CELL REFERENCE GROUND BAR ARE BOTH PRESENT, THE CRGB MUST BE CONNECTED TO THE HATCH-PLATE AND TO THE INTERIOR GROUND RING USING (2) TWO #2 AWG STRANDED GREEN INSULATED COPPER CONDUCTORS EACH.
- H EXTERIOR CABLE ENTRY PORT GROUND BARS: LOCATED AT THE ENTRANCE TO THE CELL SITE BUILDING. BOND TO GROUND RING WITH A #2 AWG SOLID TINNED COPPER CONDUCTORS WITH AN EXOTHERMIC WELD AND INSPECTION SLEEVE.
- 1 TELCO GROUND BAR: BOND TO BOTH CELL REFERENCE GROUND BAR OR EXTERIOR GROUND RING.
- (K) INTERIOR UNIT BONDS: METAL FRAMES, CABINETS AND INDIVIDUAL METALLIC UNITS LOCATED WITH THE AREA OF THE INTERIOR GROUND RING REQUIRE A #6 AWG STRANDED GREEN INSULATED COPPER BOND TO THE INTERIOR GROUND RING.
- L FENCE AND GATE GROUNDING: METAL FENCES WITHIN 7 FEET OF THE EXTERIOR GROUND RING OR OBJECTS BONDED TO THE EXTERIOR GROUND RING SHALL BE BONDED TO THE GROUND RING WITH A ∦2 AWG SOLID TINNED COPPER CONDUCTOR AT AN INTERVAL NOT EXCEEDING 25 FEET. BONDS SHALL BE MADE AT EACH GATE POST AND ACROSS GATE OPENINGS.
- M <u>Exterior unit bonds</u>; metallic objects, external to or mounted to the building, shall be bonded to the exterior ground ring. Using #2 tinned solid copper wire
- N ICE BRIDGE SUPPORTS: EACH ICE BRIDGE LEG SHALL BE BONDED TO THE GROUND RING WITH #2 AWG BARE TINNED COPPER CONDUCTOR. PROVIDE EXOTHERMIC WELDS AT BOTH THE ICE BRIDGE LEG AND BURIED
- DURING ALL DC POWER SYSTEM CHANGES INCLUDING DC SYSTEM CHANGE OUTS, RECTIFIER REPLACEMENTS OR ADDITIONS, BREAKER DISTRIBUTION CHANGES, BATTERY ADDITIONS, BATTERY REPLACEMENTS AND INSTALLATIONS OR CHANGES TO DC CONVERTER SYSTEMS IT SHALL BE REQUIRED THAT SERVICE CONTRACTORS VERIEY ALL DC POWER SYSTEMS ARE EQUIPPED WITH A MASTER DC SYSTEM RETURN GROUND CONDUCTOR FROM THE DC POWER SYSTEM COMMON RETURN BUS DIRECTLY CONNECTED TO THE CELL SITE REFERENCE GROUND BAR
- P TOWER TOP COLLECTOR BUSS BAR IS TO BE MECHANICALLY BONDED TO PROPOSED ANTENNA MOUNT COLLAR.

 REFER TO DISH WIRELESS, LLC. GROUNDING NOTES.

dësh wireless.

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JES CJ CJ	DRAWN BY:	CHECKED BY:	APPROVED BY:
	JES	CJ	CJ

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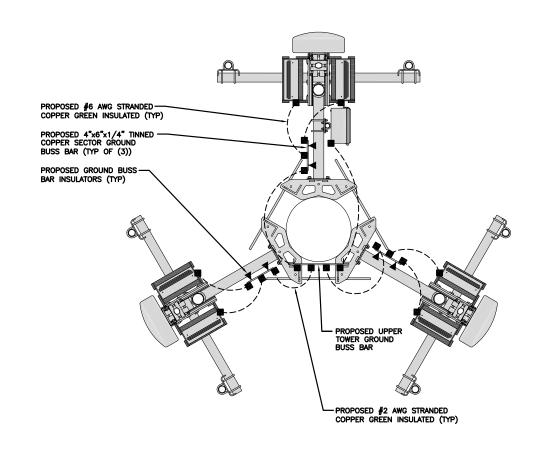
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PROJECT INFORMATION
SFSF000115A
CA-CCI-T-815755
4900 SONOMA HWY.
SANTA ROSA, CA 95409

SHEET TITLE

GROUNDING PLANS AND NOTES

SHEET NUMBER

G-1



TYPICAL ANTENNA GROUNDING PLAN


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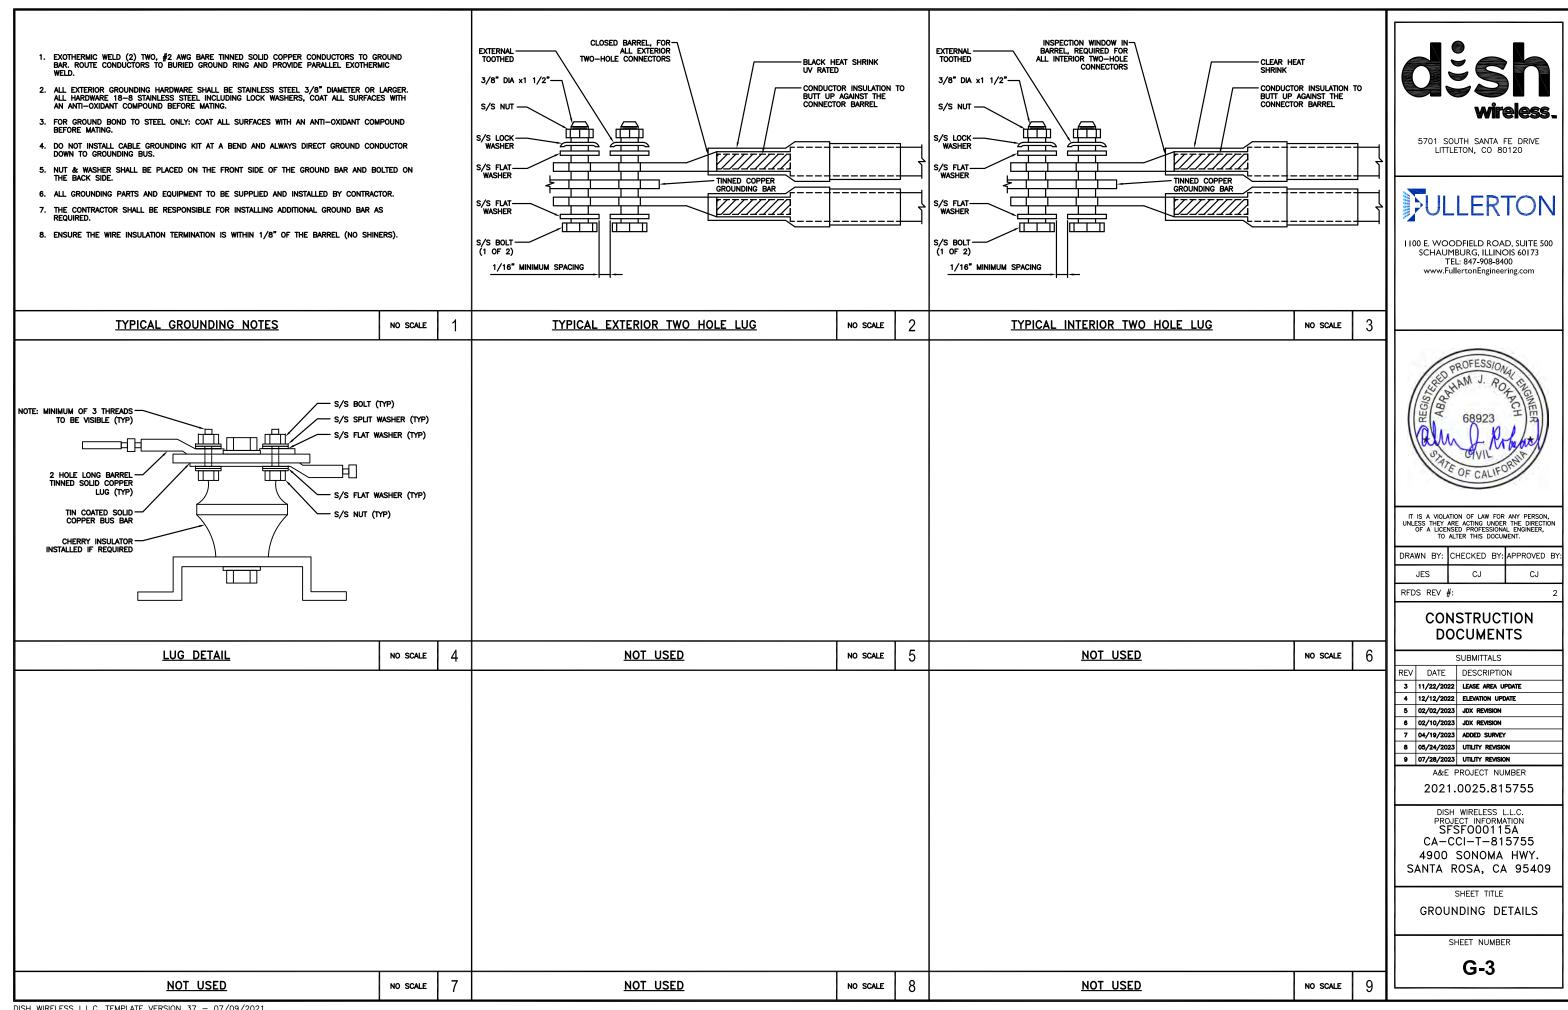
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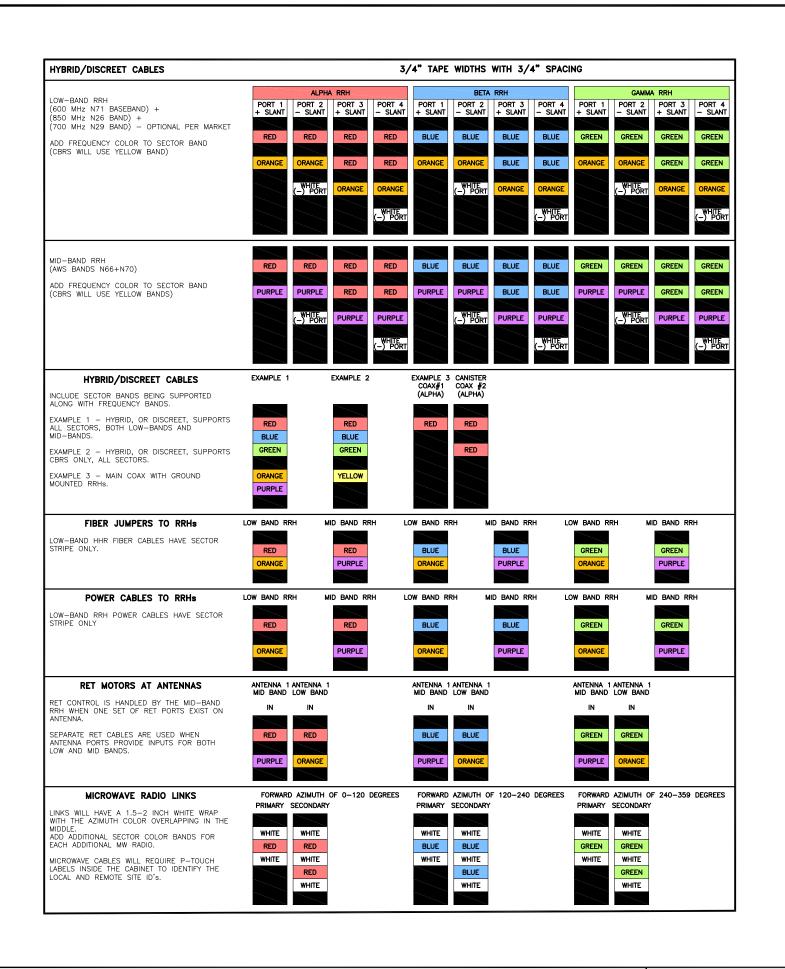
GROUNDING KEY NOTES


NO SCALE

G





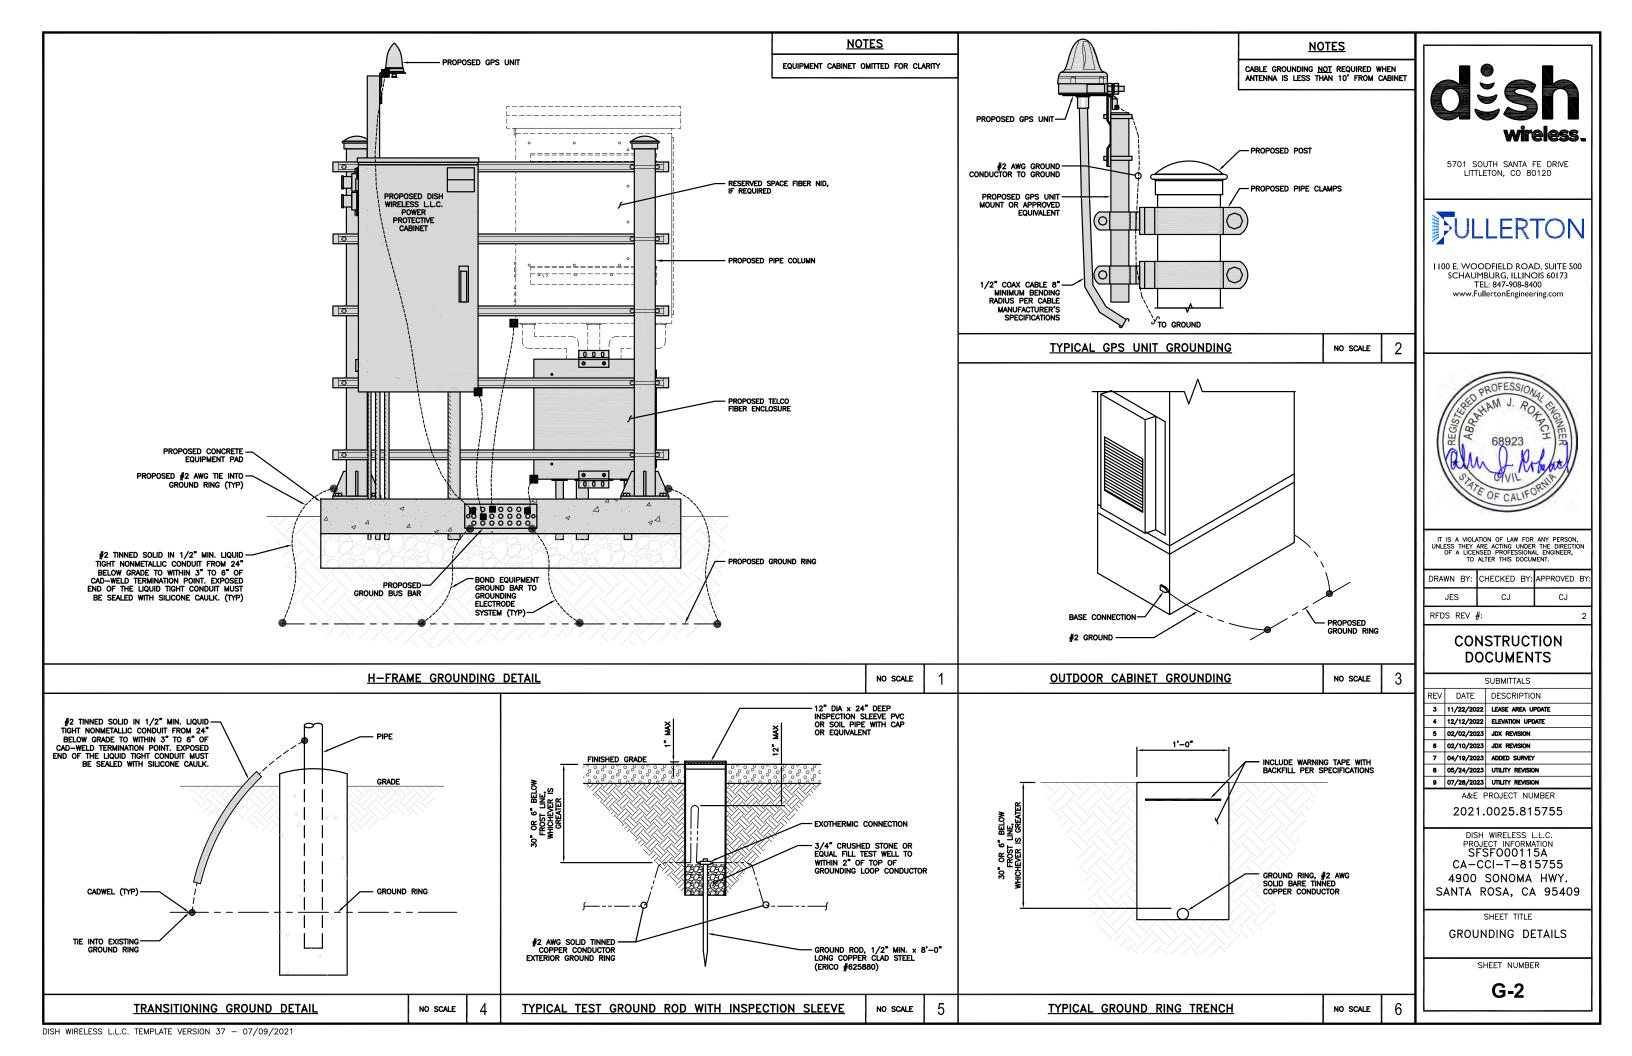

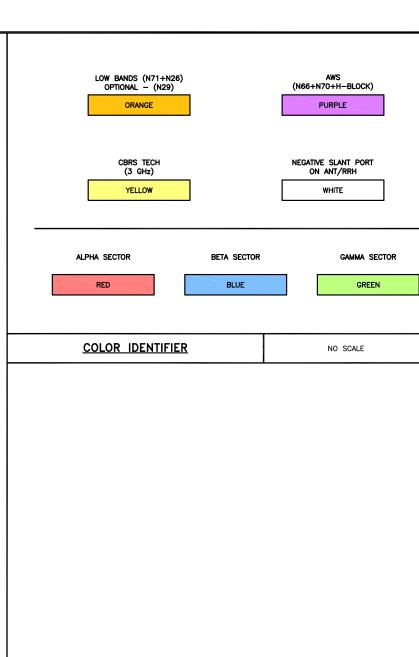

NO SCALE

NOT USED



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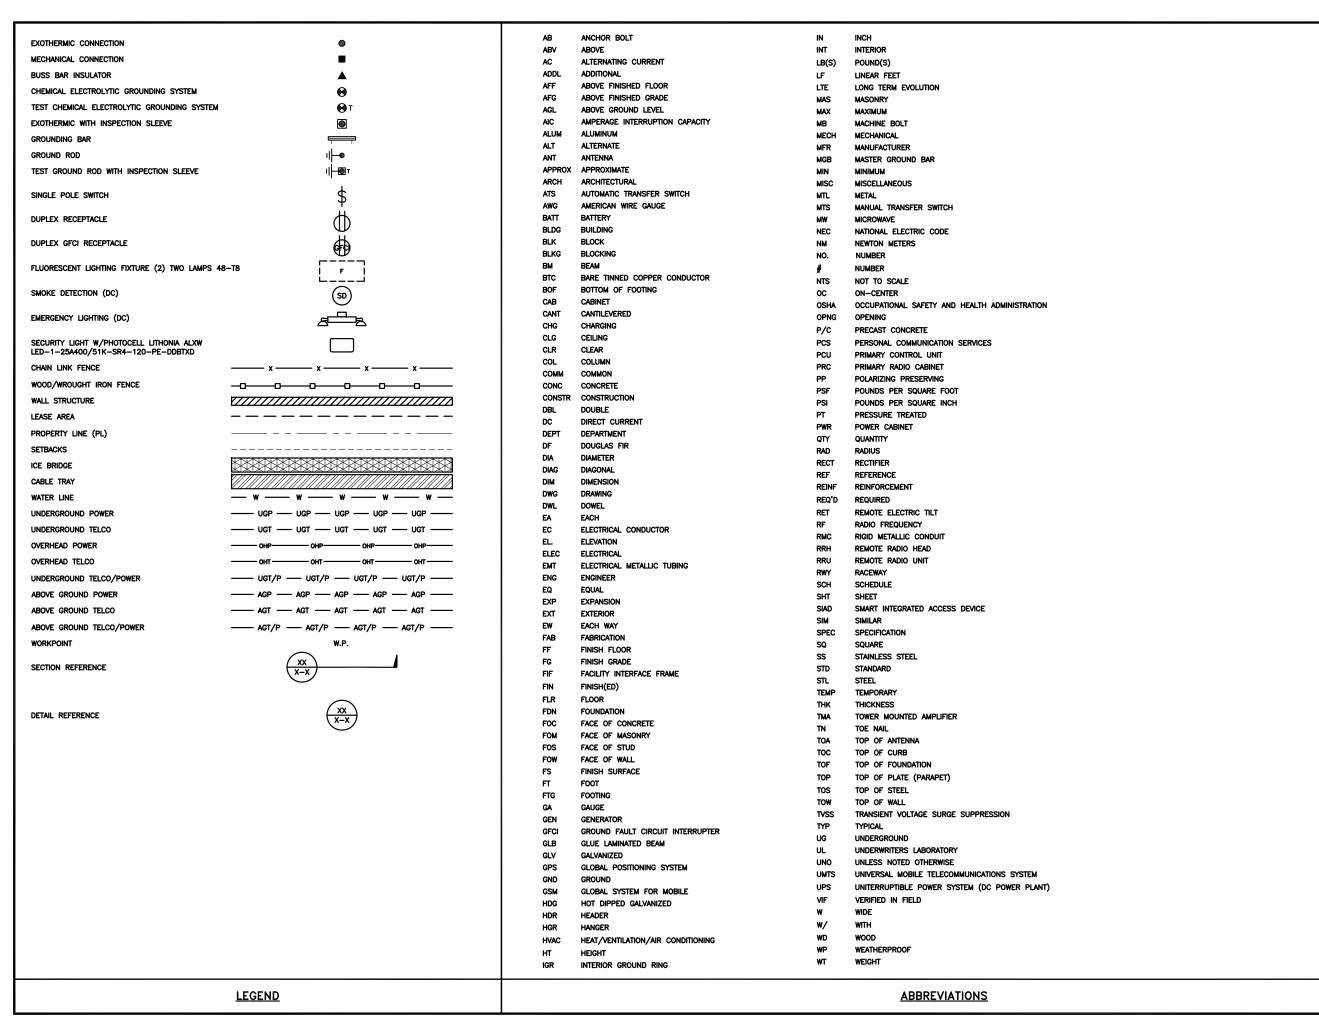
SHEET TITLE

RF

CABLE COLOR CODE

SHEET NUMBER

RF-1





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JES		CJ		CJ	

RFDS REV #:

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4900 SONOMA HWY.
SANTA ROSA, CA 95409

SHEET TITLE

LEGEND AND ABBREVIATIONS

SHEET NUMBER

	SIGN TYPES				
TYPE	COLOR	COLOR CODE PURPOSE			
INFORMATION	GREEN	"INFORMATIONAL SIGN" TO NOTIFY OTHERS OF SITE OWNERSHIP & CONTACT NUMBER AND POTENTIAL RF EXPOSURE.			
NOTICE	BLUE	"NOTICE BEYOND THIS POINT" RF FIELDS BEYOND THIS POINT MAY EXCEED THE FCC GENERAL PUBLIC EXPOSURE LIMIT. OBEY ALL POSTED SIGNS AND SITE GUIDELINES FOR WORKING IN RF ENVIRONMENTS. IN ACCORDANCE WITH FEDERAL COMMUNICATIONS COMMISSION RULES ON RADIO FREQUENCY EMISSIONS 47 CFR-1.1307(b)			
CAUTION	YELLOW	"CAUTION BEYOND THIS POINT" RF FIELDS BEYOND THIS POINT MAY EXCEED THE FCC GENERAL PUBLIC EXPOSURE LIMIT. OBEY ALL POSTED SIGNS AND SITE GUIDELINES FOR WORKING IN RF ENVIRONMENTS. IN ACCORDANCE WITH FEDERAL COMMUNICATIONS COMMISSION RULES ON RADIO FREQUENCY EMISSIONS 47 CFR-1.1307(b)			
WARNING	ORANGE/RED	"WARNING BEYOND THIS POINT" RF FIELDS AT THIS SITE EXCEED FOC RULES FOR HUMAN EXPOSURE. FAILURE TO OBEY ALL POSTED SIGNS AND SITE GUIDELINES FOR WORKING IN RF ENVIRONMENTS COULD RESULT IN SERIOUS INJURY. IN ACCORDANCE WITH FEDERAL COMMUNICATIONS COMMISSION RULES ON RADIO FREQUENCY EMISSIONS 47 CFR-1.1307(b)			

- RF SIGNAGE PLACEMENT SHALL FOLLOW THE RECOMMENDATIONS OF AN EXISTING EME REPORT, CREATED BY A THIRD PARTY PREVIOUSLY AUTHORIZED BY DISH Wireless L.L.C.
- INFORMATION SIGN (GREEN) SHALL BE LOCATED ON EXISTING DISH Wireless L.L.C EQUIPMENT.

 A) IF THE INFORMATION SIGN IS A STICKER, IT SHALL BE PLACED ON EXISTING DISH WIreless L.L.C EQUIPMENT CABINET.

 B) IF THE INFORMATION SIGH IS A METAL SIGN IT SHALL BE PLACED ON EXISTING DISH WIRELESS L.L.C H-FRAME WITH A SECURE ATTACH METHOD.
- IF EME REPORT IS NOT AVAILABLE AT THE TIME OF CREATION OF CONSTRUCTION DOCUMENTS; PLEASE CONTACT DISH Wireless L.L.C. CONSTRUCTION MANAGER FOR FURTHER INSTRUCTION ON HOW TO PROCEED.

- 1. FOR DISH Wireless L.L.C. LOGO. SEE DISH Wireless L.L.C. DESIGN SPECIFICATIONS (PROVIDED BY DISH Wireless L.L.C.)
- 2. SITE ID SHALL BE APPLIED TO SIGNS USING "LASER ENGRAVING" OR ANY OTHER WEATHER RESISTANT METHOD (DISH Wireless L.L.C. APPROVAL REQUIRED)
- 4. CABINET/SHELTER MOUNTING APPLICATION REQUIRES ANOTHER PLATE APPLIED TO THE FACE OF THE CABINET WITH WATER PROOF POLYURETHANE ADHESIVE
- 6. ALL SIGNS TO BE 8.5"x11" AND MADE WITH 0.04" OF ALUMINUM MATERIA

INFORMATION

This is an access point to an area with transmitting antennas.

Obey all signs and barriers beyond this point. Call the DISH Wireless L.L.C. NOC at 1-866-624-6874

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THIS SIGN IS FOR REFERENCE PURPOSES ONLY

NOTICE



Transmitting Antenna(s)

Radio frequency fields beyond this point MAY **EXCEED** the FCC Occupational exposure limit.

Obey all posted signs and site guidelines for working in radio frequency environments.

Call the DISH Wireless L.L.C. NOC at 1-866-624-6874 prior to working beyond this point.

dish

A CAUTION



Transmitting Antenna(s)

Radio frequency fields beyond this point MAY **EXCEED** the FCC Occupational exposure limit.

Obey all posted signs and site guidelines for working in radio frequency environments.

Call the DISH Wireless L.L.C. NOC at 1-866-624-6874 prior to working beyond this point.

dish



Transmitting Antenna(s)

Radio frequency fields beyond this point **EXCEED** the FCC Occupational exposure limit.

Obey all posted signs and site guidelines for working in radio frequency environments.

Call the DISH Wireless L.L.C. NOC at 1-866-624-6874 prior to working beyond this point.

dish

5701 SOUTH SANTA FE DRIVE LITTLETON, CO 80120



I 100 E. WOODFIELD ROAD, SUITE 500 SCHAUMBURG, ILLINOIS 60173 TEL: 847-908-8400



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	JES	CJ	CJ

CONSTRUCTION **DOCUMENTS**

	(SUBMITTALS	
REV	DATE	DESCRIPTION	
3	11/22/2022	LEASE AREA UPDATE	
4	12/12/2022	ELEVATION UPDATE	
5	02/02/2023	JDX REVISION	
6	02/10/2023	JDX REVISION	
7	04/19/2023	ADDED SURVEY	
8	05/24/2023	UTILITY REVISION	
9	07/28/2023	UTILITY REVISION	
	A&E F	PROJECT NUMBER	Ī

2021.0025.815755

PROJECT INFORMATION SFSF000115A CA-CCI-T-815755 4900 SONOMA HWY. SANTA ROSA, CA 95409

> SHEET TITLE GENERAL NOTES

SHEET NUMBER

GN-2

RF SIGNAGE

SITE ACTIVITY REQUIREMENTS:

- 1. NOTICE TO PROCEED NO WORK SHALL COMMENCE PRIOR TO CONTRACTOR RECEIVING A WRITTEN NOTICE TO PROCEED (NTP) AND THE ISSUANCE OF A PURCHASE ORDER. PRIOR TO ACCESSING/ENTERING THE SITE YOU MUST CONTACT THE DISH Wireless L.L.C. AND TOWER OWNER NOC & THE DISH Wireless L.L.C. AND TOWER OWNER CONSTRUCTION MANAGER.
- "LOOK UP" DISH Wireless L.L.C. AND TOWER OWNER SAFETY CLIMB REQUIREMENT:

THE INTEGRITY OF THE SAFETY CLIMB AND ALL COMPONENTS OF THE CLIMBING FACILITY SHALL BE CONSIDERED DURING ALL STAGES OF DESIGN, INSTALLATION, AND INSPECTION. TOWER MODIFICATION, MOUNT REINFORCEMENTS, AND/OR EQUIPMENT INSTALLATIONS SHALL NOT COMPROMISE THE INTEGRITY OR FUNCTIONAL USE OF THE SAFETY CLIMB OR ANY COMPONENTS OF THE CLIMBING FACILITY ON THE STRUCTURE. THIS SHALL INCLUDE, BUT NOT BE LIMITED TO: PINCHING OF THE WIRE ROPE, BENDING OF THE WIRE ROPE FROM ITS SUPPORTS, DIRECT CONTACT OR CLOSE PROXIMITY TO THE WIRE ROPE WHICH MAY CAUSE FRICTIONAL WEAR, IMPACT TO THE ANCHORAGE POINTS IN ANY WAY, OR TO IMPEDE/BLOCK ITS INTENDED USE. ANY COMPROMISED SAFETY CLIMB, INCLUDING EXISTING CONDITIONS MUST BE TAGGED OUT AND REPORTED TO YOUR DISH WIReless L.L.C. AND DISH WIReless L.L.C. AND TOWER OWNER POC OR CALL THE NOC TO GENERATE A SAFETY CLIMB MAINTENANCE AND CONTRACTOR NOTICE TICKET.

- 3. PRIOR TO THE START OF CONSTRUCTION, ALL REQUIRED JURISDICTIONAL PERMITS SHALL BE OBTAINED. THIS INCLUDES, BUT IS NOT LIMITED TO, BUILDING, ELECTRICAL, MECHANICAL, FIRE, FLOOD ZONE, ENVIRONMENTAL, AND ZONING. AFTER ONSITE ACTIVITIES AND CONSTRUCTION ARE COMPLETED, ALL REQUIRED PERMITS SHALL BE SATISFIED AND CLOSED OUT ACCORDING TO LOCAL JURISDICTIONAL REQUIREMENTS.
- 4. ALL CONSTRUCTION MEANS AND METHODS; INCLUDING BUT NOT LIMITED TO, ERECTION PLANS, RIGGING PLANS, CLIMBING PLANS, AND RESCUE PLANS SHALL BE THE RESPONSIBILITY OF THE GENERAL CONTRACTOR RESPONSIBLE FOR THE EXECUTION OF THE WORK CONTAINED HEREIN, AND SHALL MEET ANSI/ASSE A10.48 (LATEST EDITION); FEDERAL, STATE, AND LOCAL REGULATIONS; AND ANY APPLICABLE INDUSTRY CONSENSUS STANDARDS RELATED TO THE CONSTRUCTION ACTIVITIES BEING PERFORMED. ALL RIGGING PLANS SHALL ADHERE TO ANSI/ASSE A10.48 (LATEST EDITION) AND DISH WIRELESS L.L.C. AND TOWER OWNER STANDARDS, INCLUDING THE REQUIRED INVOLVEMENT OF A QUALIFIED ENGINEER FOR CLASS IV CONSTRUCTION, TO CERTIFY THE SUPPORTING STRUCTURE(S) IN ACCORDANCE WITH ANSI/TIA-322 (LATEST EDITION).
- 5. ALL SITE WORK TO COMPLY WITH DISH Wireless L.L.C. AND TOWER OWNER INSTALLATION STANDARDS FOR CONSTRUCTION ACTIVITIES ON DISH Wireless L.L.C. AND TOWER OWNER TOWER SITE AND LATEST VERSION OF ANSI/TIA-1019-A-2012 "STANDARD FOR INSTALLATION, ALTERATION, AND MAINTENANCE OF ANTENNA SUPPORTING STRUCTURES AND ANTENNAS."
- 6. IF THE SPECIFIED EQUIPMENT CAN NOT BE INSTALLED AS SHOWN ON THESE DRAWINGS, THE CONTRACTOR SHALL PROPOSE AN ALTERNATIVE INSTALLATION FOR APPROVAL BY DISH Wireless L.L.C. AND TOWER OWNER PRIOR TO PROCEEDING WITH ANY SUCH CHANGE OF INSTALLATION.
- 7. ALL MATERIALS FURNISHED AND INSTALLED SHALL BE IN STRICT ACCORDANCE WITH ALL APPLICABLE CODES, REGULATIONS AND ORDINANCES. CONTRACTOR SHALL ISSUE ALL APPROPRIATE NOTICES AND COMPLY WITH ALL LAWS, ORDINANCES, RULES, REGULATIONS AND LAWFUL ORDERS OF ANY PUBLIC AUTHORITY REGARDING THE PERFORMANCE OF THE WORK. ALL WORK CARRIED OUT SHALL COMPLY WITH ALL APPLICABLE MUNICIPAL AND UTILITY COMPANY SPECIFICATIONS AND LOCAL JURISDICTIONAL CODES, ORDINANCES AND APPLICABLE REGULATIONS.
- 8. THE CONTRACTOR SHALL INSTALL ALL EQUIPMENT AND MATERIALS IN ACCORDANCE WITH MANUFACTURER'S RECOMMENDATIONS UNLESS SPECIFICALLY STATED OTHERWISE.
- 9. THE CONTRACTOR SHALL CONTACT UTILITY LOCATING SERVICES INCLUDING PRIVATE LOCATES SERVICES PRIOR TO THE START OF CONSTRUCTION.
- 10. ALL EXISTING ACTIVE SEWER, WATER, GAS, ELECTRIC AND OTHER UTILITIES WHERE ENCOUNTERED IN THE WORK, SHALL BE PROTECTED AT ALL TIMES AND WHERE REQUIRED FOR THE PROPER EXECUTION OF THE WORK, SHALL BE RELOCATED AS DIRECTED BY CONTRACTOR. EXTREME CAUTION SHOULD BE USED BY THE CONTRACTOR WHEN EXCAVATING OR DRILLING PIERS AROUND OR NEAR UTILITIES. CONTRACTOR SHALL PROVIDE SAFETY TRAINING FOR THE WORKING CREW. THIS WILL INCLUDE BUT NOT BE LIMITED TO A) FALL PROTECTION B) CONFINED SPACE C) ELECTRICAL SAFETY D) TRENCHING AND EXCAVATION E) CONSTRUCTION SAFETY PROCEDURES.
- 11. ALL SITE WORK SHALL BE AS INDICATED ON THE STAMPED CONSTRUCTION DRAWINGS AND DISH PROJECT SPECIFICATIONS, LATEST APPROVED REVISION.
- 12. CONTRACTOR SHALL KEEP THE SITE FREE FROM ACCUMULATING WASTE MATERIAL, DEBRIS, AND TRASH AT THE COMPLETION OF THE WORK. IF NECESSARY, RUBBISH, STUMPS, DEBRIS, STICKS, STONES AND OTHER REFUSE SHALL BE REMOVED FROM THE SITE AND DISPOSED OF LEGALLY.
- 13. ALL EXISTING INACTIVE SEWER, WATER, GAS, ELECTRIC AND OTHER UTILITIES, WHICH INTERFERE WITH THE EXECUTION OF THE WORK, SHALL BE REMOVED AND/OR CAPPED, PLUGGED OR OTHERWISE DISCONTINUED AT POINTS WHICH WILL NOT INTERFERE WITH THE EXECUTION OF THE WORK, SUBJECT TO THE APPROVAL OF DISH Wireless L.L.C. AND TOWER OWNER, AND/OR LOCAL UTILITIES.
- 14. THE CONTRACTOR SHALL PROVIDE SITE SIGNAGE IN ACCORDANCE WITH THE TECHNICAL SPECIFICATION FOR SITE SIGNAGE REQUIRED BY LOCAL JURISDICTION AND SIGNAGE REQUIRED ON INDIVIDUAL PIECES OF EQUIPMENT, ROOMS, AND SHELTERS.
- 15. THE SITE SHALL BE GRADED TO CAUSE SURFACE WATER TO FLOW AWAY FROM THE CARRIER'S EQUIPMENT AND TOWER AREAS.
- 16. THE SUB GRADE SHALL BE COMPACTED AND BROUGHT TO A SMOOTH UNIFORM GRADE PRIOR TO FINISHED SURFACE APPLICATION.
- 17. THE AREAS OF THE OWNERS PROPERTY DISTURBED BY THE WORK AND NOT COVERED BY THE TOWER, EQUIPMENT OR DRIVEWAY, SHALL BE GRADED TO A UNIFORM SLOPE, AND STABILIZED TO PREVENT EROSION AS SPECIFIED ON THE CONSTRUCTION DRAWINGS AND/OR PROJECT SPECIFICATIONS.
- 18. CONTRACTOR SHALL MINIMIZE DISTURBANCE TO EXISTING SITE DURING CONSTRUCTION. EROSION CONTROL MEASURES, IF REQUIRED DURING CONSTRUCTION, SHALL BE IN CONFORMANCE WITH THE LOCAL GUIDELINES FOR EROSION AND SEDIMENT CONTROL.
- 19. THE CONTRACTOR SHALL PROTECT EXISTING IMPROVEMENTS, PAVEMENTS, CURBS, LANDSCAPING AND STRUCTURES. ANY DAMAGED PART SHALL BE REPAIRED AT CONTRACTOR'S EXPENSE TO THE SATISFACTION OF OWNER.
- 20. CONTRACTOR SHALL LEGALLY AND PROPERLY DISPOSE OF ALL SCRAP MATERIALS SUCH AS COAXIAL CABLES AND OTHER ITEMS REMOVED FROM THE EXISTING FACILITY. ANTENNAS AND RADIOS REMOVED SHALL BE RETURNED TO THE OWNER'S DESIGNATED LOCATION.
- 21. CONTRACTOR SHALL LEAVE PREMISES IN CLEAN CONDITION. TRASH AND DEBRIS SHOULD BE REMOVED FROM SITE ON A DAILY BASIS.
- 22. NO FILL OR EMBANKMENT MATERIAL SHALL BE PLACED ON FROZEN GROUND. FROZEN MATERIALS, SNOW OR ICE SHALL NOT BE PLACED IN ANY FILL OR EMBANKMENT.

GENERAL NOTES:

1.FOR THE PURPOSE OF CONSTRUCTION DRAWING, THE FOLLOWING DEFINITIONS SHALL APPLY:

CONTRACTOR: GENERAL CONTRACTOR RESPONSIBLE FOR CONSTRUCTION

CARRIER:DISH Wireless L.L.C.

TOWER OWNER:TOWER OWNER

- 2. THESE DRAWINGS HAVE BEEN PREPARED USING STANDARDS OF PROFESSIONAL CARE AND COMPLETENESS NORMALLY EXERCISED UNDER SIMILAR CIRCUMSTANCES BY REPUTABLE ENGINEERS IN THIS OR SIMILAR LOCALITIES. IT IS ASSUMED THAT THE WORK DEPICTED WILL BE PERFORMED BY AN EXPERIENCED CONTRACTOR AND/OR WORKPEOPLE WHO HAVE A WORKING KNOWLEDGE OF THE APPLICABLE CODE STANDARDS AND REQUIREMENTS AND OF INDUSTRY ACCEPTED STANDARD GOOD PRACTICE. AS NOT EVERY STANDARD GOOD PRACTICE FOR MISCELLANEOUS WORK NOT EXPLICITLY SHOWN.
- 3. THESE DRAWINGS REPRESENT THE FINISHED STRUCTURE. THEY DO NOT INDICATE THE MEANS OR METHODS OF CONSTRUCTION. THE CONTRACTOR SHALL BE SOLELY RESPONSIBLE FOR THE CONSTRUCTION MEANS, METHODS, TECHNIQUES, SEQUENCES, AND PROCEDURES. THE CONTRACTOR SHALL PROVIDE ALL MEASURES NECESSARY FOR PROTECTION OF LIFE AND PROPERTY DURING CONSTRUCTION. SUCH MEASURES SHALL INCLUDE, BUT NOT BE LIMITED TO, BRACING, FORMWORK, SHORING, ETC. SITE VISITS BY THE ENGINEER OR HIS REPRESENTATIVE WILL NOT INCLUDE INSPECTION OF THESE ITEMS AND IS FOR STRUCTURAL OBSERVATION OF THE FINISHED STRUCTURE ONLY.
- 4. NOTES AND DETAILS IN THE CONSTRUCTION DRAWINGS SHALL TAKE PRECEDENCE OVER GENERAL NOTES AND TYPICAL DETAILS. WHERE NO DETAILS ARE SHOWN, CONSTRUCTION SHALL CONFORM TO SIMILAR WORK ON THE PROJECT, AND/OR AS PROVIDED FOR IN THE CONTRACT DOCUMENTS. WHERE DISCREPANCIES OCCUR BETWEEN PLANS, DETAILS, GENERAL NOTES, AND SPECIFICATIONS, THE GREATER, MORE STRICT REQUIREMENTS, SHALL GOVERN. IF FURTHER CLARIFICATION IS REQUIRED CONTACT THE ENGINEER OF RECORD.
- 5. SUBSTANTIAL EFFORT HAS BEEN MADE TO PROVIDE ACCURATE DIMENSIONS AND MEASUREMENTS ON THE DRAWINGS TO ASSIST IN THE FABRICATION AND/OR PLACEMENT OF CONSTRUCTION ELEMENTS BUT IT IS THE SOLE RESPONSIBILITY OF THE CONTRACTOR TO FIELD VERIFY THE DIMENSIONS, MEASUREMENTS, AND/OR CLEARANCES SHOWN IN THE CONSTRUCTION DRAWINGS PRIOR TO FABRICATION OR CUTTING OF ANY NEW OR EXISTING CONSTRUCTION ELEMENTS. IF IT IS DETERMINED THAT THERE ARE DISCREPANCIES AND/OR CONFLICTS WITH THE CONSTRUCTION DRAWINGS THE ENGINEER OF RECORD IS TO BE NOTIFIED AS SOON AS POSSIBLE.
- 6. PRIOR TO THE SUBMISSION OF BIDS, THE BIDDING CONTRACTOR SHALL VISIT THE CELL SITE TO FAMILIARIZE WITH THE EXISTING CONDITIONS AND TO CONFIRM THAT THE WORK CAN BE ACCOMPLISHED AS SHOWN ON THE CONSTRUCTION DRAWINGS. ANY DISCREPANCY FOUND SHALL BE BROUGHT TO THE ATTENTION OF CARRIER POC AND TOWER OWNER.
- 7. ALL MATERIALS FURNISHED AND INSTALLED SHALL BE IN STRICT ACCORDANCE WITH ALL APPLICABLE CODES, REGULATIONS AND ORDINANCES. CONTRACTOR SHALL ISSUE ALL APPROPRIATE NOTICES AND COMPLY WITH ALL LAWS, ORDINANCES, RULES, REGULATIONS AND LAWFUL ORDERS OF ANY PUBLIC AUTHORITY REGARDING THE PERFORMANCE OF THE WORK. ALL WORK CARRIED OUT SHALL COMPLY WITH ALL APPLICABLE MUNICIPAL AND UTILITY COMPANY SPECIFICATIONS AND LOCAL JURISDICTIONAL CODES, ORDINANCES AND APPLICABLE REGULATIONS.
- 8. UNLESS NOTED OTHERWISE, THE WORK SHALL INCLUDE FURNISHING MATERIALS, EQUIPMENT, APPURTENANCES AND LABOR NECESSARY TO COMPLETE ALL INSTALLATIONS AS INDICATED ON THE DRAWINGS.
- 9. THE CONTRACTOR SHALL INSTALL ALL EQUIPMENT AND MATERIALS IN ACCORDANCE WITH MANUFACTURER'S RECOMMENDATIONS UNLESS SPECIFICALLY STATED OTHERWISE.
- 10. IF THE SPECIFIED EQUIPMENT CAN NOT BE INSTALLED AS SHOWN ON THESE DRAWINGS, THE CONTRACTOR SHALL PROPOSE AN ALTERNATIVE INSTALLATION FOR APPROVAL BY THE CARRIER AND TOWER OWNER PRIOR TO PROCEEDING WITH ANY SUCH CHANGE OF INSTALLATION
- 11. CONTRACTOR IS TO PERFORM A SITE INVESTIGATION, BEFORE SUBMITTING BIDS, TO DETERMINE THE BEST ROUTING OF ALL CONDUITS FOR POWER, AND TELCO AND FOR GROUNDING CABLES AS SHOWN IN THE POWER, TELCO, AND GROUNDING PLAN DRAWINGS.
- 12. THE CONTRACTOR SHALL PROTECT EXISTING IMPROVEMENTS, PAVEMENTS, CURBS, LANDSCAPING AND STRUCTURES. ANY DAMAGED PART SHALL BE REPAIRED AT CONTRACTOR'S EXPENSE TO THE SATISFACTION OF DISH Wireless L.L.C. AND TOWER OWNER
- 13. CONTRACTOR SHALL LEGALLY AND PROPERLY DISPOSE OF ALL SCRAP MATERIALS SUCH AS COAXIAL CABLES AND OTHER ITEMS REMOVED FROM THE EXISTING FACILITY. ANTENNAS REMOVED SHALL BE RETURNED TO THE OWNER'S DESIGNATED LOCATION.
- 14. CONTRACTOR SHALL LEAVE PREMISES IN CLEAN CONDITION. TRASH AND DEBRIS SHOULD BE REMOVED FROM SITE ON A DAILY BASIS.



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ULLERTON

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IT IS A VIOLATION OF LAW FOR ANY PERSON, UNLESS THEY ARE ACTING UNDER THE DIRECTION OF A LICENSED PROFESSIONAL BRGINEER, TO ALTER THIS DOCUMENT.

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CONSTRUCTION DOCUMENTS

		:	SUBMITTALS
ı	REV	DATE	DESCRIPTION
ı	3	11/22/2022	LEASE AREA UPDATE
ı	4	12/12/2022	ELEVATION UPDATE
ı	5	02/02/2023	JDX REVISION
ı	6	02/10/2023	JDX REVISION
ı	7	04/19/2023	ADDED SURVEY
ı	8	05/24/2023	UTILITY REVISION
	9	07/28/2023	UTILITY REVISION
		A&E F	PROJECT NUMBER

2021.0025.815755

DISH WIRELESS L.L.C.
PROJECT INFORMATION
SFSFO00115A
CA-CCI-T-815755
4900 SONOMA HWY.
SANTA ROSA, CA 95409

SHEET TITLE

GENERAL NOTES

SHEET NUMBER

CONCRETE, FOUNDATIONS, AND REINFORCING STEEL:

- 1. ALL CONCRETE WORK SHALL BE IN ACCORDANCE WITH THE ACI 301, ACI 318, ACI 336, ASTM A184, ASTM A185 AND THE DESIGN AND CONSTRUCTION SPECIFICATION FOR CAST—IN—PLACE CONCRETE.
- 2. UNLESS NOTED OTHERWISE, SOIL BEARING PRESSURE USED FOR DESIGN OF SLABS AND FOUNDATIONS IS ASSUMED TO BE 1000 psf.
- 3. ALL CONCRETE SHALL HAVE A MINIMUM COMPRESSIVE STRENGTH (f'c) OF 3000 psi AT 28 DAYS, UNLESS NOTED OTHERWISE. NO MORE THAN 90 MINUTES SHALL ELAPSE FROM BATCH TIME TO TIME OF PLACEMENT UNLESS APPROVED BY THE ENGINEER OF RECORD. TEMPERATURE OF CONCRETE SHALL NOT EXCEED 90'F AT TIME OF PLACEMENT.
- 4. CONCRETE EXPOSED TO FREEZE-THAW CYCLES SHALL CONTAIN AIR ENTRAINING ADMIXTURES. AMOUNT OF AIR ENTRAINMENT TO BE BASED ON SIZE OF AGGREGATE AND F3 CLASS EXPOSURE (VERY SEVERE). CEMENT USED TO BE TYPE II PORTLAND CEMENT WITH A MAXIMUM WATER-TO-CEMENT RATIO (W/C) OF 0.45.
- 5. ALL STEEL REINFORCING SHALL CONFORM TO ASTM A615. ALL WELDED WIRE FABRIC (WWF) SHALL CONFORM TO ASTM A185. ALL SPLICES SHALL BE CLASS "B" TENSION SPLICES, UNLESS NOTED OTHERWISE. ALL HOOKS SHALL BE STANDARD 90 DEGREE HOOKS, UNLESS NOTED OTHERWISE. YIELD STRENGTH (Fy) OF STANDARD DEFORMED BARS ARE AS FOLLOWS:

#4 BARS AND SMALLER 40 ksi

#5 BARS AND LARGER 60 ksi

- 6. THE FOLLOWING MINIMUM CONCRETE COVER SHALL BE PROVIDED FOR REINFORCING STEEL UNLESS SHOWN OTHERWISE ON DRAWINGS:
- CONCRETE CAST AGAINST AND PERMANENTLY EXPOSED TO EARTH 3"
- · CONCRETE EXPOSED TO EARTH OR WEATHER:
- •• #6 BARS AND LARGER 2"
- •• #5 BARS AND SMALLER 1-1/2"
- CONCRETE NOT EXPOSED TO EARTH OR WEATHER:
- •• SLAB AND WALLS 3/4"
- •• BEAMS AND COLUMNS 1-1/2"
- AGGREGATE SIZE NOT TO EXCEED 3/4 INCH
- SLUMP IS TO BE 2" TO 5"
- CONCRETE CROWNED WITH BROOM FINISH
- 7. A TOOLED EDGE OR A 3/4" CHAMFER SHALL BE PROVIDED AT ALL EXPOSED EDGES OF CONCRETE, UNLESS NOTED OTHERWISE, IN ACCORDANCE WITH ACI 301 SECTION 4.2.4.

ELECTRICAL INSTALLATION NOTES:

- 1. ALL ELECTRICAL WORK SHALL BE PERFORMED IN ACCORDANCE WITH THE PROJECT SPECIFICATIONS, NEC AND ALL APPLICABLE FEDERAL, STATE, AND LOCAL CODES/ORDINANCES.
- 2. CONDUIT ROUTINGS ARE SCHEMATIC. CONTRACTOR SHALL INSTALL CONDUITS SO THAT ACCESS TO EQUIPMENT IS NOT BLOCKED AND TRIP HAZARDS ARE ELIMINATED.
- 3. WIRING, RACEWAY AND SUPPORT METHODS AND MATERIALS SHALL COMPLY WITH THE REQUIREMENTS OF THE NEC.
- . ALL CIRCUITS SHALL BE SEGREGATED AND MAINTAIN MINIMUM CABLE SEPARATION AS REQUIRED BY THE NEC.
- 4.1. ALL EQUIPMENT SHALL BEAR THE UNDERWRITERS LABORATORIES LABEL OF APPROVAL, AND SHALL CONFORM TO REQUIREMENT OF THE NATIONAL ELECTRICAL CODE.
- 4.2. ALL OVERCURRENT DEVICES SHALL HAVE AN INTERRUPTING CURRENT RATING THAT SHALL BE GREATER THAN THE SHORT CIRCUIT CURRENT TO WHICH THEY ARE SUBJECTED, 22,000 AIC MINIMUM. VERIFY AVAILABLE SHORT CIRCUIT CURRENT DOES NOT EXCEED THE RATING OF ELECTRICAL EQUIPMENT IN ACCORDANCE WITH ARTICLE 110.24 NEC OR THE MOST CURRENT ADOPTED CODE PRE THE GOVERNING JURISDICTION.
- 5. EACH END OF EVERY POWER PHASE CONDUCTOR, GROUNDING CONDUCTOR, AND TELCO CONDUCTOR OR CABLE SHALL BE LABELED WITH COLOR—CODED INSULATION OR ELECTRICAL TAPE (3M BRAND, 1/2" PLASTIC ELECTRICAL TAPE WITH UV PROTECTION, OR EQUAL). THE IDENTIFICATION METHOD SHALL CONFORM WITH NEC AND OSHA.
- 6. ALL ELECTRICAL COMPONENTS SHALL BE CLEARLY LABELED WITH LAMICOID TAGS SHOWING THEIR RATED VOLTAGE, PHASE CONFIGURATION, WIRE CONFIGURATION, POWER OR AMPACITY RATING AND BRANCH CIRCUIT ID NUMBERS (i.e. PANEL BOARD AND CIRCUIT ID'S).
- 7. PANEL BOARDS (ID NUMBERS) SHALL BE CLEARLY LABELED WITH PLASTIC LABELS.
- TIE WRAPS ARE NOT ALLOWED
- 9. ALL POWER AND EQUIPMENT GROUND WIRING IN TUBING OR CONDUIT SHALL BE SINGLE COPPER CONDUCTOR (#14 OR LARGER) WITH TYPE THHW, THWN, THWN-2, XHHW, XHHW-2, THW, THW-2, RHW, OR RHW-2 INSULATION UNLESS OTHERWISE SPECIFIED.
- 10. SUPPLEMENTAL EQUIPMENT GROUND WIRING LOCATED INDOORS SHALL BE SINGLE COPPER CONDUCTOR (#6 OR LARGER) WITH TYPE THHW, THWN, THWN-2, XHHW, XHHW-2, THW, THW-2, RHW, OR RHW-2 INSULATION UNLESS OTHERWISE SPECIFIED.
- 11. POWER AND CONTROL WIRING IN FLEXIBLE CORD SHALL BE MULTI-CONDUCTOR, TYPE SOOW CORD (#14 OR LARGER) UNLESS OTHERWISE SPECIFIED.
- 12. POWER AND CONTROL WIRING FOR USE IN CABLE TRAY SHALL BE MULTI-CONDUCTOR, TYPE TC CABLE (#14 OR LARGER), WITH TYPE THHW, THWN, THWN-2, XHHW, XHHW-2, THW, THW-2, RHW, OR RHW-2 INSULATION UNLESS OTHERWISE SPECIFIED.
- 13. ALL POWER AND GROUNDING CONNECTIONS SHALL BE CRIMP—STYLE, COMPRESSION WIRE LUGS AND WIRE NUTS BY THOMAS AND BETTS (OR EQUAL). LUGS AND WIRE NUTS SHALL BE RATED FOR OPERATION NOT LESS THAN 75° C (90° C IF AVAILABLE).
- 14. RACEWAY AND CABLE TRAY SHALL BE LISTED OR LABELED FOR ELECTRICAL USE IN ACCORDANCE WITH NEMA, UL, ANSI/IEEE AND NEC.

- 15. ELECTRICAL METALLIC TUBING (EMT), INTERMEDIATE METAL CONDUIT (IMC), OR RIGID METAL CONDUIT (RMC) SHALL BE USED FOR EXPOSED INDOOR LOCATIONS.
- ELECTRICAL METALLIC TUBING (EMT) OR METAL-CLAD CABLE (MC) SHALL BE USED FOR CONCEALED INDOOR LOCATIONS.
- 17. SCHEDULE 40 PVC UNDERGROUND ON STRAIGHTS AND SCHEDULE 80 PVC FOR ALL ELBOWS/90s AND ALL APPROVED ABOVE GRADE PVC CONDUIT.
- 18. LIQUID-TIGHT FLEXIBLE METALLIC CONDUIT (LIQUID-TITE FLEX) SHALL BE USED INDOORS AND OUTDOORS, WHERE VIBRATION OCCURS OR FLEXIBILITY IS NEEDED.
- 19. CONDUIT AND TUBING FITTINGS SHALL BE THREADED OR COMPRESSION—TYPE AND APPROVED FOR THE LOCATION USED. SET SCREW FITTINGS ARE NOT ACCEPTABLE.
- 20. CABINETS, BOXES AND WIRE WAYS SHALL BE LABELED FOR ELECTRICAL USE IN ACCORDANCE WITH NEMA, UL, ANSI/IEEE AND THE NEC.
- 21. WIREWAYS SHALL BE METAL WITH AN ENAMEL FINISH AND INCLUDE A HINGED COVER, DESIGNED TO SWING OPEN DOWNWARDS (WIREMOLD SPECMATE WIREWAY).
- 22. SLOTTED WIRING DUCT SHALL BE PVC AND INCLUDE COVER (PANDUIT TYPE E OR EQUAL).
- 23. CONDUITS SHALL BE FASTENED SECURELY IN PLACE WITH APPROVED NON-PERFORATED STRAPS AND HANGERS. EXPLOSIVE DEVICES (i.e. POWDER-ACTUATED) FOR ATTACHING HANGERS TO STRUCTURE WILL NOT BE PERMITTED. CLOSELY FOLLOW THE LINES OF THE STRUCTURE, MAINTAIN CLOSE PROXIMITY TO THE STRUCTURE AND KEEP CONDUITS IN TIGHT ENVELOPES. CHANGES IN DIRECTION TO ROUTE AROUND OBSTACLES SHALL BE MADE WITH CONDUIT OUTLET BODIES. CONDUIT SHALL BE INSTALLED IN A NEAT AND WORKMANLIKE MANNER. PARALLEL AND PERPENDICULAR TO STRUCTURE WALL AND CEILING LINES. ALL CONDUIT SHALL BE FISHED TO CLEAR OBSTRUCTIONS. ENDS OF CONDUITS SHALL BE TEMPORARILY CAPPED FLUSH TO FINISH GRADE TO PREVENT CONCRETE, PLASTER OR DIRT FROM ENTERING. CONDUITS SHALL BE RIGIDLY CLAMPED TO BOXES BY GALVANIZED MALLEABLE IRON BUSHING ON INSIDE AND GALVANIZED MALLEABLE IRON LOCKNUT ON OUTSIDE AND INSIDE.
- 24. EQUIPMENT CABINETS, TERMINAL BOXES, JUNCTION BOXES AND PULL BOXES SHALL BE GALVANIZED OR EPOXY—COATED SHEET STEEL. SHALL MEET OR EXCEED UL 50 AND BE RATED NEMA 1 (OR BETTER) FOR INTERIOR LOCATIONS AND NEMA 3 (OR BETTER) FOR EXTERIOR LOCATIONS.
- 25. METAL RECEPTACLE, SWITCH AND DEVICE BOXES SHALL BE GALVANIZED, EPOXY—COATED OR NON—CORRODING; SHALL MEET OR EXCEED UL 514A AND NEMA OS 1 AND BE RATED NEMA 1 (OR BETTER) FOR INTERIOR LOCATIONS AND WEATHER PROTECTED (WP OR BETTER) FOR EXTERIOR LOCATIONS.
- 26. NONMETALLIC RECEPTACLE, SWITCH AND DEVICE BOXES SHALL MEET OR EXCEED NEMA OS 2 (NEWEST REVISION) AND BE RATED NEMA 1 (OR BETTER) FOR INTERIOR LOCATIONS AND WEATHER PROTECTED (WP OR BETTER) FOR EXTERIOR LOCATIONS.
- 27. THE CONTRACTOR SHALL NOTIFY AND OBTAIN NECESSARY AUTHORIZATION FROM THE CARRIER AND/OR DISH Wireless L.L.C. AND TOWER OWNER BEFORE COMMENCING WORK ON THE AC POWER DISTRIBUTION PANELS.
- 28. THE CONTRACTOR SHALL PROVIDE NECESSARY TAGGING ON THE BREAKERS, CABLES AND DISTRIBUTION PANELS IN ACCORDANCE WITH THE APPLICABLE CODES AND STANDARDS TO SAFEGUARD LIFE AND PROPERTY.
- 29. INSTALL LAMICOID LABEL ON THE METER CENTER TO SHOW "DISH Wireless L.L.C.".
- 30. ALL EMPTY/SPARE CONDUITS THAT ARE INSTALLED ARE TO HAVE A METERED MULE TAPE PULL CORD INSTALLED.



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ULLERTON

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3	11/22/2022	LEASE AREA UPDATE		
4	12/12/2022	ELEVATION UPDATE		
5	02/02/2023	JDX REVISION		
6	02/10/2023	JDX REVISION		
7	04/19/2023	ADDED SURVEY		
8	05/24/2023	UTILITY REVISION		
9	07/28/2023	UTILITY REVISION		
A&E PROJECT NUMBER				

DISH WIRELESS L.L.C.
PROJECT INFORMATION
SFSF000115A
CA-CCI-T-815755
4900 SONOMA HWY.

2021.0025.815755

SANTA ROSA, CA 95409

SHEET TITLE

GENERAL NOTES

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GROUNDING NOTES:

- 1. ALL GROUND ELECTRODE SYSTEMS (INCLUDING TELECOMMUNICATION, RADIO, LIGHTNING PROTECTION AND AC POWER GES'S) SHALL BE BONDED TOGETHER AT OR BELOW GRADE, BY TWO OR MORE COPPER BONDING CONDUCTORS IN ACCORDANCE WITH THE NEC.
- 2. THE CONTRACTOR SHALL PERFORM IEEE FALL—OF—POTENTIAL RESISTANCE TO EARTH TESTING (PER IEEE 1100 AND 81) FOR GROUND ELECTRODE SYSTEMS, THE CONTRACTOR SHALL FURNISH AND INSTALL SUPPLEMENTAL GROUND ELECTRODES AS NEEDED TO ACHIEVE A TEST RESULT OF 5 OHMS OR LESS.
- 3. THE CONTRACTOR IS RESPONSIBLE FOR PROPERLY SEQUENCING GROUNDING AND UNDERGROUND CONDUIT INSTALLATION AS TO PREVENT ANY LOSS OF CONTINUITY IN THE GROUNDING SYSTEM OR DAMAGE TO THE CONDUIT AND PROVIDE TESTING RESULTS.
- 4. METAL CONDUIT AND TRAY SHALL BE GROUNDED AND MADE ELECTRICALLY CONTINUOUS WITH LISTED BONDING FITTINGS OR BY BONDING ACROSS THE DISCONTINUITY WITH #6 COPPER WIRE UL APPROVED GROUNDING TYPE CONDUIT CLAMPS.
- 5. METAL RACEWAY SHALL NOT BE USED AS THE NEC REQUIRED EQUIPMENT GROUND CONDUCTOR. STRANDED COPPER CONDUCTORS WITH GREEN INSULATION, SIZED IN ACCORDANCE WITH THE NEC, SHALL BE FURNISHED AND INSTALLED WITH THE POWER CIRCUITS TO BTS EQUIPMENT.
- 6. EACH CABINET FRAME SHALL BE DIRECTLY CONNECTED TO THE MASTER GROUND BAR WITH GREEN INSULATED SUPPLEMENTAL EQUIPMENT GROUND WIRES, #6 STRANDED COPPER OR LARGER FOR INDOOR BTS; #2 BARE SOLID TINNED COPPER FOR OUTDOOR BTS.
- 7. CONNECTIONS TO THE GROUND BUS SHALL NOT BE DOUBLED UP OR STACKED BACK TO BACK CONNECTIONS ON OPPOSITE SIDE OF THE GROUND BUS ARE PERMITTED.
- 8. ALL EXTERIOR GROUND CONDUCTORS BETWEEN EQUIPMENT/GROUND BARS AND THE GROUND RING SHALL BE #2 SOLID TINNED COPPER UNLESS OTHERWISE INDICATED.
- 9. ALUMINUM CONDUCTOR OR COPPER CLAD STEEL CONDUCTOR SHALL NOT BE USED FOR GROUNDING CONNECTIONS.
- 10. USE OF 90° BENDS IN THE PROTECTION GROUNDING CONDUCTORS SHALL BE AVOIDED WHEN 45° BENDS CAN BE ADEQUATELY SUPPORTED.
- 11. EXOTHERMIC WELDS SHALL BE USED FOR ALL GROUNDING CONNECTIONS BELOW GRADE.
- 12. ALL GROUND CONNECTIONS ABOVE GRADE (INTERIOR AND EXTERIOR) SHALL BE FORMED USING HIGH PRESS CRIMPS.
- COMPRESSION GROUND CONNECTIONS MAY BE REPLACED BY EXOTHERMIC WELD CONNECTIONS.
- 14. ICE BRIDGE BONDING CONDUCTORS SHALL BE EXOTHERMICALLY BONDED OR BOLTED TO THE BRIDGE AND THE TOWER GROUND BAR
- 15. APPROVED ANTIOXIDANT COATINGS (i.e. CONDUCTIVE GEL OR PASTE) SHALL BE USED ON ALL COMPRESSION AND BOLTED GROUND CONNECTIONS.
- 16. ALL EXTERIOR GROUND CONNECTIONS SHALL BE COATED WITH A CORROSION RESISTANT MATERIAL.
- 17. MISCELLANEOUS ELECTRICAL AND NON-ELECTRICAL METAL BOXES, FRAMES AND SUPPORTS SHALL BE BONDED TO THE GROUND RING, IN ACCORDANCE WITH THE NEC.
- 18. BOND ALL METALLIC OBJECTS WITHIN 6 ft OF MAIN GROUND RING WITH (1) #2 BARE SOLID TINNED COPPER GROUND CONDUCTOR.
- 19. GROUND CONDUCTORS USED FOR THE FACILITY GROUNDING AND LIGHTNING PROTECTION SYSTEMS SHALL NOT BE ROUTED THROUGH METALLIC OBJECTS THAT FORM A RING AROUND THE CONDUCTOR, SUCH AS METALLIC CONDUITS, METAL SUPPORT CLIPS OR SLEEVES THROUGH WALLS OR FLOORS. WHEN IT IS REQUIRED TO BE HOUSED IN CONDUIT TO MEET CODE REQUIREMENTS OR LOCAL CONDITIONS, NON-METALLIC MATERIAL SUCH AS PVC CONDUIT SHALL BE USED. WHERE USE OF METAL CONDUIT IS UNAVOIDABLE (i.e., NONMETALLIC CONDUIT PROHIBITED BY LOCAL CODE) THE GROUND CONDUCTOR SHALL BE BONDED TO EACH END OF THE METAL CONDUIT.
- 20. ALL GROUNDS THAT TRANSITION FROM BELOW GRADE TO ABOVE GRADE MUST BE #2 BARE SOLID TINNED COPPER IN 3/4" NON-METALLIC, FLEXIBLE CONDUIT FROM 24" BELOW GRADE TO WITHIN 3" TO 6" OF CAD-WELD TERMINATION POINT. THE EXPOSED END OF THE CONDUIT MUST BE SEALED WITH SILICONE CAULK. (ADD TRANSITIONING GROUND STANDARD DETAIL AS WELL).
- 21. BUILDINGS WHERE THE MAIN GROUNDING CONDUCTORS ARE REQUIRED TO BE ROUTED TO GRADE, THE CONTRACTOR SHALL ROUTE TWO GROUNDING CONDUCTORS FROM THE ROOFTOP, TOWERS, AND WATER TOWERS GROUNDING RING, TO THE EXISTING GROUNDING SYSTEM, THE GROUNDING CONDUCTORS SHALL NOT BE SMALLER THAN 2/O COPPER. ROOFTOP GROUNDING RING SHALL BE BONDED TO THE EXISTING GROUNDING SYSTEM, THE BUILDING STEEL COLUMNS, LIGHTNING PROTECTION SYSTEM, AND BUILDING MAIN WATER LINE (FERROUS OR NONFERROUS METAL PIPING ONLY). DO NOT ATTACH GROUNDING TO FIRE SPRINKLER SYSTEM PIPES.



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